

City of Surrey PLANNING & DEVELOPMENT REPORT Application No.: 7924-0103-00

Planning Report Date: October 7, 2024

PROPOSAL:

- OCP Amendment to increase the maximum floor area ratio (FAR) from 2.5 to 2.82 in the Multiple Residential designation of the site.
- **Rezoning** from R₃ to CD (based on RM-70)
- Development Permit
- Subdivision

to permit the development of a 6-storey 87 unit rental apartment building secured through a Housing Agreement

LOCATION: 10707 - 138 Street, 10695 - 138 Street


10713 - 138 Street

ZONING: R₃

OCP DESIGNATION: Multiple Residential

CITY CENTRE PLAN Low to Mid Rise Residential

DESIGNATION:

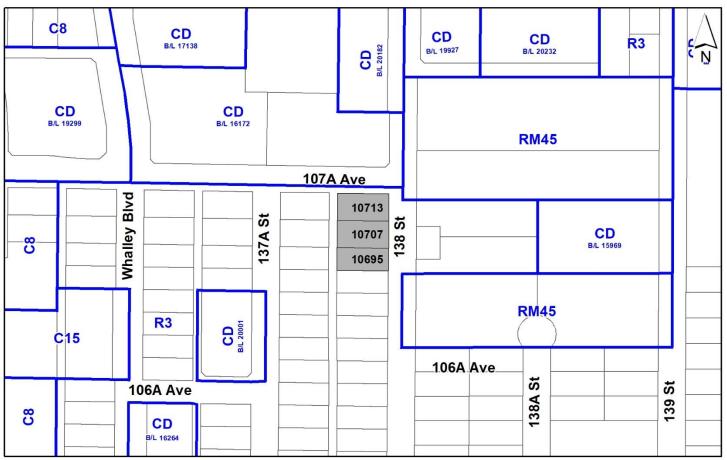

RECOMMENDATION SUMMARY

- OCP Amendment and Rezoning By-laws to proceed to Public Notification. If supported the By-laws will be brought forward for consideration of First, Second and Third Reading.
- Approval to draft Development Permit for Form and Character

DEVIATION FROM PLANS, POLICIES OR REGULATIONS

 Proposing an amendment to the Official Community Plan (OCP) to increase the maximum permitted density of the Low to Mid Rise Residential designation from 2.5 FAR to 2.82 FAR (Net density).

RATIONALE OF RECOMMENDATION

- The applicant is proposing an OCP Amendment to increase the allowable Floor Area Ratio (FAR) under the Multiple Residential designation from 2.5 to 2.82 FAR. The requested OCP Amendment is supported given that the proposed development complies with the Tier 3 Transit-Oriented Area (TOA) minimum allowable density and height in the Official Community Plan (OCP) and conforms to the goal of achieving higher density in and around existing SkyTrain stations within Surrey City Centre.
- Under Bill 47 (2023) a Public Hearing is not permitted for the subject Official Community Plan (OCP) amendment and rezoning application as the proposed density is consistent with Transit-Oriented Area (TOA) density and height provisions in the OCP. As such, Council is requested to endorse the Public Notification to proceed for the proposed OCP By-law and Rezoning By-law. The By-laws will be presented to Council for consideration of First, Second, and Third Reading, after the required Public Notification is complete, with all comments received from the Public Notification presented to Council prior to consideration of the By-law readings.
- The proposal complies with the General Urban designation in the Metro Vancouver Regional Growth Strategy (RGS).
- The proposed development is consistent with the intent with the form of development that is envisioned under the Low Rise to Mid Rise designation under the City Centre Plan. Similarly the proposal is within a Tier 3 TOA and conforms to the goal of achieving higher density development near a transit corridor, while at the same time providing an appropriate density and interface with lower density designated lands to the west.
- The applicant is proposing that all 87 units will be provided as rental units and has agreed to enter into a Housing Agreement for a 60 year period to ensure that these remain available as rental units during this time. Registration of a Housing Agreement is identified as a condition of approval for the subject application and will be brought forward for consideration by Council separately, should the proposal be supported.
- The proposed density and building form are appropriate for this part of Surrey City Centre Plan area.

- The proposal complies with the Development Permit requirements in the OCP for Form and Character.
- The proposed setbacks achieve a more urban, pedestrian streetscape in accordance with the Development Permit (Form and Character) design guidelines in the OCP.
- The proposed building achieves an attractive architectural built form, which utilizes high quality materials and contemporary lines. The street interface has been designed to a high quality to achieve a positive urban experience between the proposed building and the public realm.

RECOMMENDATION

The Planning & Development Department recommends that:

- 1. Council endorse the Public Notification to proceed for an Official Community Plan (OCP) amendment By-law (Appendix V) to amend Table 7a: Land Use Designation Exceptions within the Multiple Residential designation by adding site specific permission for the subject site to permit a density of up to 2.82 FAR (Net density).
- 2. Council determine the opportunities for consultation with persons, organizations and authorities that are considered to be affected by the proposed amendment to the OCP, as described in the Report, to be appropriate to meet the requirement of Section 475 of the Local Government Act.
- 3. Council endorse the Public Notification to proceed for a By-law to rezone the subject site from "Urban Residential Zone (R₃)" to "Comprehensive Development Zone (CD)".
- 4. Council authorize staff to draft Development Permit No. 7924-0103-00 generally in accordance with the attached drawings (Appendix I).
- 5. Council instruct staff to resolve the following issues prior to final adoption:
 - (a) ensure that all engineering requirements and issues including restrictive covenants, dedications, and rights-of-way where necessary, are addressed to the satisfaction of the General Manager, Engineering;
 - (b) submission of a subdivision layout to the satisfaction of the Approving Officer;
 - (c) resolution of all urban design issues to the satisfaction of the Planning and Development Department;
 - (d) submission of a finalized landscaping plan and landscaping cost estimate to the specifications and satisfaction of the Planning and Development Department;
 - (e) submission of a finalized tree survey and a statement regarding tree preservation to the satisfaction of the City Landscape Architect;
 - (f) the applicant enter into a Housing Agreement with the City to ensure the provision of 87 market rental units for a period no less than 60 years;
 - (g) demolition of existing buildings and structures to the satisfaction of the Planning and Development Department;
 - (h) registration of a Section 219 Restrictive Covenant requiring the applicant to pay all deferred financial contributions for Public Art, Affordable Housing Strategy, and Tier 1 Capital Projects Community Amenity Contributions should the project be converted from rental housing to market housing at any time after the subject Housing Agreement has expired.

SITE CONTEXT & BACKGROUND

Direction	Existing Use	OCP/NCP	Existing Zone
		Designation	
Subject Site	Single Family	Multiple	R ₃
	House	Residential/	
North (Across 107A Avenue):	4 storey apartment	Multiple	CD (Bylaw No.
		Residential/Low	16172)
		Rise Residential	
East (Across 138 Street):	3 vacant lots	Multiple	R ₃
		Residential/Low	
		Rise Residential	
South:	Single family house	Multiple	R ₃
		Residential/Low	
		Rise Residential	
West (Across Lane):	Single family	Multiple	R ₃
	houses.	Residential/Low	
		Rise Residential	

Context & Background

- The 0.216-hectare subject site is comprised of three (3) single family residential lots that are currently zoned single family residential, between 138 Street and 107A Avenue in the Forsyth Neighbourhood of City Centre. The site is also within the Gateway Station TOA (Tier 3).
- The subject site is designated "Multiple Residential" in the Official Community Plan (OCP), "Low to Mid Rise Residential" in the City Centre Plan and currently zoned "Urban Residential Zone (R₃)".

DEVELOPMENT PROPOSAL

Planning Considerations

- To permit the development of a 6-storey apartment building containing 87 units over two (2) levels of shared underground parking in City Centre, the applicant has requested the following:
 - OCP Amendment to allow a higher density of 2.82 FAR (Net) in the Multiple Residential designation for the consolidated site;
 - o Rezoning from R₃ to CD (based on RM-70);
 - o Detailed Development Permit for Form and Character; and
 - o Subdivision (Consolidation) from three (3) lots to one (1) lot
- The applicant is proposing that all 87 units will be provided as rental units and has agreed to
 enter into a Housing Agreement for a 60 year period to ensure that these remain available as
 rental units during this time. Registration of a Housing Agreement is identified as a condition
 of approval for the subject application and will be brought forward for consideration by
 Council separately, should the proposal be supported.

	Proposed
Lot Area	
Gross Site Area:	2156.8 m ²
Road Dedication:	111.34 m²
Net Site Area:	2045.46 m ²
Number of Lots:	3
Building Height:	20.13 m (6-storeys)
Unit Density:	30.74 upa
Floor Area Ratio (FAR):	2.68 gross, 2.82 net
Floor Area	
Residential:	5,891 m ²
Residential Units:	
1-Bedroom:	59
2-Bedroom:	22
3-Bedroom:	6
Total:	87

Referrals

Engineering: The Engineering Department has no objection to the project

subject to the completion of Engineering servicing requirements as

outlined in Appendix II.

School District: The School District has advised that there will be

approximately 13 school-age children generated by this development, of which the School District has provided the

following expected student enrollment.

8 Elementary students at Forsyth Road Elementary School

3 Secondary students at Kwantlen Park Secondary School

(Appendix III)

Note that the number of school-age children is greater than the expected enrollment due to students attending private

schools, home school or different school districts.

Parks, Recreation &

Culture:

The closest active park is Forsyth Park and is 217 metres away, and

the closest natural area is Hawthorne Rotary Park and is 610 metres

away.

Surrey Fire Department: The Surrey Fire Department does not have any objections to this

project moving forward to the next step in the development

process.

Advisory Design Panel:

At the Regular Council – Land Use meeting on December 18, 2023, Council endorsed Corporate Report No. R214 (2023) which amended the Terms of Reference of the City's Advisory Design Panel (ADP) which permits multi-family proposals that are 6-storeys or less, and supported by City staff, to proceed to Council for By-law introduction, without review and/or comment from the ADP.

The subject development proposal is generally supported by City staff and the applicant has agreed to resolve any outstanding items, to the satisfaction of the Planning and Development Department, prior to consideration of Final Adoption of the Rezoning By-law as well as issuance of the Development Permit.

Transportation Considerations

Road Network and Infrastructure:

- The applicant will provide the following road improvements to service the subject proposal:
 - o Construct the south side of 107A Ave with barrier curb and gutter, boulevard with street lighting and street trees, and sidewalk.
 - Dedication and construction of a portion of 138 Street with barrier curb and gutter, boulevard with street lighting and street trees, and sidewalk.
 - o Construct the 6.o metre wide residential lane along the western property line

Parking and Access

Access to the underground parkade will be provided from the lane only.

Transit and/or Active Transportation Routes

- The subject site is within walking distance (approximately 975 metres) from the Gateway SkyTrain station.
- The subject site is located approximately 350 metres from the following TransLink services routes along King George Boulevard:
 - o Route No. 321 (White Rock Centre/Newton Exchange/Surrey Central Station); and
 - o Route No. Nig (Downtown/Surrey Central Station Nightbus)
 - The subject site is located approximately 160 metres from the following TransLink services routes along 108 Ave:
 - o Route No. 335 (Surrey Central Station)

Sustainability Considerations

• The applicant has met all of the typical sustainable development criteria, as indicated in the Sustainable Development Checklist.

POLICY & BY-LAW CONSIDERATIONS

Regional Growth Strategy

• The proposed development complies with the "General Urban" and "Urban Centres (Surrey Metro Centre)" land use designations of the subject site in Metro Vancouver's Regional Growth Strategy (RGS).

Official Community Plan

Land Use Designation and Amendment Rationale

- The subject site is designated "Multiple Residential" in the Official Community Plan.
- In accordance with the OCP, the "Multiple Residential" designation supports a maximum floor area ratio (FAR) of up to 2.5 for sites within the City Centre Plan area.
- The applicant is requesting an increase in allowable FAR under the "Multiple Residential" designation from 2.5 to 2.68 gross FAR (2.82 net FAR), which is required in order to allow the form of development proposed.
- The requested OCP Amendment is supported given the following rationale
 - o the proposed development complies with the Tier 3 Transit-Oriented Area (TOA) minimum allowable density and height in the Official Community Plan (OCP) and has merit given;
 - the proposal is consistent with the existing pattern of multiple residential development in this portion of City Centre;
 - o the proposal is has an appropriately designed 6-storey residential form on the consolidated site; and
 - o all 87 units will be provided as market rental units, secured through a Housing Agreement for a minimum of 60 years.

Themes/Objectives

- The proposed development is compliant with the following OCP themes/policies:
 - Support compact and efficient land development that is consistent with Metro Vancouver Regional Growth Strategy (OCP Policy A1);
 - o Accommodate higher density development into Surrey's City Centre and near Frequent Transit Corridors at densities sufficient to encourage commercial development and transit service expansions (A₂);
 - o Encourage development in urban neighbourhoods to utilize existing infrastructure and amenities and to enhance existing neighborhood character and viability (A₃);
 - Encourage development that supports increased transit, pedestrian walkability, and bicycle access (B₃);
 - O Develop complete, accessible, and walkable green neighbourhoods with sufficient densities to support a high-quality transit system that is accessible to most residents (B₄);
 - o Encourage the development of accessible and adaptable units (F3); and

 Promote affordable family housing in City Centre by encouraging a mix of unit types including two-bedroom and three-bedroom apartments in new developments (F₃)

CD By-law

- The applicant proposes to rezone the subject site from "Urban Residential Zone (R₃)" to CD based on the "Multiple Residential 70 Zone (RM-70)".
- The applicant is proposing a "Comprehensive Development Zone (CD)" to accommodate a proposed 6-storey rental apartment on the subject site. The proposed CD By-law for the proposed development site identifies the uses, densities and setbacks proposed. The CD By-law will have provisions based on the "Multiple Residential 70 Zone (RM-70)".
- A comparison of the density, lot coverage, setbacks, building height and permitted uses in the RM-70 Zone and the proposed CD By-law is illustrated in the following table:

Zoning	RM-70 Zone (Part 24)	Proposed CD Zone
Unit Density:	NA	NA
Floor Area Ratio:	1.5 FAR	2.82 FAR
Lot Coverage:	33%	60%
Yards and Setbacks	7.5 metres for all lot lines	North (Front): 4.5 m East (Exterior Side): 4.5 m South (Rear): 4.5 m West (Interior Side) 6.0 m
Principal Building Height:	50m	20.13 M
Permitted Uses:	 Multiple unit residential buildings Ground-oriented multiple unit residential buildings Child Care Centres 	Multiple unit residential building
Indoor Amenity:	261 m²	The proposed 117 m ² + CIL meets the Zoning By-law requirement.
Outdoor Amenity:	261 m²	The proposed 775 m² meets the Zoning By-law requirement.
Parkin	g (Part 5)	Proposed
Residential:		83
Residential Visitor:		9
Total:		92
Bicycle Spaces		110

- The applicant is proposing an OCP Amendment to increase the allowable Floor Area Ratio (FAR) under the Multiple Residential designation from 2.5 to 2.82 FAR, when calculated on the net site area. As a result, the FAR for the net site area has been increased from 1.50 under the RM-70 Zone to a maximum of 2.82 (net) in the proposed CD Bylaw.
- The maximum lot coverage has been increased from 33% in the RM-70 Zone to a maximum of 60% in the proposed CD Bylaw in order to accommodate the proposed 6-storey apartment built form.
- The proposal to reduce the minimum building setback requirements along all lot lines, including street frontages, for the proposed development is supported given that it will allow for a more urban, pedestrian-oriented streetscape.
- Part 1 Definitions of the Surrey Zoning Bylaw allow encroachments into the required setbacks, to a maximum of 0.6 metres. The balconies encroach 0.99 metres into this setback area. As a result, the proposed CD Bylaw will include provisions that will allow for the balconies to extend 0.39 metres into the required setbacks.
- Part 5 Off-Street Parking and Loading/Unloading of the Surrey Zoning Bylaw requires that no parking facilities be constructed within 2.0 metres of the front lot line or a lot line along a flanking street. The proposed underground parkade will be located a minimum of 0.5 metres from all street frontages. As a result, the proposed CD Bylaw will include provisions that will allow for the underground parking facility to extend to within 0.5 metres of all lot lines.
- The site is located within a Transit-Oriented Area (TOA), and as such, there are no minimum residential parking requirements. The applicant is proposing to provide 83 residential parking spaces and 9 residential visitor parking spaces.

Capital Projects Community Amenity Contributions (CACs)

- On December 16, 2019, Council approved the City's Community Amenity Contribution and Density Bonus Program Update (Corporate Report No. R224; 2019). The intent of that report was to introduce a new City-wide Community Amenity Contribution (CAC) and updated Density Bonus Policy to offset the impacts of growth from development and to provide additional funding for community capital projects identified in the City's Annual Five-Year Capital Financial Plan. A fee update has been approved in April 2023, under Corporate Report No.R037;2023.
- The proposed development will not be subject to the Tier 1 Capital Plan Project CACs, as the proposal includes 100% market rental residential units. A Restrictive Covenant will be registered making CAC payable if there is a future change in tenure.
- The proposed development is not subject to the Tier 2 Capital Plan Project CACs as the proposed density complies with the Tier 3 Transit-Oriented Area (TOA) minimum allowable density and height in the Official Community Plan (OCP).

Affordable Housing Strategy

- On April 9, 2018, Council approved the City's Affordable Housing Strategy (Corporate Report No. Ro66; 2018) requiring that all new rezoning applications for residential development contribute \$1,113.92 per new unit to support the development of new affordable housing. The funds collected through the Affordable Housing Contribution are used to purchase land for new affordable rental housing projects.
- As a rental project, the subject proposal is exempt from the provision of this policy. The applicant will be required to register a Section 219 Restrictive Covenant, making the fees payable if there is a future change in tenure from the market rental, to address the City's needs with respect to the City's Affordable Housing Strategy.

Public Art Policy

• The Public Art contribution will not be required as the proposal includes 100% market rental units and will be applicable to the residential portion only if there is a future change in tenure from the market rental residential units. The applicant will be required to register a Section 219 Restrictive Covenant, making the fees payable if there is a future change in tenure from the market rental.

PUBLIC ENGAGEMENT

• Pre-notification letters were sent on June 5, 2024, and the Development Proposal Signs were installed on June 12, 2024. Staff received no responses from neighbouring properties.

DEVELOPMENT PERMITS

Form and Character Development Permit Requirement

- The proposed development is subject to a Development Permit for Form and Character and is also subject to the urban design guidelines in the Surrey City Centre Plan.
- The proposed development generally complies with the Form and Character Development Permit guidelines in the OCP and the design guidelines in the Surrey City Centre Plan.
- The applicant is proposing a single 6-storey apartment building, containing 87 market rental dwelling units, located over two (2) levels of shared underground parking. The proposal also includes 11 adaptable units located throughout the proposed development.
- The proposed 6-storey apartment complex incorporates both building massing and design aesthetics that are generally in accordance with the vision for this part of Surrey City Centre. This area is envisioned as a medium-density, medium- height residential neighbourhood of 4- to 6-storey apartments and townhouses. Specifically, the apartment addresses a number of design related items:
 - o The setbacks match the City Centre TCP Guidelines.
 - o Entries are logically located for clarity and safety. The main street front entry/lobby is easily identifiable as different materials and colours are used in this area.

- The building design and massing is sympathetic to the 4-storey apartment building across 107A Ave. Level 6 is stepped back and there is a design emphasis on levels 1-4.
- o Indoor and outdoor amenity are located away from the street and relate to each other.
- o Fenestration and balconies are designed to have a logical and attractive order.
- o There is a limited palette of materials that are high-quality and placed to create a pedestrian-scaled building base and visual interest.
- There is a clear architectural design character that engages pedestrian interest with balanced scale and composition.
- The proposed indoor and outdoor amenity spaces have been integrated for site functionality and efficiency. Outdoor amenity is provided both at grade as well as on the roof top. For more details, please see the Indoor and Outdoor Amenity Space sections in this report.

Landscaping

- The landscape plans include a mixture of trees, shrubs, and groundcover to be planted throughout the subject site, as well as hardscaping, site lighting, fencing and site furnishings.
- Street-facing, ground-level dwelling units each have access to a semi-private, raised patio space which are screened from the adjacent public sidewalk through a combination of low landscaped retaining walls, low-lying shrubs and individual trees. Each patio can be accessed either through the dwelling unit or via a gated, street-level entrance.
- Extensive landscaping and a pathway that runs alongside the rear lane are proposed along the
 west lot line, as well as a landscape buffer to the south adjacent to an existing single family
 dwelling.
- See the Outdoor Amenity section below regarding landscaping in association with the proposed on-site outdoor amenity spaces

Indoor Amenity

- The Surrey Zoning Bylaw requires the applicant to provide a minimum of 3.0 square metres of amenity space per dwelling unit. The Zoning Bylaw also prescribes the minimum indoor amenity space requirement that must be provided on site with a cash-in-lieu option to address the remaining requirement.
- Based upon the Surrey Zoning Bylaw requirement, the proposed development must provide 261 square metres of indoor amenity space to serve the residents of the proposed 87-unit apartment building. Of this 261-square metre requirement, a minimum of 74 square metres of indoor amenity space must be provided on site, and the remaining indoor amenity space requirement can be addressed through a cash-in-lieu contribution.
- The applicant proposed 117 square metres of indoor amenity space thereby requiring cash-inlieu for the proposed shortfall in accordance with City Council policy.
- The applicant is proposing the following ground floor indoor amenity spaces within the project:

- o A 70.8 square metre games room, multi-purpose lounge, and communal kitchen area; and,
- o A 46.5 square metre fitness/yoga studio

Outdoor Amenity

- Based upon the City's Zoning Bylaw requirement of 3.0 square metres per dwelling unit, the proposed development must provide a total of 261 square metres of outdoor amenity space to serve the residents of the proposed 87-unit apartment building.
- The applicant is proposing 775 square metres of outdoor amenity space, exceeding the minimum requirement.
- All of the proposed outdoor amenity space is proposed in two locations: at grade along the western portion of the site adjacent to the lane and accessed directly from the indoor amenity space on the first floor, as well as on the roof top. The proposed outdoor amenity space accessed from the indoor amenity area consists of an outdoor sitting area. The proposed roof top outdoor amenity area consists of 5 sitting areas, several planters, a children's play structure, garden plots and a BBQ area.

Outstanding Items

- There are a limited number of Urban Design items that remain outstanding, and which do not affect the overall character or quality of the project. These generally include revising some materials use at the lobby area, minor changes to soffits, and a top floor massing treatment.
- The applicant has been provided a detailed list identifying these requirements and has agreed
 to resolve these prior to Final Approval of the Development Permit, should the application be
 supported by Council.

TREES

- Kimberley Dahl, ISA Certified Arborist of Davey Resource Group prepared an Arborist Assessment for the subject site. The table below provides a summary of the proposed tree retention and removal. A detailed list of the proposed tree retention and removal by tree species can be found in Appendix V.
- All trees identified for removal, retention and/or replacement are subject to change prior to final approval of the arborist report.

Table 1: Summary of Proposed Onsite Tree Preservation by Tree Species:

	Existing	Remove	Retain
Alder/Cottonwood (outside riparian area)	0		
Alder/Cottonwood (within riparian area)	0		
Deciduous Trees	4	4	0
Coniferous Trees	2	2	0
Onsite Tree Totals	<u>6</u>	<u>6</u>	<u>0</u>
Onsite Replacement Trees Proposed	12	2	
Total Onsite Retained and Replacement Trees	12	1	

The Arborist Assessment states that there are a total of 6 bylaw protected trees on the site. The proposed tree retention was assessed taking into consideration the location of services, building footprints, road dedication and proposed lot grading.

- For those trees that cannot be retained, the applicant will be required to plant trees on a 1 to 1 replacement ratio for Alder and Cottonwood trees, and a 2 to 1 replacement ratio for all other trees. This will require a proposed total of 12 replacement trees on the site. The applicant is proposing 12 replacement trees, meeting City requirements.
- In addition to the replacement trees, boulevard street trees will be planted on 138 Street and 107A Avenue. This will be determined by the Engineering Department during the servicing design review process.
- The new trees on the site will consist of a variety of trees including Fullmoon Maple, Autumn Brilliance Serviceberry, The Rising Sun Redbud, Gold Spire Maidenhair, Ruby Vase Persian Ironwood, Bruns Serbian Spruce, Orangebark Stewartia and Snowcone Japanese Snowbell.
- In summary, a total of 12 trees are proposed to be retained or replaced on the site with no contribution to the Green City Program.

CITY ENERGY

- The subject site is located within Service Area A, as defined in the "City Centre District Energy System By-law" (see Appendix X for location). The District Energy System consists of three primary components:
 - o community energy centres, City-operated facilities that generate thermal energy for distribution through a piped hot water network;
 - o distribution piping that links the community energy centres with buildings connected to the system; and
 - o City-owned energy transfer stations (ETS) located within the building connected to the system. The ETS transfers heat energy from the distribution system to the building's mechanical system, and is used to meter the amount of energy used.

- All new developments within Service Area A with a build-out density equal to or greater than a floor area ratio (FAR) of 1.0 will be required to provide hydronic thermal energy systems in support of the City's District Energy (DE) system including domestic hot water, make-up air units and in-suite hydronic space heating. The City is committed to having the DE system operational within the timeframe of this project. Therefore, the subject application will be required to connect to the City's DE system prior to occupancy.
- In order to avoid conflicts between the District Energy System and other utilities, the location of the ETS and related service connections are confirmed by Engineering and the applicant at the servicing agreement stage. The Engineering Department also requires the applicant to register a statutory right-of-way and Section 219 Restrictive Covenant over the subject site for the following purposes:
 - o City access to, and maintenance and operation of, the ETS within the building and any infrastructure between the building and the property line; and
 - o to prevent conflicts with other utilities.
- Prior to the issuance of a building permit, the Engineering Department will confirm that the applicant has met the requirements of the "City Centre District Energy System By-law".

INFORMATION ATTACHED TO THIS REPORT

The following information is attached to this Report:

Appendix I. Proposed Subdivision Layout, Site Plan, Building Elevations, Landscape Plans

and Perspective

Appendix II. Engineering Summary
Appendix III. School District Comments

Appendix IV. Summary of Tree Survey, Tree Preservation and Tree Plans

Appendix V. OCP Redesignation Map

approved by Shawn Low

Ron Gill Acting General Manager Planning and Development

CL/ar

6-STOREY MULTI-RESIDENTIAL RENTAL BUILDING 10713/10707/10695 - 138 STREET SURREY

CIVIC ADDRESS: # 10713,#10707, #10695 138 STREET SURREY

LEGAL DESCRIPTION: LOTS 1 & 2 PLAN 14218, LOT 1 11662

ALL OF SEC 23 BLOCK 5 NORTH RANGE 2 WEST NWD

EXISTING ZONE: RF PROPOSED ZONE: CD

GROSS SITE AREA 2156.80m² NET SITE AREA 2045.46m²

	Sheet List				
Sheet Number	Sheet Name				
A00	COVER PAGE				
A01	SITE PLAN				
A02	SITE INFO. & SURVEY PLAN				
A03	FIRE FIGHTER ACCESS PLAN				
A04	BASE PLAN				
A05	FLOOR AREA OVERLAY				
A05a	FLOOR AREA OVERLAY				
A06	PROJECT DATA				
A07	CONTEXT PLAN				
A08	STREETSCAPE SECTION				
A09	SETBACK SECTIONS & STREET INTERFACE				
A10	3D VIEWS				
A11	MASSING STUDIES & MATERIALS				
A12	SHADOW ANALYSIS				
A13	DESIGN CONSEPTS & PRECENDENT				
A14	DESIGN CONSEPTS & PRECENDENT				
A201	PARKING LEVEL 2				
A202	PARKING LEVEL 1				
A203	LEVEL 1 FLOOR PLANS				
A204	LEVEL 2-5 FLOOR PLANS				
A205	LEVEL 6 FLOOR PLAN				
A206	ROOF DECK PLAN				
A207	1-BEDROOM UNIT TYPES				
A208	2/3-BEDROOM UNIT TYPES & INDOOR AMENITY				
A300	WEST ELEVATION				
A301	NORTH ELEVATION				
A302	SOUTH ELEVATION				
A303	EAST ELEVATION				
A304	ENLARGED ENTRANCE LOBBY AND UNIT ENTRANCES				
A400	CROSS SECTION				
A401	LONGITUDINAL SECTION				
A402	SITE SECTIONS				







MATTHEW CHENG ARCHITECT INC.

Unit 202 - 670 EVANS AVENUE VANCOUVER, BC V6A 2K9 Tel: (604) 731-3021 / Fax: (604) 731-3908 Cel: (604) 649-0669 / Email: matthew@mcal.c

THIS DRAWING MUST NOT BE SCALED. THE GENERAL CONTRACTOR SHALL VERIFY

GENERAL CONTRACTOR SHALL VERIFY ALL
JIMENSIONS AND LEVELS PRIOR TO
COMMENCEMENT TO WORK. ALL
ERRORS AND OMISSIONS SHALL BE
ERRORS AND OMISSIONS SHALL BE
ARCHITECT. CONTRIGHT RESERVED.
THIS PLAN AND DESIGN ARE AND AT ALL
TIMES REALANT HE EXCLUSIVE
PROPERTY OF MATTHEW OF HEND
ARCHITECT IN CAM DMY NOT BE USED
OF RETPRODUCED WITHOUT PRIOR
WITTEN COMES.

No.	Date	
1	2024-09-19	DRG RESUBMISSION



Project Title

6-STOREY MULTI-RESIDENTIAL RENTAL

10695/10713/10707 138 Street, Surrey

Sheet Title


COVER PAGE


zwn:	RNO	
ecked	MC	
ale:	1/32" = 1'-0"	

Project Number: 23SAP01

Print Date:

A00

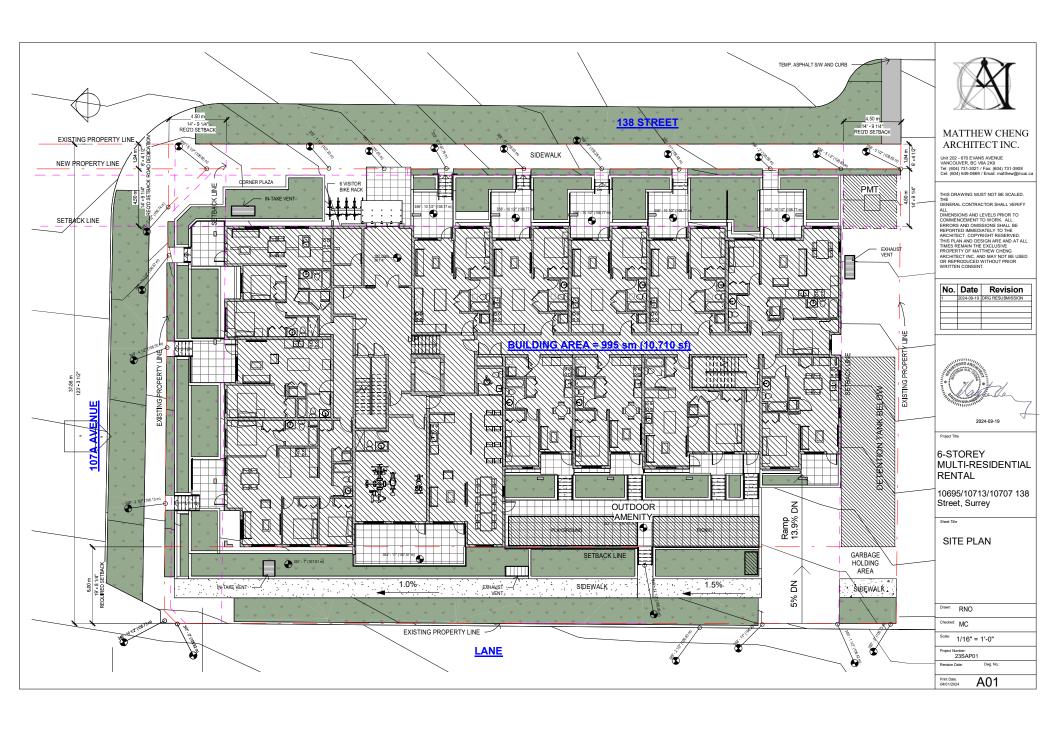

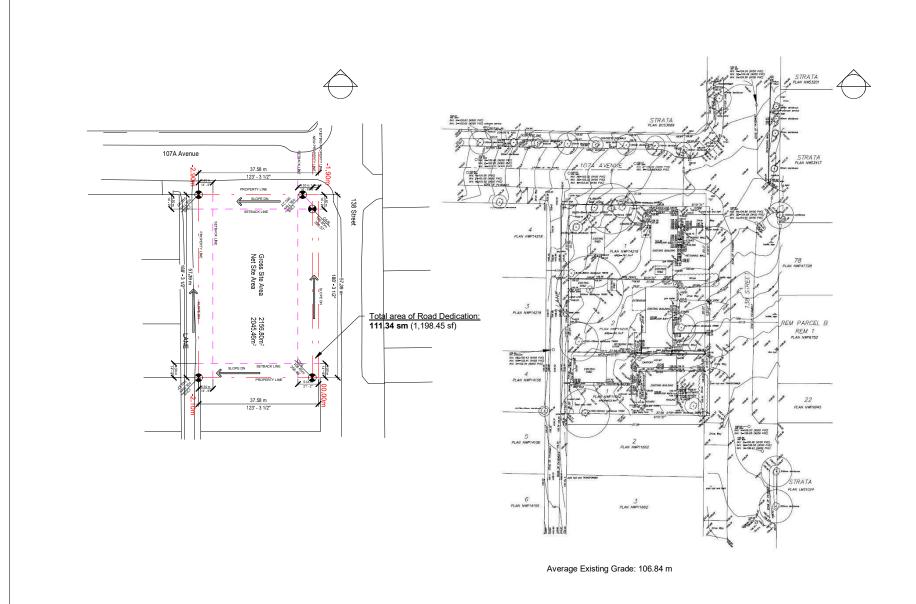



MATTHEW CHENG ARCHITECT INC.

Unit 202 - 670 EVANS AVENUE VANCOUVER, BC V6A 2K9 Tel: (604) 731-3021 / Fax: (604) 731-3908 Cel: (604) 649-0669 / Email: matthew@mcai.

THIS DRAWING MUST NOT BE SCALED. THE GENERAL CONTRACTOR SHALL VERIFY

GENERAL CONTRACTOR SHALL VERIFY ALL
DIMENSIONS AND LEVELS PRIOR TO
COMMENCEMENT TO WORK. ALL
ERRORS AND OMISSIONS SHALL BE
ERRORS THE SECULISIVE
PROPERTY OF MATTHEW OF BEING
OR REPRODUCED WITHOUT PRIOR
WRITTEN COMES BY!

No.	Date	
1	2024-09-19	DRG RESUBMISSION



6-STOREY MULTI-RESIDENTIAL RENTAL

10695/10713/10707 138 Street, Surrey

SITE INFO. & SURVEY PLAN


Drawn: RNO

Checked: MC

Scale: 1/64" = 1'-0"

Project Number: 23SAP01

A02

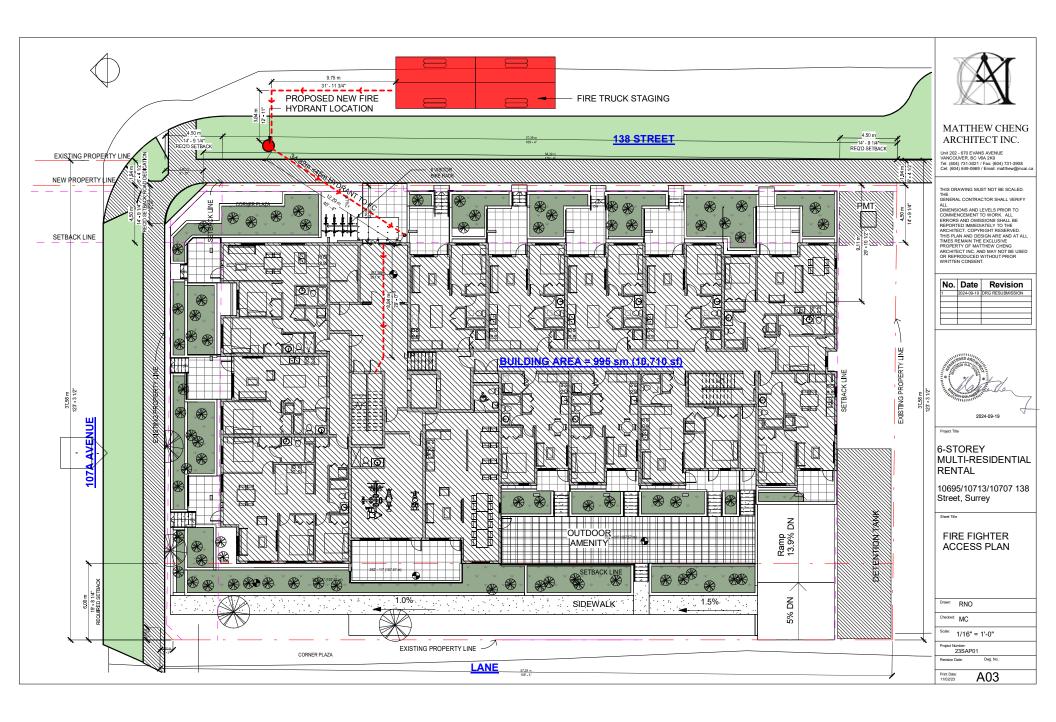

	AREA T	ABULATIONS	;			AREA 1	TABULATIONS	3			AREA T	TABULATIONS	i	
Level	Name	Number	Area	Count	Level	Name	Number	Area	Count	Level	Name	Number	Area	Co
Level 1					Level 3					Level 5				
1 BR					1 BR		_			1 BR				_
Level 1	1 BR	103	542 ft ²	1	Level 3	1 BR	314	545 ft ²	1	Level 5	1 BR	514	545 ft ²	1
Level 1 Level 1	1 BR 1 BR	113	487 ft² 486 ft²	1	Level 3	1 BR	(Adaptable)	623 ft²	1	Level 5	1 BR	(Adaptable)	623 ft ²	1
	1 BR	110	557 ft ²	1	Level 3	1 BR	309	486 ft²	1	Level 5	1 BR	509	486 ft²	1
Level 1	I DK	(Adaptable)	1007 IL		Level 3	1 BR	308	497 ft ²	1	Level 5	1 BR	508	497 ft ²	1
Level 1	1 BR	108	526 ft ²	1	Level 3	1 BR	305	526 ft ²	1	Level 5	1 BR	505	526 ft²	1
Level 1	1 BR	106	526 ft ²	1	Level 3	1 BR	303	526 ft ²	1	Level 5	1 BR	503	526 ft ²	1
Level 1	1 BR	105	526 ft ²	1	Level 3	1 BR	304	526 ft ²	1	Level 5	1 BR	504	526 ft ²	1
Level 1	1 BR	107	526 ft ²	1	Level 3	1 BR	310	487 ft ²	1	Level 5	1 BR	510	487 ft ²	1
1 BR: 8			4175 ft ²	8	Level 3	1 BR	302	526 ft ²	1	Level 5	1 BR	502	526 ft ²	1
1 BR + D					Level 3	1 BR	301	482 ft²	1	Level 5	1 BR	501	482 ft ²	1
Level 1	1 BR + D	111	578 ft²	1	1 BR: 10			5222 ft ²	10	1 BR: 10			5222 ft ²	10
1 BR + D: 1			578 ft²	1	2 BR					2 BR				
2 BR					Level 3	2 BR	315	759 ft²	1	Level 5	2 BR	515	759 ft²	1
Level 1	2 BR	104	757 ft²	1	Level 3	2 BR	311	763 ft ²	1	Level 5	2 BR	511	763 ft²	1
Level 1	2 BR	109	823 ft²	1	Level 3	2 BR	307	753 ft²	1	Level 5	2 BR	507	753 ft²	1
2 BR: 2			1580 ft²	2	Level 3	2 BR	306	824 ft ²	1	Level 5	2 BR	506	824 ft ²	1
3 BR					2 BR: 4			3099 ft ²	4	2 BR: 4			3099 ft ²	4
Level 1	3 BR	102 (Adaptable)	1050 ft²	1	3 BR Level 3	3 BR	313	1047 ft²	1	3 BR Level 5	3 BR	513	1047 ft²	1
3 BR: 1 AMENITY			1050 ft²	1	3 BR: 1	l o bit	(Adaptable)	1047 ft²	1	3 BR: 1	0.5.1	(Adaptable)	1047 ft²	<u> </u>
Level 1	AMENITY	101	1263 ft²	1	COMMON AREA	e		1047 11	'	COMMON AREAS	,		1047 11	'
AMENITY: 1	AMENIT	101	1263 ft²	1	Level 3	COMMON	300	1271 ft²	14	Level 5	COMMON	500	1271 ft²	1
COMMON AREA	s		1203 11	1	Level 3	AREAS	300	12/11		Level 5	AREAS	500	12/11	'
Level 1	COMMON	100	2017 ft²	1	COMMON AREA	S: 1		1271 ft²	1	COMMON AREAS	S: 1		1271 ft²	1
201011	AREAS	1.00	2011 11	1' 1	Level 3: 16			10639 ft ²	16	Level 5: 16			10639 ft ²	16
COMMON AREA	S: 1		2017 ft ²	1	Level 4					Level 6				
Level 1: 14			10664 ft ²	14	1 BR					1 BR				
Level 2					Level 4	1 BR	414	545 ft ²	1	Level 6	1 BR	614	436 ft²	1
1 BR					Level 4	1 BR	412	623 ft²	1	Level 6	1 BR	612	621 ft ²	1
Level 2	1 BR	214	545 ft ²	1			(Adaptable)					(Adaptable)		
Level 2	1 BR	212	623 ft ²	1	Level 4	1 BR	409	486 ft²	1	Level 6	1 BR	609	486 ft²	1
		(Adaptable)			Level 4	1 BR	408	497 ft ²	1	Level 6	1 BR	608	497 ft ²	1
Level 2	1 BR	209	486 ft ²	1	Level 4	1 BR	405	526 ft ²	1	Level 6	1 BR	605	526 ft ²	1
Level 2	1 BR	208	497 ft ²	1	Level 4	1 BR	403	526 ft ²	1	Level 6	1 BR	603	526 ft ²	1
Level 2	1 BR	205	526 ft²	1	Level 4	1 BR	404	526 ft ²	1	Level 6	1 BR	604	526 ft ²	1
Level 2	1 BR	203	526 ft ²	1	Level 4	1 BR	410	487 ft²	1	Level 6	1 BR	610	487 ft²	1
Level 2	1 BR	204	526 ft²	1	Level 4	1 BR	402	526 ft²	1	Level 6	1 BR	602	526 ft²	1
Level 2	1 BR	210	487 ft ²	1	Level 4	1 BR	401	482 ft ²	1	Level 6	1 BR	601	482 ft ²	1
Level 2	1 BR	202	526 ft²	1	1 BR: 10			5222 ft ²	10	1 BR: 10			5112 ft²	10
Level 2	1 BR	201	488 ft²	1	2 BR	10.00	1	THEN 6"		2 BR	10.00	10.00	1000 5	
1 BR: 10			5228 ft²	10	Level 4	2 BR	415	759 ft²	1	Level 6	2 BR	615	603 ft ²	1
2 BR					Level 4	2 BR	411	763 ft²	1	Level 6	2 BR	611	762 ft²	1
_evel 2	2 BR	215	780 ft ²	1	Level 4	2 BR	407	753 ft²	1	Level 6	2 BR	607	753 ft²	1
Level 2	2 BR	211	763 ft²	1	Level 4	2 BR	406	824 ft ²	1	Level 6	2 BR	606	824 ft²	1
Level 2	2 BR	207	753 ft²	1	2 BR: 4			3099 ft ²	4	2 BR: 4			2942 ft ²	4
Level 2	2 BR	206	824 ft ²	1	3 BR					3 BR				
2 BR: 4			3120 ft ²	4	Level 4	3 BR	413	1047 ft ²	1	Level 6	3 BR	613	870 ft ²	1
3 BR					0.00		(Adaptable)	4047.62	لسبل	3 BR: 1			870 ft ²	1
Level 2	3 BR	(Adaptable)	1047 ft²	1	3 BR: 1 COMMON AREA	S		1047 ft²	1	COMMON AREAS	COMMON	1600	1272 ft²	11
3 BR: 1	0	1	1047 ft²	1	Level 4	COMMON AREAS	400	1271 ft²	1		AREAS			Ĺ
COMMON AREA		1000			COMMON AREA			1271 B2	لسبل	COMMON AREAS	5: 1		1272 ft²	1
Level 2	COMMON	200	1244 ft²	1		io. I		1271 ft²	10	Level 6: 16			10195 ft²	16
COMMONANCE			1244 82	لــــــــــــــــــــــــــــــــــــــ	Level 4: 16			10639 ft ²	16	Grand total: 94			63416 ft²	94
COMMON AREA	io: 1		1244 ft²	1	LOT COVERAGE O	COMPUTATION:			Γ	ADAPTABLE UNITS CO	MPUTATION:		1	
_evel Z: 16			10039 TC	10			124 EE m2					NITE		
					NET SITE AREA:	2,0	045.46 m²			REQUIRED: 87 UNITS 2	< 10% = 8.7 UNIT	S (9 UNITS)		
Level 2: 16			10639 ft²	16	LOT COVERAGE A	AREA: 1,2 2,0 1,224.55 / 2,045.46				REQUIREMENTS: 10%	OF DWELLING UI	S (9 UNITS)		

GROSS SITE AREA NET SITE AREA			
FLOOR AREA CALCULA	ATION:		
LEVEL 1 AREA LEVEL 2 AREA LEVEL 3 AREA LEVEL 4 AREA LEVEL 5 AREA LEVEL 6 AREA GROSS FLOOR AREA (10,664 sf 10,639 sf 10,639 sf 10,639 sf 10,639 sf 10,195 sf A) 63,416 sf	(5,891.54 m²)	
FAR EXEMPTIONS: REQUIRED INDOOR AN PROVIDED INDOOR AM	IENITY 8 IENITY (B)	7 x 3m ² = 261 1,26	m² 3 sf (117.34 m²)
NET FLOOR AREA (A-I	3) 62,153 sf	(5,774.20 m²)	
	68 2.82		
REQUIRED OUTDOOR / PROVIDED OUTDOOR / PROVIDED OUTDOOR /	AMENITY ON GROU	ND LEVEL	37X3m ² =261 m ² 278 m ² 497 m ²
PARKING SPACE CALC PARKING SPACE AND (
REQUIRED PARKING S PROVIDED PARKING S		0.9	x 87 = 78.3 83
REQUIRED VISITOR PA		0.	1 x 87 = 9 9
PARKING SPACES FOR REQUIRED:	PERSONS WITH D		X 0.02 = 1.74
PROVIDED INCLUDING	+ SPACE FOR VAN		2
TOTAL PARKING SPAC	ES REQUIRED: ES PROVIDED:	87 SPACES 92 SPACES	
ALLOWED SMALL CAR PROVIDED SMALL CAR		35%	%X 87 = 30.45 22
REQUIRED BICYCLE SF 1.2 SPACE FOR EACH I + 6 PER MULTIPLE UN PROVIDED BICYCLE SI	JNIT IIT RESIDENTIAL BU	JILDING 87 x	1.2 = 104 + 6 = 110
UNIT MIX	CSUMMARY		

UNIT MIX SUMMARY					
			UNIT T	YPE	
LEVEL	1 BR	1 BR+D	2 BR	3 BR	TOTAL
LEVEL 1	8	1	2	1	12
LEVEL 2	10	-	4	1	15
LEVEL 3	10	-	4	1	15
LEVEL 4	10	-	4	1	15
LEVEL 5	10	-	4	1	15
LEVEL 6	10	-	4	1	15
TOTAL	58	1	22	6	87
	66.67%	1.15%	25.28%	6.90%	
	67.8	32%	32.1	8%	100%



MATTHEW CHENG ARCHITECT INC.

Unit 202 - 670 EVANS AVENUE VANCOUVER, BC V6A 2K9 Tel: (604) 731-3021 / Fax: (604) 731-3908 Cel: (604) 649-0669 / Email: matthew@mcal.ca

THIS DRAWING MUST NOT BE SCALED.
THE
GENERAL CONTRACTOR SHALL VERIFY

GENERAL CONTRACTOR SHALL VERIFY ALL
DIMENSIONS AND LEVELS PRIOR TO
COMMENCEMENT TO WORK. ALL
ERRORS AND OMISSIONS SHALL BE
ERRORS THE SECULIARY BE
PROPERTY OF MATTHEW OF BEING
OR REPRODUCED WITHOUT PRIOR
WRITTEN COMES BY!

No.		Revision
1	2024-09-19	DRG RESUBMISSION
	1	I



6-STOREY MULTI-RESIDENTIAL RENTAL

10695/10713/10707 138 Street, Surrey


PROJECT DATA

Drawn: RNO Checked: MC Scale: 1/32" = 1'-0" Project Number: 23SAP01

Dwg. No.:

A06

Revision Date:

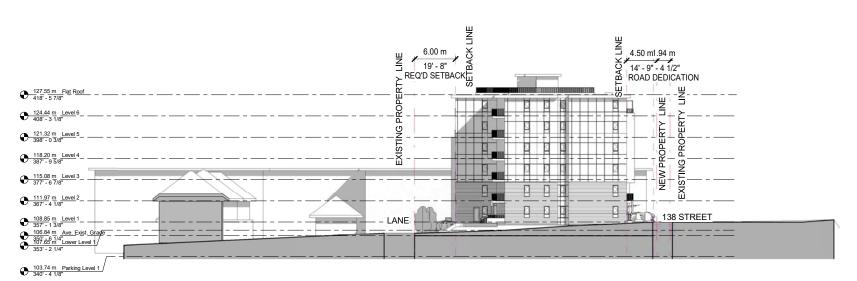

1" = 30'-0"



2 LONGITUDINAL SECTION -STREETSCAPE 1" = 30'-0"



MATTHEW CHENG ARCHITECT INC.

Unit 202 - 670 EVANS AVENUE VANCOUVER, BC V6A 2K9 Tel: (604) 731-3021 / Fax: (604) 731-3908 Cel: (604) 649-0669 / Email: matthew@mcai.c

THIS DRAWING MUST NOT BE SCALED. THE GENERAL CONTRACTOR SHALL VERIFY

No.	Date	Revision
1	2024-09-19	DRG RESUBMISSION
_		
_		



Project Title

6-STOREY MULTI-RESIDENTIAL RENTAL

10695/10713/10707 138 Street, Surrey

Sheet Ti

STREETSCAPE SECTION

Drawn: RNO

Checked: MC


Scale: 1" = 30'-0"

Project Number: 23SAP01


23SAP01

Revision Date: Dwg.


ate: A08

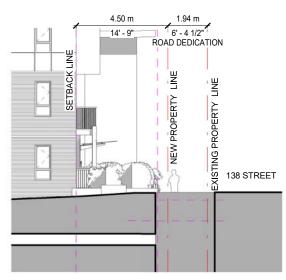


1 RATIONAL SECTION/CROSS 1" = 10'-0"

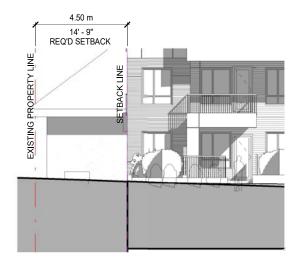

4 LONGITUDINAL SECTION -RATIONAL 1" = 10'-0"

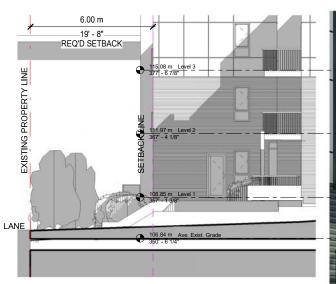

2 RATIONAL SECTION /CROSS 1" = 10'-0"

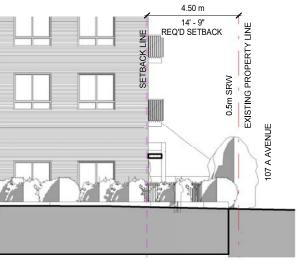

5 LONGITUDINAL SECTION -RATIONAL Copy 1
1" = 10'-0"



ARCHITECT INC.

Unit 202 - 670 EVANS AVENUE
VANCOUVER, BC V6A 2K9
Tel: (604) 731-3908
Cel: (604) 649-0669 / Email: matthew@mcai.

THIS DRAWING MUST NOT BE SCALED. THE GENERAL CONTRACTOR SHALL VERIFY

GENERAL CONTRACTOR SHALL VERIFY ALL
MINISTORM SHALL VERIFY ALL
MINISTORM SHALL BE
GENERAL SHALL SHALL SHALL BE
GENERAL SHALL SHALL SHALL SHALL BE
GENERAL SHALL SHA

No.	Date	Revision
1	2024-09-19	DRG RESUBMISSION



Project Title

6-STOREY MULTI-RESIDENTIAL RENTAL

10695/10713/10707 138 Street, Surrey

Sheet Tr

SETBACK SECTIONS & STREET INTERFACE

zwn:	RNO

Checked: MC

1" = 10'-0"


Project Number: 23SAP01

23SAP01 tevision Date: Dr


Date: A09



3 UNIT ENTRANCE VIEW

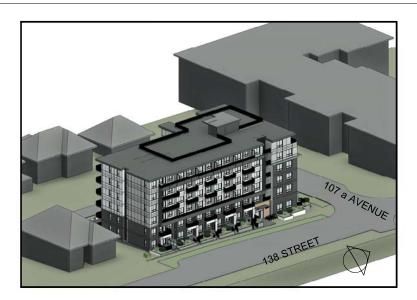


2 South-East View

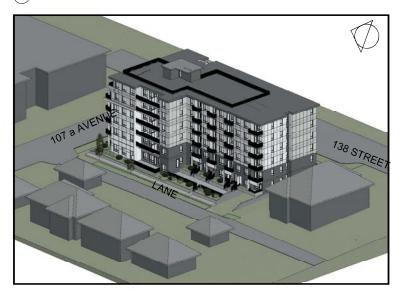

3 South-West View



1 North-East Veiw

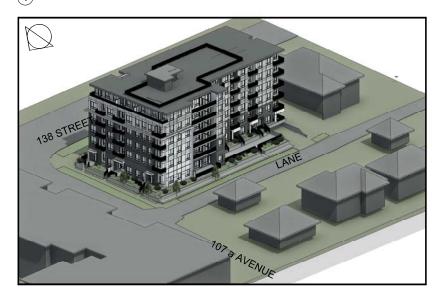

4 North-West View



MATTHEW CHENG ARCHITECT INC.

Unit 202 - 670 EVANS AVENUE VANCOUVER, BC V6A 2K9 Tel: (604) 731-3021 / Fax: (604) 731-3908 Cel: (604) 649-0669 / Email: matthew@mcai

THIS DRAWING MUST NOT BE SCALED. THE GENERAL CONTRACTOR SHALL VERIFY

GENERAL CONTRACTOR SHALL VERIFY ALL
DIMENSIONS AND LEVELS PRIOR TO
COMMENCEMENT TO WORK. ALL
ERRORS AND OMISSIONS SHALL BE
ERRORS THE SECULIARY BE
PROPERTY OF MATTHEW OF BEING
OR REPRODUCED WITHOUT PRIOR
WRITTEN COMES BY!

No.	Date	Revision
1	2024-09-19	DRG RESUBMISSION



6-STOREY MULTI-RESIDENTIAL RENTAL

10695/10713/10707 138 Street, Surrey

3D VIEWS

Drawn: RNO Checked: MC

Project Number: 23SAP01

A10

EXTERIOR FINISHES

M01:EXTERIOR WALLS FIBRE CEMENT BOARD CEDARMILL TEXTURE MIDNIGHT BLACK

ARCTIC WHITE

M02: EXTERIOR, FASCIA, WALLS AND BELTS FIBRE CEMENT BOARD SMOOTH TEXTURE

M03:EXTERIOR WALLS
HARDIE PLANK, LAP SIDING
BEADED CEDARMILL
SMOOTH TEXTURE
LIGHT MIST



M07: MAIN ENTRANCE WALL FAUX WOOD METAL PANEL, HEMLOCK OR EQUIVALENT

THE EXTENDED WHITE WALLS FROM

LEVEL 3 TO LEVEL 5 EFFECTIVELY

BREAK HORIZONTAL MASS OF THE

BUILDING AND KEEP THE RHYTHM



M06: BUILT-UP WALLS, EXTERIOR

WALLS, ROOF FASCIA, SOFFITS

FIBRE CEMENT BOARD

SMOOTH TEXTURE

IRON GRAY





MATTHEW CHENG ARCHITECT INC.

Unit 202 - 670 EVANS AVENUE VANCOUVER, BC V6A 2K9 Tel: (604) 731-3021 / Fax: (604) 731-3908 Cel: (604) 649-0669 / Email: matthew@mcai.ca

THIS DRAWING MUST NOT BE SCALED. THE GENERAL CONTRACTOR SHALL VERIFY

No.	Date	Revision
1	2024-09-19	DRG RESUBMISSION
		I



Project Title

6-STOREY MULTI-RESIDENTIAL RENTAL

10695/10713/10707 138 Street, Surrey

eet Title


MASSING STUDIES & MATERIALS

Drawn: RNO
Checked: MC

Scale: 1/16" = 1'-0"
Project Number:


Project Number: 23SAP01 Revision Date: Dwg. No.

Print Date: A11

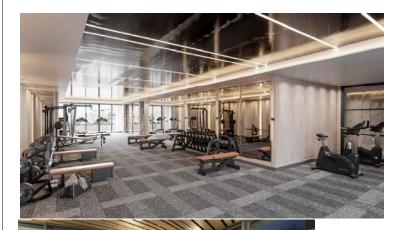



OUTDOOR AMENITIES

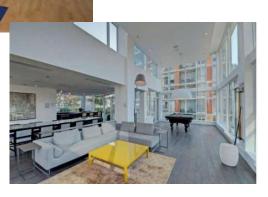

INDOOR AMENITIES



LOBBY



MATTHEW CHENG ARCHITECT INC.

Unit 202 - 670 EVANS AVENUE VANCOUVER, BC V6A 2K9 Tel: (604) 731-3021 / Fax: (604) 731-3908 Cel: (604) 649-0669 / Email: matthew@mcai.

THIS DRAWING MUST NOT BE SCALED.
THE
GENERAL CONTRACTOR SHALL VERIFY

GENERAL CONTRACTOR SHALL VERIFY ALL
DIMENSIONS AND LEVELS PRIOR TO
COMMENCEMENT TO WORK. ALL
ERRORS AND OMISSIONS SHALL BE
ERRORS THE SECULIARY BE
PROPERTY OF MATTHEW OF BEING
OR REPRODUCED WITHOUT PRIOR
WRITTEN COMES BY!

No.	Date	
1	2024-09-19	DRG RESUBMISSION



Project Title

6-STOREY MULTI-RESIDENTIAL RENTAL

10695/10713/10707 138 Street, Surrey

Sheet Ti

DESIGN CONSEPTS & PRECENDENT

Drawn: RNO

Checked: MC


Scale:

Project Number: 23SAP01

Revision Date: Dwg. No.:

t Date: A1

A14

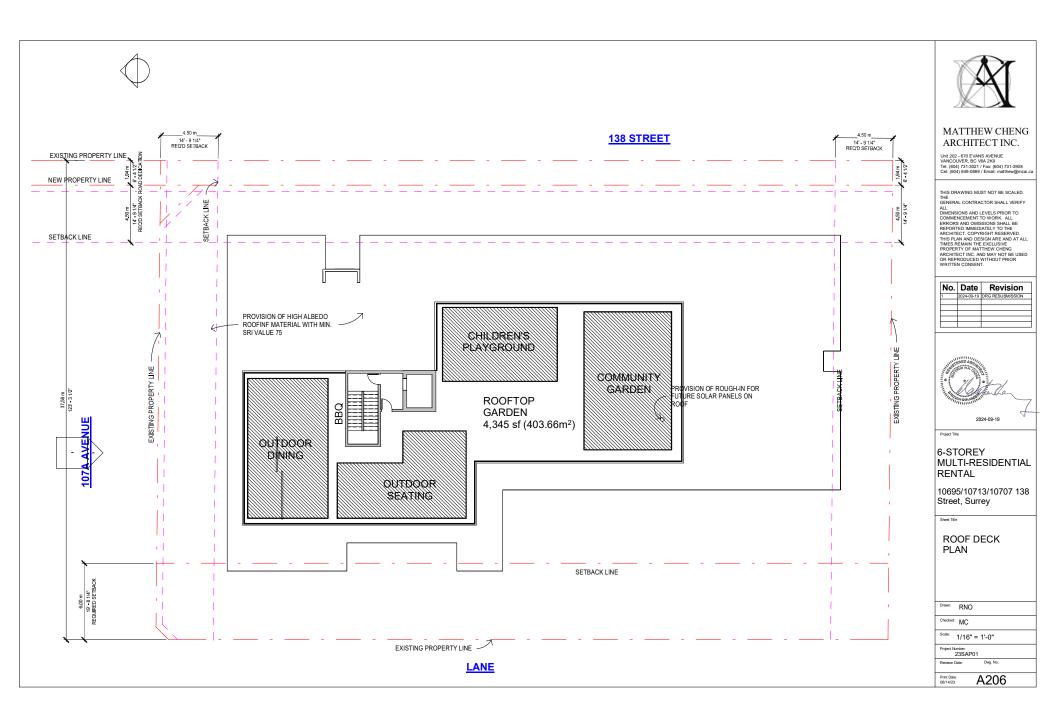





2 A-2 ADAPTABLE 1-BEDROOM (561sf) 3/32" = 1'-0"



3 A-3 1-BEDROOM (582 sf) 3/32" = 1'-0"



4 A-4 1-BEDROOM (488 sf) 3/32" = 1'-0"



MATTHEW CHENG ARCHITECT INC.

Unit 202 - 670 EVANS AVENUE VANCOUVER, BC V6A 2K9 Tel: (604) 731-3021 / Fax: (604) 731-3908 Cel: (604) 649-0669 / Email: matthew@mcai.ca

THIS DRAWING MUST NOT BE SCALED. THE GENERAL CONTRACTOR SHALL VERIFY

GENERAL CONTRACTOR SHALL VERIFY ALL
DIMENSIONS AND LEVELS PRIOR TO
COMMENCEMENT TO WORK. ALL
ERRORS AND OMISSIONS SHALL BE
ERRORS THE SECULIARY BE
PROPERTY OF MATTHEW OF BEING
OR REPRODUCED WITHOUT PRIOR
WRITTEN COMES BY!

1	2024-09-19	DRG RESUBMISSION



Project Title

6-STOREY MULTI-RESIDENTIAL RENTAL

10695/10713/10707 138 Street, Surrey

Sheet T

1-BEDROOM UNIT TYPES

Drawn: RNO

Checked: MC

Scale: As indicated

Project Number: 23SAP01

23SAP01 ision Date: Dwg. No.:

A207



6 A-6 1-BEDROOM (496 sf) 3/32" = 1'-0"


-BEDROOM



7 A-7 1-BEDROOM (622 sf) 1/16" = 1'-0"



8 A-8 1-BEDROOM (499 sf) 1/16" = 1'-0"

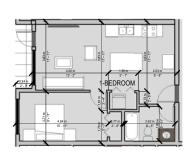


5 A-5 1-BEDROOM (544 sf) 3/32" = 1'-0"



1 B-1 2-BEDROOM (765 sf) 3/32" = 1'-0"



B-2 2-BEDROOM (830 sf) 3/32" = 1'-0"

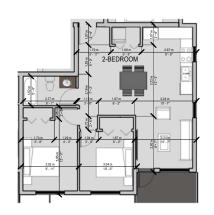

B-3 2-BEDROOM (759 sf) 3/32" = 1'-0"



4 B-4 2-BEDROOM (787 sf) 3/32" = 1'-0"




MATTHEW CHENG ARCHITECT INC.

Unit 202 - 670 EVANS AVENUE VANCOUVER, BC V6A 2K9 Tel: (604) 731-3021 / Fax: (604) 731-3908 Cel: (604) 649-0669 / Email: matthew@mcai.c

THIS DRAWING MUST NOT BE SCALED. THE GENERAL CONTRACTOR SHALL VERIFY

GENERAL CONTRACTOR SHALL VERIFY ALL
DIMENSIONS AND LEVELS PRIOR TO
COMMENCEMENT TO WORK. ALL
ERRORS AND OMISSIONS SHALL BE
ERRORS THE SECULIARY BE
PROPERTY OF MATTHEW OF BEING
OR REPRODUCED WITHOUT PRIOR
WRITTEN COMES BY!

No.	Date	Revision
	2024-09-19	DRG RESUBMISSION

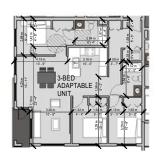


6 C-1 ADAPTABLE (1054 sf) 1/16" = 1'-0"



(5) B-5 2-BEDROOM+DEN (767 sf) 1/16" = 1'-0"



7 INDOOR AMENITY (1320 sf) 3/32" = 1'-0"

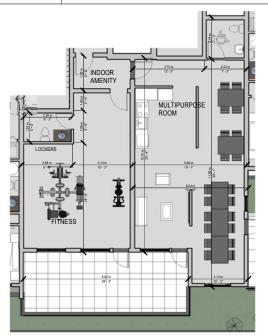



6-STOREY MULTI-RESIDENTIAL RENTAL

10695/10713/10707 138 Street, Surrey

2/3-BEDROOM **UNIT TYPES &** INDOOR AMENITY

Drawn: RNO

Checked: MC


Scale: As indicated

Project Number: 23SAP01

A208





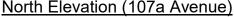



MATTHEW CHENG ARCHITECT INC.

Unit 202 - 670 EVANS AVENUE VANCOUVER, BC V6A 2K9 Tel: (604) 731-3021 / Fax: (604) 731-3908 Cel: (604) 649-0669 / Email: matthew@mcai.

THIS DRAWING MUST NOT BE SCALED. THE GENERAL CONTRACTOR SHALL VERIFY

GENERAL CONTRACTOR SHALL VERIFY ALL LIBRATIONS AND LEVELS PRIOR TO COMMENCEMENT TO WORK, ALL EDITOR TO COMMENCEMENT TO WORK, ALL ESTEPPORTED MIMEDIATELY TO THE ARCHITECT, COPYRIGHT RESERVED. THIS PLAN AND DESIGN ARE DATE ALL THE SECULIARY OF MATTHEW CHEM'S ARCHITECT FOR AND MAY NOT BE USED OF REPRODUCED WITHOUT PRIOR WITHO

No.	Date	Revision
1	2024-09-19	DRG RESUBMISSION
_		
_		



6-STOREY MULTI-RESIDENTIAL RENTAL

10695/10713/10707 138 Street, Surrey

NORTH **ELEVATION**

Drawn: RNO Checked: MC Scale: 1/16" = 1'-0"

23SAP01

A301

North Elevation (107a Avenue)



SOUTH ELEVATION



MATTHEW CHENG ARCHITECT INC.

Unit 202 - 670 EVANS AVENUE VANCOUVER, BC V6A 2K9 Tel: (604) 731-3021 / Fax: (604) 731-3908 Cel: (604) 649-0669 / Email: matthew@mcai.c

THIS DRAWING MUST NOT BE SCALED. THE GENERAL CONTRACTOR SHALL VERIFY

GENERAL CONTRACTOR SHALL VERIFY ALL
MINISTORM SHALL VERIFY ALL
MINISTORM SHALL BE
GENERAL SHALL SHALL SHALL BE
GENERAL SHALL SHALL SHALL SHALL BE
GENERAL SHALL SHA

No.	Date	Revision
1	2024-09-19	DRG RESUBMISSION



6-STOREY MULTI-RESIDENTIAL RENTAL

10695/10713/10707 138 Street, Surrey

SOUTH **ELEVATION**

Drawn: RNO Checked: MC Scale: 1/16" = 1'-0"

23SAP01

A302

M07: MAIN ENTRANCE WALL FAUX WOOD METAL PANEL, HEMLOCK OR EQUIVALENT

SMOOTH TEXTURE

IRON GRAY BY

WALLS, ROOF FASCIA, SOFFITS FIBRE CEMENT BOARD

M01:EXTERIOR WALLS

CEDARMILL TEXTURE MIDNIGHT BLACK

FIBRE CEMENT BOARD SMOOTH TEXTURE ARCTIC WHITE

M03:EXTERIOR WALLS

BEADED CEDARMILL

FIBRE CEMENT BOARD SMOOTH TEXTURE

SMOOTH TEXTURE RICH ESPRESSO M05:EXTERIOR WALLS

HARDIE PLANK, LAP SIDING BEADED CEDARMILL SMOOTH TEXTURE

M02: EXTERIOR, FASCIA, WALLS

VERTICAL SIDING FIBRE CEMENT BOARD


AND BELTS

LIGHT MIST M04:EXTERIOR WALLS HARDIE PLANK, LAP SIDING

LIGHT MIST






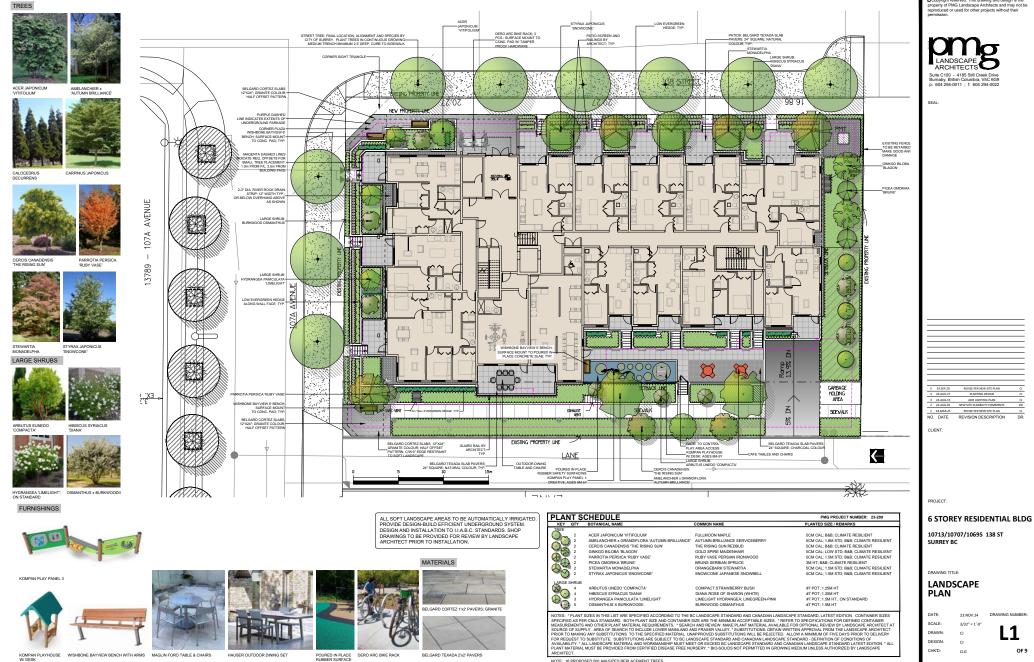

NOTE: 16 PROPOSED BYLAW-SIZED REPLACEMENT TREES.

pyright reserved. This drawing and design is the erty of PMG Landscape Architects and may not be aduced or used for other projects without their

CLG

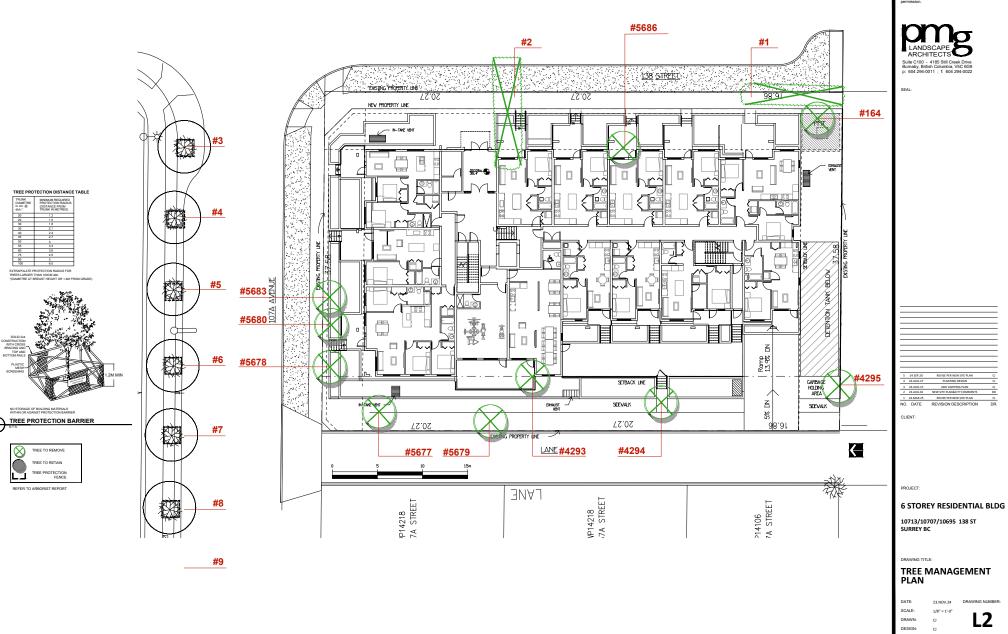


Ocopyright reserved. This drawing and design is the property of PMG Landscape Architects and may not be eproduced or used for other projects without their


CHKD: CLG


23209-6.ZIP PMG PROJECT NUMBER:

23-209

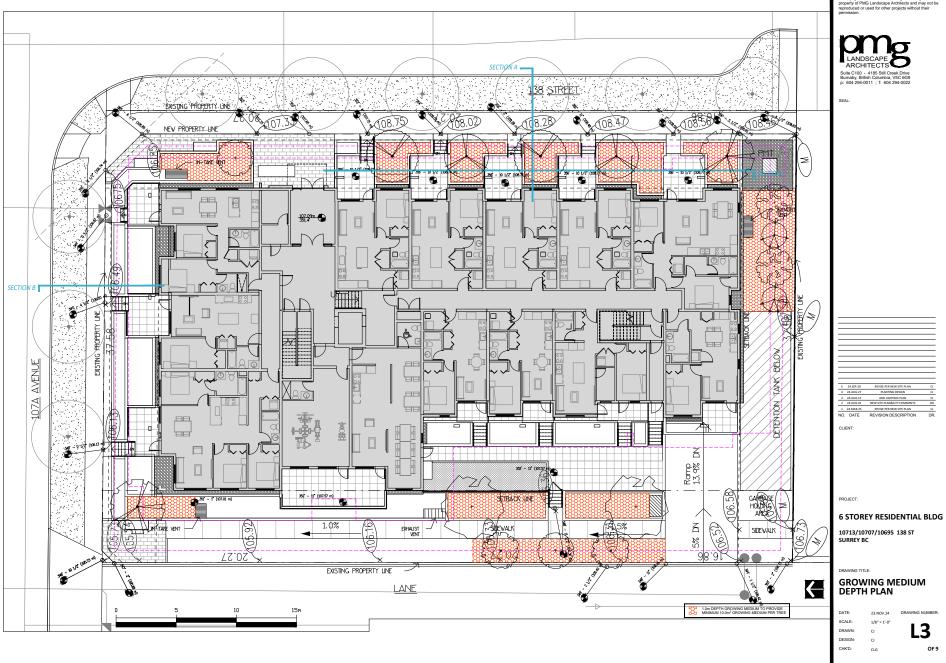

©Copyright reserved. This drawing and design is the property of PMG Landscape Architects and may not be reproduced or used for other projects without their

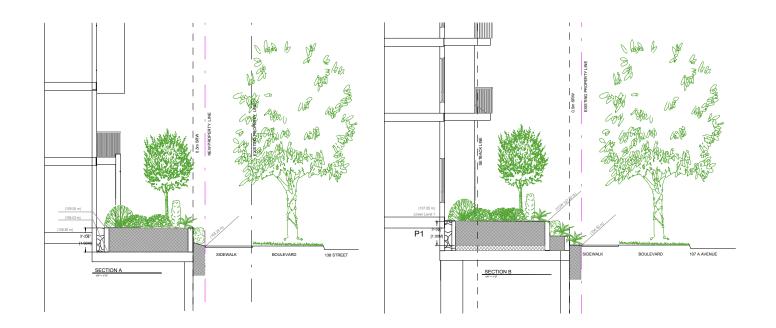

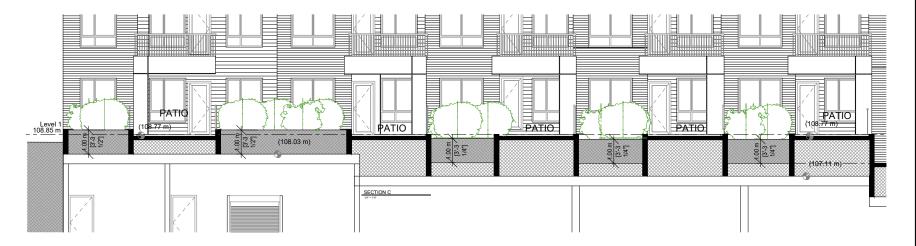

©Copyright reserved. This drawing and design is the property of PMG Landscape Architects and may not be reproduced or used for other projects without their



CLIENT:


6 STOREY RESIDENTIAL BLDG

10713/10707/10695 138 ST SURREY BC

LANDSCAPE SECTIONS

DATE:	23.NOV.24	DRAWING NUMBER:
SCALE:		
DRAWN:	CI	14
DESIGN:	CI	
CHKD:	CLG	OF 9

23-209

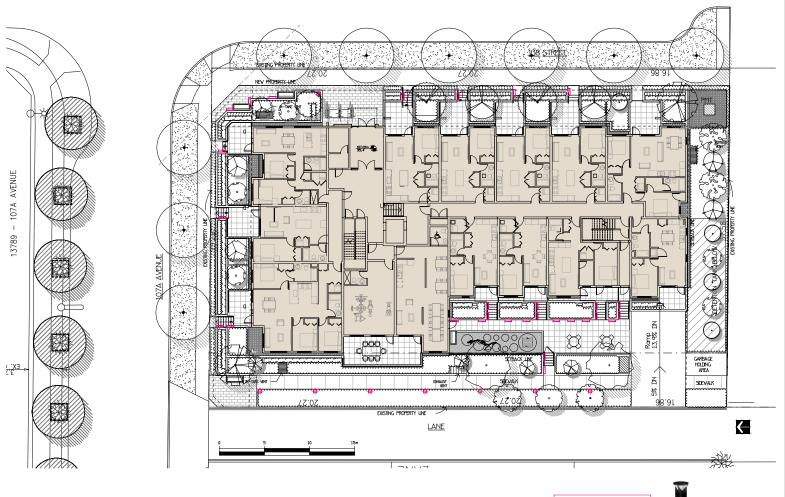

Copyright reserved. This drawing and design is the property of PMG Landscape Architects and may not be reproduced or used for other projects without their

ARCHITECTS

Suite C100 - 4185 Still Creek Drive
Burnaby, British Columbia, VSC 6G9
p: 604 294-0011 ; f: 604 294-0022

SEAL:

CLIENT:

PROJECT:

6 STOREY RESIDENTIAL BLDG


10713/10707/10695 138 ST SURREY BC

LANDSCAPE LIGHTING PLAN

DATE: SCALE: 3/32" = 1'-0" L5 DRAWN: DESIGN: CHKD: CLG

23-209

LIGHTING SUMMARY

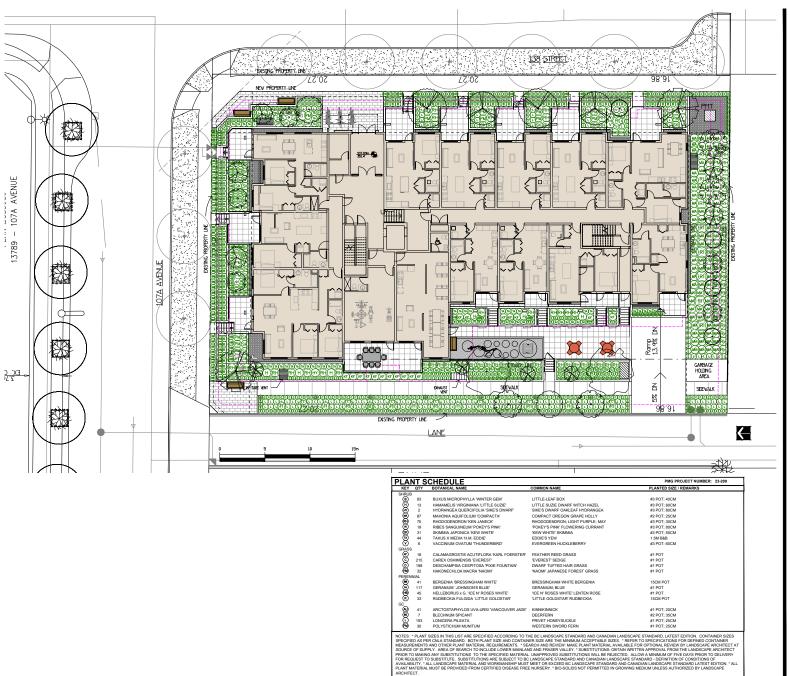

©Copyright reserved. This drawing and design is the property of PMG Landscape Architects and may not be reproduced or used for other projects without their

LANDSCAPE ARCHITECTS Suite C100 - 4185 Still Creek Drive Burnaby, British Columbia, V5C 665 p: 604 294-0022

SEAL:

\$ 24,507,20 REPORT PER NEW WITH FLAN. C. 4. 244,007.27 REPORT PER NEW WITH FLAN. C. 2. 244,007.27 REPORT PER NEW WITH FLAN. C. 2. 244,007.27 REPORT PER NEW WITH FLAN. C. 2. 244,007.27 REVISION DESCRIPTION DISCUSSION.

PROJECT:

6 STOREY RESIDENTIAL BLDG

10713/10707/10695 138 ST SURREY BC

DRAWING TITLE

LANDSCAPE PLANTING PLAN

DATE:	23.NOV.24	DRAWING NUMBER:
SCALE:	3/32" = 1'-0"	
DRAWN:	CI	L6
DESIGN:	CI	
CHKD:	CLG	OF 9

138 STREET

WISHBONE BAYVIEW 5' BENCH; SURFACE MOUNT TO POURED IN PLACE CONCRETE SLAB; TYP.

OURED IN PLACE RUBBER SAFETY SURFACE

UNUS LUSITANICA: LARGE SHRUB IN TREE FORM

ALL PLANTERS UNDER 42" HT. & FURNITURE TO BE OFFSET FROM RAILING BY A MIN. OF 42"

SETBACK LINE





AMELANCHIER CANADENSIS 'GLENN FORM'



ROOF PLANTERS



POWDERCOATED ALUMINUM PLANTERS ROOF FURNISHINGS

KOMPAN UNO CLIMBER

HAUSER OUTDOOR LOUNGE FURNITURE



MAGLIN FORO TABLE & CHAIRS



CAFE TABLES AND CHAIRS TRELLIS

EXISTING PROPERTY LINE NEW PROPERTY LINE

SETBACK LINE

PROPERTY LINE

AVENUE



EXISTING PROPERTY LINE

LANE

PLANT SCHEDULE - ROOF PMG PROJECT NUMBER: 23-209 PLANTED SIZE / REMARKS AMELANCHIER CANADENSIS 'GLENN FORM' RAINBOW PILLAR CANADIAN SERVICEBERRY PORTUGESE LAUREL 2M HT; LOW STD.; B&B 2M HT; 1M STD PRUNUS LUSITANICA

BELGARD TEXADA SLAB PAVERS; 24* SQUARE: NATURAL COLOUR: TYP.

NOTES - PARK SEES IN THE USE THAT SEED PROFIED ACCORDING TO THE BE LANDSCAPE STANDARD AND CANDOWN LANDSCAPE STANDARD. LATES EDITION. CONTAINER SIZES SPECIFIED AS PER COLA STRUMBED. SIZES IN THE USE THAT SEED THAT SEE




6 STOREY RESIDENTIAL BLDG

10713/10707/10695 138 ST SURREY BC

ROOF DECK LANDSCAPE PLAN

DATE:	23.NOV.24	DRAWING NUMBER:
SCALE:	1/8" = 1'-0"	
DRAWN:	СІ	17
DESIGN:	СІ	
CHKD:	CLG	OF 9

23-209

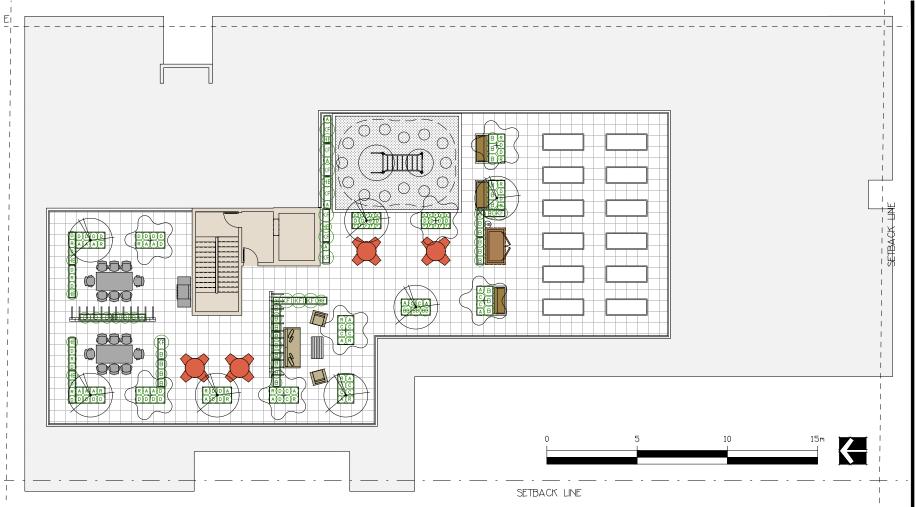

KFY	OTY	BOTANICAL NAME	COMMON NAME	PLANTED SIZE / REMARKS
	QIT	BUTANICAL NAME	COMMON NAME	PLANTED SIZE / REMARKS
SHRUB				
ⅎ	35	BUXUS MICROPHYLLA WINTER GEM	LITTLE-LEAF BOX	#3 POT; 40CM
SRASS				
(P)	12	CALAMAGROSTIS ACUTIFLORA 'KARL FOERSTER'	FEATHER REED GRASS	#1 POT
800	14	CAREX OSHIMENSIS 'EVEREST'	'EVEREST' SEDGE	#1 POT
ത	44	DESCHAMPSIA CESPITOSA 'PIXIE FOUNTAIN'	DWARF TUFTED HAIR GRASS	#1 POT
VINE				
(X)	2	CLEMATIS ARMANDII	EVERGREEN CLEMATIS	#3 POT; 75CM; STAKED
PERENI	NIAL			
(A)	26	ACHILLEA FILIPENDULINA 'SUMMER PASTELS'	SUMMER PASTELS YARROW	15CM POT
ಹ	4	BERGENIA 'BRESSINGHAM WHITE'	BRESSINGHAM WHITE BERGENIA	15CM POT
3886	7	HELLEBORUS x G. 'ICE N' ROSES WHITE'	ICE N' ROSES WHITE' LENTEN ROSE	#1 POT
ത	20	RUDBECKIA FULGIDA 'LITTLE GOLDSTAR'	'LITTLE GOLDSTAR' RUDBECKIA	15CM POT
GC				
Ē	20	FRAGARIA VESCA 'MARA DU BOIS'	WOODI AND STRAWBERRY	9CM POT

Copyright reserved. This drawing and design is the property of PMG Landscape Architects and may not be reproduced or used for other projects without their

Suite C100 - 4185 Still Creek Drive Burnaby, British Columbia, V5C 6G9 p: 604 294-0011 ; f: 604 294-0022

SEAUG 27 PLANTING DESIGN CI SEAUG 15 ADD LIGHTING PLAN CI SEAUG 10 NEW SITE PLANÉCITY COMMENTS DD SEAUG 25 REVISE PER NEW SITE PLAN CI			
SEAUG 27 PLANTING DESIGN CI SEAUG 15 ADD LIGHTING PLAN CI SEAUG 10 NEW SITE PLANÉCITY COMMENTS DD SEAUG 25 REVISE PER NEW SITE PLAN CI			
ALAUG.15 ADD LIGHTING PLAN CI MAUG.01 NEW SITE PLANECITY COMMENTS DD MARAZS REVISE PER NEW SITE PLAN CI	24.5EP.20	REVISE PER NEW SITE PLAN	cı
94.AUG.01 NEW SITE PLANSCITY COMMENTS DD 94.MAR.25 REVISE PER NEW SITE PLAN CI	4.AUG.27	PLANTING DESIGN	cı
A.MAR.25 REVISE PER NEW SITE PLAN CI	4.AUG.15	ADD LIGHTING PLAN	CI
	4.AUG.01	NEW SITE PLANSCITY COMMENTS	DD
DATE REVISION DESCRIPTION DR.	4.MAR.25	REVISE PER NEW SITE PLAN	CI
	DATE	REVISION DESCRIPTION	DR.

6 STOREY RESIDENTIAL BLDG


10713/10707/10695 138 ST SURREY BC


CLIENT:


ROOF DECK PLANTING PLAN


DATE:	23.NOV.24	DRAWING NUMBER:
SCALE:	3/16" = 1'-0"	
DRAWN:	СІ	18
DESIGN:	СІ	
CHKD:	CLG	OF 9

23-209

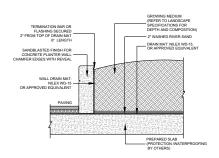

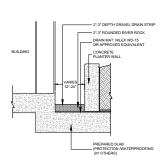

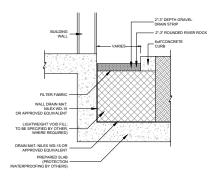

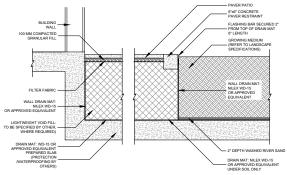


opyright reserved. This drawing and design is the verty of PMG Landscape Architects and may not be oduced or used for other projects without their ARCHITECTS Suite C100 - 4185 Still Creek Dr Burnaby, British Columbia, V5C 6 p: 604 294-0011 ; f: 604 294-01 SEAL:

PLANTER WALL ON SLAB

2 DRAIN ROCK STRIP AT BUILDING ON SLAB

3 DRAIN STRIP AT BUILDING AT SLAB DROP

4 PATIO/LANDSCAPE AT SLAB DROP

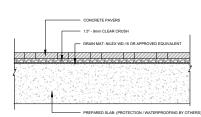

PAVERS ON SLAB

NOTE:

PAVERS TO BE INSTALLED TO MANUFACTURERS SPECIFICATIONS
PAVERS NOT TO BE CUIT MORE THAN HALF SIZE

ALL PAVERS TO BE DIMANDING CUIT

MAX PAVER LIPPAGE IN BETWEEN SURFACES


FATINESS TO LEARNING: 38" OVER 10 FT

ONLY PAVERS OFF SILAB ARE TO BE INFILED WITH POLYMERIC SAND
ONLY PAVERS OF SILAB ARE TO ME INFILED

ONLY PAVERS OFF SILAB ARE TO ME INFILED

ONLY PAVERS OFF SILAB ARE TO ME INFILED

ONLY PAVERS OFF SILAB ARE TO ME BEDDING SAND LEVELING COURSE

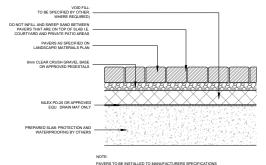


6 PAVERS ON SLAB WITH VOID FILL


PAVERS TO BE INSTALLED TO MANUFACTURERS SPECIFICATIONS PAVERS NOT TO BE CUIT MORE THAN HALF SIZE ALL PAVERS TO BE DIAMOND CUIT MAX PAVER LIPPAGE 18" BETWEEN SURFACES MAX PAVER LIPPAUS: 1/8" BE I WEER SURF MACO
FLATNESS TOLERANCE: 3/8" OVER 10 FT
ONLY PAVERS OFF SLAB ARE TO BE INFILLED WITH POLYMERIC SAND
ONLY PAVERS OFF SLAB ARE TO HAVE BEDDING SAND LEVELING COURSE

RESILIENT SURFACE POURED IN PLACE RUBBER TO MANUFACTURER'S SPECIFICATION: 13MM RUBBER WEAR COURSE 75MM RUBBER BASE COURSE 6" COMPACTED 9MM CLEAR CRUSH AGGREGATE AS REQUIRED TO ENSURE FINISHED GRADE IS FLUSH WITH ADJACENT SURFACES CONCRETE PAVERS AS PER LANDSCAPE PLAN HOUSEKEEPING SLAB AS REQUIRED BY PLAY EQUIPMENT MANU. VOID FILL: TO BE SPECIFIED BY OTHERS, WHERE REQUIRED) DRAIN MAT: NILEX PD-20 OR APPROVED EQUIVALENT NOTE: RESILIENT SURFACE TO BE INSTALLED TO MANUFACTURER'S SPECIFICATION AND MUST BE IN COMPLIANCE WITH CSA FALL HEIGHT FOR THE RESPECTIVE PLAY STRUCTURES


7 POURED IN PLACE RUBBER SAFETY SURFACE & EDGE

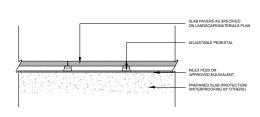

8 HYDRAPRESSED SLABS OVER PEDESTALS

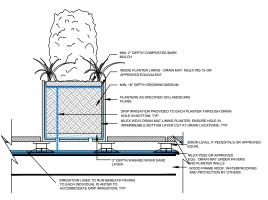

9 ROOF DECK PLANTERS

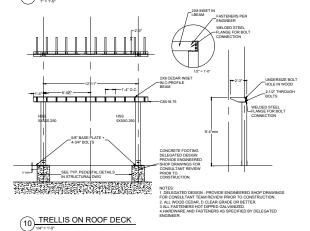

LANDSCAPE

DETAILS

10713/10707/10695 138 ST SURREY BC

DATE SCALE: L9 DRAWN: DESIGN: CHKD: CLG

6 STOREY RESIDENTIAL BLDG

23-209

23209-6.ZIP

PMG PROJECT NUMBER:



INTER-OFFICE MEMO

TO: Director, Development Planning, Planning and Development Department

FROM: Manager, Development Services, Engineering Department

DATE: September 27, 2024 PROJECT FILE: 7824-0103-00

RE: Engineering Requirements

Location: 10695, 10707, and 10713 - 138 Street

OCP TEXT AMENDMENT

There are no engineering requirements relative to the OCP Text Amendment.

REZONE/SUBDIVISION

Property and Right-of-Way Requirements

- Dedicate 1.942 m along 138 St.;
- Dedicate 1.0-metre x 1.0-metre corner cut at Lane;
- Dedicate 3.0-metre x 3.0-metre corner cut at intersection of 107A Ave. and 138 St.; and
- Register 0.5 m statutory right-of-way (SRW) along road frontages.

Works and Services

- Construct the south side of 107A Ave.;
- Construct the west side of 138 St.;
- Construct Lane;
- Construct required mains for water, sanitary and drainage to service the development site;
 - o Construct/upgrade existing sanitary main in the lane;
 - o Design of the storm sewer in the rear (west) lane should consider the potential for properties to the south to also drain to the rear lane.
 - o Submit sanitary catchment analysis up to King George Blvd (with NCP scenario).
 - o Upsize any downstream systems if required.

A Servicing Agreement is required prior to Rezone/Subdivision.

DEVELOPMENT PERMIT

There are no engineering requirements relative to issuance of the Development Permit.

Jeff Pang, P.Eng.

Jeffy lang

Manager, Development Services

M51



Planning and Demographics June 7, 2024 City of Surrey Department:

Report For:

Development Impact Analysis on Schools For:

Application #:

The proposed development of 87 Low Rise Apartment are estimated to have the following impact on elementary and secondary schools within the school regions.

School-aged children population projection

Projected Number of Students From This Development In:				
Elementary School =	8			
Secondary School =	3			
Total Students =	11			

Current Enrolment and Capacities:			
Forsyth Road Elementary			
Enrolment	427		
Operating Capacity	317		
# of Portables	6		
Kwantlen Park Secondary			
•			
Enrolment	1594		
Operating Capacity	1200		
# of Portables	16		

Summary of Impact and Commentary


The following tables illustrate the historical, current and future enrolment projections ncluding current/approved ministry operating capacity for the elementary and secondary chools serving the proposed development.

orsyth Road Elementary serves northern city centre neighborhood community and students. Given he densification of the City Centre surroundings, the school is projected to double its current student nrolment over the next 10 years, indicating a strong case for an addition to the school.

The Ministry of Education and Child Care has supported the District's capital request to plan and reate a busines case for a new 8-classrom capacity addition. No funding has been approved to move the project into design and construction. The addition is targeted to open 2029.


As of September 2023, Kwantlen Park Secondary is currently operating at 133% with 16 portables on site used for enrolling classes and is projected to grow signficantly over the next 10 years. This school will also be impacted by timing of future high-rise development in the area. In February 2023, the District received capital funding approval from the Ministry to build a 500-capacity addition, targeted to open in the fall of 2027. However additional measures will also be required to address the future growth.

Forsyth Road Elementary

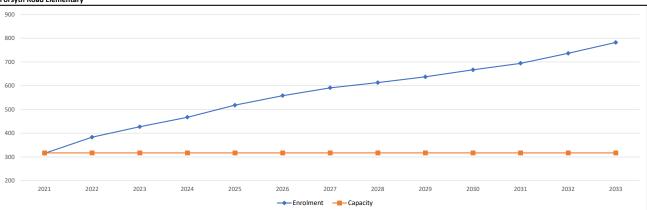


Note: If this report is provided in the months of October, November and December, the 10-year projections are out of date and they will be updated in January of next year

Kwantlen Park Secondary

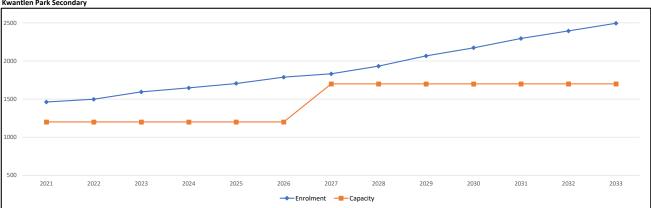

Note: If this report is provided in the months of October, November and December, the 10-year projections are out of date and they will be updated in January of next year.

Population: The projected population of children aged 0-17 impacted by the development. **Enrolment:** The number of students projected to attend the Surrey School District ONLY.

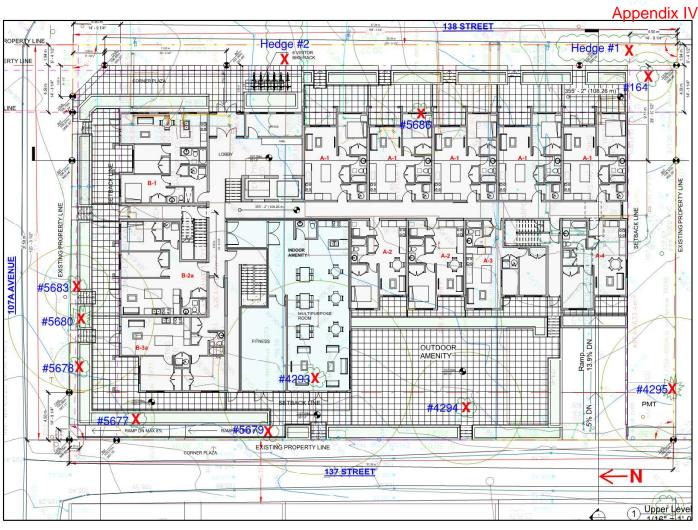

Tree Management Plan- Scale, 1" = 30'

Summary of Tree Preservation by Tree Species:

Tree Species	Existing			Remove	Retain
Alder and Cottonwood Trees					
Alder		0		0	0
Cottonwood		0		0	0
	Deciduous Trees (Excluding Alder and Cottonwood Trees)				
Holly		1		1	0
Photinia		1		1	0
Walnut		2		2	0
Coniferous Trees					
Douglas Fir	1		1	0	
Western Red Cedar	1		1	0	
Total (excluding Alder and Cottonwood Trees)	6		6	0	
Additional [Estimated] Trees in the proposed [Open Space / Riparian Area] -planner/arborist to choose]	0		0	0	
Total Replacement Trees Proposed (excluding Boulevard Street Trees)			12		
Total Retained and Replace	ment Trees		12		
Contribution to the Green City Program			-		

Tree Preservation Summary				
Surrey Project No: Address: 10695-10713 138 Street, Surrey				
Registered Arborist: Davey Resource Gro	up – Kimber	Tey Dani PN/658A		
On-Site Trees	Number of Trees	Off-Site Trees Number of Trees		
Protected Trees Identified *	6	Protected Trees Identified 0		
Protected Trees to be Removed	6	Protected Trees to be Removed 0		
Protected Trees to be Retained (excluding trees within proposed open space or riparian areas)	0	Protected Trees to be Retained 0		
Total Replacement Trees Required:		Total Replacement Trees Required:		
- Alder & Cottonwoods to be removed (1:1) 0 X 0 = 0	12	- Alder & Cottonwoods to be removed (1:1) 0 X one (1) = 0		


- All other species to be removed (2:1) 6 X two (2) = 12		- All other species to be removed (2:1) 0 X two (2) = 0		
Replacement Trees Proposed	12	Replacement Trees Proposed -		
Replacement Trees in Deficit	0	Replacement Trees in Deficit -		
Protected Trees to be Retained in Proposed Open Space or Riparian Areas	0			
*on-site and shared trees, including trees within boulevards and proposed streets and lanes, but excluding trees in				

*on-site and shared trees, including trees within boulevards and proposed streets and lanes, but excluding trees in proposed open space or riparian areas


Summary, report, and plan prepared and submitted by:

Arborist)

(Signature of Date

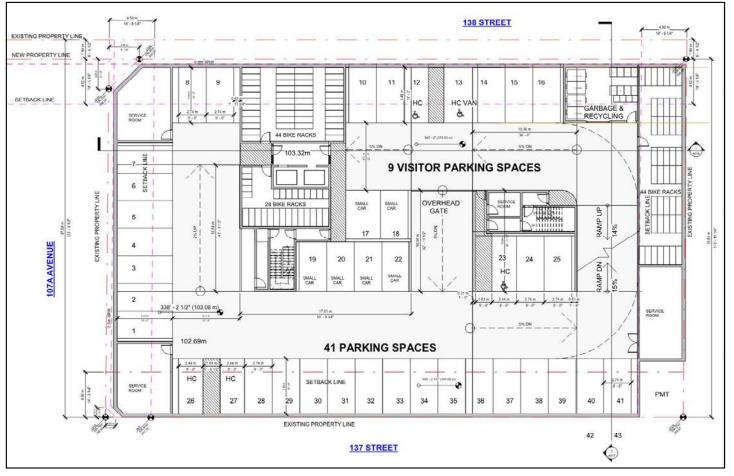

Parking Plan, Level 1 - Not to Scale

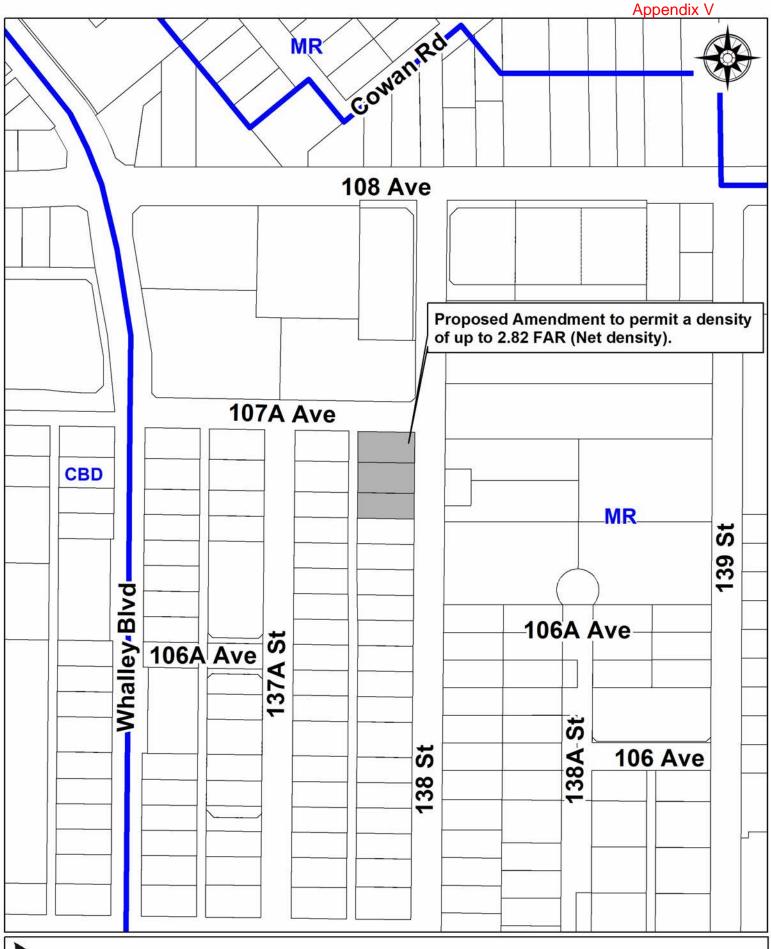



OCP Amendment 24-0103-00

Proposed Amendment to to permit a density of up to 2.82 FAR (Net density).

