

City of Surrey PLANNING & DEVELOPMENT REPORT Application No.: 7920-0302-00

Planning Report Date: March 8, 2021


PROPOSAL:

• Development Variance Permit

to reduce the front yard setback for a proposed single family dwelling on a lot located along an arterial road (128 Street)

LOCATION: 10542 - 128 Street

ZONING: RF
OCP DESIGNATION: Urban

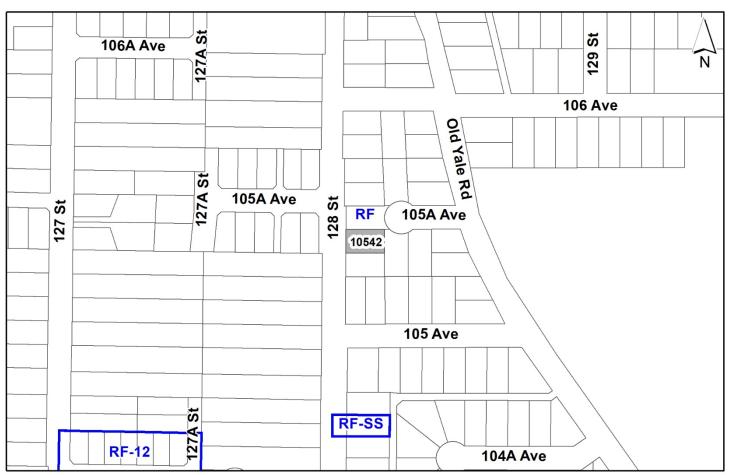

RECOMMENDATION SUMMARY

• Approval for Development Variance Permit to proceed to Public Notification.

DEVIATION FROM PLANS, POLICIES OR REGULATIONS

• The applicant is seeking a variance to reduce the minimum front yard setback requirement of the RF zone for a proposed single-family dwelling.

RATIONALE OF RECOMMENDATION

- In accordance with Part 7 Special Building Setbacks of the Zoning By-law, the setback of lots flanking or fronting an arterial or collector road are measured from the centerline of the ultimate road allowance.
- 128 Street is an arterial road with an ultimate road allowance of 30 metres. This ultimate road allowance will require future road widening of 4.9 metres from the front (west) property line.
- The requested reduced setback will allow the owner to achieve a typical RF type house and will result in a consistent streetscape with the other existing houses along this section of 128 Street.
- The proposed single family dwelling will still have a minimum 6.7 metre long driveway to accommodate off-street vehicle parking even after the ultimate road widening is achieved.
- Staff supports the requested variance to proceed to Public Notification.

RECOMMENDATION

The Planning & Development Department recommends that:

- 1. Council approve Development Variance Permit No. 7920-0302-00 (Appendix II) varying the following, to proceed to Public Notification:
 - (a) to reduce the minimum front yard setback of the RF Zone from 7.5 metres to 6.7 metres to the garage and 4.8 metres to the remainder of the principal building face.

SITE CONTEXT & BACKGROUND

Direction	Existing Use	OCP Designation	Existing Zone	
Subject Site	Existing single family dwelling to demolished	Urban	RF	
North:	Single family dwellings	Urban	RF	
East:	Single family dwellings	Urban	RF	
South:	Single family dwellings	Urban	RF	
West (Across 128 Street):	Single family dwellings	Urban/Medium Density Residential Lane Served (15-23 upa) in the South Westminster Infill Area	RF	

Context & Background

• The 665 square metre subject property is located at 10542 – 128 Street, east of the South Westminster Heights Infill Area. The site is designated "Urban" in the Official Community Plan (OCP) and is zoned "Single Family Residential Zone (RF)".

DEVELOPMENT PROPOSAL

Planning Considerations

• The applicant is seeking variances to setbacks to accommodate a typical RF house on the existing lot (see By-law Variance Section).

Referrals

Engineering: The Engineering Department has no objection to the project.

Transportation Considerations

- 128 Street, along the lot frontage, is classified as an arterial road. Under the revised standards of the Subdivision & Development By-law approved by Council in 2011, the ultimate width is 30 metres. The existing road allowance for 128 Street requires road widening of 4.9 metres from the front (west) property line.
- The Engineering Department has determined that within the next 7 10 years, 30 metres of road allowance for 128 Street will be required for future road construction. Under Part 7 Special Building Setbacks of the Zoning By-law, No. 12000 (the "Zoning Bylaw"), the setbacks of buildings and structures on a lot abutting a highway shown on the Surrey Major Road Allowance Map, which includes this portion of 128 Street, shall be the sum of one-half of the width of the ultimate highway allowance as measured from the ultimate highway allowance plus the required setback of the zone in which the lot is located. This results in a front yard setback requirement of 12.4 metres from the existing front lot line on the subject lot.
- The required front yard setback of 12.4 metres from the existing front lot line is calculated by adding the 4.9-metre future road widening requirement to the required 7.5-metre front yard setback in the RF Zone.

POLICY & BY-LAW CONSIDERATIONS

Zoning By-law

Front Setback Variance

• The applicant is requesting the following variance:

to reduce the minimum front yard setback of the RF Zone from 7.5 metres to 6.7 metres to the garage and 4.8 metres to the remainder of the principal building face.

- The subject lot fronts 128 Street, which is a designated Arterial Road in the Surrey Road Classification Map (R-91), attached as Schedule D to Surrey Subdivision and Development By-Law No. 8830. The Surrey Major Road Allowance Map, attached as Schedule K to the Subdivision and Development By-Law, identifies a 30 metre wide road allowance for arterial roads. This road allowance, approved in 2011, is a 3.0 metre increase from the previous arterial road allowance of 27 metres.
- For this portion of 128 Street, the Engineering Department has concluded that within the next 7 10 years, 30 metres of road allowance will be required for future road construction.
- Part 7 Special Building Setbacks of the Zoning By-law, stipulates that the setback of buildings on a lot abutting an existing or future major road as shown in the Surrey Major Road Allowance Map, shall be the sum of one-half of the ultimate highway allowance shown in the Major Road Allowance Map measured from the centerline of the road, plus the required setback of the zone in which the lot is located.

- On this basis, the required front yard setback is 15 metres from the ultimate centerline of 128 Street, plus the 7.5 metre front yard setback requirement for the principal building of the RF Zone for a total Special Building Setback of 22.5 metres to the ultimate centreline.
- This equates to an additional 4.9 metre setback from the existing front (west) property line beyond the typical 7.5 metre setback, resulting in a required 12.4 metre building setback from the existing front property line.
- The proposed front yard setback of 4.8 metres from the new lot line to the building face is supportable as it achieves a consistent streetscape along 128 Street and allows the applicant to construct a reasonably-sized single family home on the lot.
- The proposed single family dwelling will have a minimum 6.7 metre long driveway to accommodate off-street vehicle parking even after the ultimate road widening is achieved.
- Staff support the requested variances to proceed for consideration.

TREES

Francis Klimo, ISA Certified Arborist of Klimo & Associates Ltd., prepared an Arborist
Assessment for the subject property. The table below provides a summary of the tree
retention and removal by tree species:

Table 1: Summary of Tree Preservation by Tree Species:

Tree Species	Existing Remove			Retain
(excluding	ous Trees	ood Trees)		
Japanese Maple	1		1	0
Total (excluding Alder and Cottonwood Trees)	1		1	o
Total Replacement Trees Proposed (excluding Boulevard Street Trees)			2	
Total Retained and Replacement T	Trees		2	

- The Arborist Assessment states that there is 1 mature tree on the site. It was determined that the tree cannot be retained as part of this development proposal.
- For the tree that cannot be retained, the applicant will be required to plant trees on a 2 to 1 replacement ratio. This will require a total of 2 replacement trees on the site. The applicant is proposing 2 replacement trees, meeting City requirements.
- In summary, a total of 2 trees are proposed to be replaced on the site.

INFORMATION ATTACHED TO THIS REPORT

The following information is attached to this Report:

Appendix I. Site Plan

Appendix II. Development Variance Permit No. 7920-0302-00

Appendix III. Tree Management Plan

approved by Ron Gill

Jean Lamontagne General Manager Planning and Development

ELM/cm

Appendix I 85.73 -RF 86. TS wood fence 7'-10" [2,41N] (no types) 4'-11" [1.50M] I. 85.0 24"-74" [7.50M] ZONING ANALYSIS RF ZONE SURREY PROJECT NUMBER:
LOT NUMBER: 40 LOT AREA = 485.0 m2
ADDRESS: 10542 128 STREET, SURREY, BC SINGLE FAMILY RESIDENTIAL ZONE (RF) SECTION B. PERMITTED USES 85.0 SINGLE FAMILY DETACHED DWELLING : YES SECONDARY SUITE DECLARED : NO SECTION D. DENSITY (FLOOR AREA) MERGE DISTING GRADE AROUND PRINCIPAL DRELIANS:

(85.18 + 85.21 + 85.25 + 85.18) / 4 = 85.21

RECHEMIN HEADT (SUR TO SIERRY) = N/A

PROPOSED BESTRUCHT SURB ELEMATON = N/A

RESEMBLY IS 0.00 % BELOW NO. DUSTING GRADE

(THERETOKE BESTRUCHT ASSA NOT COLUMBE)) 5'-11#" [1.81M] 5'-11" [1.82M] P.EL.=85.40 E.EL.=85.18 P.EL.=85.40 E.EL.=85.21 COVERED DECK | MIX. FLOOR ABEA BATIO (F.A.R.) = 0.40 FOR FRST 560m2
| PUIS 0.35 FOR EDMANNE ABEA BATIO (F.A.R.) = 0.40 FOR FRST 560m2
| MAXIMAIN FLOOR ABEA BASED ON F.A.R. = 372.75 m2
| FLOOR ABEA DATE = 485 m2 (SJOES 50.2FL]
| THEREFORE BILAN MAX. FLOOR ABEA = 372.75 m2 ф. 80._{1,2,.} LOT#40 10542 128 STREET SURREY, B.C. MAIN FLOOR=85.70 TOP FLOOR=89.09 AVG. BLDG. GR.=85.21 32.995 , Å, XX. SECTION E. LOT COVERAGE

(OT COVERAGE FOR LOTS <= 590 m² = 0.40

FOR LOTS > 560m², DEDUCT (LOT SIZE = 560m²,) × .000215

(MOREVER, LOT COVERAGE NEED NOT SEE LISS THAN 0.25)

MAX. LOT COVERAGE • 37.74% = 250.97m². GARAGE SLAB: © REAR=85.48 © FRONT=85.4 5'-1 1" [1.82M] 6 4'-58" [1.37M] 19'-8#" [6.00M] 24'-7#" [7.50M] REQ. SETBACK DRIVEWAY 22'-11" [6.75M] DVP SETBACK 5'-117" [1.82M] SECTION F. YARDS AND SETBACKS EXPOSED AGGREGATI SECTION 1. YARUS AND SCIENCIAS
FROM ACCESS COMESS:

— MINIMA REON ESTRICK TO GARDS = 7.5m.

— STATE OF BARDS ST BARDS AND ON ON UNCE THEN
THE WAS STRICK ON BE REQUED TO A.7m

— FOUR FROM COME OF REQUED TO A.7m

— FROM FROM GARDS COSS STOT ESTED FOR UNCE
THEN HAVE TO SEPHI TOWAN HAVEN

ON

— THEN BAY OF ANY TOPIC ONE, SET BACK 0.8m.

M/A 2.31% D/W SLOPE 18'-2" [5.54M] REQ. SETBACK 0 PERMITTED FAR =4012.25 SQ.FT.) (N) PROPOSED FAR WITHOUT DVP =3766.71 SQ.FT. PROPOSED FAR WITH DVP = 4009.42 SQ.FT. FRONT SETBACK TO PRINCIPAL DWELLING : - MN. FRONT SETBACK TO BOTH FLOORS DWELLING = 7.5m. - 50% OF WOTH CAN BE SET AT 5.5m (ONE STOREY ONLY) REAR SETBACK TO PRINCIPAL DWELLING : BYLAW REAR SETBACK 7.5m, OR 50% SET 6.0m FROM REAR IF OTHER 50% SET 8.5m FROM REAR. INTERIOR SIDE SETBACK TO PRINCIPAL DWELLING = 1.8 m (OR 1.2m ON ONE SIDE AND 2.4m ON THE OTHER) √ρ× Ś cedar hedge g^k× 6'-0\" [1.83M] 19'-81" [6.00M] 20.116 9k.9G1. 8×. 85. 81 85.KA 85.5 28 ACCESSORY STRUCTURE <= 10 m FRONT SETBACK REAR SETBACK INTERIOR SIDE SETBACK OPPOSITE INTERIOR SIDE SETBACK FLANKING SIDE SETBACK , \$⁶2. ాన్స్ asphalt gutter ళా. ళా. \mathbb{Q}^{2} SECTION J. SPECIAL REGULATIONS BASEMENT ENTRY WELL: \$5.5° SECTION H. OFF-STREET PARKING 85.K1 85.57 storm m/h rim el=85.26m 1) MINIMUM 3 OFF-STREET PHYRIDING SPICES OK
2) DRIVENAY WOTH MAXIMUM 8.0 m, OR 3.0 m x THE NUMBER
OF SIDE BY SIDE PARKING SPICES AT FRONT SETBACK
3) DRIVENAY AREA <= 5.3% OF FRONT YARD AREA
OK 1) PERMITTED IN REAR YARD ONLY AND IN SIDEYARD OF REAR HALF OF DWELLING. south invert el.=83.37 m diam. = NA BASEMENT ENTRY WELL MUXIMUM ACTUAL

MAX. AREA INCLUDING STARS (m2) 28.00 0.00 road centerline | GARACE DMENSONS (m2) | RECURRED | ACTUAL | UNIMUM INTEROS WOTH | 5.70 | 5.79 | UNIMUM INTEROS (CEPTH | 6.10 | 6.10 | UNIMUM CARACE AREA | 39.0 m2 | 37.18 | Ε anitary m/h 'im el=85.22m invert 82.46 r 8. = NA 128TH STREET &.@ SECTION L. OTHER REGULATIONS: SECTION E. WESSINGD FROM THE MORE FROM TRETIONE OF THE FRONT LOT LINE, OR FROM THE CONTRELINE OF THE ULTIMATE HOHBOY ALLOMANCE. (SEE SCHEDULE K, BYLAW 1986 NO 8830) MEASURED FROM THE FRONT LOT LINE FOR THIS LOT. SECTION I. LANDSCAPING south is el.= & MINIMUM POROUS SURFACE AREA : REQUIRED ACTUAL
ENTRE YARD AREA x 305 199.50 375.94 SITE PLAN

DRAWING NO. REFERENCE NO. REVISION BY DATE DRAWING NO. DRAWING NO.	FORM TO REQUIREMENTS JILDING CODE 2018.
MR. GURNAM SINGH	
NOON Designs Ltd. LOT#40, 10542 128 STREET OND H.B. DD 20-8230-P1 SURREY, B.C. PRODE 178-990-2713	DHILLON DESIGNS LTD. T215-12830-80th AVE. SURREY, B.C. V3W 3A8 PHONE: (604) 590-2808 FAX: (604) 590-2878 MAIL:info@dhillondesigns.ca

CITY OF SURREY

(the "City")

DEVELOPMENT VARIANCE PERMIT

NO.: 7	7920-0302-00
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Issued To:

(the "Owner")

Address of Owner:

- 1. This development variance permit is issued subject to compliance by the Owner with all statutes, by-laws, orders, regulations or agreements, except as specifically varied by this development variance permit.
- 2. This development variance permit applies to that real property including land with or without improvements located within the City of Surrey, with the legal description and civic address as follows:

Parcel Identifier: 010-324-411 Lot 40 Section 21 Block 5 North Range 2 West New Westminster District Plan 17972

10542 - 128 Street

(the "Land")

- 3. Surrey Zoning By-law, 1993, No. 12000, as amended is varied as follows:
- (a) In Section F of Part 16 "Single Family Residential Zone (RF)", the minimum front yard setback is reduced from 7.5 metres to 6.7 metres to the garage, and 4.8 metres to the remainder of the principal building face.
- 4. This development variance permit applies to only that portion of the buildings and structures on the Land shown on Schedule A which is attached hereto and forms part of this development variance permit. This development variance permit does not apply to additions to, or replacement of, any of the existing buildings shown on attached Schedule A, which is attached hereto and forms part of this development variance permit.
- 5. The Land shall be developed strictly in accordance with the terms and conditions and provisions of this development variance permit.

6.	1 1	if the Owner does not substantially start any opment variance permit is issued, within two ance permit is issued.
7.	The terms of this development variance perm persons who acquire an interest in the Land.	nit or any amendment to it, are binding on all
8.	This development variance permit is not a bu	ilding permit.
	ORIZING RESOLUTION PASSED BY THE CO D THIS DAY OF , 20 .	UNCIL, THE DAY OF , 20 .
		Mayor – Doug McCallum
		City Clerk – Jennifer Ficocelli

8.0 TREE PRESERVATION SUMMARY

Surrey Project No: N/A


Address: **10542 128 St, Surrey** Registered Arborist: Francis Klimo

On-Site Trees	Number of Trees
Protected Trees Identified	1
(on-site and shared trees, including trees within boulevards and proposed streets and	
lanes, but excluding trees in proposed open space or riparian areas and non-bylaw protected trees)	
Protected Trees to be Removed	1
Protected Trees to be Retained (excluding trees within proposed open space or riparian areas)	
Total Replacement Trees Required:	
Alder & Cottonwood Trees Requiring 1 to 1 Replacement Ratio	
0 X one (1) = 0	0
All other Trees Requiring 2 to 1 Replacement Ratio	U
1 X two (2) = 2	2
Replacement Trees Proposed	2
Replacement Trees in Deficit	0
Protected Trees to be Retained in Proposed [Open Space / Riparian Areas]	0

Off-Site Trees	Number of Trees
Protected Off-Site Trees to be Removed	0
Total Replacement Trees Required:	
Alder & Cottonwood Trees Requiring 1 to 1 Replacement Ratio	
0 X one (1) = 0	0
All other Trees Requiring 2 to 1 Replacement Ratio	
0 X two (2) = 0	0
Replacement Trees Proposed	0
Replacement Trees in Deficit	0

Summary, report and plan prepared and submitted by:

Francis Kelmo	February 10, 2021
(Signature of Arborist)	Date

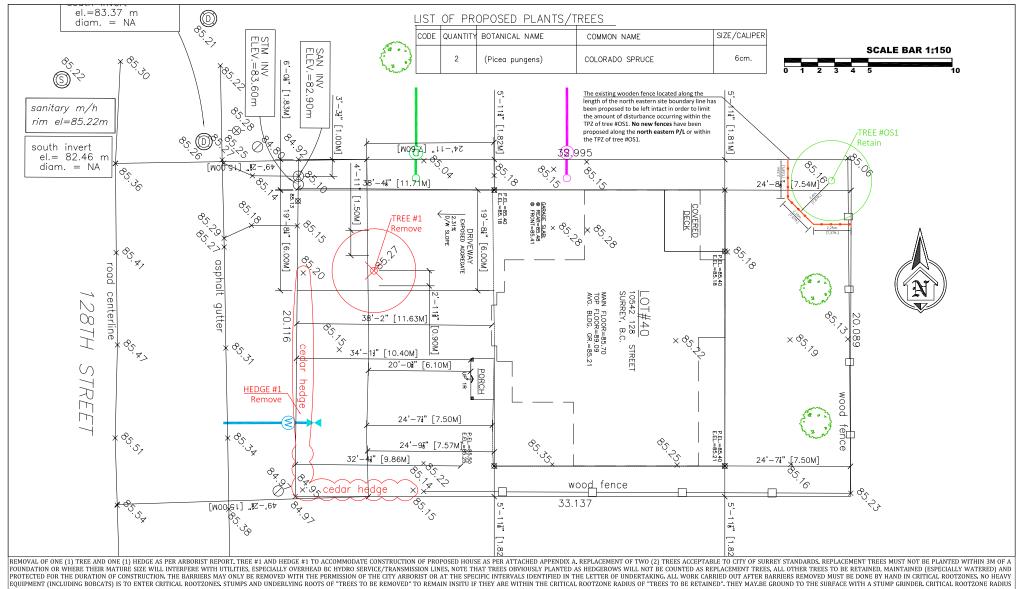

EQUIPMENT (INCLUDING BOBCATS) IS TO ENTER CRITICAL ROOTZONES, STUMPS AND UNDERLYING PRINTERS TO BE REMOVED" TO REMAIN INSITU IF THEY ARE WITHIN THE CRITICAL ROOTZONE RADIUS OF "TREES TO BE RETAINED". THEY MAY BE GROUND TO THE SURFACE WITH A STUMP GRINDER. CRITICAL ROOTZONE RADIUS OF "TREES TO BE REMOVED" TO REMAIN INSITU IF THEY ARE WITHIN THE CRITICAL ROOTZONE RADIUS OF "TREES TO BE REMOVED" TO REMAIN INSITU IF THEY ARE WITHIN THE CRITICAL ROOTZONE RADIUS OF "TREES TO BE REMOVED" TO REMAIN INSITU IF THEY ARE WITHIN THE CRITICAL ROOTZONE RADIUS OF "TREES TO BE REMOVED" TO REMAIN INSITU IF THEY ARE WITHIN THE CRITICAL ROOTZONE RADIUS OF "TREES TO BE REMOVED" TO REMAIN INSITU IF THEY ARE WITHIN THE CRITICAL ROOTZONE RADIUS OF "TREES TO BE REMOVED" TO REMAIN INSITU IF THEY ARE WITHIN THE CRITICAL ROOTZONE RADIUS OF "TREES TO BE REMOVED" TO REMAIN INSITU IF THEY ARE WITHIN THE CRITICAL ROOTZONE RADIUS OF "TREES TO BE REMOVED" TO REMAIN INSITU IF THEY ARE WITHIN THE CRITICAL ROOTZONE RADIUS OF "TREES TO BE REMOVED" TO REMAIN INSITU IF THEY ARE WITHIN THE CRITICAL ROOTZONE RADIUS OF "TREES TO BE REMOVED" TO REMAIN INSITU IF THEY ARE WITHIN THE CRITICAL ROOTZONE RADIUS OF "TREES TO BE REMOVED" TO REMAIN INSITU IF THEY ARE WITHIN THE CRITICAL ROOTZONE RADIUS OF "TREES TO BE REMOVED". THEY ARE WITHIN THE CRITICAL ROOTZONE RADIUS OF "TREES TO BE REMOVED" TO REMAIN INSITU IF THEY ARE WITHIN THE CRITICAL ROOTZONE RADIUS OF "TREES TO BE REMOVED".

TREE MANAGEMENT PLAN	Re	visions	
Project Number	No	. Date	
Date Sheet #			
February 24, 2021			
Scale 1:150			
Drawn	_		
Checked			
Francis R. Klimo			
ISA Certified Arborist #PN-8149	-A		

Consultants

ISA Certified Tree Risk Assessor (TRAQ)

BC Wildlife Danger Tree Assessor #7193

10542 128 ST, SURREY

Klimo & **Associates**