

City of Surrey PLANNING & DEVELOPMENT REPORT File: 7918-0159-00

Planning Report Date: December 17, 2018

PROPOSAL:

• Temporary Use Permit

to permit the development of a temporary real estate sales centre for three proposed 4-storey apartment buildings on the adjacent properties.


LOCATION: 10575, 10593 and 10605 - 139 Street

ZONING: RF

OCP DESIGNATION: Multiple Residential

CITY CENTRE PLAN Residential Low to Mid Rise up to

DESIGNATION: 2.5 FAR

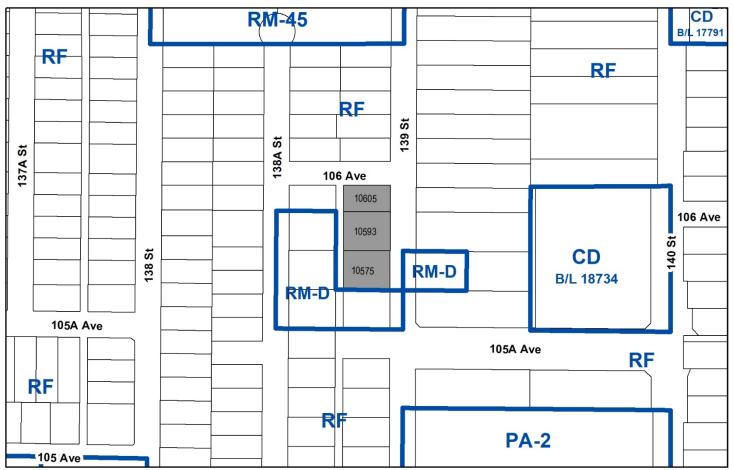

RECOMMENDATION SUMMARY

Approval for Temporary Use Permit to proceed to Public Notification.

DEVIATION FROM PLANS, POLICIES OR REGULATIONS

None.

RATIONALE OF RECOMMENDATION

- The proposed Temporary Use Permit (TUP) will allow for the construction of a temporary sales centre from which the applicant (Mosaic Homes) will be able to market residential units for a proposed development located directly across the street at 10558, 10576, 10596 and 10604—139 Street.
- The subject application is associated with Development Application No. 7917-0599-00 which proposes to construct 218 apartment units within three 4-storey buildings. The proposal was granted Third Reading by Council on December 3, 2018.
- The applicant will post \$5,000.00 bond to ensure the removal of the temporary building in the future.

RECOMMENDATION

The Planning & Development Department recommends that:

1. Council approve Temporary Use Permit No. 7918-0159-00 (Appendix V) to proceed to Public Notification.

- 2. Council instruct staff to resolve the following issues prior to final approval:
 - (a) ensure that all engineering requirements and issues including restrictive covenants, dedications, and rights-of-way where necessary, are addressed to the satisfaction of the General Manager, Engineering;
 - (b) submission of a landscaping plan to the specifications and satisfaction of the Planning and Development Department;
 - (c) resolution of all urban design issues to the satisfaction of the Planning and Development Department;
 - (d) the applicant satisfy the deficiency in tree replacement on the site, to the satisfaction of the Planning and Development Department;
 - (e) submission of security to ensure the building is removed and the site is brought into compliance with the Zoning By-law following the expiration of the Temporary Use Permit; and
 - (f) demolition of existing buildings and structures to the satisfaction of the Planning and Development Department.

REFERRALS

Engineering: The Engineering Department has no objection to the project subject

to the completion of Engineering servicing requirements as outlined

in Appendix III.

Surrey Fire Department: No Concerns.

SITE CHARACTERISTICS

<u>Existing Land Use:</u> Single family residential and vacant parcels.

Adjacent Area:

Direction	Existing Use	City Centre Plan Designation	Existing Zone
North (Across 106 Avenue):	Single family dwellings	Residential Low to Mid Rise up to 2.5 FAR	RF
East (Across 139 Street):	Single family dwellings and vacant parcel. Development Application No. 7917-0599-00 proposes to construct three 4-storey apartment buildings with 218 residential units. The application was granted Third Reading on December 3, 2018.	Residential Low to Mid Rise up to 2.5 FAR	RF and RM-D
South:	Duplex	Residential Low to Mid Rise up to 2.5 FAR	RM-D
West (Across unconstructed lane):	Single family dwelling and Duplexes	Residential Low to Mid Rise up to 2.5 FAR	RF and RM-D

DEVELOPMENT CONSIDERATIONS

Background

- The subject properties are located at 10575, 10593 and 10605 139 Street. The site is designated "Multiple Residential" in the Official Community Plan (OCP), "Residential Low to Mid Rise up to 2.5 FAR" in the Surrey City Centre Plan and zoned "Single Family Residential Zone (RF)".
- Mosaic Homes has submitted an application at 10558, 10576, 10596 and 10604 139 Street (Development Application No. 7917-0599-00) in order to construct three 4-storey apartment buildings with a total of 218 dwelling units. The application received Third Reading at the Regular Council Public Hearing Meeting on December 3, 2018.

Current Proposal

- The applicant (Mosaic Homes) is requesting a Temporary Use Permit (TUP) on the subject site in order to allow a sales centre from which to market their multi-family residential project on the east side of 139 Street called "Parker" (Development Application No. 7917-0599-00).
- The TUP is proposed to be in effect for three years, which should be sufficient time for the applicant to complete the sales of the proposed apartments.
- The applicant will post a bond of \$5,000 to ensure the removal of the temporary building after marketing of the project is complete.

DESIGN PROPOSAL AND REVIEW

- The proposed sales centre will be a single-storey building with a total floor area of 238.8 square metres (2,571 sq. ft.) and a footprint of approximately 11.6 metres (38 ft.) by 20.4 metres (67 ft.).
- The sales centre will contain an office/reception area with a small kitchen, accessible washroom and a mock-up of a 2-bedroom apartment.
- The proposed building will have a 7.6 metre (25 ft.) setback from the east lot line. A minimum 1.2 metre (4 ft.) wide landscape strip is proposed around the building and on-site parking with a small portion of the landscape strip being located within the minimum building setback.
- The proposed building includes a cast-in-place concrete foundation, wood siding with a black pine tar finish, a standing seam metal roof that matches the wood cladding, prefinished metal flashing and cantilevered canopies. The building proposes a combination of gable and flat roofs with a vaulted main entry.
- An asphalt surface parking lot, with space for 12 vehicles, will be constructed directly south of the proposed building with access from 139 Street. A concrete paver sidewalk will connect the parking lot to the entrance of the building. A concrete paver sidewalk connection is also proposed from the entrance of the building to 139 Street.
- The building will be landscaped with grasses, low-lying shrubs as well as Japanese Stewartia, Serbian Spruce and Osakazuki Japanese Maple trees.

TREES

Connor Corbett, ISA Certified Arborist of Diamond Head Consulting Ltd. prepared an Arborist
Assessment for the subject property. The table below provides a summary of the tree retention
and removal by tree species:

Table 1: Summary of Tree Preservation by Tree Species:

Tree Species	Existing	Remove	Retain	
Alder and Cottonwood Trees				
Alder/Cottonwood	2	1	1	
Deciduous Trees (excluding Alder and Cottonwood Trees)				
Apple	1	1	0	
Cherry	1	0	1	
Holly	1	1	0	
Coniferous Trees				
Pine	1	0	1	
Spruce	35	2	33	
Douglas-fir	3	0	3	
Cedar	2	0	2	
Total (excluding Alder and Cottonwood Trees)	44	4	40	

Total Replacement Trees Proposed (excluding Boulevard Street Trees)	3
Total Retained and Replacement Trees	43
Contribution to the Green City Fund	\$2,400

- The Arborist Assessment states that there are a total of 44 protected trees on the site, excluding Alder and Cottonwood trees. 2 existing trees, approximately 4% of the total trees on the site, are Alder and Cottonwood trees. It was determined that 40 trees can be retained as part of this development proposal. The proposed tree retention was assessed taking into consideration the location of services, building footprints, road dedication and proposed lot grading.
- For those trees that cannot be retained, the applicant will be required to plant trees on a 1 to 1 replacement ratio for Alder and Cottonwood trees, and a 2 to 1 replacement ratio for all other trees. This will require a total of 9 replacement trees on the site. Since only 3 replacement trees can be accommodated on the site, the deficit of 6 replacement trees will require a cashin-lieu payment of \$2,400, representing \$400 per tree, to the Green City Fund, in accordance with the City's Tree Protection By-law.
- In summary, a total of 41 trees are proposed to be retained on the site with a contribution of \$2,400 to the Green City Fund.

PRE-NOTIFICATION

• In accordance with Council policy, a development proposal sign was erected on June 26, 2018 and a pre-notification letter was sent on June 13, 2018. Staff have not received any responses from adjacent property owners with respect to the proposed Temporary Use Permit (TUP).

INFORMATION ATTACHED TO THIS REPORT

The following information is attached to this Report:

Appendix I. Lot Owners and Action Summary (Confidential)

Appendix II. Site Plan, Building Elevation Drawings and Landscape Plans

Appendix III. Engineering Summary
Appendix IV. Tree Preservation Summary

Appendix V. Temporary Use Permit No. 7918-0159-00

original signed by Ron Gill

Jean Lamontagne General Manager Planning and Development

MRJ/cm

APPENDIX I HAS BEEN

REMOVED AS IT CONTAINS

CONFIDENTIAL INFORMATION

ABBREVIATIONS AIR BARRIER ALBERTA BUILDING CODE ABOVE AREA DRAIN AFF ABOVE FINISHED FLOOR AIR HANDLING UNIT ALUM ALUMINUM ANN ANNUNCIATOR ARCH ARCHITECTURAL ARCHITECTURAL WOOD WORK ACOUSTIC WALL PANEL BULLETIN BOARD BASEBOARD HEATER BCBC BRITISH COLUMBIA BUILDING CODE BLDG BUILDING BLW BELOW BOC BOTTOM OF CURB BOTTOM OF STEE BOW BOTTOM OF WALL BSMT BASEMENT BTWN BETWEEN CORNER GUARD CAST-IN-PLACE CONTROL JOINT CENTERLINE CLG CEILING CLR CLEAR CONSTRUCTION MANAGER CLEANOUT CONC CONCRETE CONT CONTINUOUS CARPET CERAMIC TILE CUST CUSTODIAL COLD WATER COMPLETE WITH DECIBEL DIAMETER DIM DIMENSION(S) DCW DOMESTIC COLD WATER DHW DOMESTIC HOT WATER DHWT DOMESTIC HOT WATER TANK DOWN

DOWNSPOUT

DW DISHWASHER

DWG DRAWING

EXHAUST AIR **EXHAUST FAN EXPANSION JOINT** ELEC ELECTRICAL ELEV ELEVATION EXPANDED POLYSTYRENE EXT EXTERIOR FIBER CEMENT PANEL FIRE EXTINGUISHER

ENERGY RECOVERY VENTILATOR FINISH FLOOR ELEVATION FNDN FOUNDATION FACE OF CONCRETE FACE OF FINISH FRIDGE / REFRIGERATOR FIRE RESISTANCE RATING FOOT / FEET

FTG FOOTING FURN FURNITURE GALV GALVANIZED GENERAL CONTRACTOR GROUND FAULT INTERRUPTER GLASS / GLAZING / GLAZED GROUND HOSE BIB (WALL HYDRANT) **HOLLOW METAL** HORIZONTAL

GWB GYPSUM (WALL) BOARD HORIZ HEAT RECOVERY VENTILATOR HRV HOLLOW STEEL SECTION HOT WATER HOT WATER HEATER HOT WATER RETURN HWR HOT WATER SUPPLY HOT WATER TANK INSIDER DIAMETER INCHES

INFORMATION INSUL INSULATE / INSULATED INVERT JAN JANITOR / JANITORIAL "L" ANGLE LAMINATED LAV LAVATORY

POUND LINEAR FOOT LEFT HAND LEFT HAND REVERSE METERS MAXIMUM

LAMINATED VENEER LUMBER MECH MECHANICAL MEZZANINE MEDIUM DENSITY FIBERBOARD THOUSANDTH OF AN INCH (0.001") MIN MINIMIM MIRROR MILLIMETERS METAL MTL MICROWAVE MWP METAL WALL PANEL NA / N/A NOT APPLICABLE NIC NOT IN CONTRACT

NTS NOT TO SCALE

OC / O.C. ON CENTER

OPNG OPENING

OUTDOOR AIR

OSB ORIENTED STRAND BOARD

PROPERTY LINE

PTD PAPER TOWEL DISPENSER

PLATE (STEEL)

PLAM PLASTIC LAMINATE

PREFAB PREFABRICATED

RISER

RCP

REV

RETURN AIR

RUBBER BASE

ROLLER BLIND

REFER TO

REVISION

ROOM

ROW RIGHT OF WAY

ROOF DRAIN

ROUGH OPENING

RAINWATER LEADER

REOD REOUIRED

REFLECTED CEILING PLAN

PAINT

OD OUTSIDE DIAMETER

TONGUE & GROOVE TO BE CONFIRMED TO BE DETERMINED TELEPHONE TOP OF CONCRETE / TOP OF CURB TOP OF STEEL TOW TOP OF WALL TPD TOILET PAPER DISPENSER TREAD TRIM TYPE NUMBER # TYP TYPICAL UNO UR URINAL VCT

SUPPLY AIR

SANITARY

STRC STRUCTURAL

SOAP DISPENSER

STAINLESS STEEL

SOUARE FOOT

SELF-ADHERED MEMBRANE

SANITARY NAPKIN DISPENSER

SOUND TRANSMISSION CLASS

SANITARY NAPKIN WASTE (BIN)

SPRAY-APPLIED POLYURETHANE FOAM

S/A

SST

UNLESS NOTED OTHERWISE UTIL UTILITY VAPOUR BARRIER VINYL COMPOSITION TILE VERT VERTICAL VERIFY IN FIELD VAPOUR RETARDER WITH W/O WITHOUT WHITEBOARD WATERCLOSE1

WOOD WIDE FLANGE WORK POINT XPS

EXTRUDED POLYSTYRENE PLUS/MINUS

D222b AW22

GLAZING OPENING WINDOW NUMBER CASEWORK/MILLWORK TAG

SIGNAGE INDICATOR

MATCH LINE

ASSEMBLY TAG

DOOR TAG

ADJACENT SHEET NUMBER

CON1


NUMBER OF TREADS AND SIZE NUMBER OF RISERS AND SIZE LEVEL DATUM

ROOM TAG

ROOM NUMBER

WORK POINT

ROOM NAME

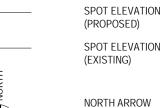

REVISION INDICATOR CLOUD AROUND REVISION REVISION NUMBER

CENTER LINE PROPERTY LINE — - - — H FIRE-RATED PARTITION

_---2 HOURS EXISTING CONSTRUCTION 25. REFER TO ENLARGED TOILET ROOM PLANS AND NEW CONSTRUCTION TO BE DEMOLISHED

TYPICAL DEVICE MOUNTING **ELEVATIONS (UNO)**

THERMOSTAT, HVAC SENSOR/ 🖫 🎱 — 60-64" CONTROL, SECURITY KEYPAD FIRE ALARM PULL STATION SWITCH, A/V CONTROL SECURITY CARD READER ELECTRICAL RECEPTACLE, ₿ — 8" CABLE (CATV), TELEPHONE - , — — — FINISHED FLOOR LEVEL

INSTALL 8" FROM ADJACENT WALL/DOORWAY / TYP

1. CONFIRM LOCATIONS OF ALL EXPOSED TO VIEW MECHANICAL, FIRE PROTECTION, ELECTRICAL, LIGHTING, AND SECURITY DEVICES WITH ARCHITECT

2. WHERE MULTIPLE ADJACENT DEVICES ARE INSTALLED AT A COMMON ELEVATION, GANG TOGETHER UNDER A SINGLE COVERPLATE

3. CENTER MULTIPLE DEVICES IN A VERTICALLY

DEVICE MOUNTING NOTES

PRIOR TO INSTALLATION.

ALIGNED MANNER WHEREVER POSSIBLE 4. UNLESS NOTED OTHERWISE, PROVIDE LEVITON "DECORA PLUS" SERIES SCREWLESS COVERPLATES. COLOUR: WHITE DEVICES + WHITE COVERPLATES IN WHITE WALLS; BLACK DEVICES + BLACK COVERPLATES IN BLACK/GREY WALLS.

GENERAL NOTES

1. ALL WORK TO COMPLY WITH BRITISH COLUMBIA BUILDING CODE 2012 VOLUME 1 AND VOLUME 2, AND OTHER APPLICABLE CODES AND

ORDINANCES. 2. VERIFY AND COORDINATE SITE CONDITIONS AND DIMENSIONS. BRING INCONSISTENCIES TO ATTENTION OF ARCHITECT BEFORE PROCEEDING WITH WORK. 3. PERFORM EXCAVATION AND FOUNDATION WORK IN CONFORMANCE WITH THE REQUIREMENTS OF

MEASUREMENTS. NOTIFY ARCHITECT OF

7. ALL DIMENSIONS ARE TO FINISH FACE OF

MASONRY, AND CENTERLINE OF COLUMNS.

UNLESS NOTED OTHERWISE. DIMENSIONS IN

8. DRAWINGS AND SPECIFICATIONS: EXAMINE AND

PARTITION OR CEILING, FACE OF CONCRETE OR

ALTERNATE UNITS (E.G. METRIC VS IMPERIAL) ARE

BUILDING SECTION THE GEOTECHNICAL ASSESSMENT AND CONSTRUCTION DOCUMENTS. 4. PROVIDE BUILDING SUBSURFACE DRAINAGE SYSTEM IN ACCORDANCE WITH THE GEOTECHNICAL ASSESSMENT.

WALL SECTION DRAWING NUMBER 5. IMMEDIATELY BRING ERRORS AND OMISSIONS FOUND IN THESE DRAWINGS TO ATTENTION OF ARCHITECT DETAIL REFERENCE 6. DO NOT SCALE DRAWINGS. FOLLOW DIMENSIONS SHOWN ON DRAWINGS AND ACTUAL FIELD

SHEET NUMBER

A2.22

2 < (A2.22)

A2.22

ARCHITECTURAL

GRAPHIC SYMBOL LEGEND

22 DRAWING NAME
1:2000 VIEW TO

DRAWING NUMBER

VIEW TITLE

DRAWING NUMBER DRAWING SCALE

DRAWING NUMBER


SHEET NUMBER



IN [BRACKETS], ADJUST LOCATION OF GYPSUM BOARD ASSEMBLY TYPES TO ALLOW FOR SCHEDULED APPLICATION OF SKIM AND FEATHER COATS, TAPE AND SPACKLE, VENEER PLASTERS, AND TRIM SHAPES AS REQUIRED IN ORDER TO MAINTAIN DIMENSIONS AND CRITICAL ALIGNMENTS

DISCREPANCIES.

INDICATED AT DRAWINGS.

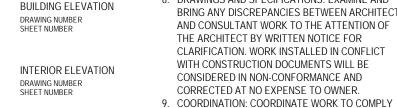

CORRECTED AT NO EXPENSE TO OWNER. 9. COORDINATION: COORDINATE WORK TO COMPLY WITH DRAWINGS AND SPECIFICATIONS AND TO ACCURATELY LOCATE OPENINGS FOR MECHANICAL, ELECTRICAL AND OTHER EQUIPMENT SO AS TO NOT INTERFERE WITH STRUCTURAL FRAMING 10. FOLLOW MANUFACTURER'S INSTRUCTIONS.

EXCEPT WHERE MORE STRINGENT REQUIREMENTS ARE INDICATED OR REQUIRED BY 11 PROVIDE AND INSTALL SOLID BLOCKING AND

BACKING FOR WALL- AND CEILING-MOUNTED 12. INSTALL GYPSUM BOARD ON BOTH SIDES OF WALL FRAMING, UNINTERRUPTED FROM FLOOR TO UNDERSIDE OF ROOF DECK, UNLESS NOTED

13. ATTACH PIPING IN ACOUSTICALLY SEPARATED WALLS WITH VIBRATION ISOLATORS, ISOLATE PIPING IN CONTACT WITH CONSTRUCTION. 14. MOUNT SWITCHES 42" [1100] ABOVE FINISHED FLOOR UNLESS NOTED OTHERWISE. VERIFY SWITCH AND OUTLET HEIGHTS ABOVE CASEWORK TO CLEAR BACKSPLASH

DRAIN INSTALLATION WITH EQUIPMENT

CODE REQUIREMENTS.

SUBCONTRACTOR.

0 FINISHES: IN FINISHE

THE WORK. PROVIDE AND INSTALL SEISMIC

BRACING AND FASTENING IN ACCORDANCE WITH

18. COORDINATE EXACT LOCATION OF PLUMBING AND PIPING WORK INTERFACING OTHER BUILDING

EXPOSED PIPE, CONDUITS, DUCTS, ETC. CONCEAL

UTILITY LINES BEHIND FINISHED CONSTRUCTION

CONSTRUCTION ON DRAWINGS OR APPROVED BY ARCHITECT. IF WORK CANNOT BE CONCEALED

UNLESS NOTED AS EXPOSED TO VIEW

WITHIN FINISHED CONSTRUCTION OF THE

ADJACENT FINISH TO CONCEAL WORK. COORDINATE WITH ARCHITECT.

SURFACES FLUSH AND TRUE TO LINE. 21. PROVIDE GALVANIC ISOLATION BETWEEN

DISSIMILAR METALS.

CONTRACT DOCUMENTS, THE CONTRACTOR

SHALL PROVIDE & INSTALL FURRED & FINISHEI

HORIZONTAL & VERTICAL CHASES TO MATCH

20. OFFSET AND ADJUST FRAMING TO MAKE FINISHED

22. LOCATE FIRE EXTINGUISHER CABINETS AS SHOWN

ADDITIONAL FIRE EXTINGUISHERS AS REQUIRED

BY BUILDING CODE AND NEPA 10: STANDARD FOR

PORTABLE FIRE EXTINGUISHERS. COORDINATE

23. COORDINATE INSTALLATION OF FIRE PROTECTION

PLUMBING, AND ELECTRICAL WORK TO ENSURE

AND FINISH MATERIAL ACRONYMS INDICATED AT

ELEVATIONS FOR TOILET ROOM ACCESSORIES

26. PROMPTLY BRING CONFLICTS AND OMISSIONS IN

FINISH MATERIALS LIST AND OTHER GRAPHIC

INDICATORS TO ARCHITECT'S ATTENTION FOR

DEVICES AND EQUIPMENT PROVIDED UNDER

28. ALL EXISTING AND NEW SERVICE PENETRATIONS

FIRESTOPPED, INCLUDING BUT NOT LIMITED TO

CUSTODIAL ROOMS, MECHANICAL ROOMS, AND

THROUGH FIRE-RATED ASSEMBLIES TO BE

FIRE-RATED FLOOR ASSEMBLIES.

WORK OF OTHER DISCIPLINES INCLUDING BUT NOT LIMITED TO MECHANICAL, ELECTRICAL, SECURITY,

NO CONFLICT AS A RESULT OF FIRE PROTECTION

EXACT LOCATION OF SUPPLEMENTAL FIRE

EXTINGUISHERS AND FIRE EXTINGUISHER

SYSTEM WITH STRUCTURAL, MECHANICAL,

24. REFER TO FINISH SYMBOLS LEGEND WHERE APPLICABLE FOR ADDITIONAL ABBREVIATIONS

DRAWINGS AND SPECIFICATIONS.

ABBREVIATIONS AND ACRONYMS.

INTERPRETATION AND DIRECTION. 27. REFER TO ARCHITECTURAL DRAWINGS FOR EXACT LOCATIONS OF ALL EXPOSED TO VIEW

AND AUDIO VISUAL

CABINETS WITH ARCHITECT.

SYSTEM INSTALLATION.

ON PLANS. PROVIDE EXTINGUISHER TYPE AND

SYSTEMS AND ASSEMBLIES WITH PLUMBING

15. ISOLATE AND OFFSET OUTLETS ONE STUD SPACE MINIMUM AT SOUND WALLS TO PREVENT SOUND TRANSMISSION. 16. COORDINATE SIZES AND LOCATIONS OF OPENINGS AND ROUGH-INS FOR MECHANICAL 1 HR EQUIPMENT WITH MECHANICAL CONTRACTOR, 1.5 HR AND SHOP DRAWINGS REVIEWED BY ARCHITECT BEFORE PROCEEDING WITH THE WORK.

1 HR 1.5 HR NOTE: NO FIRE SEPARATIONS IN PROJECT 17. VERIFY SIZES AND LOCATIONS OF MECHANICAL NUMBER OF REQUIRED EXITS [9.9.8.2] EQUIPMENT PADS, BASES, POWER, WATER AND MANUFACTURERS BEFORE PROCEEDING WITH

BUILDING CODE SUMMARY

PRIVATE: MIN (mm) MAX (mm)

PUBLIC: MIN (mm) MAX (mm)

TREAD 280 NO LIMIT

MINIMUM STAIR WIDTH = 860mm

MINIMUM EXIT STAIR WIDTH = 900mm

AND SURFACE BEHIND [9.8.7.5.(1)]

SMOKE ALARMS [9.10.19.]

REQUIRED LOCATIONS:

FIRE EXTINGUISHERS

[3.8.2.3.(1) AND (2)]

[9.10.14.4.A.]

SPATIAL SEPARATION SUMMARY

BUILDING FACE

NORTH 358sf (33m2) 140'-0" (43m) 100%

| SOUTH | 437sf (41m2) | 90'-0" (27m) | 100%

| WEST | 825sf (77m2) | 62'-0" (19m) | 100%

EAST | 880sf (82m2) | 65'-0" (20m) | 100%

TREAD 235 355

125 200

210 355

125 180

280 NO LIMIT

50MM CLEARANCE BETWEEN GRASPABLE RAIL

SOUND TRANSMISSION CLASS (STC) RATINGS

AND ALL OTHER SPACES IN THE BUILDING

TO BE INSTALLED AT OR NEAR THE CEILING.

- MIN 1 ON EACH STOREY [9.10.19.3.1.(a)]

- IN EACH DWELLING UNIT AND IN EACH

— PROVIDE EMEGENCY LIGHTING IN EXIT

POWER TO BE PROVIDED TO EMERGENCY

LIGHITNG FOR A MIMIMUM OF 30 MINS IN THE

CASE OF A POWER INTERRUPTION. [9.9.12.3.(3)]

PROVIDE FIRE EXTINGUISHERS IN OR ADJACENT

— ACCESSIBLE WASHROOM TO BE PROVIDED

ELEV- AREA OF LIMITING PERMITTED AREA ACTUAL

ATION EXPOSING DISTANCE OF UNPROTECTED AREA

OPENINGS

26%

28%

SMOKE ALARMS WITHIN DWELLING UNITS TO BE

CORRIDORS AT AN AVERAGE OF 10 LX AT FLOOR

— ALL EMERGENCY LIGHTING TO BE POWERED BY

A SUPPLY SEPARATE FROM THE BUILDING POWER

— AUTOMATICALLY ACTUATED BACKUP BATTERY

SLEEPING ROOM [9.10.19.3.1.(b)]

INTERCONNECTED [9.10.19.5]

LIGHTING & EMERGENCY POWER

AND/OR TREAD LEVEL. [9.9.12.3.(4)]

MIN STC 50 REQUIRED BETWEEN DWELLING UNITS

RISER

RUN

RISER

HANDRAILS

BUILDING CODE BC BUILDING CODE 2012 DOORS, INC. EXIT DOORS [9.9.6.2, 9.9.6.3] MIN HEIGHT 2030mm [80", 6'-8"] BUILDING AREA 238.8m² [2571 SF] MIN WIDTH 800mm [31.5"] CLEAR WIDTH

CODE APPLICATION PART 9 OCCUPANT LOAD [9.9.1.3.]

BUILDING HEIGHT 1 STOREY

 REAL ESTATE PRE-SALES CENTRE (MERCANTILE) • 186.5 M² @ 3.70 M²/PERSON = 51 PERSONS OFFICE 42.1 M² @ 9.30 M²/PERSON = 5 PERSONS

TOTAL: 56 PERSONS DIMENSIONS OF MEANS OF EGRESS [9.9.3] MIN 1100 FOR PUBLIC CORRIDORS (SERVING MORE THAN 1 SUITE); 900 OTHERWISE - MIN CLEAR HEIGHT: 2100 TYP

OCCUPANCY CLASSIFICATION [9.10.2.] MAJOR OCCUPANCY GROUP E: MERCANTILE (GROUND FLOOR) SECONDARY OCCUPANCY GROUP D: OFFICE (GROUND FLOOR)

MEMBRANES [9.10.5.] MEMBRANES FOR ASSEMBLIES W/ FIRE RESISTANCE RATINGS SHALL NOT BE PIERCED BY OPENINGS, — ELECTRICAL OUTLET BOXES (OR SIMILAR) PROVIDED THEY ARE TIGHTLY FITTED (OFFSET BY MIN. ONE STUD CAVITY AND BLOCK ABOVE/BELOW WHERE 2 DEVICES ARE ON OPPOSITE SIDES OF THE ASSEMBLY)

PERMITTED OPENINGS IN WALL AND CEILING

— WHERE FRR IS ASSIGNED PER TABLE A-9.10.3.1.B OR APPENDIX D, OPENINGS TO DUCTS W/IN CEILING SPACE PERMITTED PER APPENDIX D CONSTRUCTION PERMITTED COMBUSTIBLE AND/OR NONCOMBUSTIBLE

[3.2.2.60.] GROUP D UP TO 2 STOREYS [3.2.2.66.] GROUP E UP TO 2 STOREYS REQUIRED ASSEMBLY RATINGS [9.10.8.] ROOFS: NOT RATED FLOORS: 45 MIN (N/A IN PROJECT) EXTERIOR WALLS: 1 HOUR [9.10.14.5.A]

TO CORRIDORS THAT PROVIDE ACCESS TO EXIT NOTE: LOADBEARING WALLS/COLUMNS IN STOREY ACCESSIBILITY REQUIREMENTS IMMEDIATELY BELOW A RATED FLOOR/ROOF ASSEMBLY SHALL HAVE FRR NOT LESS THAN THE SUPPORTED ASSEMBLY

FIRE SEPARATIONS [9.10.9] NONE IN PROJECT

SEPARATION OF OCCUPANCIES [9.10.9.11] NONE IN PROJECT

FIRE SUPPRESSION SYSTEM NOT REQUIRED [3.2.2.60., 3.2.2.66.] FIRE ALARM SYSTEM

NOT REQUIRED [9.10.18.2.(2)] CLOSURES IN FIRE SEPARATIONS [9.10.13.1] FRR OF FIRE SEPARATION MIN FRR OF CLOSURE 45 MIN 45 MIN

2 EXITS REQUIRED FROM FLOOR AREA, SPACED SO TRAVEL DISTANCE TO NEAREST EXIST IS NOT MORE THAN 30M [9.9.8.2.(1)(c)

PROJECT NOTES

REFER TO SURVEY PLAN PREPARED BY OLSEN & ASSOCIATES FOR PROPERTY LINES AND NATURAL GRADE TOPOGRAPHY

REFER TO GEOTECHNICAL REPORT FROM GEOPACIFIC CONSULTANTS LTD. FOR GEOTECHNICAL INFORMATION REFER TO ARBORICULTURAL INVENTORY AND

REPORT PREPARED BY *DIAMOND HEAD CONSULTING*

LEGAL DESCRIPTION

LOT 58 PLAN 27955, LOT 44 PLAN 17345 AND LOT 45 ALL OF SECTION 23 BLOCK 5 NORTH RANGE 2 WEST NEW WESTMINSTER DISTRICT

CIVIC ADDRESS 10575 / 10593 / 10605 - 139 ST, SURREY, BC, V3T 4L8

DEVELOPMENT STATISTICS

LOTS 10575 / 10593 / 10605 2951.7m² [31772 SF] SETBACKS FRONT YARD: 7.5m [25ft] REAR YEARD: 7.5m [25ft] SIDE YARD: 1.8m [6ft] HEIGHT: MAX 9m [30ft], MAX 7.3m [24ft] FOR ANY ROOF WITH SLOPE <1:4

CURRENT ZONING RF (SINGLE FAMILY RESIDENTIAL ZONE) BYLAW 12000, SECTION 16.1

106 Ave

PRE-SALE SITE

STREET, SURREY

10605, 10593,

10575 139TH

GROSS BUILDING AREA: 238.8m² [2571 SF] PARKING PROVIDED: 12 STALLS TOTAL (1 HC)

PROJECT DIRECTORY

MOSAIC T: 604-685-3888 STEPHANIE DA SILVA

MIZA ARCHITECTS INC

303 - 2425 QUEBEC ST. VANCOUVER, BC V5T 4L6 T: 604-800-6147 DAVID ZEIBIN, ARCHITECT AIBC MRAIC LEED AP BD+C E: DZEIBIN@MIZAARCHITECTS.COM M: 604-220-6921

STRUCTURAL CHRIS LEE TLSE STRUCTURAL ENGINEERING T: 604-873-1768 CHRIS.LEE@TLSE.CA

MECHANICAL RICHARD CORRA ROCKY POINT ENGINEERING LTD T: 604-888-7779 RICHARD.CORRA@RPENG.CA

ELECTRICAL MARC GAGER

CORMAC NOLAN CORE GROUP CONSULTANTS 320 - 8988 FRASERTON COURT, BURNABY, BC V5J 5H8 T: 604-299-0605

LANDSCAPE ARCHITECT JUDY STOYKO CONNECT LANDSCAPE ARCHITECTURE T: 604-681-3303 JUDY@CONNECTLA.CA

> DIAMOND HEAD CONSULTING 3559 COMMERCIAL ST, VANCOUVER BC V5N 4E8 T: 604-733-4886 CONOR@DIAMONDHEADCONSULTING.COM INTERIOR DESIGNER KRISTA CALERO INSIGHT DESIGN GROUP

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M: 604-761-8608

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208-20171 92A AVENUE, LANGLEY, BC V1M 3A5

20689 56TH AVENUE, LANGLEY, BC V3A 3Y9 T: 778-277-2225 MARC.GAGER@GAGERELECTRICAL.COM

CNOLAN@COREGROUPCONSULTANTS.COM

2305 HEMLOCK ST, VANCOUVER, BC V6H 2V1 ARBORIST CONOR CORBETT

STUDIO 200 - 1737 W 3 AVE, VANCOUVER, BC, V6J 1K7 T: 604-602-1750 D:778-945-6316 E: KRISTA@INSIGHTDESIGNINC.COM

Forsyth Park

MOSAIC PARKER

DEVELOPMENT

A0 GENERAL

A2 FLOOR PLANS

A4 ELEVATIONS

STRUCTURAL

A001

A101

A210

A401

COVER SHEET

SITE PLAN

FLOOR PLAN

ELEVATIONS

REFER TO DRAWING SET - S SERIES MECHANICAL REFER TO DRAWING SET - M SERIES

ELECTRICAL REFER TO DRAWING SET - E SERIES

REFER TO DRAWING SET - C SERIES LANDSCAPE ARCHITECT REFER TO DRAWING SET - L SERIES

INTERIOR DESIGNER REFER TO DRAWING SET - ID SERIES

APPLICATION NO. 18-0159 17 SEP 2018

13 17 SEP 2018 TUP RE-SUBMISSION 12 31 AUG 2018 TENDER 11 30 JULY 2018 COORDINATION 10 26 JUNE 2018 BUILDING PERMIT 9 11 JUNE 2018 COORDINATION 8 08 JUNE 2018 TUP RE-SUBMISSION 7 06 JUNE 2018 COORDINATION 5 23 MAY 2018 COORDINATION 4 04 MAY 2018 COORDINATION


DESCRIPTION

NO DATE

SEAL

ISSUES + REVISIONS

CONTEXT PLAN
NOT TO SCALE

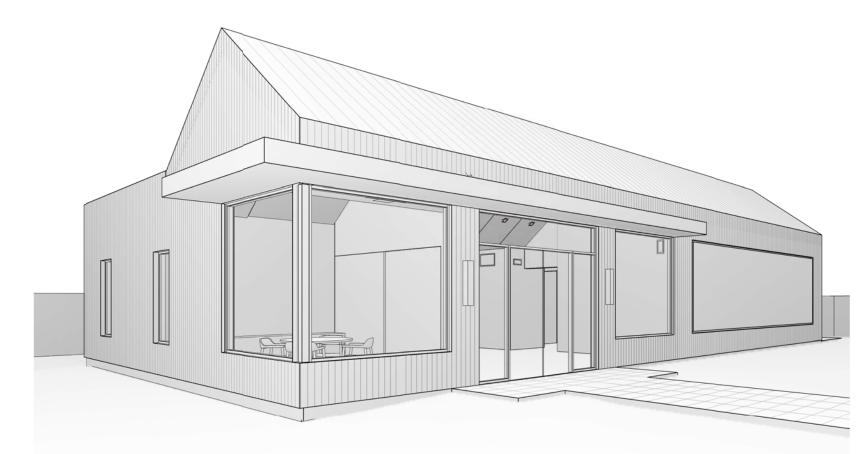

→ PERSPECTIVE VIEW

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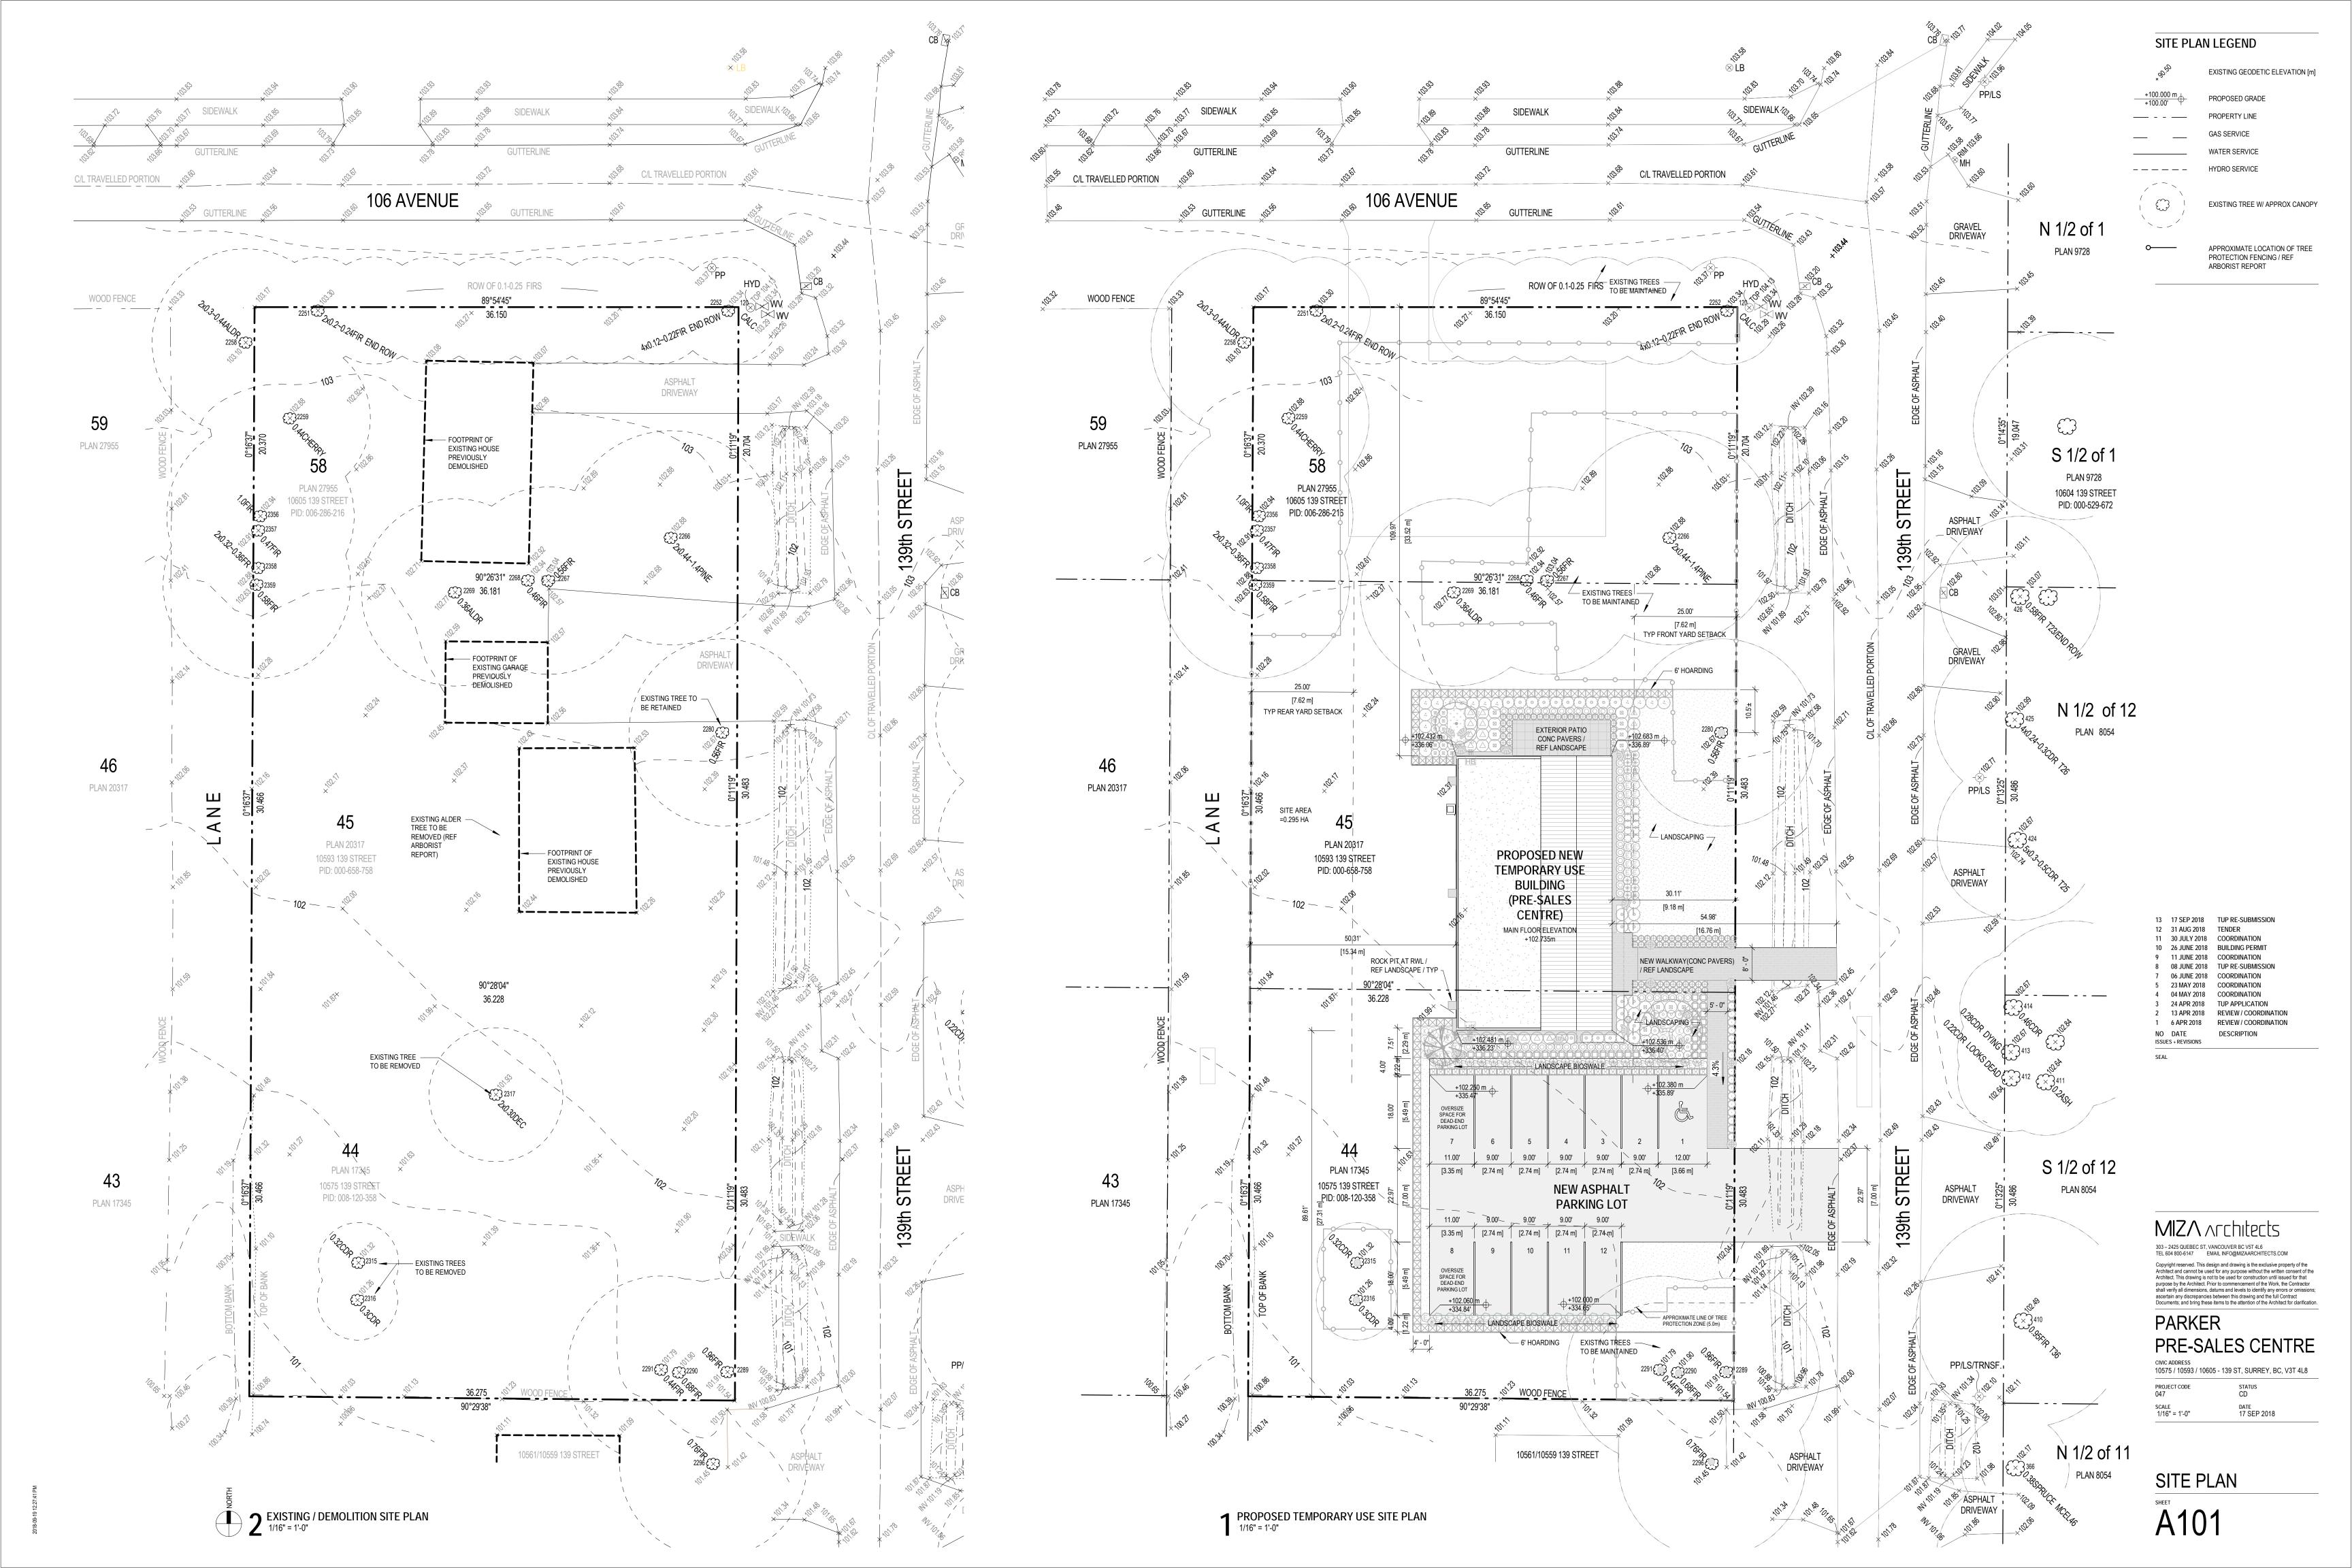
MIZA Architects


PARKER PRE-SALES CENTRE

10575 / 10593 / 10605 - 139 ST, SURREY, BC, V3T 4L8

PROJECT CODE 17 SEP 2018 As indicated

COVER SHEET



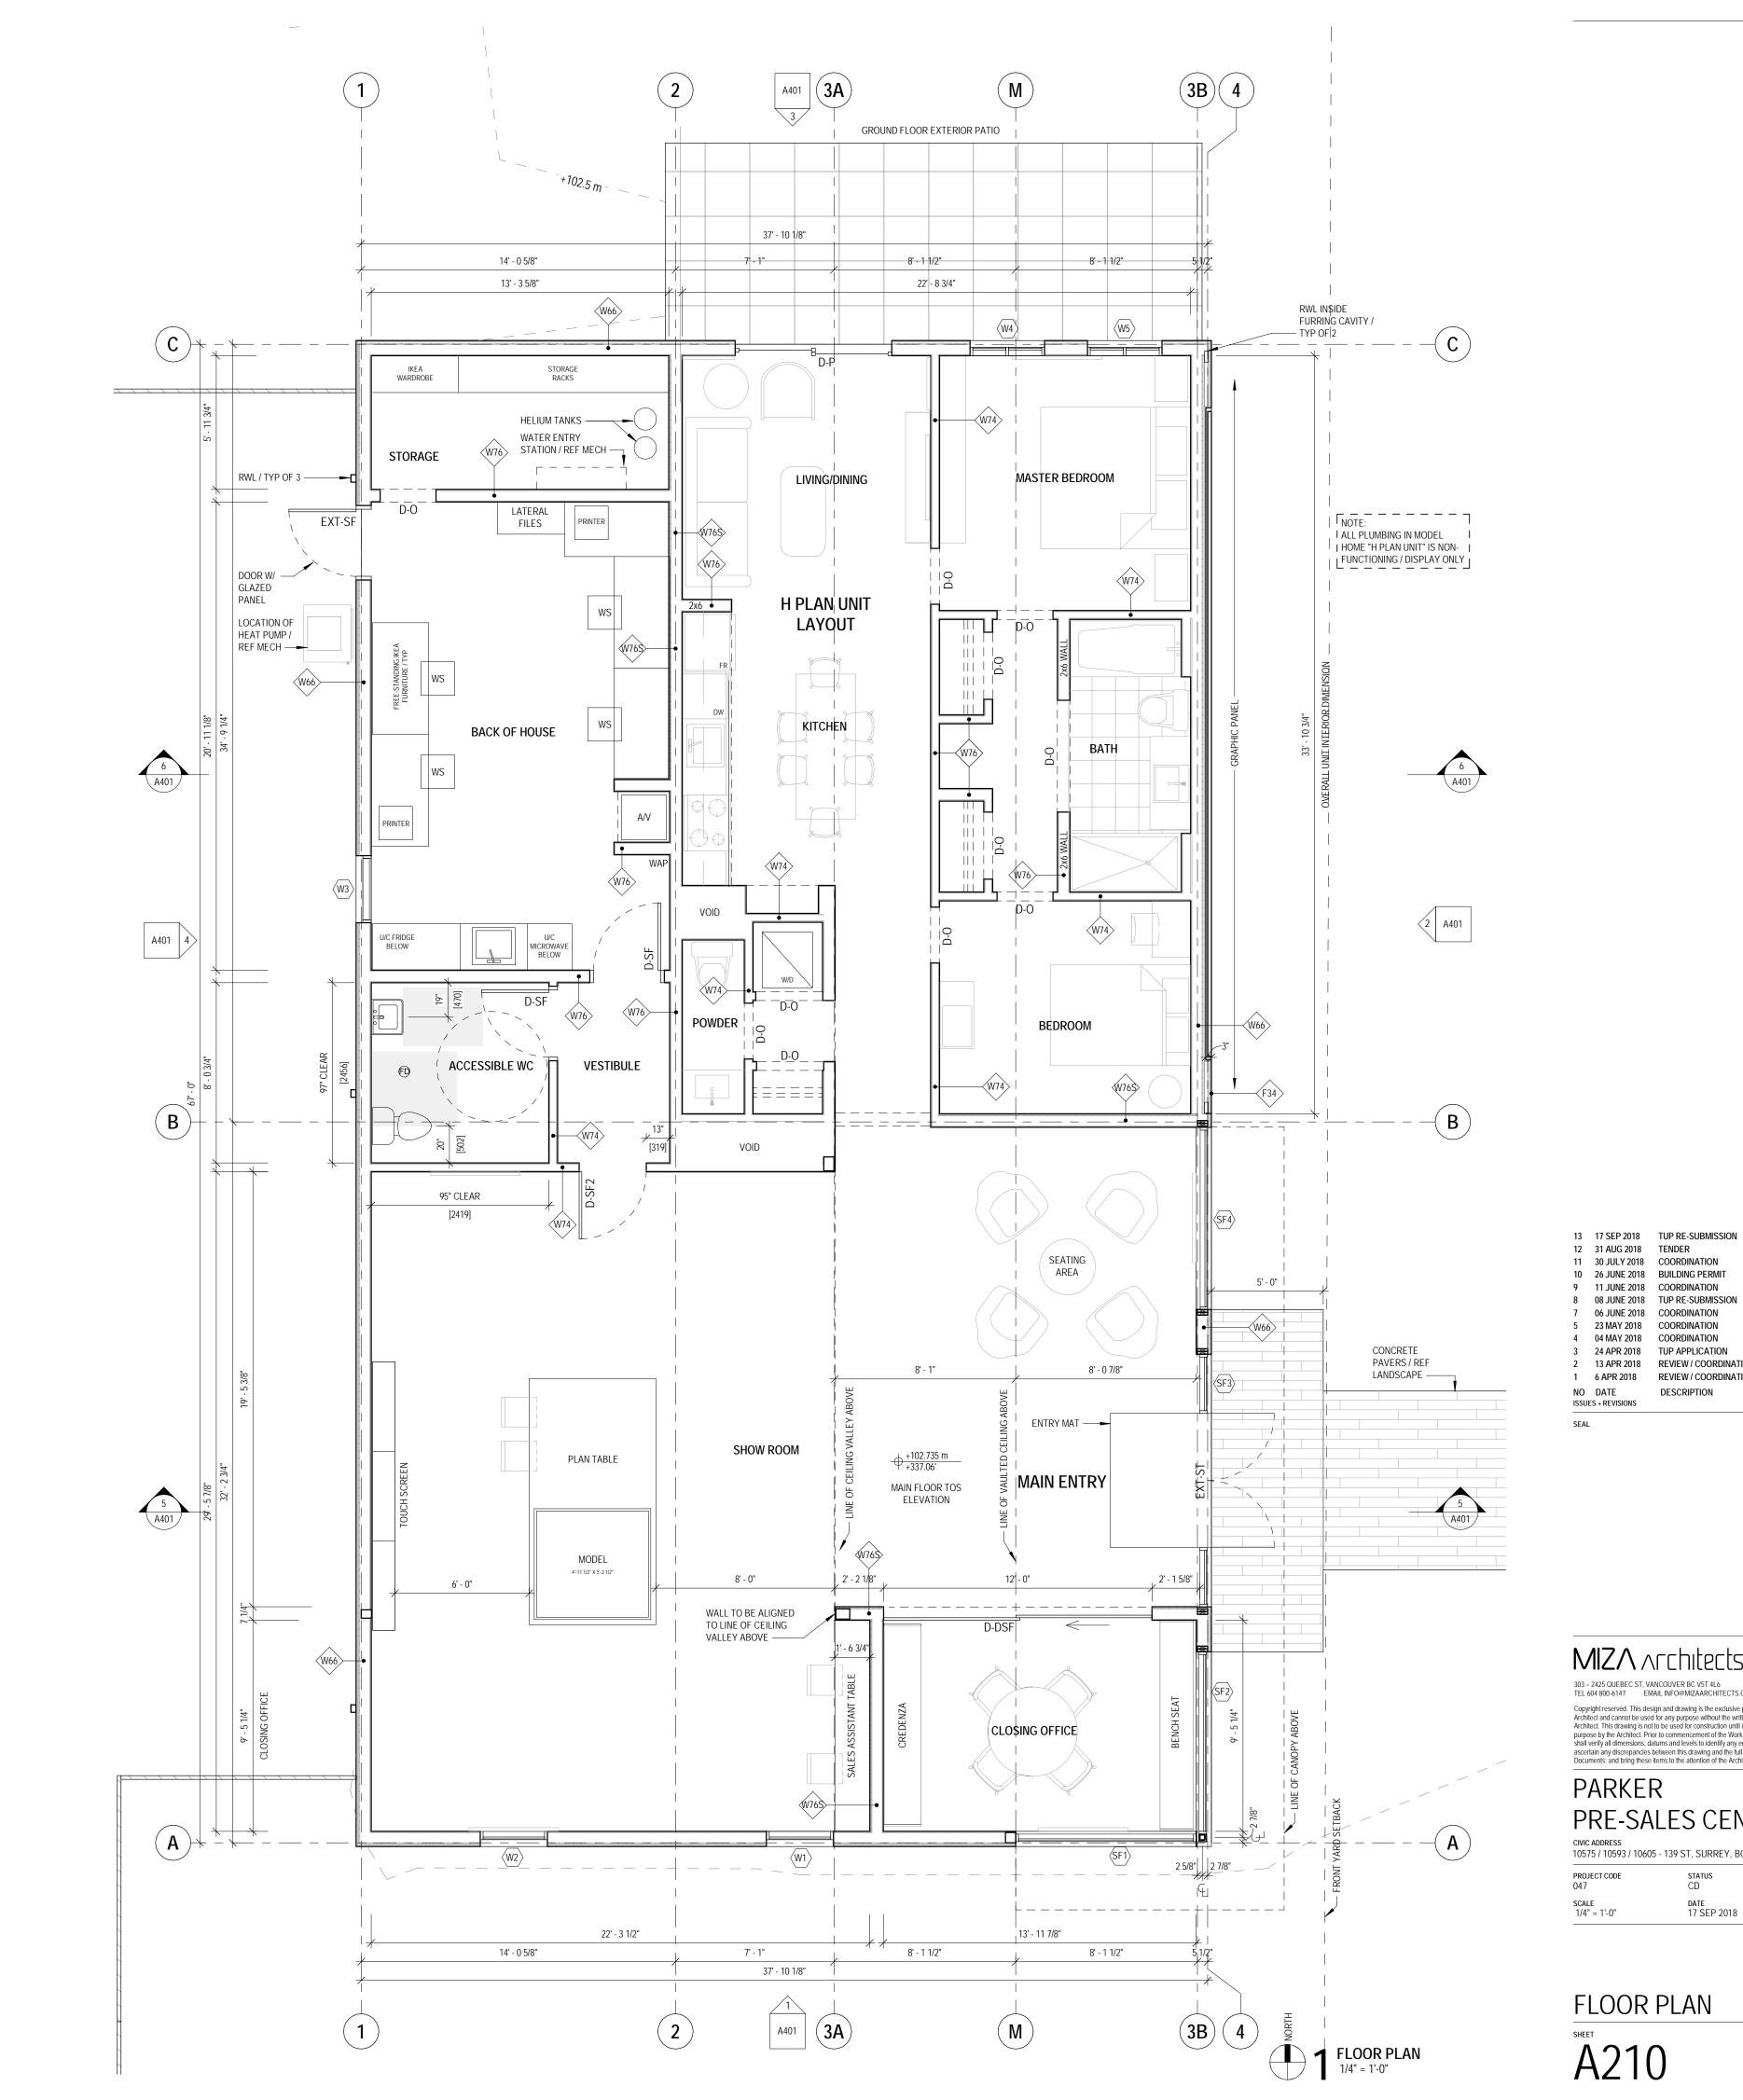

12 31 AUG 2018 TENDER
11 30 JULY 2018 COORDINATION 10 26 JUNE 2018 BUILDING PERMIT 9 11 JUNE 2018 COORDINATION 8 08 JUNE 2018 TUP RE-SUBMISSION 7 06 JUNE 2018 COORDINATION 5 23 MAY 2018 COORDINATION 4 04 MAY 2018 COORDINATION 3 24 APR 2018 TUP APPLICATION 2 13 APR 2018 REVIEW / COORDINATION 1 6 APR 2018 REVIEW / COORDINATION NO DATE ISSUES + REVISIONS DESCRIPTION SEAL

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PARKER

PRE-SALES CENTRE CIVIC ADDRESS 10575 / 10593 / 10605 - 139 ST, SURREY, BC, V3T 4L8

DATE 17 SEP 2018

FLOOR PLAN

A210





ELEVATIONS

SCALE As indicated DATE 17 SEP 2018

PRE-SALES CENTRE CIVIC ADDRESS 10575 / 10593 / 10605 - 139 ST, SURREY, BC, V3T 4L8 PROJECT CODE

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3 24 APR 2018 TUP APPLICATION

2 13 APR 2018 REVIEW / COORDINATION

1 6 APR 2018 REVIEW / COORDINATION

DESCRIPTION

MIZA Architects

NO DATE ISSUES + REVISIONS

SEAL

NORTH 358sf (33m2) 140'-0" (43m) 100% EAST 880sf (82m2) 65'-0" (20m) 100% 26% 29% 28% 2% SOUTH 437sf (41m2) 90'-0" (27m) 100% WEST 825sf (77m2) 62'-0" (19m) 100%

SPATIAL SEPARATION SUMMARY [9.10.14.4.A.] ELEV- AREA OF LIMITING PERMITTED AREA ACTUAL ATION EXPOSING DISTANCE OF UNPROTECTED AREA BUILDING FACE

4 BUILDING ELEVATION / WEST 3/16" = 1'-0"

6.2 -BEYOND 0.1
BEYOND 10'-0" U/S CEILING +347.06' [+105.783 m] 6.1 7.14 6.1 MAIN FLOOR +337.06' [+102.735 m] 7.12 8.1 8.8 7.12 $\langle 23.1 \rangle$ $\langle 3.1 \rangle$ 7.12

3/16" = 1'-0"

╷╙┩╃┩╇┩╇┩╇┩╇

7.13

3 BUILDING ELEVATION / NORTH 3/16" = 1'-0"

MAIN ENTRY

5 CROSS SECTION AT MAIN ENTRY 3/16" = 1'-0"

T/O ROOF +356.66' [+108.710 m]

_____10'-0" U/S CEILING +347.06' ••• [+105.783 m]

T/O ROOF +356.66' [+108.710 m]

10'-0" U/S CEILING +347.06' [+105.783 m]

MAIN FLOOR +337.06' [+102.735 m]

T/O FOOTING +334.89' [+102.075 m]

UPLIGHTING / REF LANDSCAPE

AND ELEC

— DRYWALL CEILING — WOOD CEILING PANEL

BUILDING ELEVATION / SOUTH

(3B) SETOUT POINT FOR CLADDING / ALIGN 🗡 🖚 T/O ROOF +356.66' [+108.710 m] TO ROOF RIDGE 7.3

BEYOND (0.1) / (7.1) - 10'-0" U/S CEILING +347.06' [+105.783 m] 12 6.1 6.3 | | | | | | | | | MAIN FLOOR +337.06' → [+102.735 m] UPLIGHTING / REF LANDSCAPE 8.8 $\langle 22.1 \rangle \langle 8.10 \rangle$ 7.13 3.1 8.8

SETOUT POINT FOR

8.8

SHOW ROOM

PLAN TABLE + MODEL

W66

8.7

8.8

CLADDING / ALIGN

TO ROOF RIDGE

SETOUT POINTS FOR CLADDING / ALIGN TO EDGES OF STOREFRONT DOOR SETOUT POINT FOR ROOFING 7.12 6.3 8.9

 $\left\langle 8.10\right\rangle \left\langle 26.1\right\rangle$

H PLAN UNIT

LAYOUT

BATH

6 CROSS SECTION AT UNIT LAYOUT 3/16" = 1'-0"

BACK OF HOUSE

8.10

8.10 26.1

22.1

└ VINYL-WRAPPED GRAPHIC PANEL

20.52 m² [221 SF] AREA 28'-10" X 7'-8"

T/O ROOF +356.66' [+108.710 m]

_____10'-0" U/S CEILING +347.06' ← [+105.783 m]

MAIN FLOOR +337.06' [+102.735 m]

T/O FOOTING +334.89' [+102.075 m]

 $\overline{\left\langle 7.12\right\rangle \left\langle 6.1\right\rangle }$

T/O ROOF +356.66' [+108.710 m]

3.1 7.12

2 BUILDING ELEVATION / EAST 3/16" = 1'-0"

MAIN FLOOR +337.06' [+102.735 m]

UPLIGHTING /

AND ELEC

SETOUT POINT

FOR ROOFING

AND CLADDING

REF LANDSCAPE

WOOD CLADDING MODULE / COLOUR TO BE CLOSEST MATCH TO WOOD CLADDING (TO BE CONFIRMED BY ARCHITECT AND OWNER) CANOPY SOFFIT / NATURAL CEDAR WITH CLEAR COAT FINISH

CAST-IN-PLACE CONC FOUNDATION / PAINT EXPOSED SURFACES BLACK ANCHOR BOLT WITH SILL GASKET / REF STRC 1x4 NOMINAL T&G WOOD SIDING ON 1x3 STRAPPING W/ BLACK PAINT FINISH / REF STANDING SEAM METAL ROOFING AT NOMINAL 12" O.C. / SEAMS TO ALIGN WITH

KEYNOTES — ELEVATIONS CANTLEVERED CANOPY

PREFINISHED METAL FLASHING

PAINTED METAL DOOR

CHAIN DRAIN HEAT PUMP / REF MECH

4 WALL CAP FOR HRV INTAKE / REF MECH

VINYL SLIDING DOOR
VINYL WINDOW W/ DOUBLE-GLAZING /

ANODIZED ALUMINUM BRAKE SHAPE 8.10 ALUMINUM STOREFRONT WINDOW/DOOR C/W DOUBLE-GLAZED INSULATED UNITS

26.1 EXTERIOR LIGHT FIXTURE / REF ELEC.

33.1 GRAVEL DRAIN STRIP / REF LANDSCAPE

2x6" RAIN WATER LEADER / REF LANDSCAPE

PROVIDE OPERABLE SECTIONS OF GLAZING
WHERE INDICATED

6' HIGH HOARDING/FENCE

PARKER PRE-SALES CENTRE

RE-ISSUED FOR TUP NOVEMBER 23, 2018

LANDSCAPE DRAWING INDEX

DRAWING INDEX		
SHEET No.	ET No. SHEET NAME	
L0.0	COVER SHEET AND DRAWING LIST	
L1.0	LAYOUT AND MATERIALS PLAN	
L2.0	PLANT LIST	
L2.1	PLANTING PLAN	
L3.0	IRRIGATION PLAN	
L4.0	DETAILS - SOFTSCAPE	
L4.1	DETAILS - HARDSCAPE	

GENERAL NOTES

ALL LANDSCAPE ARCHITECTURAL DRAWINGS IN THIS PACKAGE SHALL BE READ IN CONJUNCTION WITH ALL OTHER LANDSCAPE ARCHITECTURAL DRAWINGS, DETAILS, SPECIFICATIONS, AND OTHER CORRESPONDANCE THAT MAY BE ISSUED DURING THE COURSE OF THE CONTRACT.

IF A DISCREPANCY OCCURS BETWEEN THE DRAWINGS AND THE SPECIFICATIONS OR ANY OTHER DOCUMENT ASSOCIATED WITH THE PROJECT, THE CONFLICT SHALL BE REPORTED IN WRITING TO THE LANDSCAPE ARCHITECT TO OBTAIN CLARIFICATION AND APPROVAL BEFORE PROCEEDING WITH WORKS.

THE CONTRACTOR SHALL VISIT THE SITE TO VERIFY THE TRUE EXISTING CONDITIONS. ANY UNCLEAR ISSUES SHALL BE CLARIFIED WITH THE LANDSCAPE ARCHITECT. NO CLAIM SHALL BE ALLOWED FOR EXTRAS WHICH MAY ARISE THROUGH NEGLECT OF THIS ADVICE.

ALL EXISTING INFORMATION IS BASED ON AVAILABLE RECORDS AND SHALL NOT BE CONSTRUED TO BE COMPLETE OR ACCURATE.

LAYOUT OF HARDSCAPE, SITE FURNITURE, SOIL, PLANTING, AND ALL OTHER MATERIALS IS TO BE STAKED OUT AND APPROVED BY THE LANDSCAPE ARCHITECT PRIOR TO INSTALLATION.

ALL PLANTING SHALL BE IN ACCORDANCE WITH BC LANDSCAPE STANDARD, LATEST EDITION, AND CANADIAN LANDSCAPE STANDRAD, LATEST EDITION.

THE CONTRACTOR IS RESPONSIBLE FOR DETERMINING THE EXISTENCE, LOCATION, AND ELEVATION OF ALL UTILITIES AND CONCEALED STRUCTURES, AND IS RESPONSIBLE FOR NOTIFYING THE APPROPRIATE COMPANY, DEPARTMENT OR PERSON(S) OF ITS INTENTION TO CARRY OUT ITS OPERATIONS.

CONNECT LANDSCAPE ARCHITECTURE INC. DOES NOT GUARANTEE THE EXISTENCE, LOCATION, AND ELEVATION OF UTILITIES OR CONCEALED STRUCTURES AT THE PROJECT SITE.

FINAL SELECTION AND APPROVAL OF ALL STREET TREES TO BE DONE BY THE CITY OF SURREY.

ALL PUBLIC REALM DETAILS TO THE SATISFACTION OF THE CITY OF SURREY.



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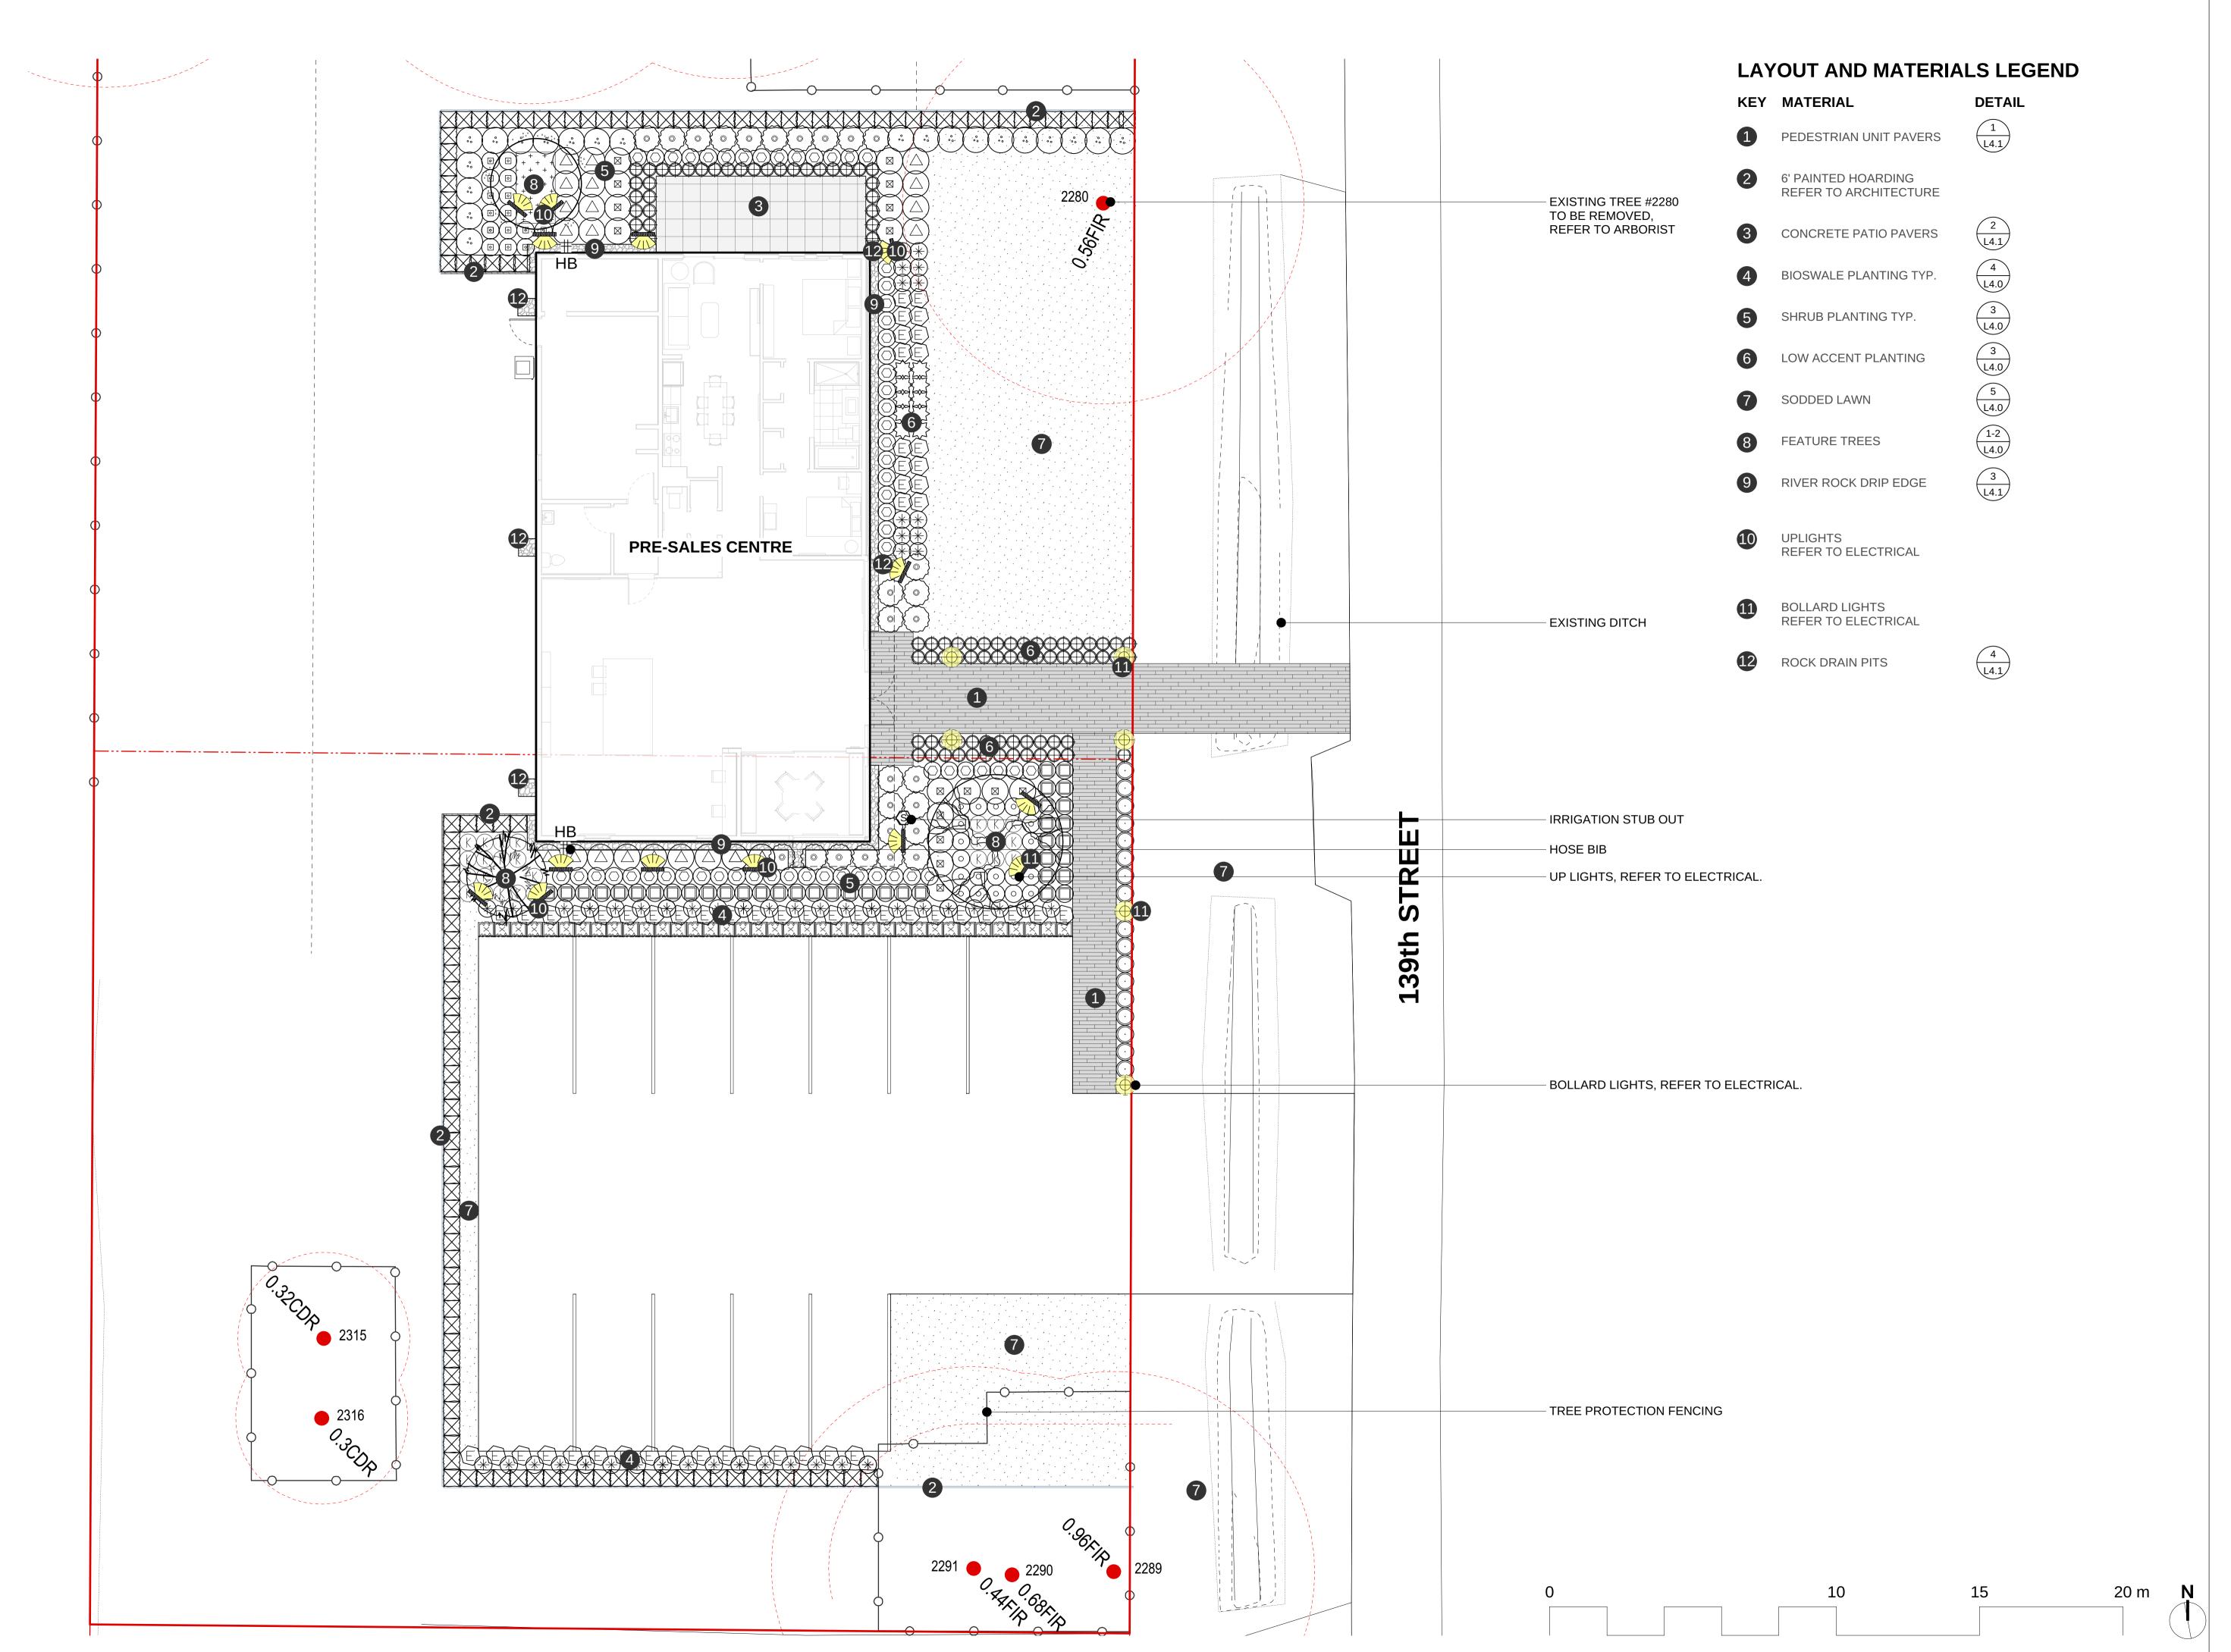
7	RE-ISSUED FOR TUP	18-11-23
6	RE-ISSUED FOR TUP	18-09-14
5	ISSUED FOR TENDER	18-08-31
4	ISSUED FOR DRAFT IFT REVIEW	18-08-03
3	ISSUED FOR BP	18-06-26
2	ISSUED FOR TUP	18-06-11
1	ISSUED FOR REVIEW	18-05-11
RE	VISIONS	

PARKER PRE-SALES CENTRE

10593 - 139 ST. Surrey, BC, V3T 4L8

Scale:	1:100
Drawn:	KW
Reviewed:	DS
Project No.	06-577

COVER SHEET AND DRAWING LIST





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7 RE-ISSUED FOR TUP

PARKER PRE-SALES CENTRE

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Scale:	1:100
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Reviewed:	DS
Project No.	06-577

LAYOUT AND MATERIALS PLAN

L1.0

PLANT LIST

205 Sodded lawn area (m2)

		TREES QTY.	BOTANICAL NAME	COMMON NAME	SIZE	SPACING
		1	Acer palmatum 'Osakazuki'	Osakazuki Japanese Maple	3M ht., B&B	as shown
		1	Picea omorika	Serbian Spruce	3M ht., B&B	as shown
		1	Stewartia pseudocamellia	Japanese Stewartia	5cm cal., B&B	as shown
		SHRUB	S			
• •		27	Hydrangea macrophylla	Bigleaf Hydrangea	#5 pot	36" o.c
	0	21	Pieris japonica 'Mountain Fire'	Lily-of-the-Valley Shrub	#5 pot	36" o.c
		16	Prunus laurocerasus 'Zabeliana'	Zabel's Cherry Laurel	#3 pot	24" o.c
	\triangle	23	Rhododendron 'Crete'	Pink Rhododendron	#5 pot	36" o.c
	(\boxtimes)	16	Rhododendron 'Hotei'	Yellow Rhododendron	#5 pot	36" o.c
		60	Rhododendron 'Ken Janeck'	Pink Yaku Rhododendron	#3 pot	24" o.c
	\odot	17	Sarcococca hookerana 'Humilis'	Himalayan Sweet Box	#3 pot	24" o.c
		38	Skimmia japonica	Japanese Skimmia	#3 pot	24" o.c
		37	Thuja occidentalis 'smaragd'	4' Emerald Cedar	#5 pot	24" o.c
		128	Thuja occidentalis 'smaragd'	6' Emerald Cedar	#5 pot	24" o.c
	\odot	21	Weigela florida 'Bokraspiwi'	Spilled Wine Weigela	#5 pot	36" o.c
		GROUN	ID COVERS AND VINES			
	K	24	Arctostaphylos uva ursi	Kinnikinnick	#1 pot	15" o.c
	+ + +	24	Pachysandra terminalis	Japanese Spurge	4"(10cm) pot	15" o.c
		PEREN	NIALS, GRASSES, BULBS, AND ANN	UALS		
	E	55	Echinacea purpurea	Purple Coneflower	#1 pot	18" o.c
		10	Hemerocallis 'Stella D'Oro'	Day Lily	#1 pot	18" o.c
	igoplus	93	Lavandula angustifolia	English Lavender	#1 pot	18" o.c
	*	61	Rudbeckia hirta	Black-Eyed Susan	#1 pot	24" o.c

PLANTING NOTES

- 1. ALL PLANTING SHALL BE IN ACCORDANCE WITH BC LANDSCAPE STANDARD, AND CANADIAN LANDSCAPE STANDARDS LATEST EDITION.
- 2. ALL TREE AND SHRUB BEDS ARE TO BE MULCHED WITH 50mm OF 2 MEDIUM FINE MULCH, LESS THAN 50mm DIAMETER.
- 3. ALL LANDSCAPE AREAS TO BE IRRIGATED WITH HIGH EFFICIENCY IRRIGATION SYSTEM.



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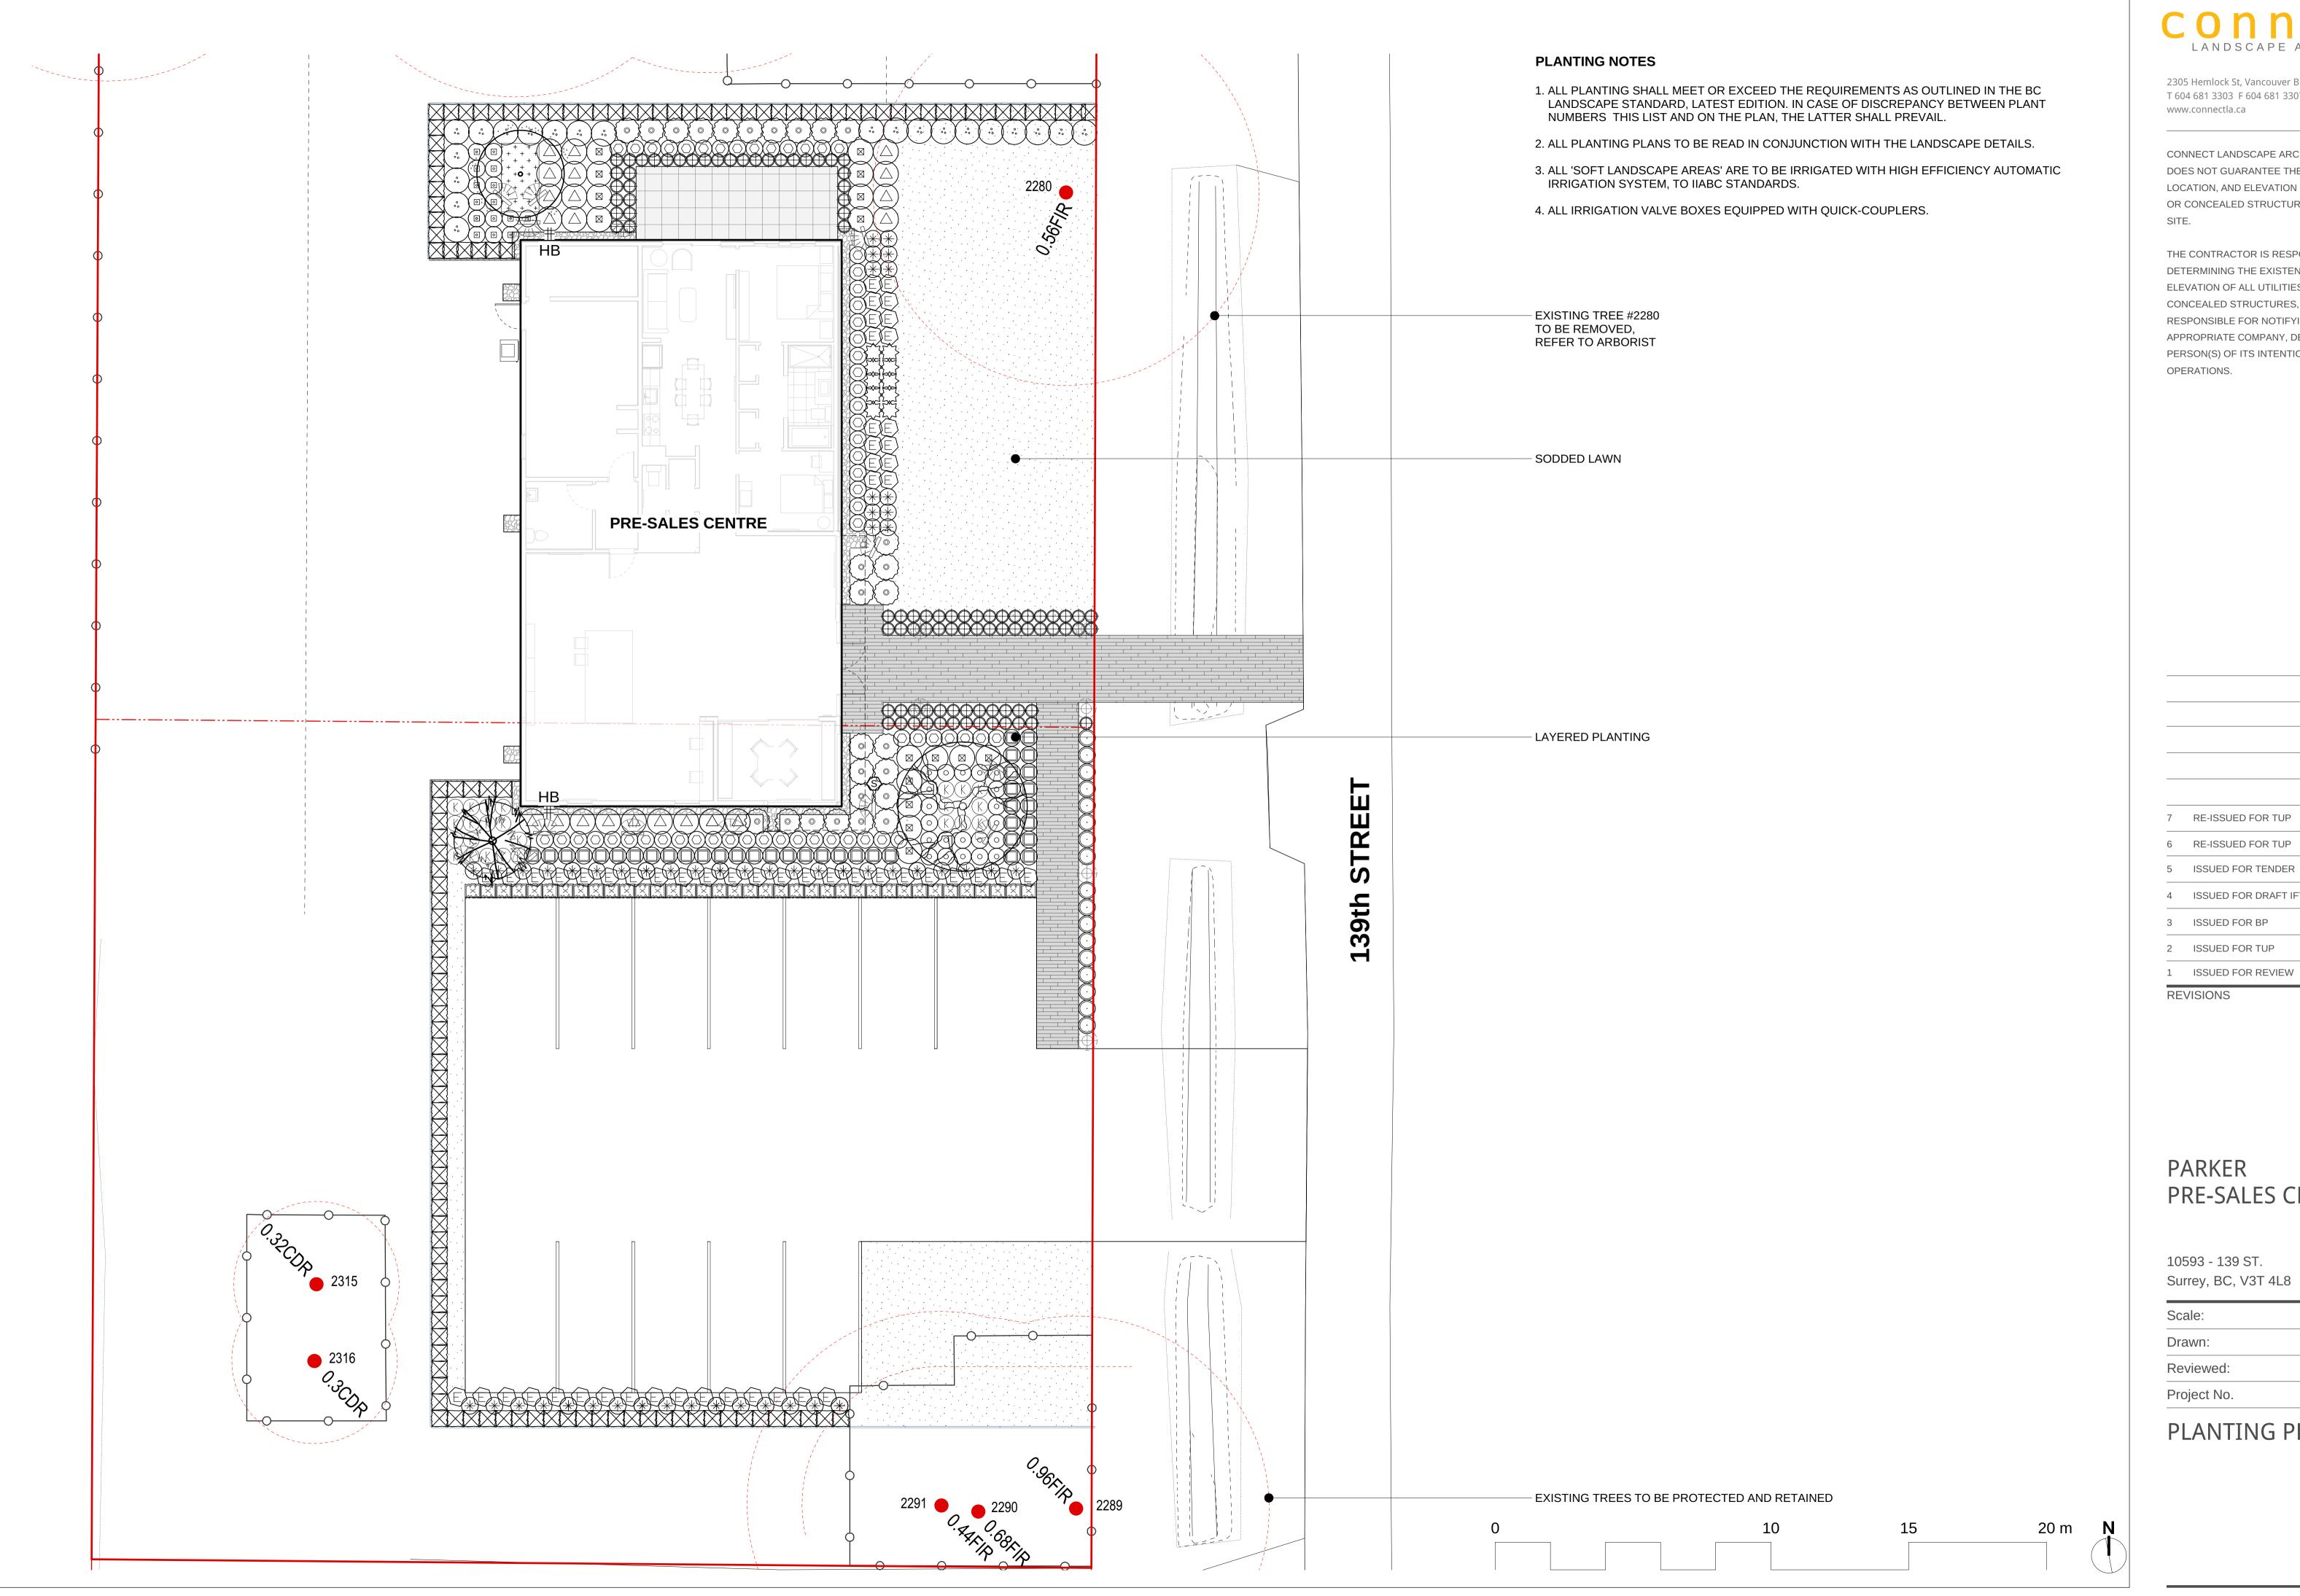
PARKER PRE-SALES CENTRE

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REVISIONS

Scale:	1:10)(
Drawn:	KV	W
Reviewed:	D:)S
Project No.	06-57	77
		_

PLANT LIST





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4	ISSUED FOR DRAFT IFT REVIEW	18-08-
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1	ISSUED FOR REVIEW	18-05-
REV	VISIONS	

18-09-14


18-08-31


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Scale:	1:100
Drawn:	KW
Reviewed:	DS
Project No.	06-577

PLANTING PLAN



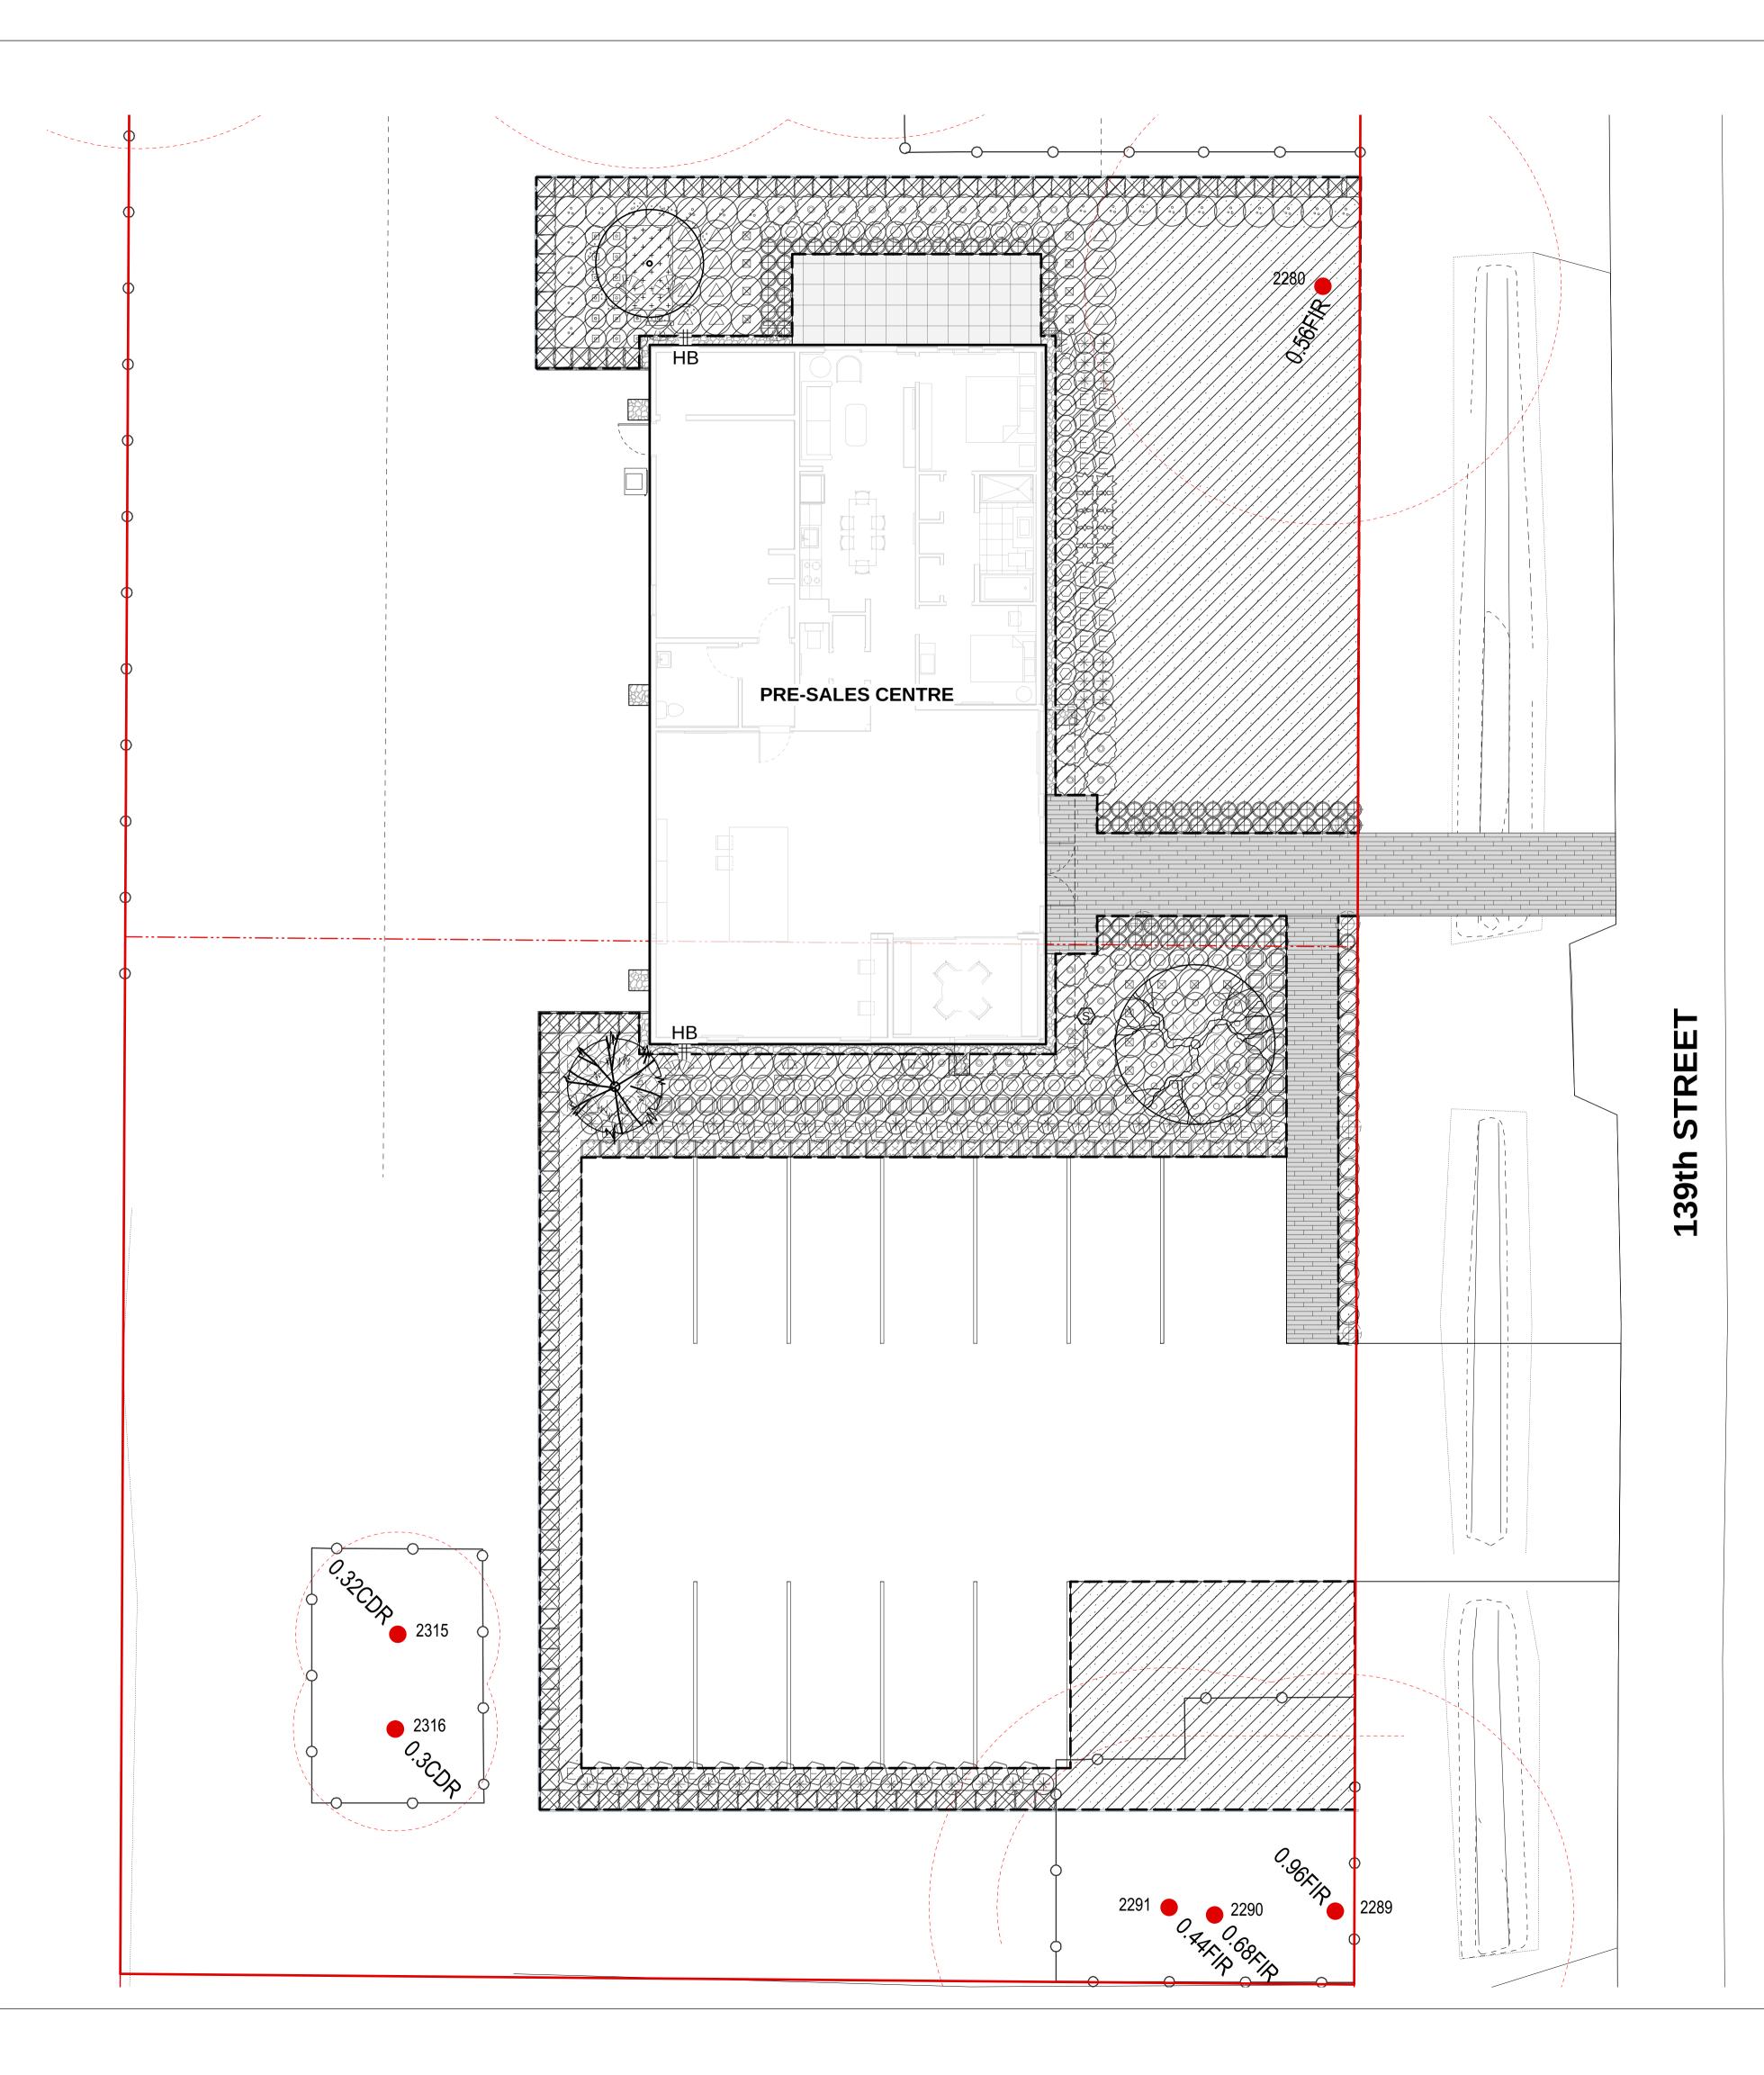

AREA TO BE IRRIGATED

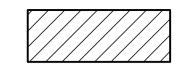DESIGN BUILD IRRIGATION NOTES:

- 1. LANDSCAPE CONTRACTOR TO PROVIDE COMPLETE DESIGN-BUILD SERVICES FOR ALL AUTOMATIC SITE IRRIGATION WORKS.
- 2. IRRIGATION CONTRACTOR PERFORMING THE WORK MUST HAVE MINIMUM (5) FIVE YEARS DOCUMENTED EXPERIENCE, AND A MEMBER IN GOOD STANDING OF THE IIABC (IRRIGATION INDUSTRY ASSOCIATION OF BC).
- 3. IRRIGATION TO CONFORM TO ALL LOCAL PLUMBING AND ELECTRICAL CODE REQUIREMENTS. CONTRACTOR IS RESPONSIBLE FOR COORDINATION WITH MECHANICAL AND ELECTRICAL CONSULTANTS AND TRADES.
- 4. IRRIGATION TO CONFORM TO ALL IIABC STANDARDS WITH THE FOLLOWING EXCEPTIONS: a. MATERIALS SECTION 8B: ALL PIPE TO BE MINIMUM CLASS 200 b. MATERIALS SECTION 5G: NO WIRE SMALLER THAN 14 GAUGE DIRECT BURIAL
- 5. COORDINATE WITH CIVIL CONTRACTOR TO PROVIDE PVC SLEEVING WHERE REQUIRED.
- 6. IRRIGATION STUB-OUTS AND HOSE BIBS PER MECHANICAL PLANS.
- 7. PROVIDE SHOP DRAWINGS FOR IRRIGATION LAYOUT TO CONSULTANT FOR REVIEW AND APPROVAL PRIOR TO FABRICATION AND INSTALLATION. INCLUDE SLEEVING, DRIP LINE, PIPE SIZE, VALVE BOXES, ETC., AND ALL IRRIGATION COMPONENT SPECIFICATIONS. VALVE BOXES TO BE LOCATED IN LOW-VISIBLE, PLANTED AREAS ONLY AND LOCATIONS TO BE APPROVED.
- 8. HIGH EFFICIENCY IRRIGATION TECHNOLOGY TO BE EMPLOYED INCLUDE, BUT ARE NOT LIMITED TO: CENTRAL SHUT-OFF VALVE, HIGH EFFICIENCY DRIP IRRIGARTION LINES
- 9. TEST SYSTEM PRIOR TO COMPLETION OF LANDSCAPE WORKS TO ENSURE NO LEAKAGE AND SPECIFIED PSI IS MET. PROVIDE WRITTEN NOTICE THAT PRESSURE TESTING HAS MET STANDARDS (LEAKS SHALL NOT BE REPAIRED BY PATCHING).
- 10. PROVIDE COVERAGE AND CONTROLLER TEST WHEN SYSTEM IS COMPLETE AND MAKE ADJUSTMENTS AS REQUIRED.
- 11. PROVIDE AS-BUILT RECORD DRAWINGS TO SCALE SHOWING LOCATIONS OF ALL CONCEALED COMPONENTS, PIPING SYSTEM AND CONDUIT.
- 12. MAINTAIN AND OPERATE IRRIGATION PER MANUFACTURER'S RECOMMENDATIONS THROUGHOUT WARRANTY PERIOD WINTERIZE AS REQUIRED.
- 13. PROVIDE (3) COPIES OF INSTRUCTIONS MANUALS FOR OPERATION AND MAINTENANCE OF SYSTEM AND CONTROLS, SEASONAL ACTIVITY AND SHUTDOWN AND MANUFACTURER'S PARTS CATALOGUE.
- 14. INSTRUCT OWNER'S PERSONNEL IN THE OPERATION AND MAINTENANCE OF SYSTEM, INCLUDING ADJUSTING OF SPRINKLER HEADS. USE OPERATION AND MAINTENANCE MATERIAL AS BASIS FOR DEMONSTRATION.
- 15. IRRIGATION PIPE SIZE TO BE 2" WITH 50 USGPM AND 55PSI.



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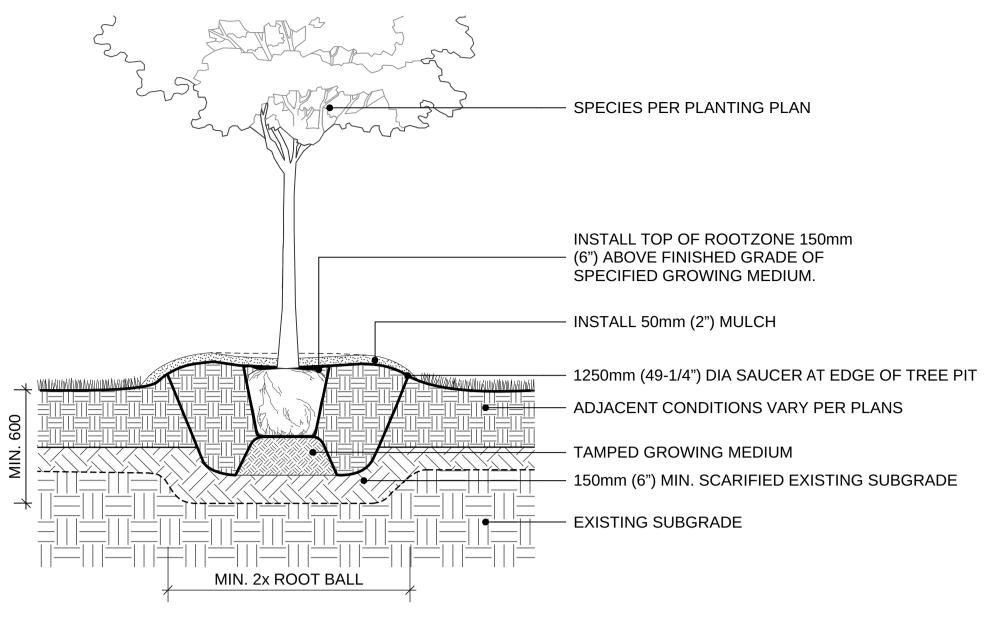
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IRRIGATION PLAN

0 10 15 20 m



SPECIES PER PLANTING PLAN

INSTALL 50mm (2") MULCH

1250mm (49-1/4") DIA SAUCER AT EDGE OF TREE PI'

ADJACENT CONDITIONS VARY PER PLANS

INSTALL TOP OF ROOTZONE 150mm (6")

ABOVE FINISHED GRADE OF SPECIFIED

GROWING MEDIUM.

TAMPED GROWING MEDIUM

150mm (6") MIN. SCARIFIED EXISTING SUBGRADE

EXISTING SUBGRADE

MIN. 2x ROOT BALL

CONIFEROUS TREE PLANTING ON GRADE (TYPICAL)

Scale: 1:20

MAX SLOPE

1 DECIDUOUS TREE PLANTING ON GRADE (TYPICAL)

- DISTANCE FROM EDGE IS HALF THE SPECIFIED O.C. SPACING ROW OPTIONAL: BULB PLANTING AT CENTRE OF PLANT "TRIANGLE" EQUIDISTANT FROM EACH PLANT O.C. PLANT CENTRE TRIANGULAR SPACING AT SPECIFIED - O.C. DISTANCE -SEE PLANT SCHEDULE - SPECIES PER PLANTING PLAN INSTALL MULCH TO 50mm (2") DEPTH INSTALL SPECIFIED GROWING MEDIUM - TO MINIMUM 450mm (18") DEPTH BULB PLANTING AT CENTRE OF PLANT "TRIANGLE" EQUIDISTANT FROM EACH PLANT O.C. - 150mm (6") MIN. SCARIFIED EXISTING SUBGRADE EXISTING SUBGRADE

SHRUB AND GROUNDCOVER PLANTING (TYPICAL)

(3) Scale: 1:25

T SCHEDULE

ER PLANTING PLAN

JLCH TO 50mm (2") DEPTH

PECIFIED GROWING MEDIUM
M 450mm (18") DEPTH

ITING AT CENTRE OF PLANT "TRIANGLE"
NT FROM EACH PLANT O.C.

MIN. SCARIFIED EXISTING SUBGRADE


SUBGRADE

SPECIES PER PLANTING PLAN.
ENSURE POSITIVE DRAINAGE THROUGHOUT PLANTING BED.

INSTALL MULCH AS SPECIFIED

INSTALL SPECIFIED GROWING MEDIUM TO MINIMUM 450mm (18") DEPTH

150mm (6") MIN. SCARIFIED EXISTING SUBGRADE
EXISTING SUBGRADE

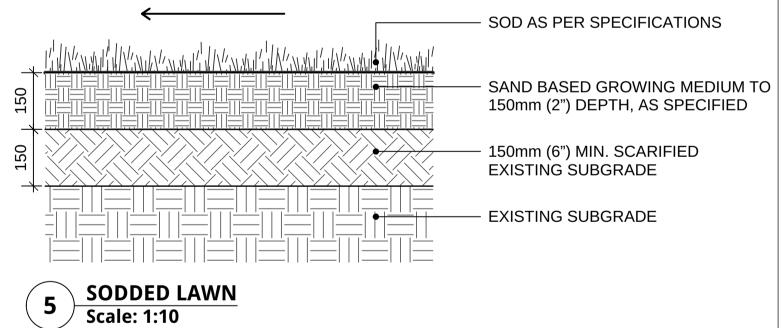

POSITIVE DRAINAGE

PLANTING ON SLOPE (TYPICAL)
Scale: 1:25

Connect LANDSCAPE ARCHITECTURE

2305 Hemlock St, Vancouver BC, V6H 2V1 T 604 681 3303 F 604 681 3307 www.connectla.ca

CONNECT LANDSCAPE ARCHITECTURE INC.

DOES NOT GUARANTEE THE EXISTENCE,

LOCATION, AND ELEVATION OF UTILITIES AND /

OR CONCEALED STRUCTURES AT THE PROJECT

SITE.

THE CONTRACTOR IS RESPONSIBLE FOR

DETERMINING THE EXISTENCE, LOCATION, AND

ELEVATION OF ALL UTILITIES AND / OR

CONCEALED STRUCTURES, AND IS

RESPONSIBLE FOR NOTIFYING THE

APPROPRIATE COMPANY, DEPARTMENT OR

PERSON(S) OF ITS INTENTION TO CARRY OUT ITS

OPERATIONS.

,	RE-ISSUED FOR TUP	18-11-23
	RE-ISSUED FOR TUP	18-09-17
	ISSUED FOR TENDER	18-08-31
	ISSUED FOR DRAFT IFT REVIEW	18-08-03
	ISSUED FOR BP	18-06-26
	ISSUED FOR TUP	18-06-11
	ISSUED FOR REVIEW	18-05-11
RΕ'	VISIONS	

PARKER PRESENTATION CENTRE


10593 - 139 ST. Surrey, British Columbia


Scale:	AS SHOWN
Drawn:	KW
Reviewed:	DS
Project No.	06-577

SOFTSCAPE DETAILS


UNIT PAVING CLASSIC STANDARD SERIES
SIZE: 3:1 225mm x 75mm x 60mm (8-7/8" X 3" X 2-3/8")
BY: ABBOTSFORD CONCRETE PRODUCTS
(1.800.663.4091)



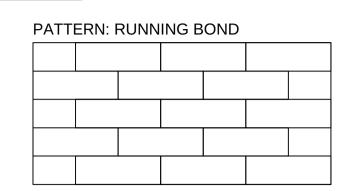

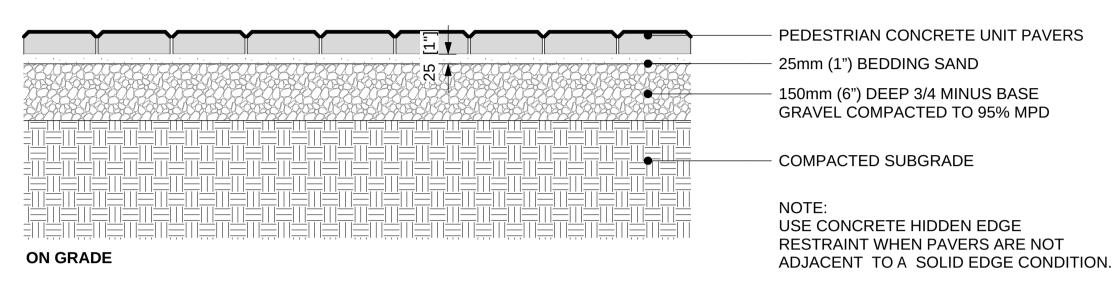



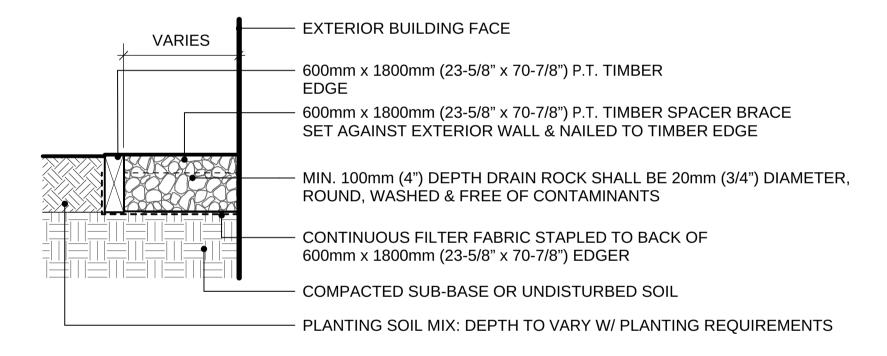

NOTE: ALL LUMBER SIZES ARE SHOWN AS NOMINAL





TEXADA HYDRAPRESSED SLABS
SIZE: STANDARD SIZE 24"X24" (610MM X 610MM X 50MM)
COLOUR: NATURAL
PATTERN: GRID
SUPPLIED BY ABBOTSFORD CONCRETE PRODUCTS

COLOR: NATURAL

1.800.663.4091



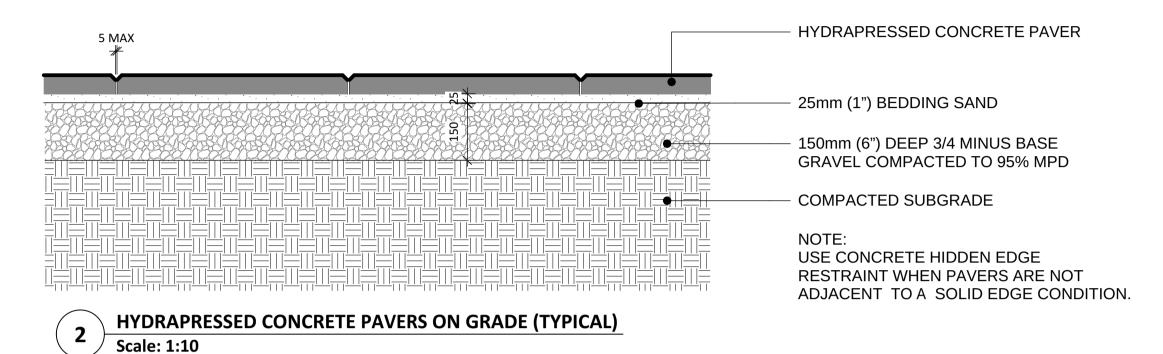

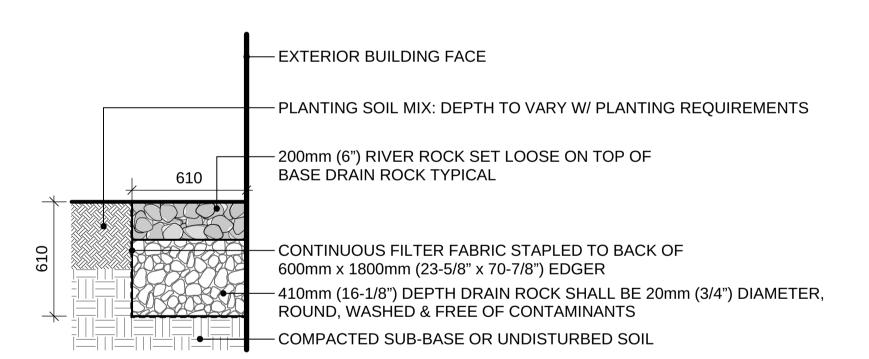





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ELEVATION OF ALL UTILITIES AND / OR

CONCEALED STRUCTURES, AND IS

RESPONSIBLE FOR NOTIFYING THE

APPROPRIATE COMPANY, DEPARTMENT OR

PERSON(S) OF ITS INTENTION TO CARRY OUT ITS

OPERATIONS.

7	RE-ISSUED FOR TUP	18-11-23
6	RE-ISSUED FOR TUP	18-09-17
5	ISSUED FOR TENDER	18-08-31
4	ISSUED FOR DRAFT IFT REVIEW	18-08-03
3	ISSUED FOR BP	18-06-26
2	ISSUED FOR TUP	18-06-11
1	ISSUED FOR REVIEW	18-05-11

PARKER PRESENTATION CENTRE

10593 - 139 ST. Surrey, British Columbia

Scale:	AS SHOWN
Drawn:	KW
Reviewed:	DS
Project No.	06-577

HARDSCAPE DETAILS



INTER-OFFICE MEMO

TO: Manager, Area Planning & Development

- North Surrey Division

Planning and Development Department

FROM: Development Services Manager, Engineering Department

DATE: Aug 3, 2018 PROJECT FILE: 7818-0159-00

Engineering Requirements (Temporary Use Permit) Location: 10575/93 – 139 Street & 10605 139 Street

TEMPORARY USE PERMIT

The following are to be addressed as a condition of the issuance of this Temporary Use Permit for a temporary sales centre to market the apartment units proposed under project 7917-0599-00.

- Construct a 7.3m wide driveway letdown. Locate driveway outside of Tree Protection Zone.
- Construct on-site water quality treatment features for surface runoff from on-site parking and drive aisle areas, as determined through review of key plan. Register restrictive covenant for water quality/sediment control, if applicable.
- Provide metered water, storm and sanitary service connections to the lot.
- Provide temporary Hydro servicing strategy.
- Submit an updated key plan and storm water control plan. The storm water control plan and key plan will be reviewed through the building permit review process.

A Servicing Agreement is not required for this proposed Temporary Use Permit. The above noted works can be constructed subject to issuance of a City Road and Right-of-Way Permit obtainable at the Engineering front counter upon payment of securities and permit fees.

Tommy Buchmann, P.Eng.

Acting Development Services Manager

HB₄

RF.

4.0 Tree Preservation Summary

Table 3: City of Surrey tree preservation summary table for on-site and off-site trees, including the number of replacement trees proposed.

Surrey Project Number Unknown

Site Address 10605, 10596, 10575 139th Street Surrey BC

Registered Arborist Conor Corbett (PN-8429A)

On-Site Trees	Number of Trees
Protected Trees Identified	46
(On-site and shared trees, including trees within boulevards and proposed streets and lanes, but excluding trees in proposed open space or riparian areas)	
Protected Trees to be Removed	5
Protected Trees to be Retained	41
(excluding trees within proposed open space or riparian areas)	
Total Replacement Trees Required:	
- Alder & Cottonwood Trees Requiring 1 to 1 Replacement Ratio	
1 X one (1) = 1	9
- All other Trees Requiring 2 to 1 Replacement Ratio	
4 X two (2) = 8	
Replacement Trees Proposed	3
Replacement Trees in Deficit	6
Protected Trees to be Retained in Proposed Open Space / Riparian Areas	0

Off-Site Trees	Number of Trees
Protected Off-Site Trees to be Removed	0
Total Replacement Trees Required:	
- Alder & Cottonwood Trees Requiring 1 to 1 Replacement Ratio	
X one (1) = 0	0
- All other Trees Requiring 2 to 1 Replacement Ratio	
X two (2) = 0	
Replacement Trees Proposed	0
Replacement Trees in Deficit	0

Summary, report and plan prepared and submitted by

December 13, 2018

Signature of Arborist

Date

CITY OF SURREY

(the "City")

TEMPORARY USE PERMIT

NO.:	7918-0159-00

Issued To:

(the "Owner")

Address of Owner:

- 1. This temporary use permit is issued subject to compliance by the Owner with all statutes, by-laws, orders, regulations or agreements, except as specifically varied by this temporary use permit.
- 2. This temporary use permit applies to that real property including land with or without improvements located within the City of Surrey, with the legal description and civic address as follows:

Parcel Identifier: 006-286-216 Lot 58 Section 23 Block 5 North Range 2 West New Westminster District Plan 27955

10605 - 139 Street

Parcel Identifier: 008-120-358 Lot 44 Section 23 Block 5 North Range 2 West New Westminster District Plan 17345

10575 - 139 Street

Parcel Identifier: 000-658-758 Lot 45 Section 23 Block 5 North Range 2 West New Westminster District Plan 20317

10593 - 139 Street

(the "Land")

- 3. The authority to issue Temporary Use Permits is granted to municipalities under Sections 492 and 493 of the *Local Government Act* R.S.B.C. 2015, c.1. Pursuant to Implementation, II(c) Implementation Instruments, Temporary Use Permits of Surrey Official Community Plan, 2013, No. 18020, as amended, the entire City of Surrey is designated a Temporary Use Permit area.
- 4. The temporary use permitted on the Land shall be for a real estate sales centre and associated surface parking lot.

- 5. The temporary use permitted on the Land shall be in accordance with:
 - (a) The appearance and location of the buildings, access and parking as shown on Schedule A and numbered 7918-0159-00(A) through to and including 7918-0159-00 (K) (the "Drawings") which is attached hereto and forms part of this permit;
 - (b) Parking is restricted to vehicles less than 5,000 kilograms (11,023 lbs.) G.V.W.; and
 - (c) Upon termination of this Temporary Use Permit, the real estate sales centre shall be removed.
- 6. As a condition of the issuance of this temporary use permit, Council is holding security set out below (the "Security") to ensure that the temporary use is carried out in accordance with the terms and conditions of this temporary use permit. Should the Owner fail to comply with the terms and conditions of this temporary use permit within the time provided, the amount of the Security shall be forfeited to the City. The City has the option of using the Security to enter upon the Land and perform such works as is necessary to eliminate the temporary use and bring the use and occupancy of the Land into compliance with Surrey Zoning By-law, 1993, No. 12000, as amended (the "Works"). The Owner hereby authorizes the City or its agents to enter upon the Land to complete the Works. There is submitted accordingly:

Cash or Irrevocable Letter of Credit, in a form acceptable to the City, in the amount of \$5,000.

- 7. The Land shall be developed strictly in accordance with the terms and conditions and provisions of this temporary use permit. This temporary use permit is not a building permit.
- 8. An undertaking submitted by the Owner is attached hereto as Appendix I and forms part of this temporary use permit.
- 9. This temporary use permit is not transferable.

10.	This tem	porary use peri	nit shall laps	se on or before three yea	rs from date o	of issuance.
AUTH	IORIZING	RESOLUTION	I PASSED BY	THE COUNCIL, THE	DAY OF	, 20 .
ISSUE	D THIS	DAY OF	, 20 .			
				Mayor – Douş	g McCallum	
				City Clerk		
IN CONSIDERATION OF COUNCIL'S APPROVAL OF THIS TEMPORARY USE PERMIT AND OTHER GOOD AND VALUABLE CONSIDERATION, I/WE THE UNDERSIGNED AGREED TO THE TERMS AND CONDITIONS OF THIS TEMPORARY USE PERMIT AND ACKNOWLEDGE THAT WE HAVE READ AND UNDERSTOOD IT.						
				Authorized A	gent: Signatu	ıre
OR				Name (Please	Print)	
				Owner: Signa	ture	

TO THE CITY OF SURREY:

I,	(Name of Owner)
being the	owner of
	(Legal Description)
known as	(Civic Address)
hereby un	dertake as a condition of issuance of my temporary use permit to:
(a)	demolish or remove all buildings and/or structures that are permitted to be constructed pursuant to the temporary use permit issued to me; and
(b)	restore the land described on the temporary use permit to a condition specified in that permit;
all of whice permit.	th shall be done not later than the termination date set out on the temporary use
agents ma is necessa compliand submitted	understand that should I not fulfill the undertaking described herein, the City or its sy enter upon the land described on the temporary use permit and perform such work as ry to eliminate the temporary use and bring the use and occupancy of the land in see with Surrey Zoning By-law, 1993, No. 12000, as amended, and that any securities by me to the City pursuant to the temporary use permit shall be forfeited and applied to frestoration of my land as herein set out.
This unde	rtaking is attached hereto and forms part of the temporary use permit.
	(Owner)
	(Witness)

ABBREVIATIONS ABOVE AFF ALUM ANN ARCH

CLG

CLR

CW

DIM

DCW

DHW

AIR BARRIER EXHAUST AIR ALBERTA BUILDING CODE **EXHAUST FAN EXPANSION JOINT** AREA DRAIN ELEC ELECTRICAL ABOVE FINISHED FLOOR ELEV ELEVATION AIR HANDLING UNIT ALUMINUM ANNUNCIATOR EXT EXTERIOR ARCHITECTURAL ARCHITECTURAL WOOD WORK FIBER CEMENT PANEL ACOUSTIC WALL PANEL FIRE EXTINGUISHER FINISH FLOOR ELEVATION

BULLETIN BOARD BASEBOARD HEATER BCBC BRITISH COLUMBIA BUILDING CODE BLDG BUILDING BLW BELOW BOC BOTTOM OF CURB BOTTOM OF STEE BOW BOTTOM OF WALL

BSMT BASEMENT BTWN BETWEEN CORNER GUARD CAST-IN-PLACE CONTROL JOINT CENTERLINE CEILING CLEAR CONSTRUCTION MANAGER CLEANOUT

CONC CONCRETE CONT CONTINUOUS CARPET CERAMIC TILE CUST CUSTODIAL COLD WATER COMPLETE WITH DECIBEL DIAMETER

DIMENSION(S) DOMESTIC COLD WATER DOMESTIC HOT WATER DHWT DOMESTIC HOT WATER TANK DOWN DOWNSPOUT DW DISHWASHER DWG DRAWING

EXPANDED POLYSTYRENE ENERGY RECOVERY VENTILATOR

FNDN FOUNDATION

FTG FOOTING

HORIZ

HRV

HWR

FURN FURNITURE

GALV GALVANIZED

GROUND

GWB GYPSUM (WALL) BOARD

HOLLOW METAL

HORIZONTAL

HOT WATER

FOOT / FEET

GENERAL CONTRACTOR

GLASS / GLAZING / GLAZED

HOSE BIB (WALL HYDRANT)

HEAT RECOVERY VENTILATOR

HOLLOW STEEL SECTION

HOT WATER HEATER

HOT WATER RETURN

HOT WATER SUPPLY

HOT WATER TANK

INSIDER DIAMETER

INCHES

INVERT

INFORMATION

INSUL INSULATE / INSULATED

JAN JANITOR / JANITORIAL

"L" ANGLE

LAV LAVATORY

LAMINATED

GROUND FAULT INTERRUPTER

LEFT HAND LEFT HAND REVERSE LAMINATED VENEER LUMBER METERS MAXIMUM MECH MECHANICAL MEZZANINE MEDIUM DENSITY FIBERBOARD THOUSANDTH OF AN INCH (0.001") MIN MINIMIM FACE OF CONCRETE MIRROR FACE OF FINISH MILLIMETERS FRIDGE / REFRIGERATOR METAL MTL FIRE RESISTANCE RATING MICROWAVE

MWP METAL WALL PANEL NA / N/A NOT APPLICABLE NIC NOT IN CONTRACT NTS NOT TO SCALE OUTDOOR AIR OC / O.C. ON CENTER OD OUTSIDE DIAMETER

RISER

RCP

REV

RETURN AIR

RUBBER BASE

ROLLER BLIND

REFER TO

REVISION

ROOM

ROW RIGHT OF WAY

ROOF DRAIN

ROUGH OPENING

RAINWATER LEADER

REOD REOUIRED

POUND

LINEAR FOOT

TPD TYP UNO UR UTIL UTILITY OPNG OPENING OSB ORIENTED STRAND BOARD PROPERTY LINE VCT PLATE (STEEL) PLAM PLASTIC LAMINATE PAINT PREFAB PREFABRICATED PTD PAPER TOWEL DISPENSER

VERT VERTICAL W/O REFLECTED CEILING PLAN XPS

SUPPLY AIR S/A SELF-ADHERED MEMBRANE SANITARY SOAP DISPENSER SOUARE FOOT SANITARY NAPKIN DISPENSER SANITARY NAPKIN WASTE (BIN) SPRAY-APPLIED POLYURETHANE FOAM SST STAINLESS STEEL SOUND TRANSMISSION CLASS STRC STRUCTURAL

TOP OF CONCRETE / TOP OF CURB

TONGUE & GROOVE

TO BE CONFIRMED

TO BE DETERMINED

TOILET PAPER DISPENSER

UNLESS NOTED OTHERWISE

VINYL COMPOSITION TILE

TRIM TYPE NUMBER #

VAPOUR BARRIER

VAPOUR RETARDER

VERIFY IN FIELD

WHITEBOARD

WATERCLOSE1

WIDE FLANGE

WORK POINT

PLUS/MINUS

EXTRUDED POLYSTYRENE

TELEPHONE

TOP OF STEEL

TOP OF WALL

TREAD

TYPICAL

URINAL

WITH

WITHOUT

WOOD

TOW


DRAWING NUMBER DRAWING SCALE

GRAPHIC SYMBOL LEGEND

22 DRAWING NAME
1:2000 VIEW TO


ARCHITECTURAL




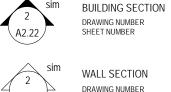



WALL SECTION DRAWING NUMBER DETAIL REFERENCE

VIEW TITLE

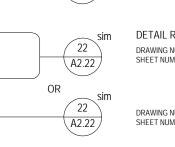

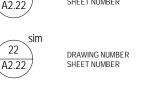

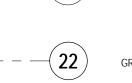

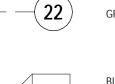


COATS, TAPE AND SPACKLE, VENEER PLASTERS, **BUILDING ELEVATION** DRAWING NUMBER



A2.22

MATCH LINE ADJACENT SHEET NUMBER

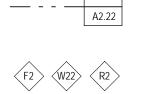


ASSEMBLY TAG D222b DOOR TAG




GLAZING OPENING WINDOW NUMBER CASEWORK/MILLWORK TAG




SIGNAGE INDICATOR

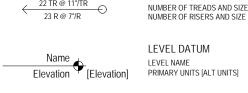

ROOM NAME ROOM TAG ROOM NUMBER

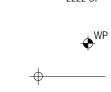

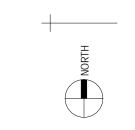

NORTH ARROW REVISION INDICATOR

> CLOUD AROUND REVISION REVISION NUMBER

WORK POINT

SPOT ELEVATION

SPOT ELEVATION

(EXISTING)

(PROPOSED)



CENTER LINE PROPERTY LINE FIRE-RATED PARTITION



TYPICAL DEVICE MOUNTING **ELEVATIONS (UNO)**

THERMOSTAT, HVAC SENSOR/ 🖫 🎱 — 60-64" CONTROL, SECURITY KEYPAD FIRE ALARM PULL STATION SWITCH, A/V CONTROL SECURITY CARD READER

ELECTRICAL RECEPTACLE,

CABLE (CATV), TELEPHONE

INSTALL 8" FROM ADJACENT WALL/DOORWAY / TYP DEVICE MOUNTING NOTES

- , — — — FINISHED FLOOR LEVEL

₿ — 8"

LIGHTING, AND SECURITY DEVICES WITH ARCHITECT PRIOR TO INSTALLATION. 2. WHERE MULTIPLE ADJACENT DEVICES ARE INSTALLED AT A COMMON ELEVATION, GANG TOGETHER UNDER A SINGLE COVERPLATE

3. CENTER MULTIPLE DEVICES IN A VERTICALLY

1. CONFIRM LOCATIONS OF ALL EXPOSED TO VIEW MECHANICAL, FIRE PROTECTION, ELECTRICAL,

ALIGNED MANNER WHEREVER POSSIBLE 4. UNLESS NOTED OTHERWISE, PROVIDE LEVITON "DECORA PLUS" SERIES SCREWLESS COVERPLATES. COLOUR: WHITE DEVICES + WHITE COVERPLATES IN WHITE WALLS; BLACK DEVICES + BLACK COVERPLATES IN BLACK/GREY WALLS.

GENERAL NOTES

1. ALL WORK TO COMPLY WITH BRITISH COLUMBIA BUILDING CODE 2012 VOLUME 1 AND VOLUME 2, AND OTHER APPLICABLE CODES AND

ORDINANCES. 2. VERIFY AND COORDINATE SITE CONDITIONS AND DIMENSIONS. BRING INCONSISTENCIES TO ATTENTION OF ARCHITECT BEFORE PROCEEDING WITH WORK. 3. PERFORM EXCAVATION AND FOUNDATION WORK IN CONFORMANCE WITH THE REQUIREMENTS OF

THE GEOTECHNICAL ASSESSMENT AND

MEASUREMENTS. NOTIFY ARCHITECT OF

7. ALL DIMENSIONS ARE TO FINISH FACE OF

MASONRY, AND CENTERLINE OF COLUMNS.

BOARD ASSEMBLY TYPES TO ALLOW FOR

UNLESS NOTED OTHERWISE. DIMENSIONS IN

PARTITION OR CEILING, FACE OF CONCRETE OR

ALTERNATE UNITS (E.G. METRIC VS IMPERIAL) ARE

SCHEDULED APPLICATION OF SKIM AND FEATHER

IN [BRACKETS], ADJUST LOCATION OF GYPSUM

CONSTRUCTION DOCUMENTS. 4. PROVIDE BUILDING SUBSURFACE DRAINAGE SYSTEM IN ACCORDANCE WITH THE GEOTECHNICAL ASSESSMENT. 5. IMMEDIATELY BRING ERRORS AND OMISSIONS FOUND IN THESE DRAWINGS TO ATTENTION OF ARCHITECT 6. DO NOT SCALE DRAWINGS. FOLLOW DIMENSIONS SHOWN ON DRAWINGS AND ACTUAL FIELD

DISCREPANCIES.

SHEET NUMBER

SHEET NUMBER

AND TRIM SHAPES AS REQUIRED IN ORDER TO MAINTAIN DIMENSIONS AND CRITICAL ALIGNMENTS INDICATED AT DRAWINGS. 8. DRAWINGS AND SPECIFICATIONS: EXAMINE AND BRING ANY DISCREPANCIES BETWEEN ARCHITECT AND CONSULTANT WORK TO THE ATTENTION OF THE ARCHITECT BY WRITTEN NOTICE FOR

CLARIFICATION. WORK INSTALLED IN CONFLICT WITH CONSTRUCTION DOCUMENTS WILL BE CONSIDERED IN NON-CONFORMANCE AND CORRECTED AT NO EXPENSE TO OWNER. 9. COORDINATION: COORDINATE WORK TO COMPLY WITH DRAWINGS AND SPECIFICATIONS AND TO ACCURATELY LOCATE OPENINGS FOR MECHANICAL, ELECTRICAL AND OTHER EQUIPMENT SO AS TO NOT INTERFERE WITH

STRUCTURAL FRAMING 10. FOLLOW MANUFACTURER'S INSTRUCTIONS. EXCEPT WHERE MORE STRINGENT REQUIREMENTS ARE INDICATED OR REQUIRED BY 11 PROVIDE AND INSTALL SOLID BLOCKING AND

BACKING FOR WALL- AND CEILING-MOUNTED 12. INSTALL GYPSUM BOARD ON BOTH SIDES OF WALL FRAMING, UNINTERRUPTED FROM FLOOR TO UNDERSIDE OF ROOF DECK, UNLESS NOTED

13. ATTACH PIPING IN ACOUSTICALLY SEPARATED WALLS WITH VIBRATION ISOLATORS, ISOLATE PIPING IN CONTACT WITH CONSTRUCTION. 14. MOUNT SWITCHES 42" [1100] ABOVE FINISHED FLOOR UNLESS NOTED OTHERWISE. VERIFY SWITCH AND OUTLET HEIGHTS ABOVE CASEWORK

TO CLEAR BACKSPLASH. 15. ISOLATE AND OFFSET OUTLETS ONE STUD SPACE MINIMUM AT SOUND WALLS TO PREVENT SOUND TRANSMISSION. 16. COORDINATE SIZES AND LOCATIONS OF OPENINGS AND ROUGH-INS FOR MECHANICAL EQUIPMENT WITH MECHANICAL CONTRACTOR, AND SHOP DRAWINGS REVIEWED BY ARCHITECT BEFORE PROCEEDING WITH THE WORK.

EQUIPMENT PADS, BASES, POWER, WATER AND DRAIN INSTALLATION WITH EQUIPMENT MANUFACTURERS BEFORE PROCEEDING WITH THE WORK. PROVIDE AND INSTALL SEISMIC BRACING AND FASTENING IN ACCORDANCE WITH CODE REQUIREMENTS. 18. COORDINATE EXACT LOCATION OF PLUMBING AND

17. VERIFY SIZES AND LOCATIONS OF MECHANICAL

PIPING WORK INTERFACING OTHER BUILDING SYSTEMS AND ASSEMBLIES WITH PLUMBING SUBCONTRACTOR. 0 FINISHES: IN FINISHE EXPOSED PIPE, CONDUITS, DUCTS, ETC. CONCEAL UTILITY LINES BEHIND FINISHED CONSTRUCTION UNLESS NOTED AS EXPOSED TO VIEW CONSTRUCTION ON DRAWINGS OR APPROVED BY

ARCHITECT. IF WORK CANNOT BE CONCEALED WITHIN FINISHED CONSTRUCTION OF THE CONTRACT DOCUMENTS, THE CONTRACTOR SHALL PROVIDE & INSTALL FURRED & FINISHEI HORIZONTAL & VERTICAL CHASES TO MATCH ADJACENT FINISH TO CONCEAL WORK. COORDINATE WITH ARCHITECT. 20. OFFSET AND ADJUST FRAMING TO MAKE FINISHED SURFACES FLUSH AND TRUE TO LINE.

21. PROVIDE GALVANIC ISOLATION BETWEEN DISSIMILAR METALS. 22. LOCATE FIRE EXTINGUISHER CABINETS AS SHOWN ON PLANS. PROVIDE EXTINGUISHER TYPE AND ADDITIONAL FIRE EXTINGUISHERS AS REQUIRED BY BUILDING CODE AND NEPA 10: STANDARD FOR PORTABLE FIRE EXTINGUISHERS. COORDINATE EXACT LOCATION OF SUPPLEMENTAL FIRE

EXTINGUISHERS AND FIRE EXTINGUISHER CABINETS WITH ARCHITECT. 23. COORDINATE INSTALLATION OF FIRE PROTECTION SYSTEM WITH STRUCTURAL, MECHANICAL, PLUMBING, AND ELECTRICAL WORK TO ENSURE NO CONFLICT AS A RESULT OF FIRE PROTECTION SYSTEM INSTALLATION 24. REFER TO FINISH SYMBOLS LEGEND WHERE

APPLICABLE FOR ADDITIONAL ABBREVIATIONS AND FINISH MATERIAL ACRONYMS INDICATED AT DRAWINGS AND SPECIFICATIONS. EXISTING CONSTRUCTION 25. REFER TO ENLARGED TOILET ROOM PLANS AND **ELEVATIONS FOR TOILET ROOM ACCESSORIES** ABBREVIATIONS AND ACRONYMS. 26. PROMPTLY BRING CONFLICTS AND OMISSIONS IN

FINISH MATERIALS LIST AND OTHER GRAPHIC

INDICATORS TO ARCHITECT'S ATTENTION FOR INTERPRETATION AND DIRECTION. 27. REFER TO ARCHITECTURAL DRAWINGS FOR EXACT LOCATIONS OF ALL EXPOSED TO VIEW DEVICES AND EQUIPMENT PROVIDED UNDER WORK OF OTHER DISCIPLINES INCLUDING BUT NOT LIMITED TO MECHANICAL, ELECTRICAL, SECURITY AND AUDIO VISUAL 28. ALL EXISTING AND NEW SERVICE PENETRATIONS THROUGH FIRE-RATED ASSEMBLIES TO BE FIRESTOPPED, INCLUDING BUT NOT LIMITED TO

CUSTODIAL ROOMS, MECHANICAL ROOMS, AND

FIRE-RATED FLOOR ASSEMBLIES.

BUILDING CODE SUMMARY

BUILDING CODE BC BUILDING CODE 2012 DOORS, INC. EXIT DOORS [9.9.6.2, 9.9.6.3] MIN HEIGHT 2030mm [80", 6'-8"] MIN WIDTH 800mm [31.5"] CLEAR WIDTH

BUILDING AREA 238.8m² [2571 SF] **BUILDING HEIGHT** 1 STOREY CODE APPLICATION PART 9

OCCUPANT LOAD [9.9.1.3.] REAL ESTATE PRE-SALES CENTRE (MERCANTILE) • 186.5 M² @ 3.70 M²/PERSON = 51 PERSONS OFFICE

 42.1 M² @ 9.30 M²/PERSON = 5 PERSONS TOTAL: 56 PERSONS

DIMENSIONS OF MEANS OF EGRESS [9.9.3] MIN 1100 FOR PUBLIC CORRIDORS (SERVING MORE) THAN 1 SUITE); 900 OTHERWISE - MIN CLEAR HEIGHT: 2100 TYP OCCUPANCY CLASSIFICATION [9.10.2.]

MAJOR OCCUPANCY GROUP E: MERCANTILE (GROUND FLOOR) SECONDARY OCCUPANCY GROUP D: OFFICE (GROUND FLOOR) PERMITTED OPENINGS IN WALL AND CEILING

OR APPENDIX D, OPENINGS TO DUCTS W/IN CEILING

SPACE PERMITTED PER APPENDIX D

[3.2.2.60.] GROUP D UP TO 2 STOREYS

[3.2.2.66.] GROUP E UP TO 2 STOREYS

FLOORS: 45 MIN (N/A IN PROJECT)

EXTERIOR WALLS: 1 HOUR [9.10.14.5.A]

NOTE: LOADBEARING WALLS/COLUMNS IN STOREY

ASSEMBLY SHALL HAVE FRR NOT LESS THAN THE

IMMEDIATELY BELOW A RATED FLOOR/ROOF

SEPARATION OF OCCUPANCIES [9.10.9.11]

CLOSURES IN FIRE SEPARATIONS [9.10.13.1]

NOTE: NO FIRE SEPARATIONS IN PROJECT

2 EXITS REQUIRED FROM FLOOR AREA, SPACED SO

TRAVEL DISTANCE TO NEAREST EXIST IS NOT MORE

NUMBER OF REQUIRED EXITS [9.9.8.2]

THAN 30M [9.9.8.2.(1)(c)

FRR OF FIRE SEPARATION MIN FRR OF CLOSURE

45 MIN

45 MIN

1 HR

1.5 HR

COMBUSTIBLE AND/OR NONCOMBUSTIBLE

REQUIRED ASSEMBLY RATINGS [9.10.8.]

CONSTRUCTION PERMITTED

ROOFS: NOT RATED

SUPPORTED ASSEMBLY

NONE IN PROJECT

NONE IN PROJECT

FIRE ALARM SYSTEM

1 HR

1.5 HR

FIRE SEPARATIONS [9.10.9]

FIRE SUPPRESSION SYSTEM

NOT REQUIRED [9.10.18.2.(2)]

NOT REQUIRED [3.2.2.60., 3.2.2.66.]

ASSEMBLY)

SMOKE ALARMS [9.10.19.] MEMBRANES [9.10.5.] MEMBRANES FOR ASSEMBLIES W/ FIRE RESISTANCE TO BE INSTALLED AT OR NEAR THE CEILING. RATINGS SHALL NOT BE PIERCED BY OPENINGS, REQUIRED LOCATIONS: - MIN 1 ON EACH STOREY [9.10.19.3.1.(a)] — ELECTRICAL OUTLET BOXES (OR SIMILAR) - IN EACH DWELLING UNIT AND IN EACH PROVIDED THEY ARE TIGHTLY FITTED (OFFSET BY SLEEPING ROOM [9.10.19.3.1.(b)] MIN. ONE STUD CAVITY AND BLOCK ABOVE/BELOW SMOKE ALARMS WITHIN DWELLING UNITS TO BE WHERE 2 DEVICES ARE ON OPPOSITE SIDES OF THE INTERCONNECTED [9.10.19.5] — WHERE FRR IS ASSIGNED PER TABLE A-9.10.3.1.B

LIGHTING & EMERGENCY POWER — PROVIDE EMEGENCY LIGHTING IN EXIT CORRIDORS AT AN AVERAGE OF 10 LX AT FLOOR AND/OR TREAD LEVEL. [9.9.12.3.(4)] — ALL EMERGENCY LIGHTING TO BE POWERED BY A SUPPLY SEPARATE FROM THE BUILDING POWER — AUTOMATICALLY ACTUATED BACKUP BATTERY POWER TO BE PROVIDED TO EMERGENCY

PRIVATE: MIN (mm) MAX (mm)

PUBLIC: MIN (mm) MAX (mm)

TREAD 280 NO LIMIT

MINIMUM STAIR WIDTH = 860mm

MINIMUM EXIT STAIR WIDTH = 900mm

AND SURFACE BEHIND [9.8.7.5.(1)]

TREAD 235 355

125 200

210 355

125 180

280 NO LIMIT

50MM CLEARANCE BETWEEN GRASPABLE RAIL

SOUND TRANSMISSION CLASS (STC) RATINGS

AND ALL OTHER SPACES IN THE BUILDING

MIN STC 50 REQUIRED BETWEEN DWELLING UNITS

RISER

RUN

RISER

HANDRAILS

CASE OF A POWER INTERRUPTION. [9.9.12.3.(3)] FIRE EXTINGUISHERS PROVIDE FIRE EXTINGUISHERS IN OR ADJACENT TO CORRIDORS THAT PROVIDE ACCESS TO EXIT

LIGHITNG FOR A MIMIMUM OF 30 MINS IN THE

ACCESSIBILITY REQUIREMENTS — ACCESSIBLE WASHROOM TO BE PROVIDED [3.8.2.3.(1) AND (2)]

SPATIAL SEPARATION SUMMARY

9.10.14.4.A.]						
ELEV-	AREA OF	LIMITING	PERMITTED AREA	ACTUAL		
ATION	EXPOSING	DISTANCE	OF UNPROTECTED	AREA		
	BUILDING FACE		OPENINGS			
NORTH	358sf (33m2)	140'-0" (43m)	100%	26%		
EAST	880sf (82m2)	65'-0" (20m)	100%	29%		
SOUTH	437sf (41m2)	90'-0" (27m)	100%	28%		
NEST	825sf (77m2)	62'-0" (19m)	100%	2%		

PROJECT NOTES

REFER TO SURVEY PLAN PREPARED BY OLSEN & ASSOCIATES FOR PROPERTY LINES AND NATURAL GRADE TOPOGRAPHY

REFER TO GEOTECHNICAL REPORT FROM GEOPACIFIC CONSULTANTS LTD. FOR GEOTECHNICAL INFORMATION REFER TO ARBORICULTURAL INVENTORY AND

REPORT PREPARED BY *DIAMOND HEAD CONSULTING*

LEGAL DESCRIPTION

LOT 58 PLAN 27955, LOT 44 PLAN 17345 AND LOT 45 ALL OF SECTION 23 BLOCK 5 NORTH RANGE 2 WEST NEW WESTMINSTER DISTRICT

CIVIC ADDRESS 10575 / 10593 / 10605 - 139 ST, SURREY, BC, V3T 4L8

DEVELOPMENT STATISTICS

LOTS 10575 / 10593 / 10605 2951.7m² [31772 SF] SETBACKS FRONT YARD: 7.5m [25ft] REAR YEARD: 7.5m [25ft] SIDE YARD: 1.8m [6ft] HEIGHT: MAX 9m [30ft], MAX 7.3m [24ft] FOR ANY ROOF WITH SLOPE <1:4

CURRENT ZONING RF (SINGLE FAMILY RESIDENTIAL ZONE) BYLAW 12000, SECTION 16.1

106 Ave

PRE-SALE SITE

STREET, SURREY

10605, 10593,

10575 139TH

GROSS BUILDING AREA: 238.8m² [2571 SF] PARKING PROVIDED: 12 STALLS TOTAL (1 HC)

PROJECT DIRECTORY

MOSAIC 500-2609 GRANVILLE ST, VANCOUVER, BC V6H 3H3 T: 604-685-3888 STEPHANIE DA SILVA

E: STEPHANIE.DASILVA@MOSAICHOMES.COM M: 604-761-8608 MIZA ARCHITECTS INC 303 - 2425 QUEBEC ST, VANCOUVER, BC V5T 4L6 T: 604-800-6147 DAVID ZEIBIN, ARCHITECT AIBC MRAIC LEED AP BD+C

E: DZEIBIN@MIZAARCHITECTS.COM M: 604-220-6921 STRUCTURAL CHRIS LEE TLSE STRUCTURAL ENGINEERING 121 WEST 6TH AVENUE, VANCOUVER, BC V5Y 1K3

T: 604-873-1768 CHRIS.LEE@TLSE.CA MECHANICAL RICHARD CORRA ROCKY POINT ENGINEERING LTD 208-20171 92A AVENUE, LANGLEY, BC V1M 3A5 T: 604-888-7779

T: 778-277-2225

RICHARD.CORRA@RPENG.CA ELECTRICAL MARC GAGER 20689 56TH AVENUE, LANGLEY, BC V3A 3Y9

MARC.GAGER@GAGERELECTRICAL.COM CORMAC NOLAN CORE GROUP CONSULTANTS 320 - 8988 FRASERTON COURT, BURNABY, BC V5J 5H8 T: 604-299-0605

CNOLAN@COREGROUPCONSULTANTS.COM LANDSCAPE ARCHITECT JUDY STOYKO CONNECT LANDSCAPE ARCHITECTURE 2305 HEMLOCK ST, VANCOUVER, BC V6H 2V1 T: 604-681-3303

JUDY@CONNECTLA.CA ARBORIST CONOR CORBETT DIAMOND HEAD CONSULTING 3559 COMMERCIAL ST, VANCOUVER BC V5N 4E8 T: 604-733-4886 CONOR@DIAMONDHEADCONSULTING.COM INTERIOR DESIGNER

KRISTA CALERO INSIGHT DESIGN GROUP STUDIO 200 - 1737 W 3 AVE, VANCOUVER, BC, V6J 1K7 T: 604-602-1750 D:778-945-6316 E: KRISTA@INSIGHTDESIGNINC.COM

Forsyth Park

MOSAIC PARKER

DEVELOPMENT

A0 GENERAL A001

COVER SHEET SITE PLAN

DRAWING INDEX

A101 A2 FLOOR PLANS FLOOR PLAN A210

A4 ELEVATIONS A401 ELEVATIONS

STRUCTURAL REFER TO DRAWING SET - S SERIES

REFER TO DRAWING SET - M SERIES ELECTRICAL

MECHANICAL

INTERIOR DESIGNER

REFER TO DRAWING SET - E SERIES REFER TO DRAWING SET - C SERIES

LANDSCAPE ARCHITECT REFER TO DRAWING SET - L SERIES

REFER TO DRAWING SET - ID SERIES

NO. 18-0159 17 SEP 2018 13 17 SEP 2018 TUP RE-SUBMISSION 12 31 AUG 2018 TENDER 11 30 JULY 2018 COORDINATION

APPLICATION

10 26 JUNE 2018 BUILDING PERMIT 9 11 JUNE 2018 COORDINATION 8 08 JUNE 2018 TUP RE-SUBMISSION


7 06 JUNE 2018 COORDINATION 5 23 MAY 2018 COORDINATION 4 04 MAY 2018 COORDINATION NO DATE DESCRIPTION ISSUES + REVISIONS


SEAL

TEL 604 800-6147 EI Copyright reserved. This des Architect and cannot be used Architect. This drawing is not purpose by the Architect. Pr shall verify all dimensions, ascertain any discrepand Documents; and bring these PARKER PRE-SA CIVIC ADDRESS 10575 / 10593 / 1060 PROJECT CODE SCALE As indicated COVER SHEET

→ PERSPECTIVE VIEW


CONTEXT PLAN
NOT TO SCALE

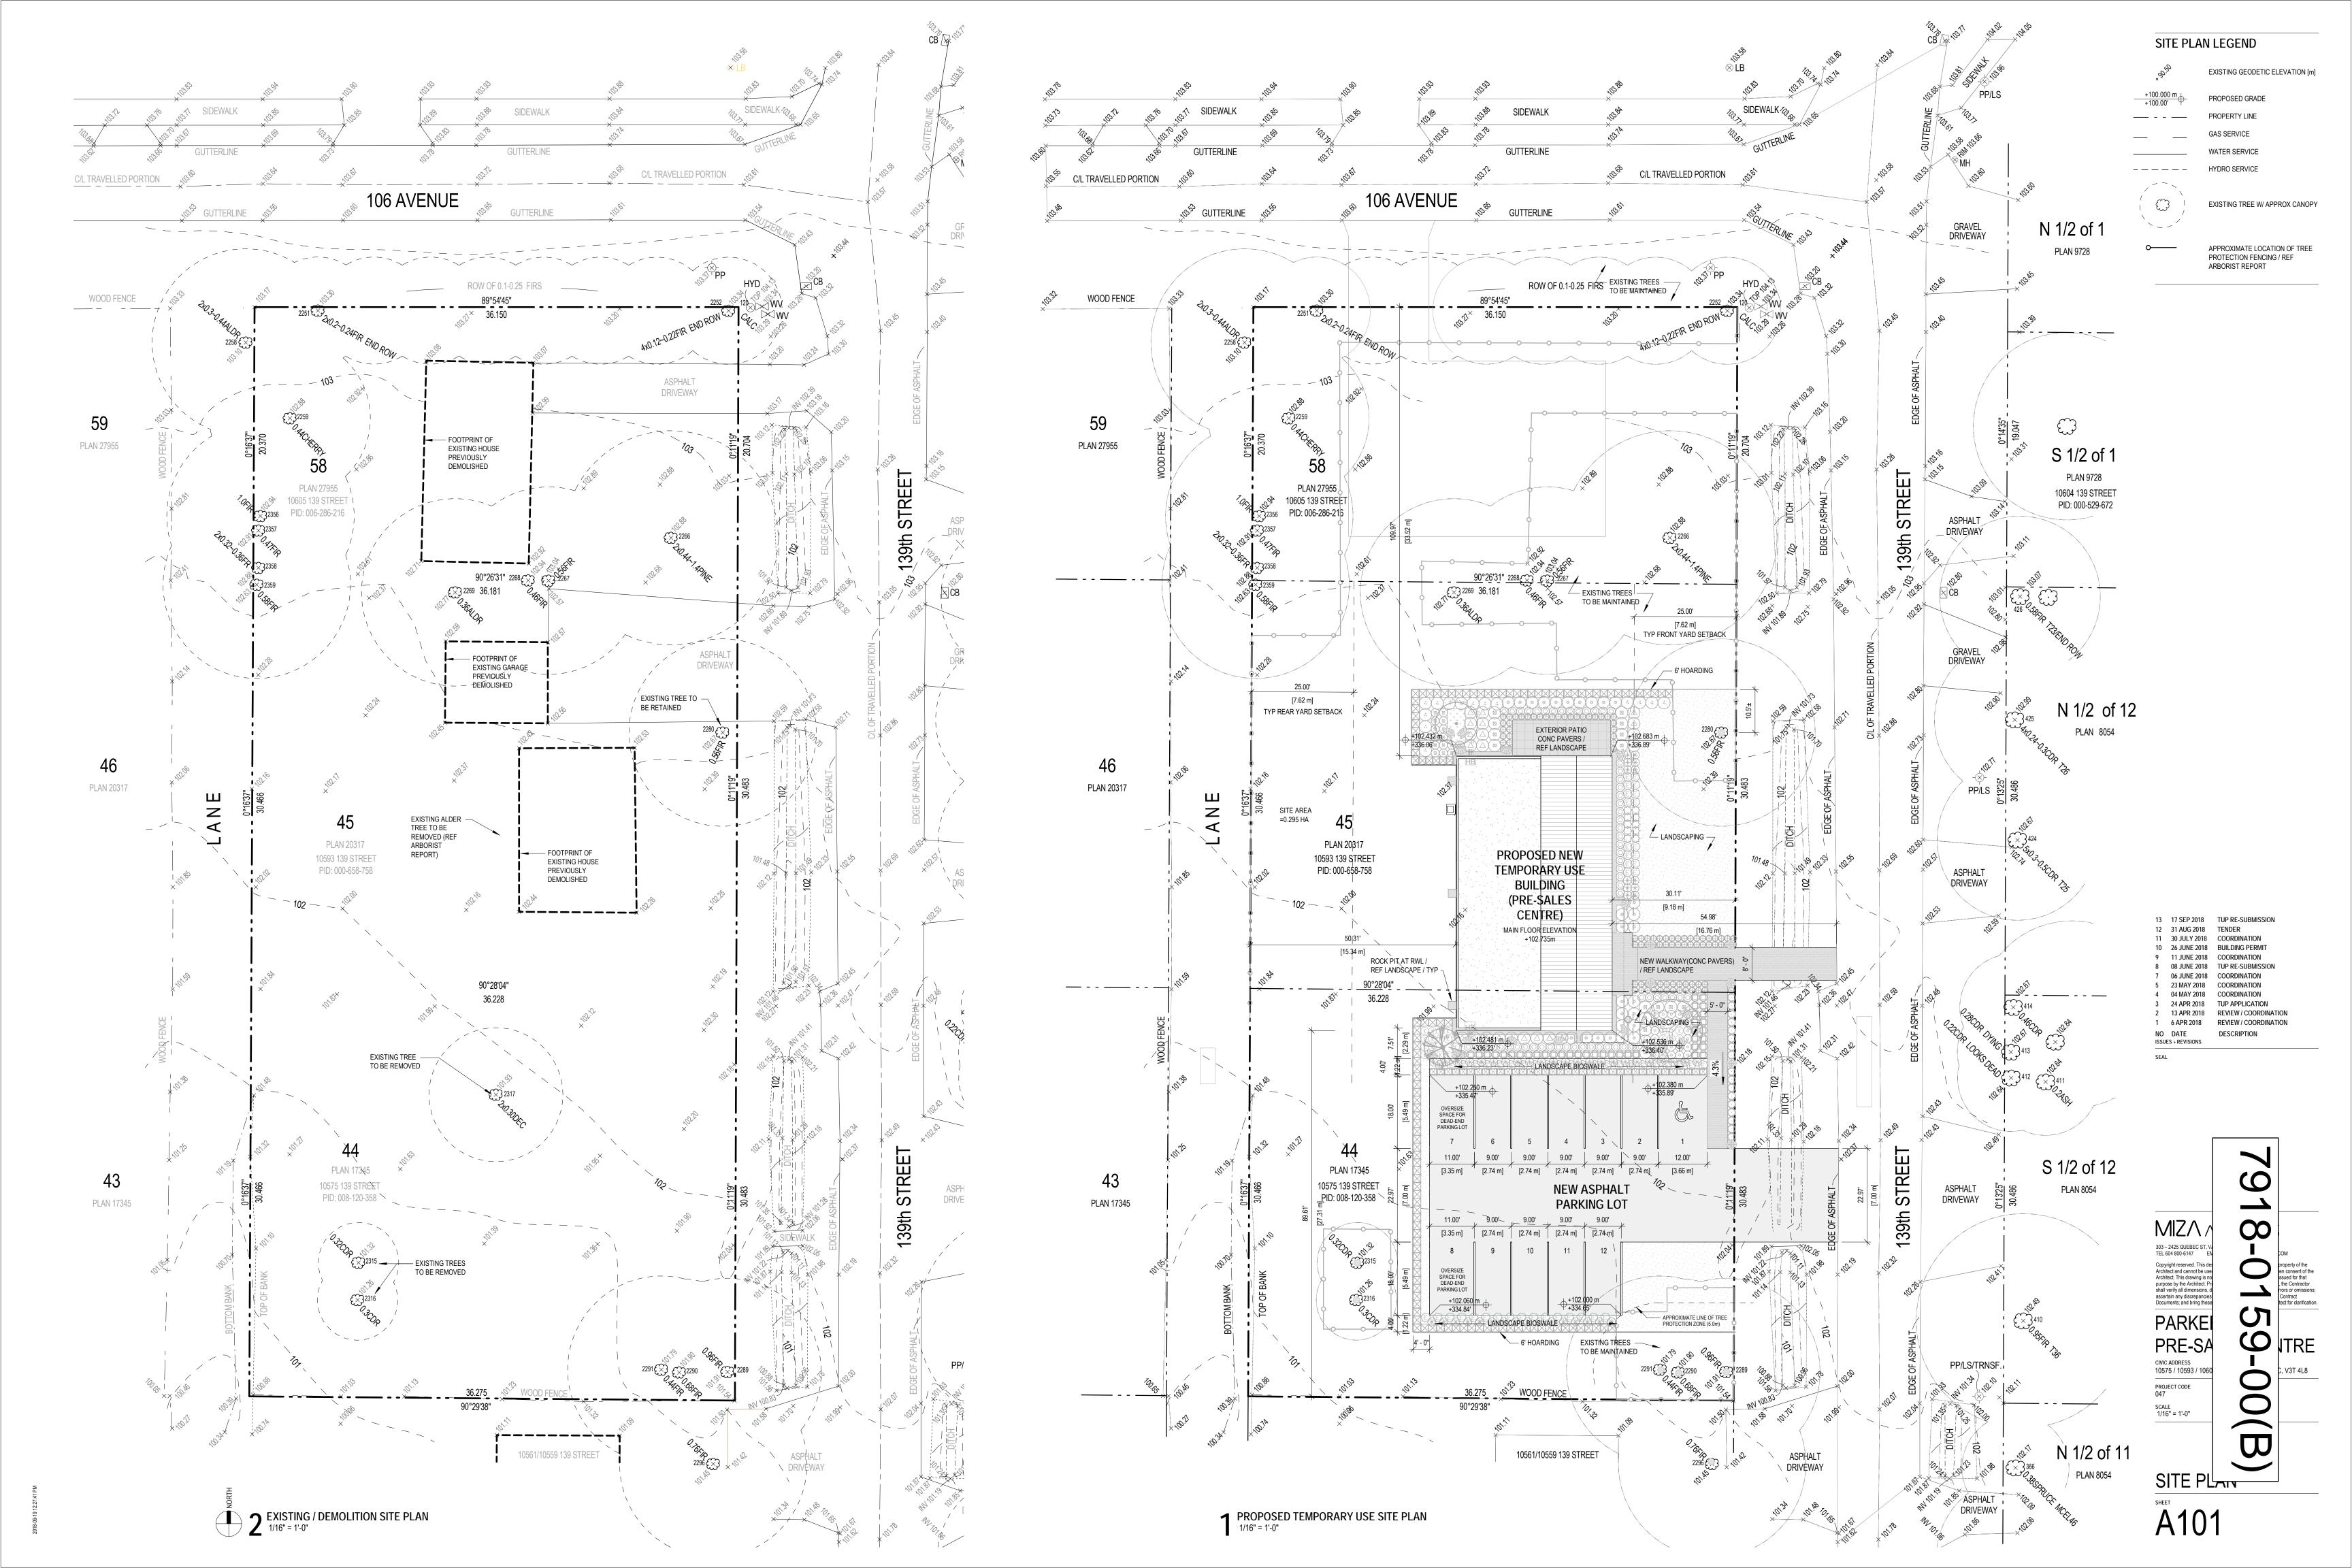

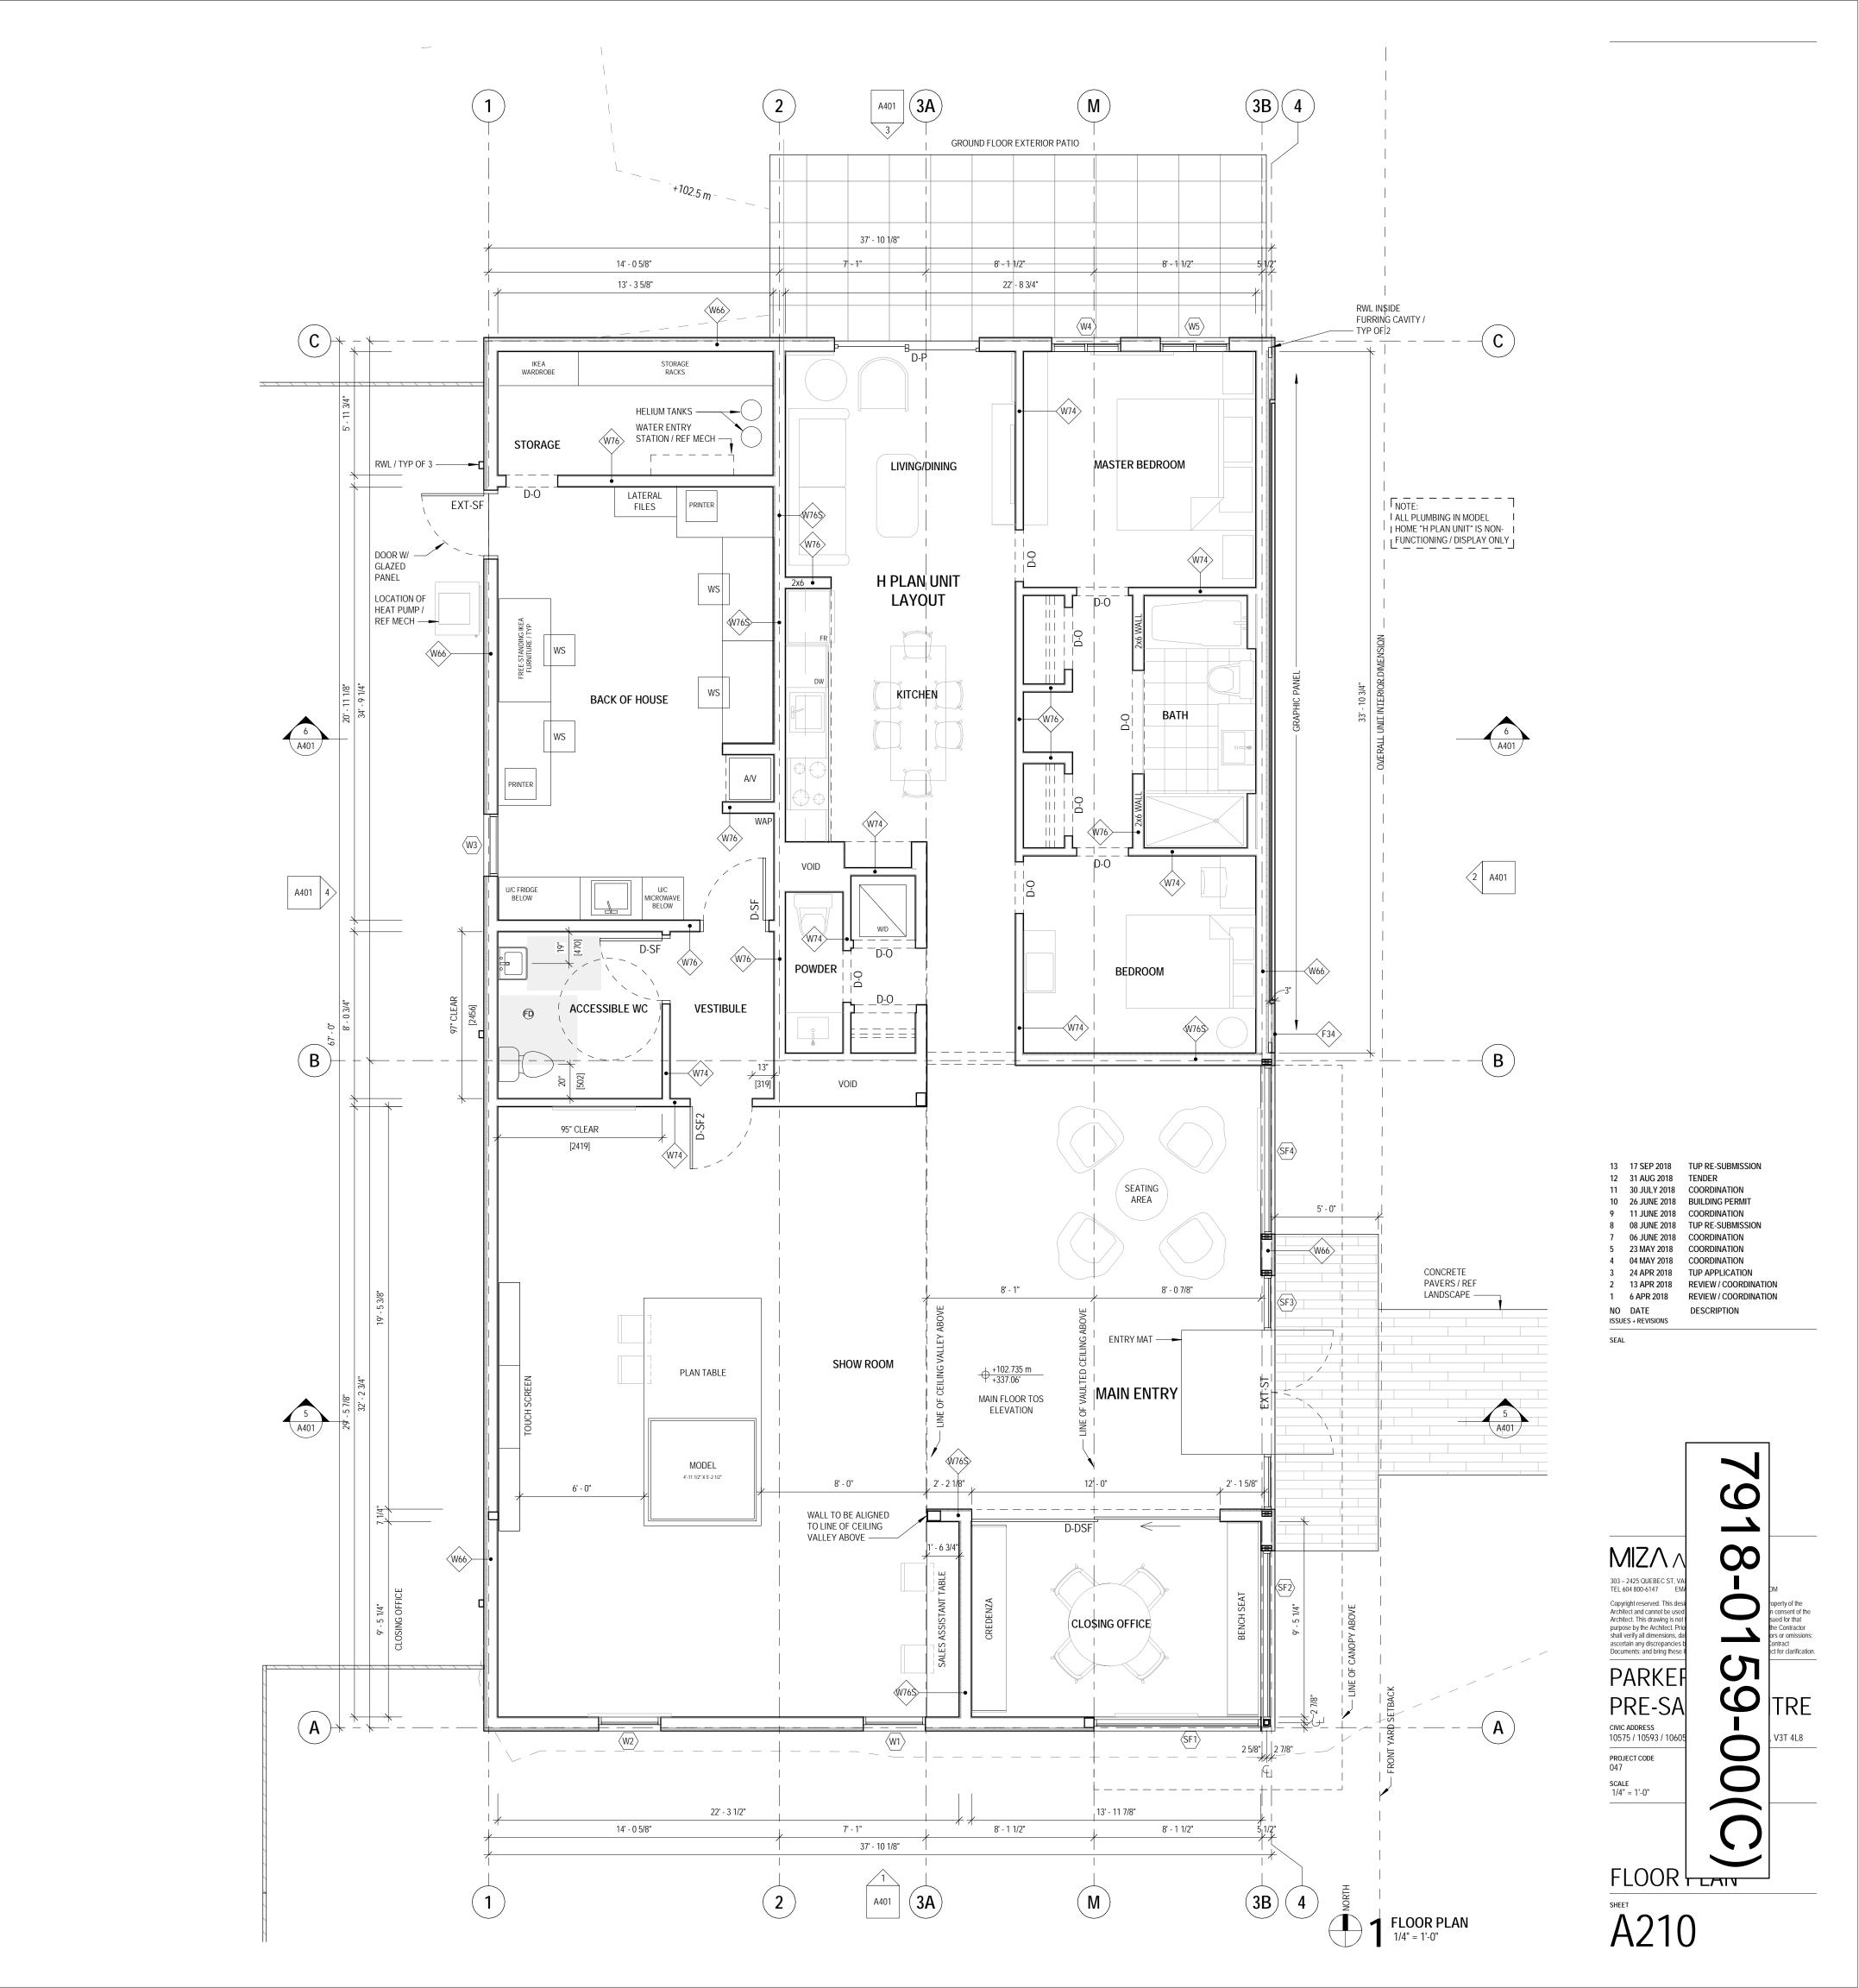

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PARKER PRE-SALES CENTRE

RE-ISSUED FOR TUP NOVEMBER 23, 2018

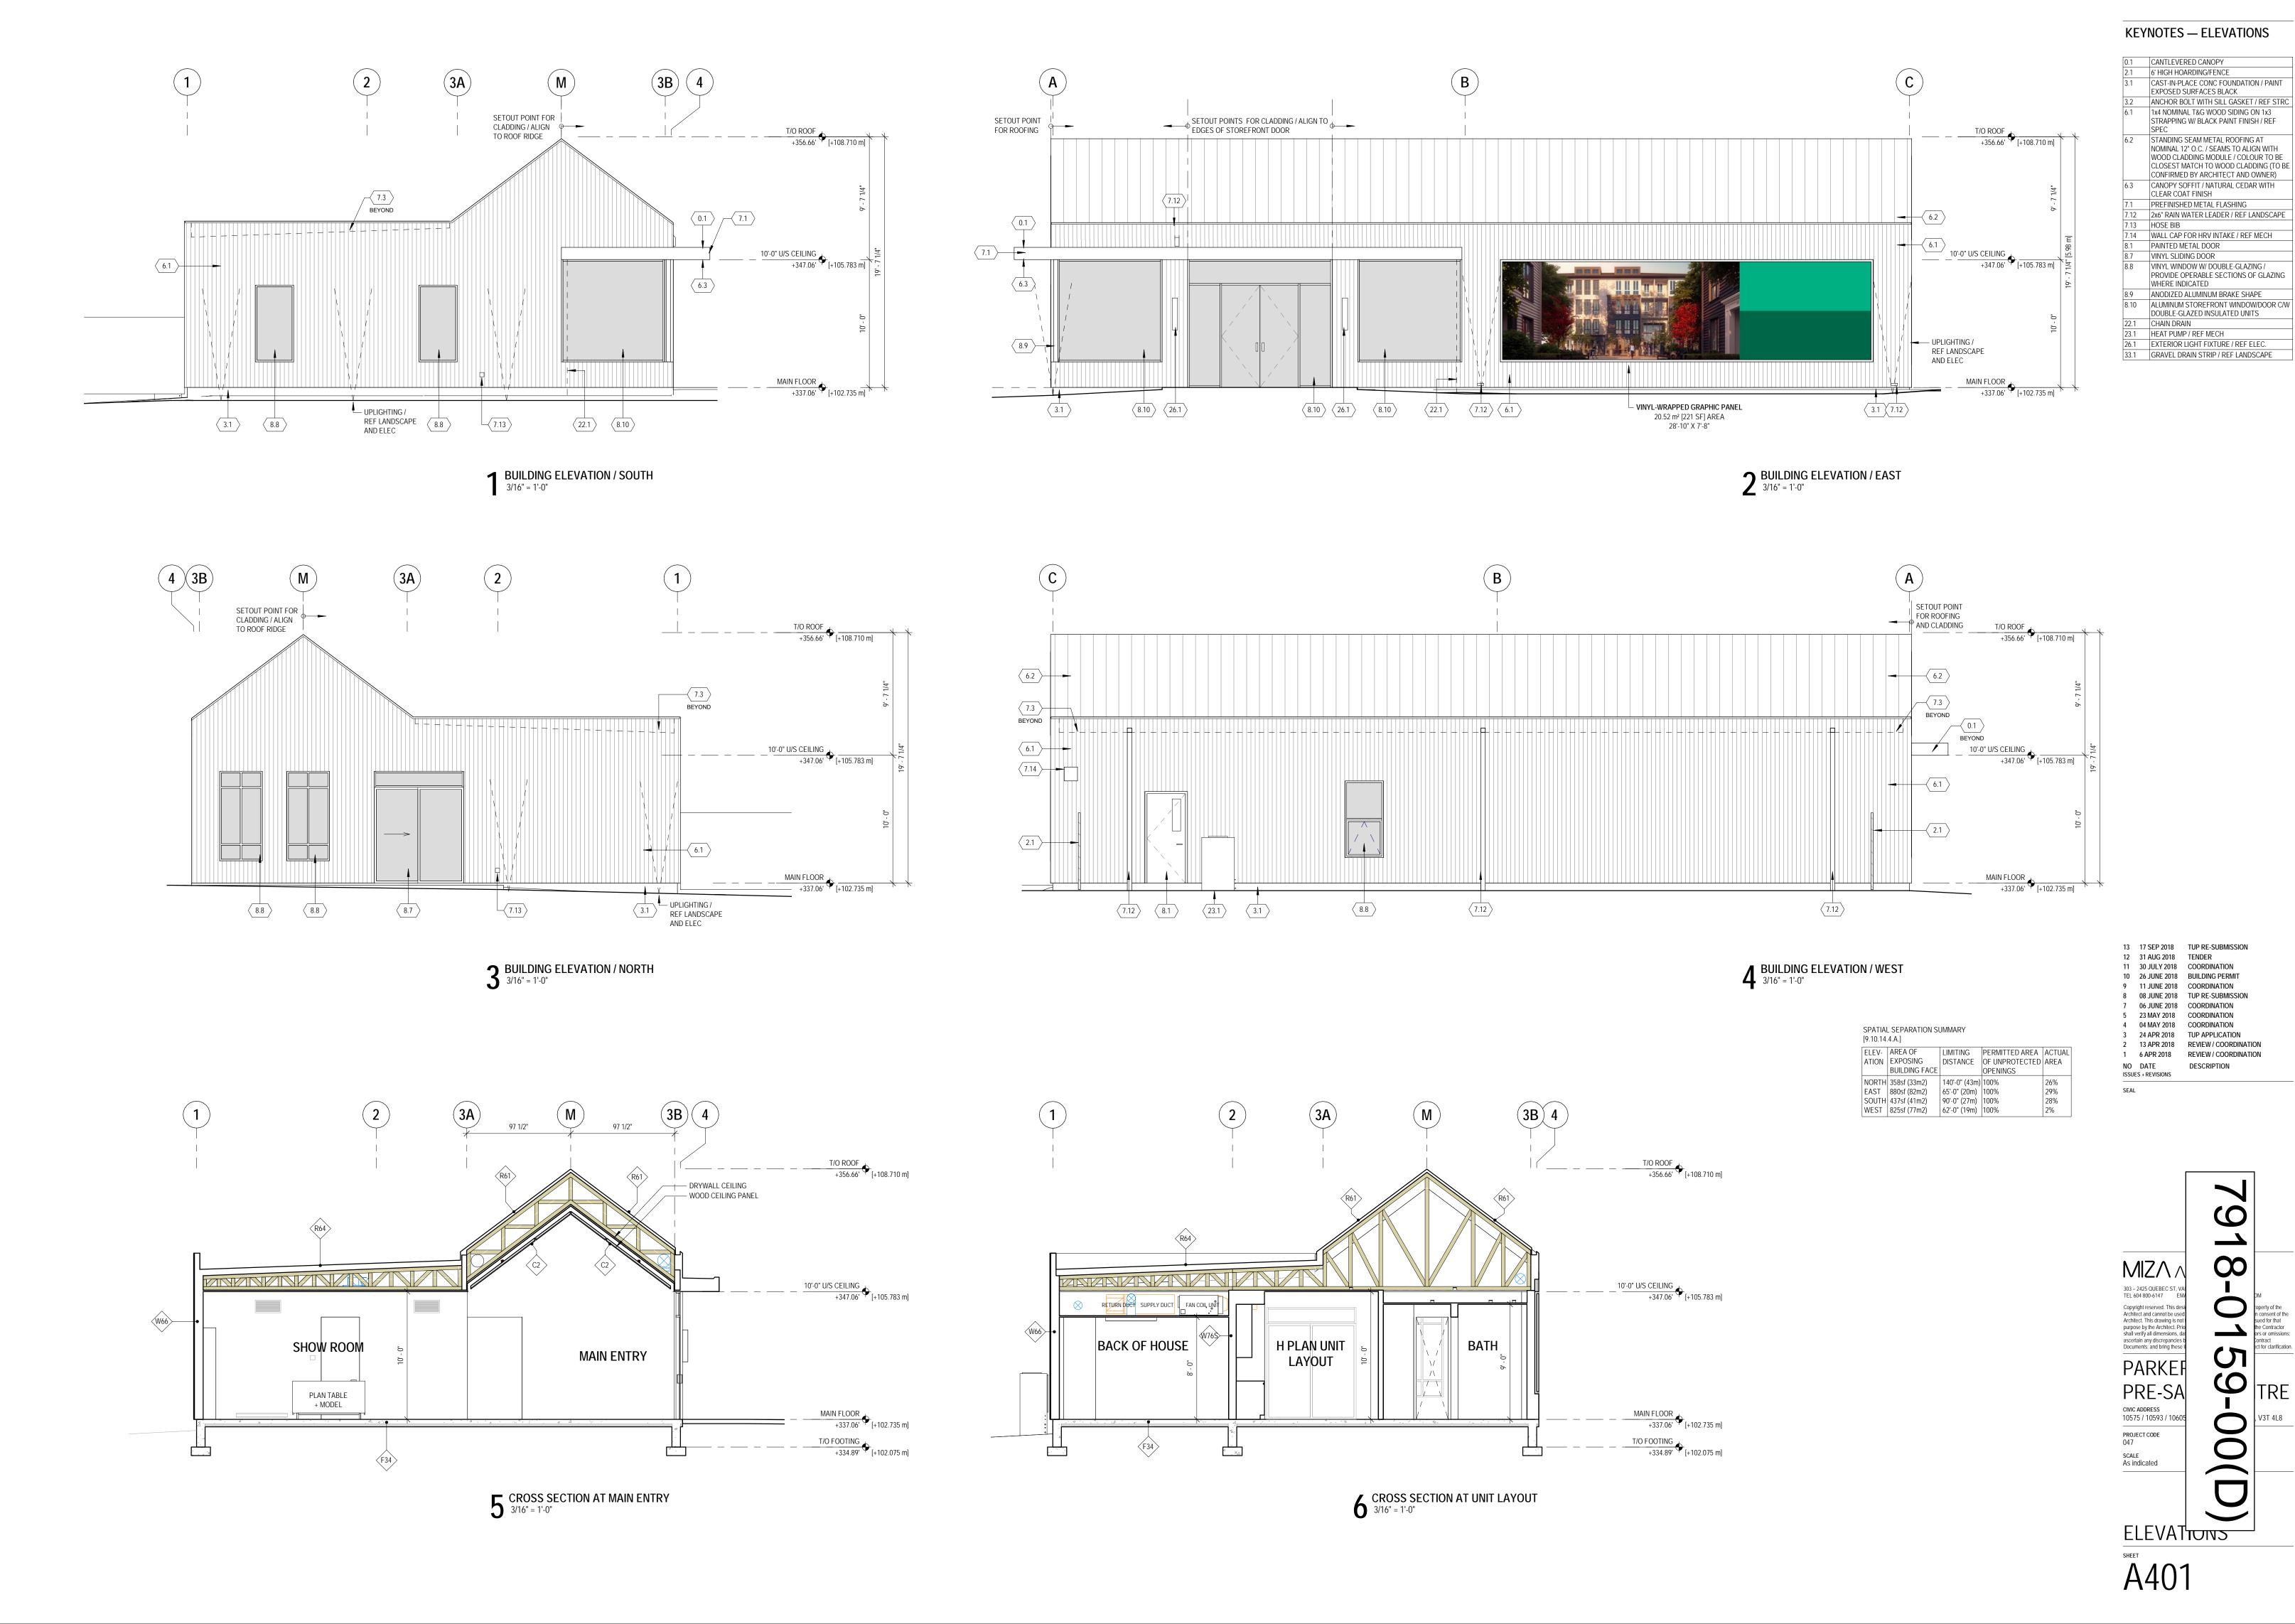LANDSCAPE DRAWING INDEX

DRAWING INDEX				
SHEET No.	SHEET NAME			
L0.0	COVER SHEET AND DRAWING LIST			
L1.0	LAYOUT AND MATERIALS PLAN			
L2.0	PLANT LIST			
L2.1	PLANTING PLAN			
L3.0	IRRIGATION PLAN			
L4.0	DETAILS - SOFTSCAPE			
L4.1	DETAILS - HARDSCAPE			

GENERAL NOTES

ALL LANDSCAPE ARCHITECTURAL DRAWINGS IN THIS PACKAGE SHALL BE READ IN CONJUNCTION WITH ALL OTHER LANDSCAPE ARCHITECTURAL DRAWINGS, DETAILS, SPECIFICATIONS, AND OTHER CORRESPONDANCE THAT MAY BE ISSUED DURING THE COURSE OF THE CONTRACT.

IF A DISCREPANCY OCCURS BETWEEN THE DRAWINGS AND THE SPECIFICATIONS OR ANY OTHER DOCUMENT ASSOCIATED WITH THE PROJECT, THE CONFLICT SHALL BE REPORTED IN WRITING TO THE LANDSCAPE ARCHITECT TO OBTAIN CLARIFICATION AND APPROVAL BEFORE PROCEEDING WITH WORKS.

THE CONTRACTOR SHALL VISIT THE SITE TO VERIFY THE TRUE EXISTING CONDITIONS. ANY UNCLEAR ISSUES SHALL BE CLARIFIED WITH THE LANDSCAPE ARCHITECT. NO CLAIM SHALL BE ALLOWED FOR EXTRAS WHICH MAY ARISE THROUGH NEGLECT OF THIS ADVICE.

ALL EXISTING INFORMATION IS BASED ON AVAILABLE RECORDS AND SHALL NOT BE CONSTRUED TO BE COMPLETE OR ACCURATE.

LAYOUT OF HARDSCAPE, SITE FURNITURE, SOIL, PLANTING, AND ALL OTHER MATERIALS IS TO BE STAKED OUT AND APPROVED BY THE LANDSCAPE ARCHITECT PRIOR TO INSTALLATION.

ALL PLANTING SHALL BE IN ACCORDANCE WITH BC LANDSCAPE STANDARD, LATEST EDITION, AND CANADIAN LANDSCAPE STANDRAD, LATEST EDITION.

THE CONTRACTOR IS RESPONSIBLE FOR DETERMINING THE EXISTENCE, LOCATION, AND ELEVATION OF ALL UTILITIES AND CONCEALED STRUCTURES, AND IS RESPONSIBLE FOR NOTIFYING THE APPROPRIATE COMPANY, DEPARTMENT OR PERSON(S) OF ITS INTENTION TO CARRY OUT ITS OPERATIONS.

CONNECT LANDSCAPE ARCHITECTURE INC. DOES NOT GUARANTEE THE EXISTENCE, LOCATION, AND ELEVATION OF UTILITIES OR CONCEALED STRUCTURES AT THE PROJECT SITE.

FINAL SELECTION AND APPROVAL OF ALL STREET TREES TO BE DONE BY THE CITY OF SURREY.

ALL PUBLIC REALM DETAILS TO THE SATISFACTION OF THE CITY OF SURREY.



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SITE

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OPERATIONS.

	RE-ISSUED FOR TUP	18-11-2
6	RE-ISSUED FOR TUP	18-09-14
5	ISSUED FOR TENDER	18-08-3
4	ISSUED FOR DRAFT IFT REVIEW	18-08-0
3	ISSUED FOR BP	18-06-26
2	ISSUED FOR TUP	18-06-13
1	ISSUED FOR REVIEW	18-05-13

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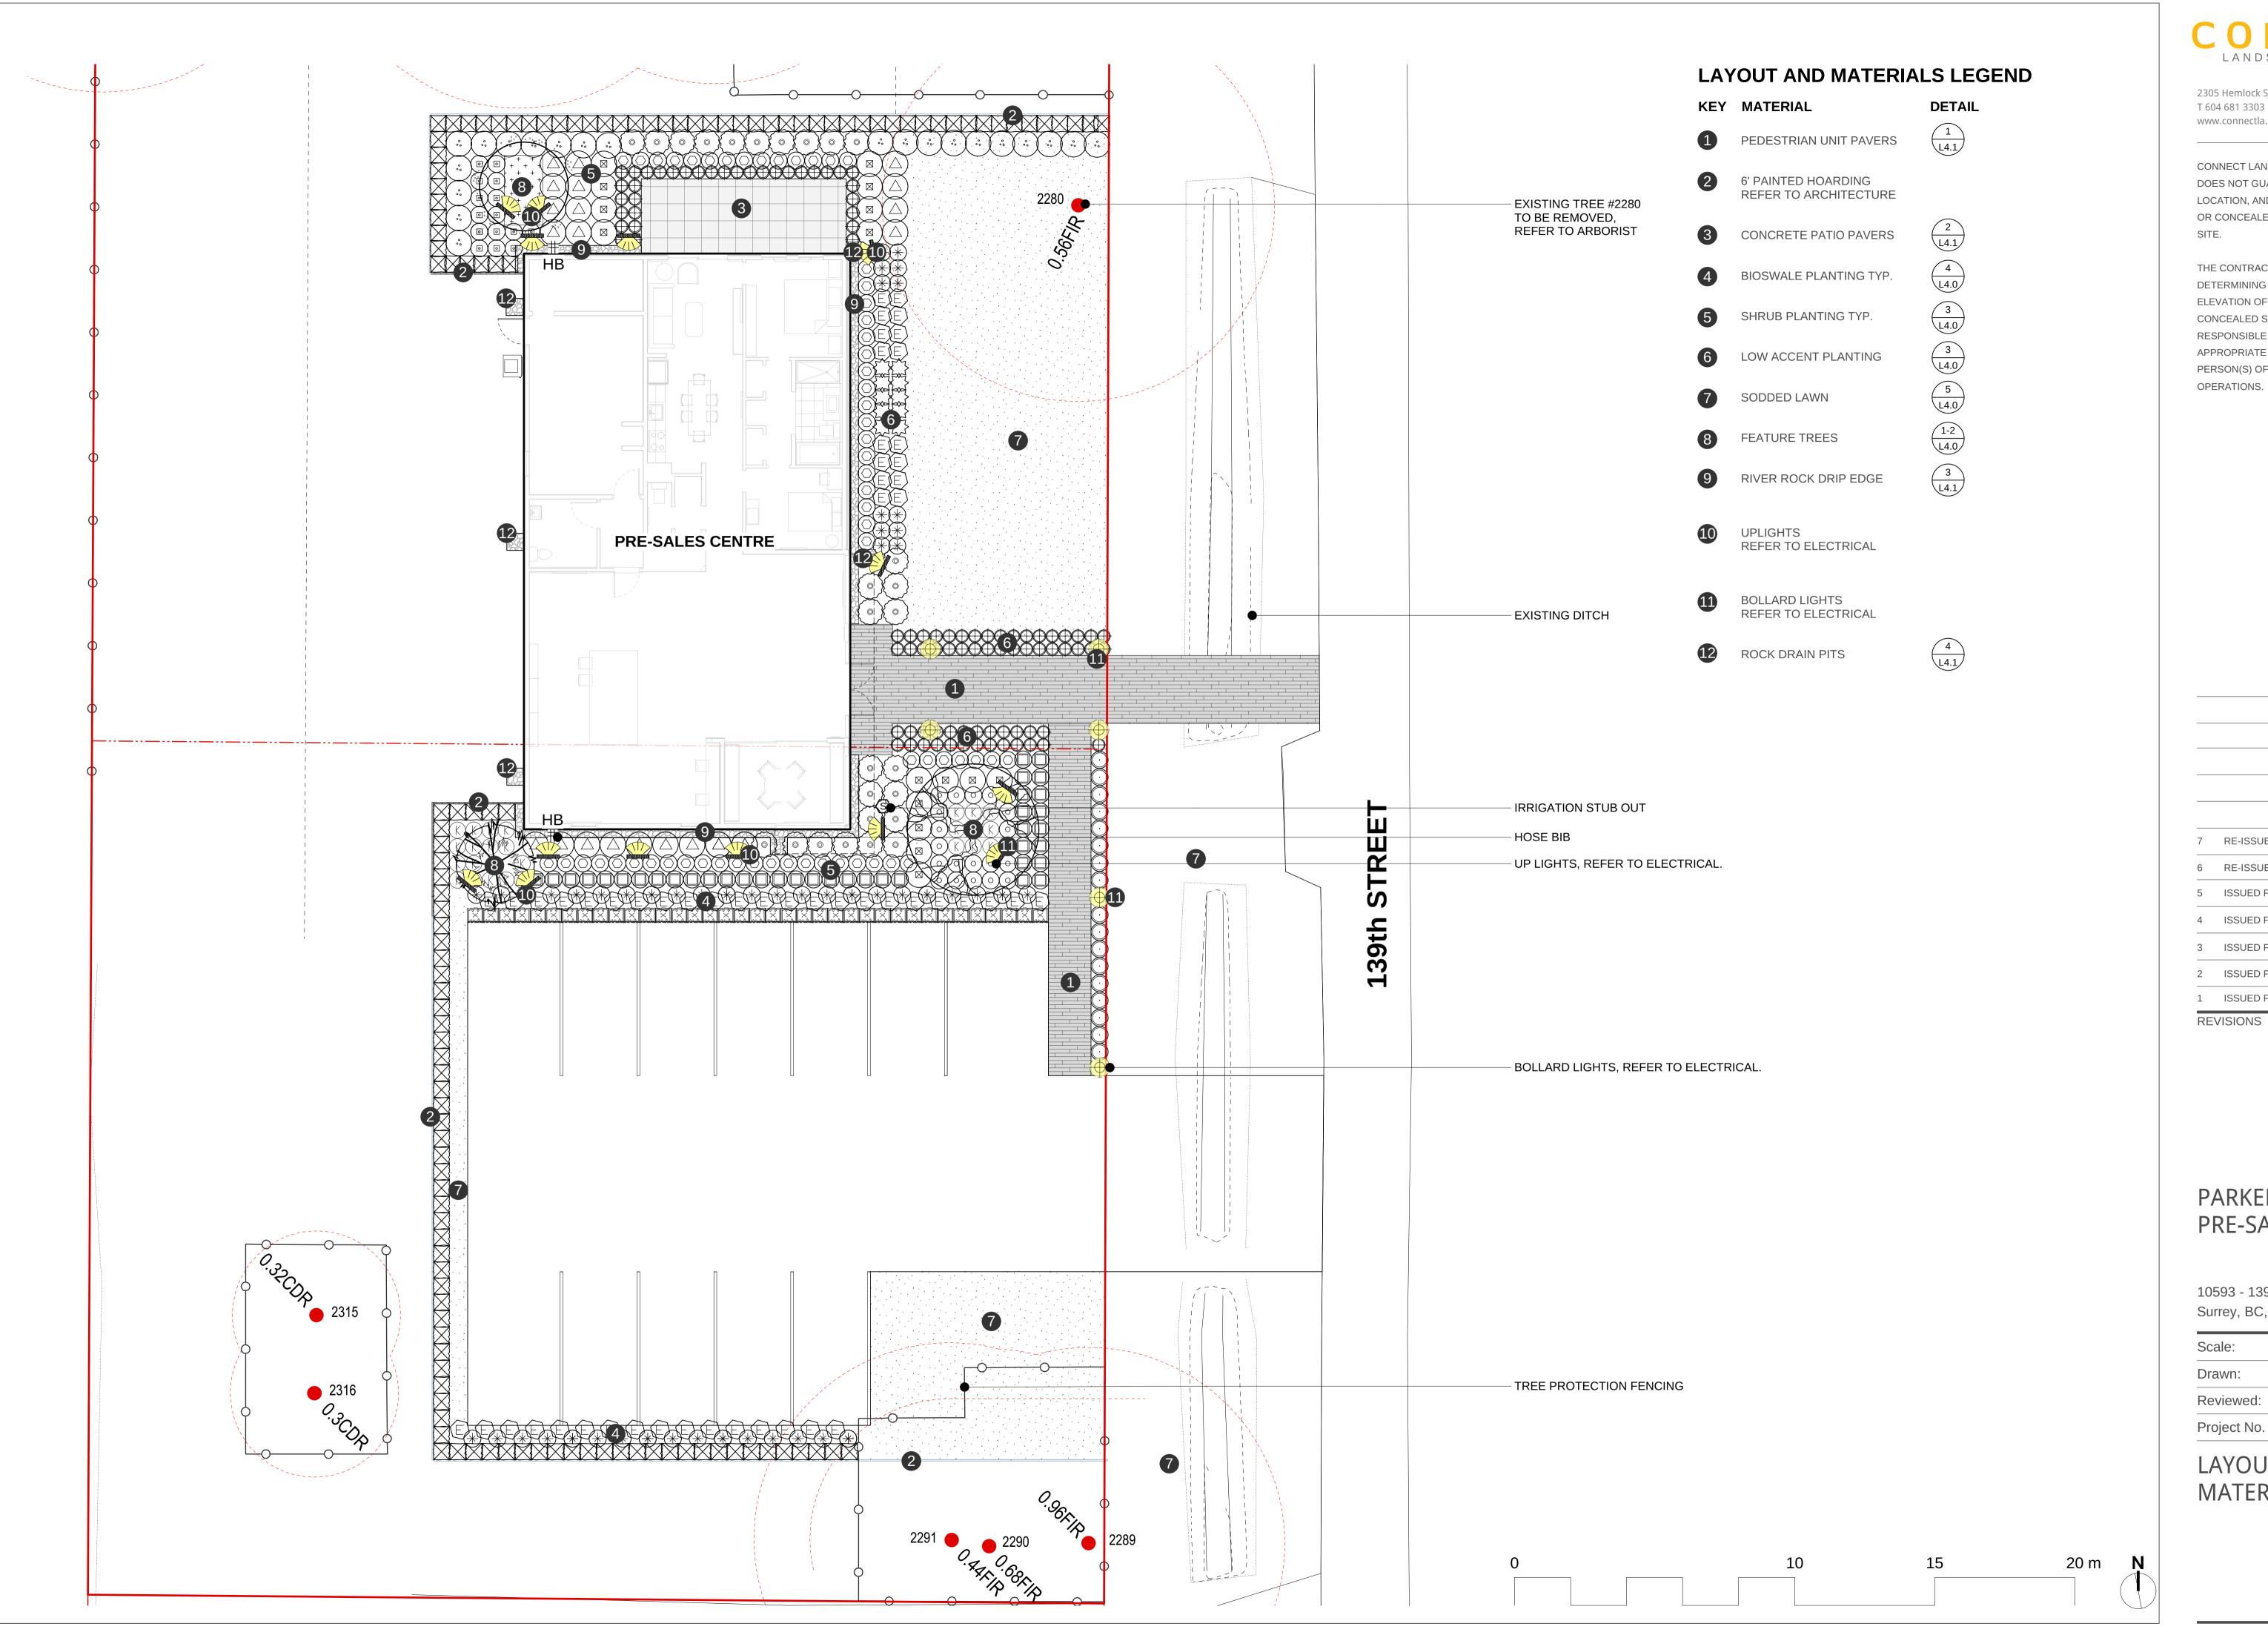
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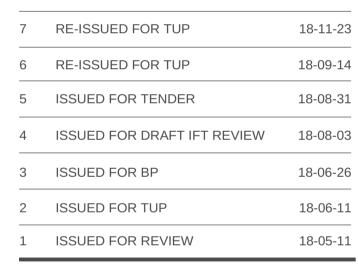




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PARKER PRE-SALES C

10593 - 139 ST.

Surrey, BC, V3T 4L8

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LAYOUT AND **MATERIALS**

PLANT LIST

205 Sodded lawn area (m2)

		TREES QTY.	BOTANICAL NAME	COMMON NAME	SIZE	SPACING
	N N	1	Acer palmatum 'Osakazuki'	Osakazuki Japanese Maple	3M ht., B&B	as shown
		1	Picea omorika	Serbian Spruce	3M ht., B&B	as shown
0		1	Stewartia pseudocamellia	Japanese Stewartia	5cm cal., B&B	as shown
		SHRUB	S			
00000		27	Hydrangea macrophylla	Bigleaf Hydrangea	#5 pot	36" o.c
	·••	21	Pieris japonica 'Mountain Fire'	Lily-of-the-Valley Shrub	#5 pot	36" o.c
	<u> </u>	16	Prunus laurocerasus 'Zabeliana'	Zabel's Cherry Laurel	#3 pot	24" o.c
	\triangle	23	Rhododendron 'Crete'	Pink Rhododendron	#5 pot	36" o.c
	\boxtimes	16	Rhododendron 'Hotei'	Yellow Rhododendron	#5 pot	36" o.c
		60	Rhododendron 'Ken Janeck'	Pink Yaku Rhododendron	#3 pot	24" o.c
	\odot	17	Sarcococca hookerana 'Humilis'	Himalayan Sweet Box	#3 pot	24" o.c
		38	Skimmia japonica	Japanese Skimmia	#3 pot	24" o.c
		37	Thuja occidentalis 'smaragd'	4' Emerald Cedar	#5 pot	24" o.c
		128	Thuja occidentalis 'smaragd'	6' Emerald Cedar	#5 pot	24" o.c
	\odot	21	Weigela florida 'Bokraspiwi'	Spilled Wine Weigela	#5 pot	36" o.c
		GROUN	ID COVERS AND VINES			
	K	24	Arctostaphylos uva ursi	Kinnikinnick	#1 pot	15" o.c
	+ + + +	24	Pachysandra terminalis	Japanese Spurge	4"(10cm) pot	15" o.c
		PERENI	NIALS, GRASSES, BULBS, AND ANI			
	E	55	Echinacea purpurea	Purple Coneflower	#1 pot	18" o.c
	\}	10	Hemerocallis 'Stella D'Oro'	Day Lily	#1 pot	18" o.c
	\bigoplus	93	Lavandula angustifolia	English Lavender	#1 pot	18" o.c
	*	61	Rudbeckia hirta	Black-Eyed Susan	#1 pot	24" o.c

PLANTING NOTES

- 1. ALL PLANTING SHALL BE IN ACCORDANCE WITH BC LANDSCAPE STANDARD, AND CANADIAN LANDSCAPE STANDARDS LATEST EDITION.
- 2. ALL TREE AND SHRUB BEDS ARE TO BE MULCHED WITH 50mm OF 2 MEDIUM FINE MULCH, LESS THAN 50mm DIAMETER.
- 3. ALL LANDSCAPE AREAS TO BE IRRIGATED WITH HIGH EFFICIENCY IRRIGATION SYSTEM.



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7 RE-ISSUED FOR TUP 18-11-23 6 RE-ISSUED FOR TUP 18-09-14 5 ISSUED FOR TENDER 18-08-31 4 ISSUED FOR DRAFT IFT REVIEW 18-08-03 3 ISSUED FOR BP 18-06-26 2 ISSUED FOR TUP 18-06-11 1 ISSUED FOR REVIEW 18-05-11

PARKER PRE-SALES C

REVISIONS


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PLANT LIST






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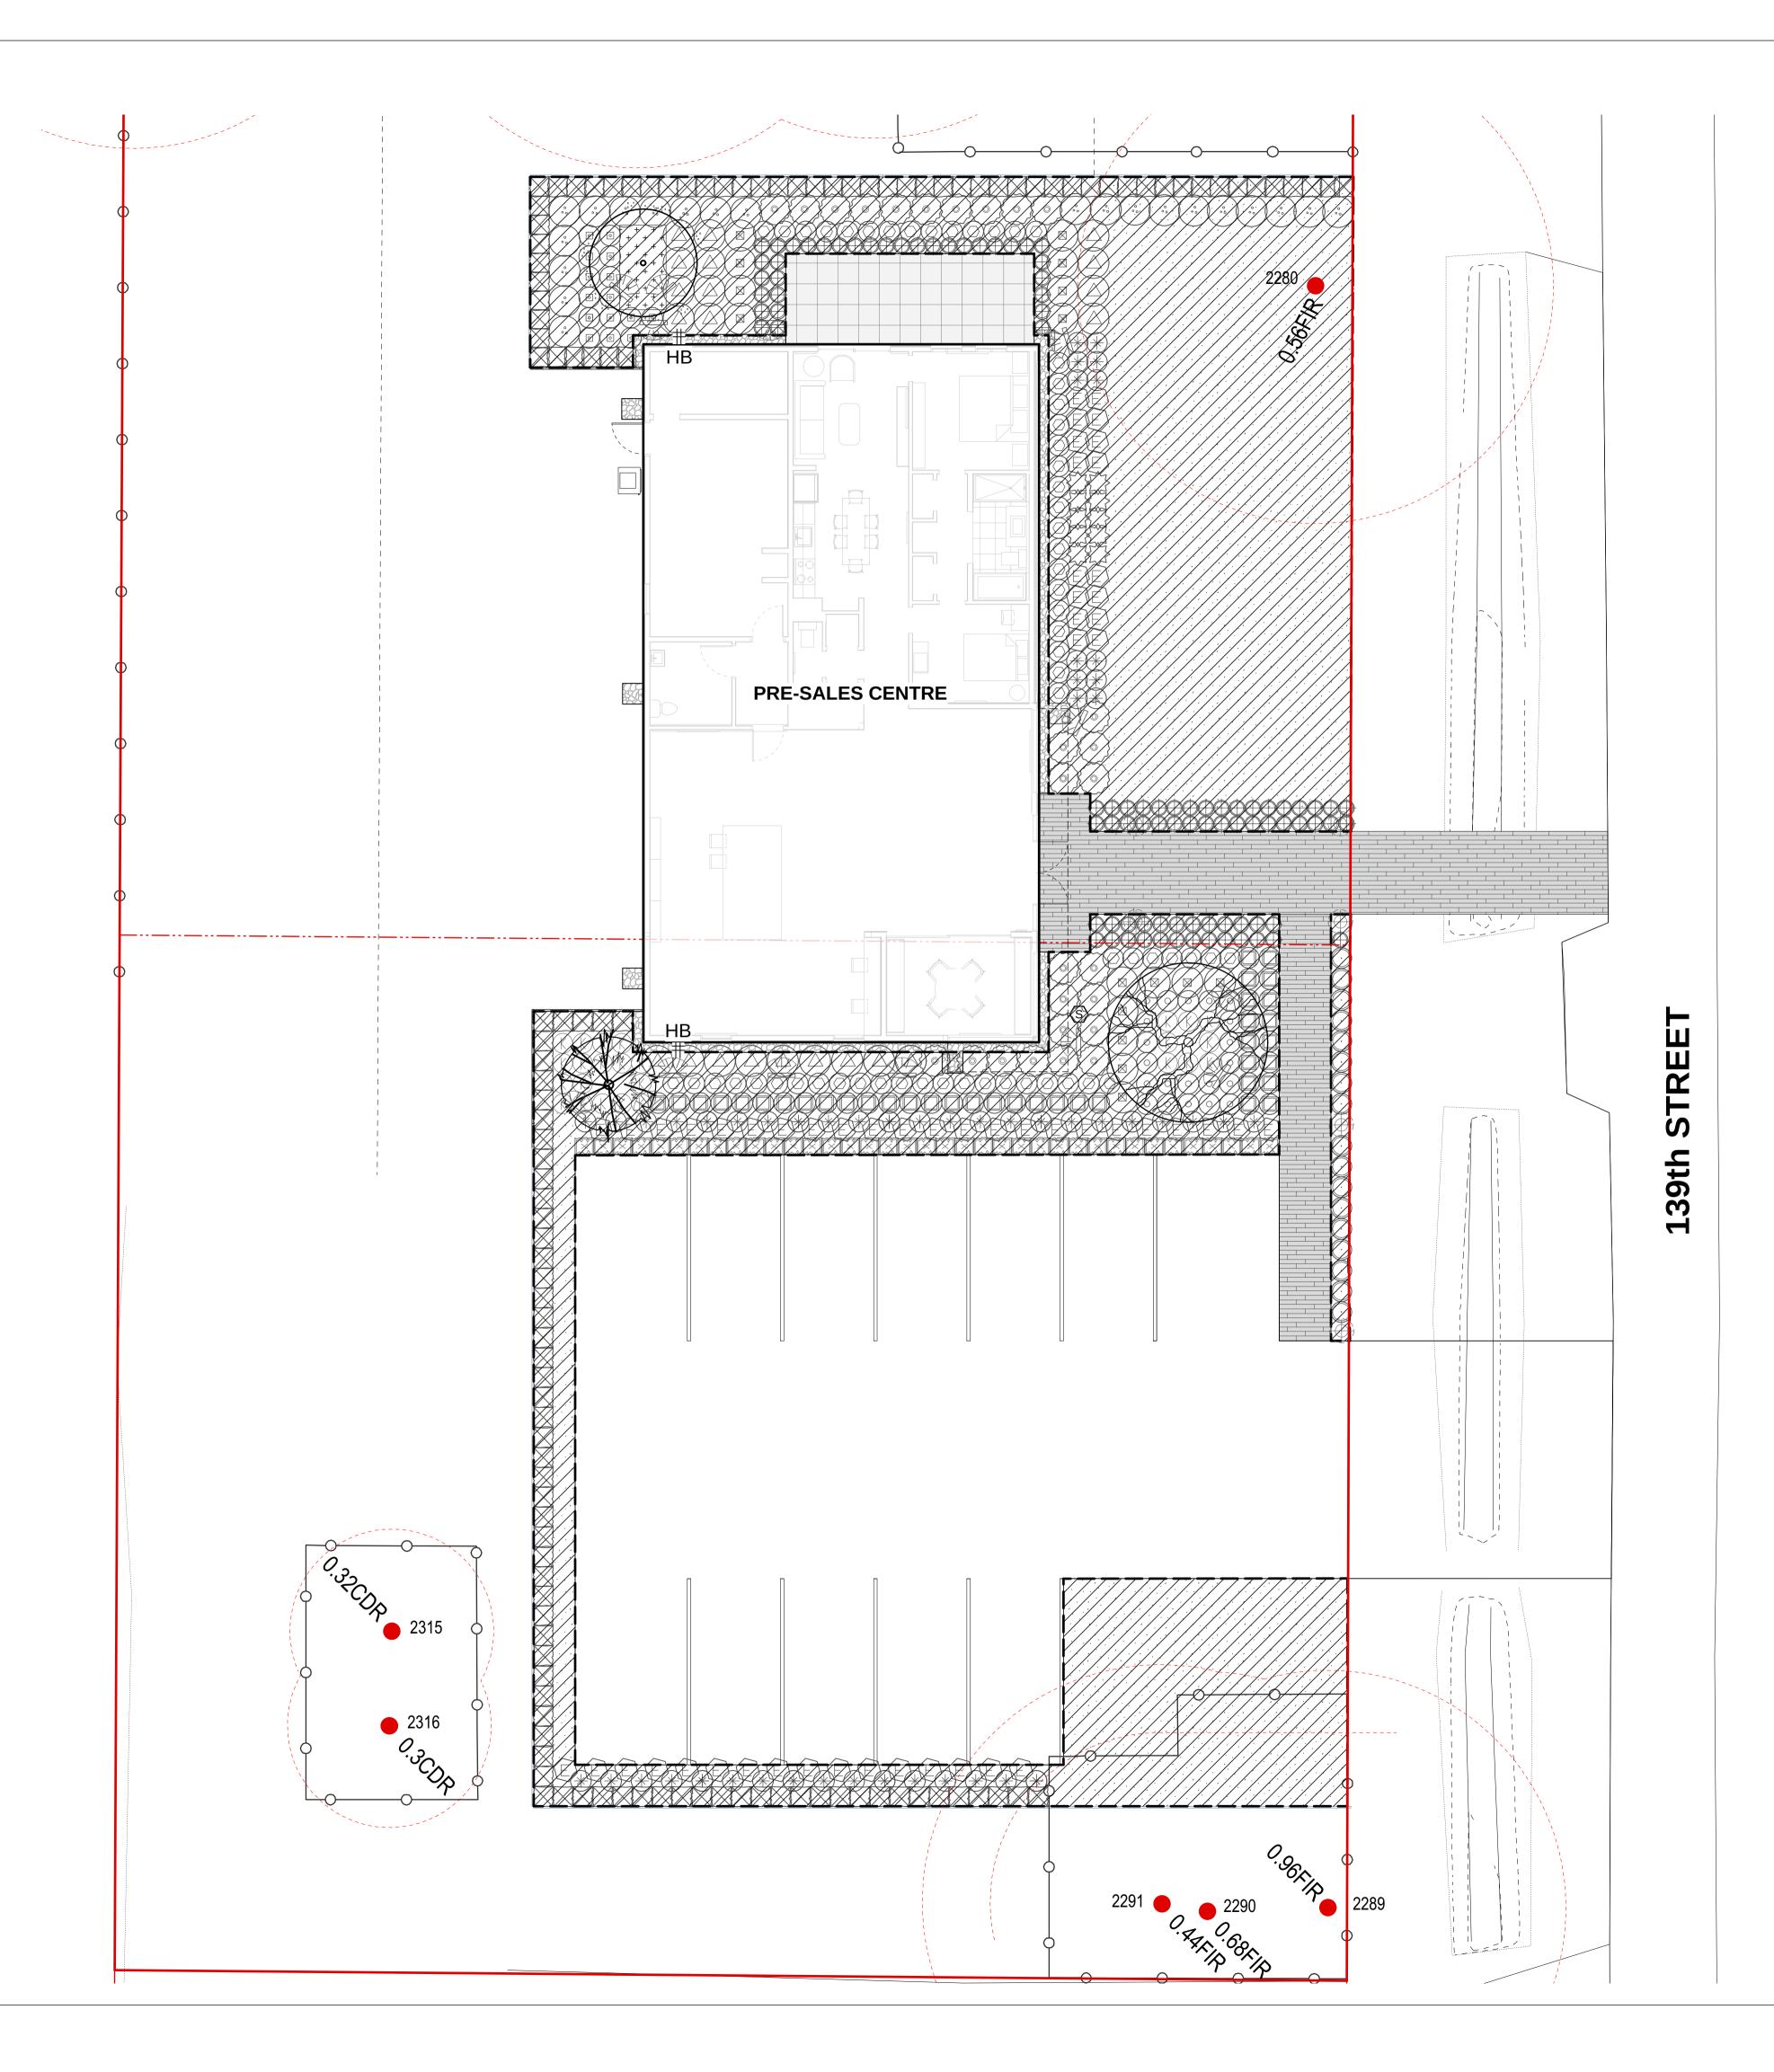
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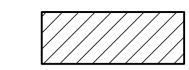


PARKER PRE-SALES C
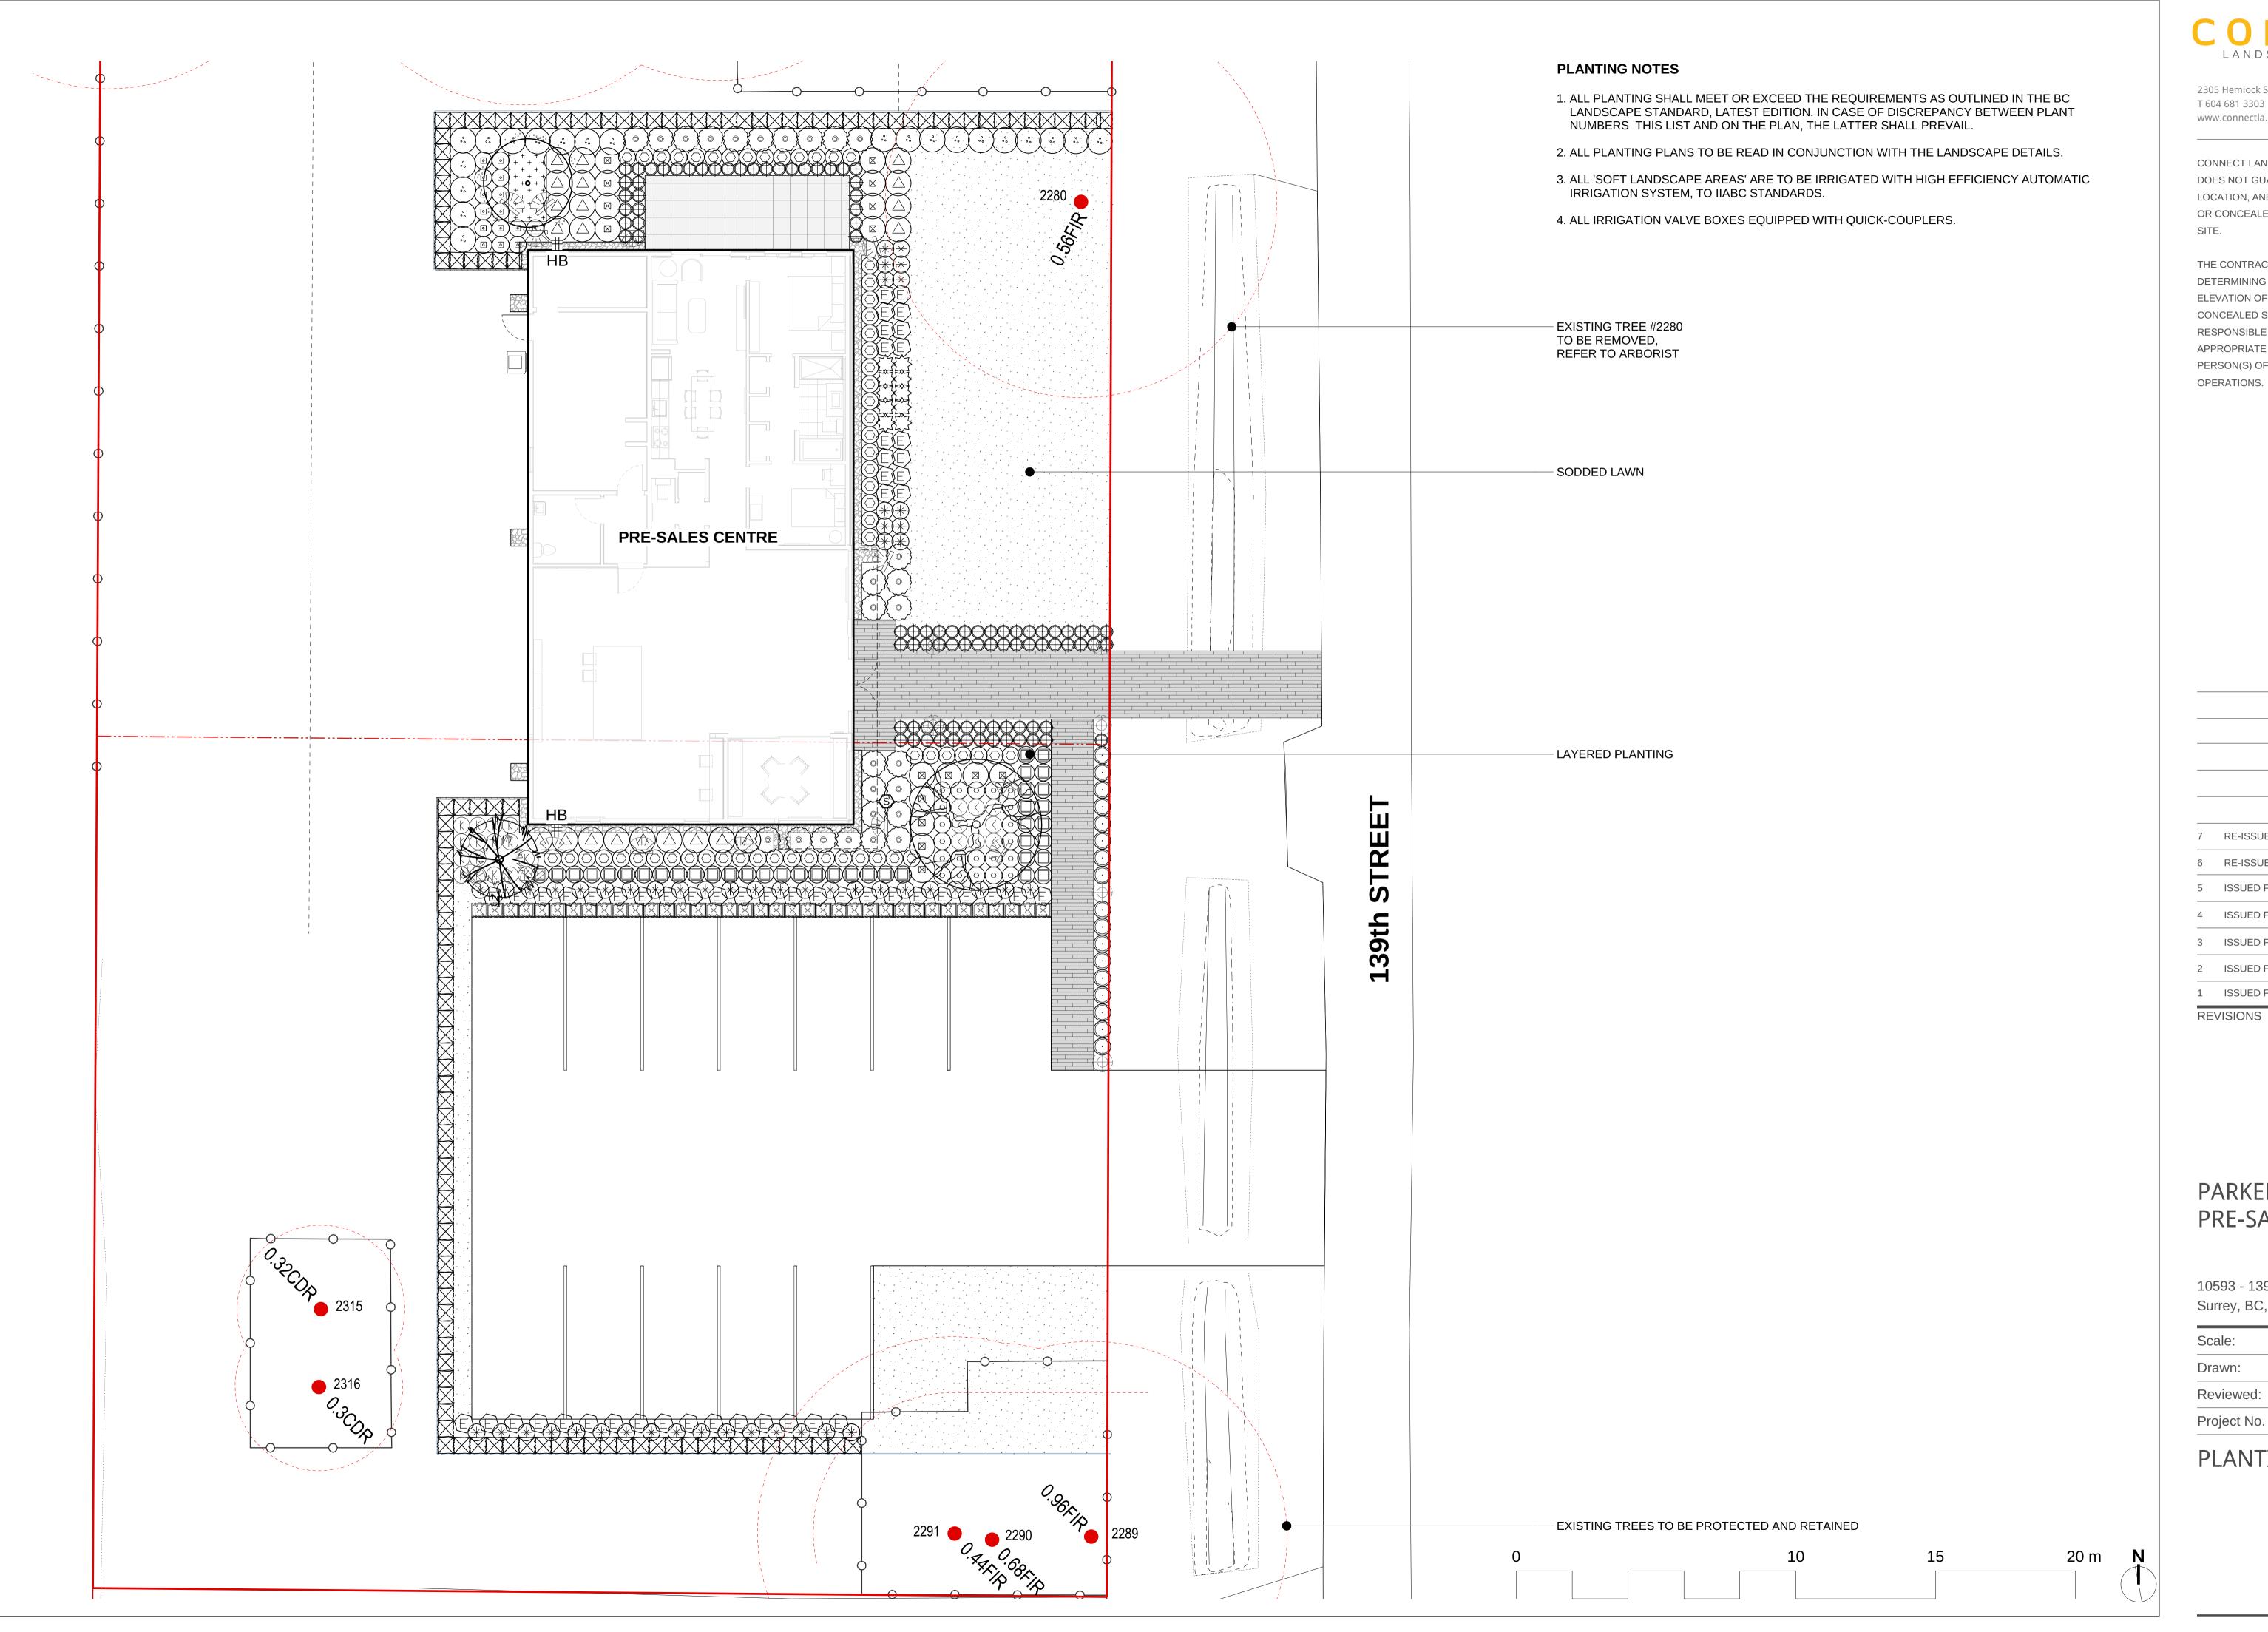
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PLANTING P

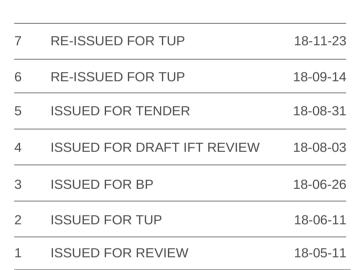



AREA TO BE IRRIGATED

DESIGN BUILD IRRIGATION NOTES:

- 1. LANDSCAPE CONTRACTOR TO PROVIDE COMPLETE DESIGN-BUILD SERVICES FOR ALL AUTOMATIC SITE IRRIGATION WORKS.
- 2. IRRIGATION CONTRACTOR PERFORMING THE WORK MUST HAVE MINIMUM (5) FIVE YEARS DOCUMENTED EXPERIENCE, AND A MEMBER IN GOOD STANDING OF THE IIABC (IRRIGATION INDUSTRY ASSOCIATION OF BC).
- 3. IRRIGATION TO CONFORM TO ALL LOCAL PLUMBING AND ELECTRICAL CODE REQUIREMENTS. CONTRACTOR IS RESPONSIBLE FOR COORDINATION WITH MECHANICAL AND ELECTRICAL CONSULTANTS AND TRADES.
- 4. IRRIGATION TO CONFORM TO ALL IIABC STANDARDS WITH THE FOLLOWING EXCEPTIONS: a. MATERIALS SECTION 8B: ALL PIPE TO BE MINIMUM CLASS 200 b. MATERIALS SECTION 5G: NO WIRE SMALLER THAN 14 GAUGE DIRECT BURIAL
- 5. COORDINATE WITH CIVIL CONTRACTOR TO PROVIDE PVC SLEEVING WHERE REQUIRED.
- 6. IRRIGATION STUB-OUTS AND HOSE BIBS PER MECHANICAL PLANS.
- 7. PROVIDE SHOP DRAWINGS FOR IRRIGATION LAYOUT TO CONSULTANT FOR REVIEW AND APPROVAL PRIOR TO FABRICATION AND INSTALLATION. INCLUDE SLEEVING, DRIP LINE, PIPE SIZE, VALVE BOXES, ETC., AND ALL IRRIGATION COMPONENT SPECIFICATIONS. VALVE BOXES TO BE LOCATED IN LOW-VISIBLE, PLANTED AREAS ONLY AND LOCATIONS TO BE APPROVED.
- 8. HIGH EFFICIENCY IRRIGATION TECHNOLOGY TO BE EMPLOYED INCLUDE, BUT ARE NOT LIMITED TO: CENTRAL SHUT-OFF VALVE, HIGH EFFICIENCY DRIP IRRIGARTION LINES
- 9. TEST SYSTEM PRIOR TO COMPLETION OF LANDSCAPE WORKS TO ENSURE NO LEAKAGE AND SPECIFIED PSI IS MET. PROVIDE WRITTEN NOTICE THAT PRESSURE TESTING HAS MET STANDARDS (LEAKS SHALL NOT BE REPAIRED BY PATCHING).
- 10. PROVIDE COVERAGE AND CONTROLLER TEST WHEN SYSTEM IS COMPLETE AND MAKE ADJUSTMENTS AS REQUIRED.
- 11. PROVIDE AS-BUILT RECORD DRAWINGS TO SCALE SHOWING LOCATIONS OF ALL CONCEALED COMPONENTS, PIPING SYSTEM AND CONDUIT.
- 12. MAINTAIN AND OPERATE IRRIGATION PER MANUFACTURER'S RECOMMENDATIONS THROUGHOUT WARRANTY PERIOD WINTERIZE AS REQUIRED.
- 13. PROVIDE (3) COPIES OF INSTRUCTIONS MANUALS FOR OPERATION AND MAINTENANCE OF SYSTEM AND CONTROLS, SEASONAL ACTIVITY AND SHUTDOWN AND MANUFACTURER'S PARTS CATALOGUE.
- 14. INSTRUCT OWNER'S PERSONNEL IN THE OPERATION AND MAINTENANCE OF SYSTEM, INCLUDING ADJUSTING OF SPRINKLER HEADS. USE OPERATION AND MAINTENANCE MATERIAL AS BASIS FOR DEMONSTRATION.
- 15. IRRIGATION PIPE SIZE TO BE 2" WITH 50 USGPM AND 55PSI.



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 ISSUED FOR BP
 18-06-26

 2
 ISSUED FOR TUP
 18-06-11

 1
 ISSUED FOR REVIEW
 18-05-11

 REVISIONS

PARKER PRE-SALES C

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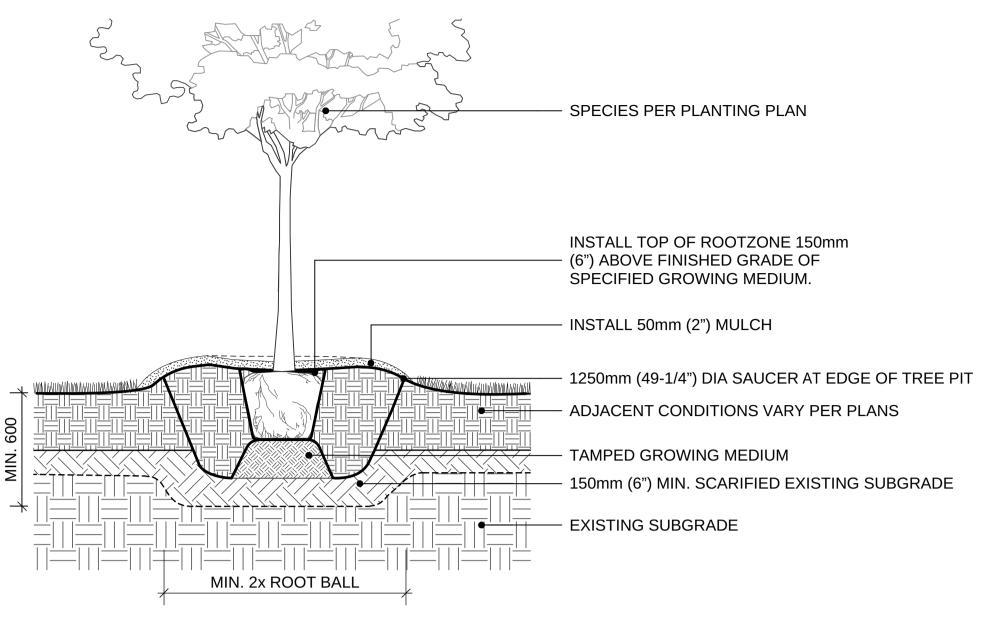
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IRRIGATION

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0 10 15 20 m



SPECIES PER PLANTING PLAN

INSTALL 50mm (2") MULCH

1250mm (49-1/4") DIA SAUCER AT EDGE OF TREE PI'

ADJACENT CONDITIONS VARY PER PLANS

INSTALL TOP OF ROOTZONE 150mm (6")

ABOVE FINISHED GRADE OF SPECIFIED

GROWING MEDIUM.

TAMPED GROWING MEDIUM

150mm (6") MIN. SCARIFIED EXISTING SUBGRADE

EXISTING SUBGRADE

MIN. 2x ROOT BALL

CONIFEROUS TREE PLANTING ON GRADE (TYPICAL)


Scale: 1:20

MAX SLOPE


1 DECIDUOUS TREE PLANTING ON GRADE (TYPICAL)

- DISTANCE FROM EDGE IS HALF THE SPECIFIED O.C. SPACING ROW OPTIONAL: BULB PLANTING AT CENTRE OF PLANT "TRIANGLE" EQUIDISTANT FROM EACH PLANT O.C. PLANT CENTRE TRIANGULAR SPACING AT SPECIFIED - O.C. DISTANCE -SEE PLANT SCHEDULE - SPECIES PER PLANTING PLAN INSTALL MULCH TO 50mm (2") DEPTH INSTALL SPECIFIED GROWING MEDIUM - TO MINIMUM 450mm (18") DEPTH BULB PLANTING AT CENTRE OF PLANT "TRIANGLE" EQUIDISTANT FROM EACH PLANT O.C. - 150mm (6") MIN. SCARIFIED EXISTING SUBGRADE EXISTING SUBGRADE

3 Scale: 1:25 Scale: 1:25

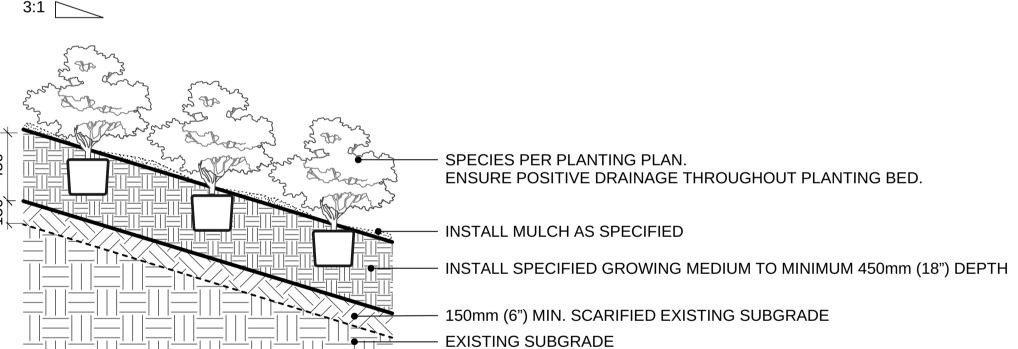

4 PLANTING ON SLOPE (TYPICAL)
Scale: 1:25

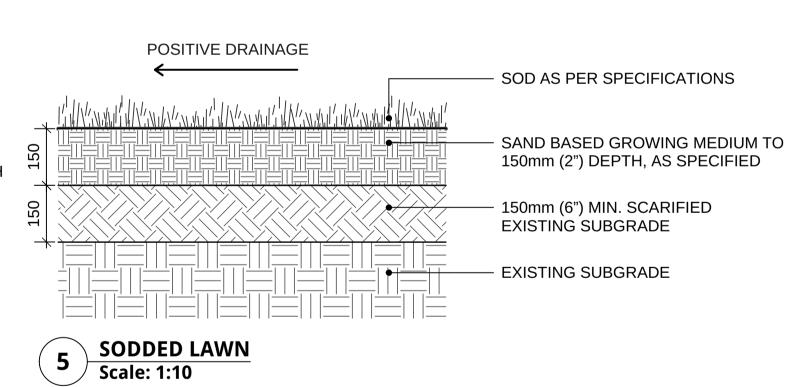

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RESPONSIBLE FOR NOTIFYING THE
APPROPRIATE COMPANY, DEPARTMENT OR
PERSON(S) OF ITS INTENTION TO CARRY OUT ITS
OPERATIONS.

7 RE-ISSUED FOR TUP 18-11-23
6 RE-ISSUED FOR TUP 18-09-17
5 ISSUED FOR TENDER 18-08-31
4 ISSUED FOR DRAFT IFT REVIEW 18-08-03
3 ISSUED FOR BP 18-06-26
2 ISSUED FOR TUP 18-06-11
1 ISSUED FOR REVIEW 18-05-11
REVISIONS

PARKER PRESENTATI CENTRE

10593 - 139 ST. Surrey, British Colum

Scale: Drawn:

Reviewed:
Project No.


SOFTSCAPE


9-00(J)

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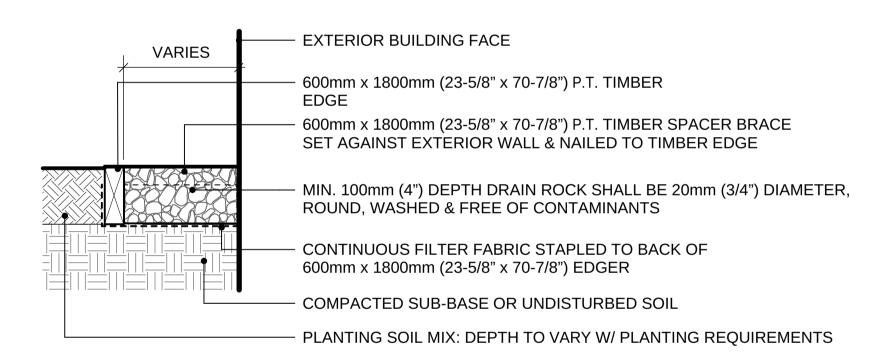
UNIT PAVING CLASSIC STANDARD SERIES
SIZE: 3:1 225mm x 75mm x 60mm (8-7/8" X 3" X 2-3/8")
BY: ABBOTSFORD CONCRETE PRODUCTS
(1.800.663.4091)





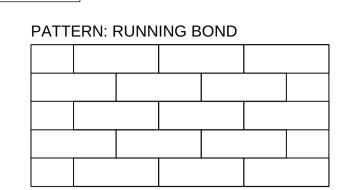

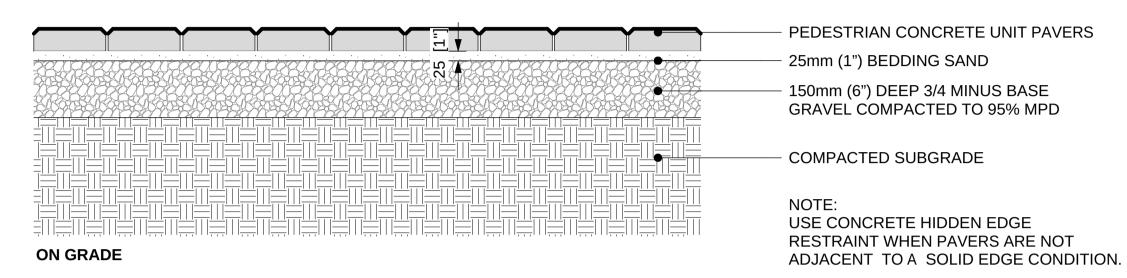



NOTE: ALL LUMBER SIZES ARE SHOWN AS NOMINAL





TEXADA HYDRAPRESSED SLABS
SIZE: STANDARD SIZE 24"X24" (610MM X 610MM X 50MM)
COLOUR: NATURAL
PATTERN: GRID
SUPPLIED BY ABBOTSFORD CONCRETE PRODUCTS

COLOR: NATURAL

1.800.663.4091



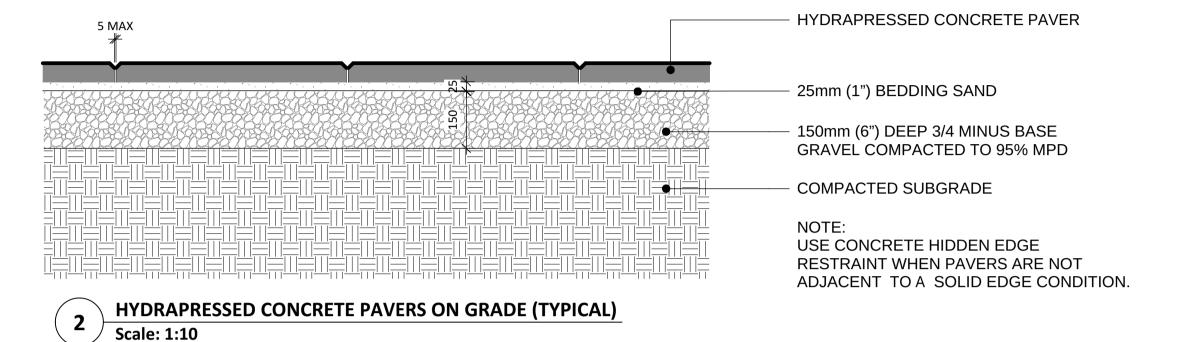

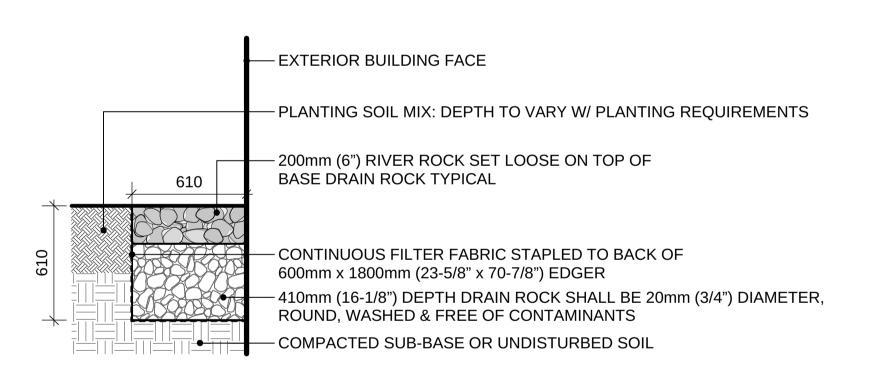





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PARKER PRESENTATIO CENTRE

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Scale:
Drawn:
Reviewed:

Project No.

HARDSCAPE [

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