

# City of Surrey PLANNING & DEVELOPMENT REPORT File: 7918-0072-00

Planning Report Date: July 9, 2018

### **PROPOSAL:**

- **OCP Amendment** from Urban to Multiple Residential and to allow higher floor area ratio (FAR) in the Multiple Residential designation
- NCP Amendment, of a portion, from 22-45 u.p.a (High Density) to 30-70 u.pa. (High Density)
- **Rezoning** from RA to CD (based on RM-70)
- Development Permit


To permit the development of two, 5 storey apartment buildings.

**LOCATION:** 6529 - 196 Street

ZONING: RA
OCP DESIGNATION: Urban

NCP DESIGNATION: 22-45 u.p.a (High Density)/Public

Open Space/Park

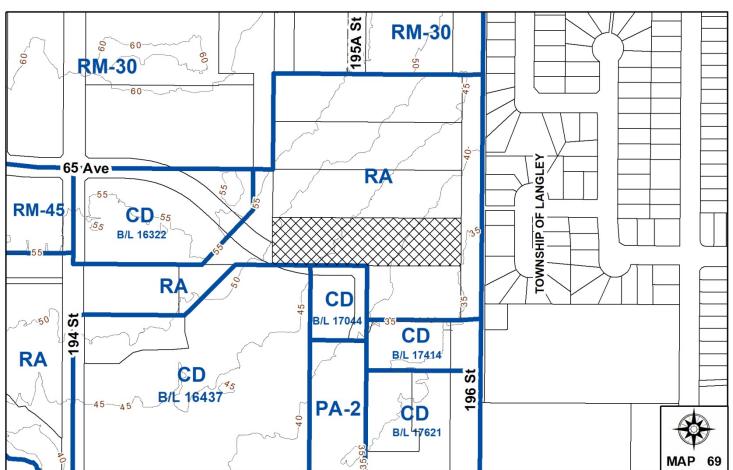

### **RECOMMENDATION SUMMARY**

- By-law Introduction and set date for Public Hearing for:
  - OCP Amendment;
  - OCP Text Amendment; and
  - Rezoning
- Approval to draft Development Permit.

### DEVIATION FROM PLANS, POLICIES OR REGULATIONS

- The Urban designation in the Official Community Plan (OCP) is proposed to be amended to Multiple Residential which is required as part of the implementation process outlined in the East Clayton Neighbourhood Concept Plan (NCP).
- An OCP Text Amendment is proposed to allow an increase to the maximum floor area ratio (FAR) of 1.5 under the Multiple Residential designation.
- The East Clayton Neighbourhood Concept Plan (NCP) is proposed to be amended from 22-45 u.p.a to 30-70 u.p.a (High Density) in order to allow for a 5- storey apartment form with smaller units.

### **RATIONALE OF RECOMMENDATION**

- The proposed OCP Amendment from Urban to Multiple Residential was anticipated to accommodate the density and built form envisioned in the East Clayton NCP. The OCP Text Amendment to increase the allowable FAR under the Multiple Residential designation from 1.5 to 2.2 will allow for an increase in building height from 4 to 5 storeys as well as an increase in unit density in order to allow smaller, potentially more affordable, units.
- The proposed NCP Amendment from 22-45 u.p.a to 30-70 u.p.a allows for smaller units and is consistent with the designation of the adjacent developments approved to the south. The proposal supports the objectives of the East Clayton NCP to develop a compact, diverse and walkable community.
- The applicant has volunteered to dedicate 599 square metres (6,448 sq. ft.) of land to the City to be used for Parks purposes, as well as a cash contribution of \$50,000 to be put toward park improvements as a community benefit associated with the proposal.
- The applicant has demonstrated community support for the proposal.
- The proposed density and building form are appropriate for this part of East Clayton and in context with the existing developments to the south as well as the land use designations of the undeveloped properties to the north which allow for buildings of up to 4 storeys.
- Significant sustainable design features are proposed as part of the proposed development.

### **RECOMMENDATION**

The Planning & Development Department recommends that:

- 1. A Bylaw be introduced to amend the Official Community Plan by redesignating the subject site in Development Application No. 7918-0072-00 from Urban to Multiple Residential and increasing the allowable floor area ratio within the Multiple Residential designation for the subject site from 1.5 to 2.2, and a date be set for Public Hearing.
- 2. Council determine the opportunities for consultation with persons, organizations and authorities that are considered to be affected by the proposed amendment to the Official Community Plan, as described in the Report, to be appropriate to meet the requirement of Section 475 of the Local Government Act.
- 3. A Bylaw be introduced to rezone the subject site from "One Acre Residential Zone (RA)" to "Comprehensive Zone (CD)" and a date be set for Public Hearing.
- 4. Council authorize staff to draft Development Permit No. 7918-0072-00 generally in accordance with the attached drawings (Appendix III).
- 5. Council instruct staff to resolve the following issues prior to final adoption:
  - (a) ensure that all engineering requirements and issues including restrictive covenants, dedications, and rights-of-way where necessary, are addressed to the satisfaction of the General Manager, Engineering;
  - (b) submission of a subdivision layout to the satisfaction of the Approving Officer;
  - (c) submission of a finalized tree survey and a statement regarding tree preservation to the satisfaction of the City Landscape Architect;
  - (d) submission of a finalized landscaping plan and landscaping cost estimate to the specifications and satisfaction of the Planning and Development Department;
  - (e) resolution of all urban design issues, including the Advisory Design Panel (ADP) comments, to the satisfaction of the Planning and Development Department;
  - (f) submission of an acoustical report and registration of a Section 219 Restrictive Covenant to ensure the implementation of noise mitigation measures;
  - (g) registration of a Section 219 Restrictive Covenant to adequately address the City's needs with respect to public art, to the satisfaction of the General Manager Parks, Recreation and Culture;
  - (h) registration of a Section 219 Restrictive Covenant to ensure the proposed energy efficiency design and construction proposed is implemented;
  - (i) conveyance of proposed Lot 3, to the City, for Parks purposes; and
  - (j) provision of a community benefit in support of the proposed OCP Text Amendment.

6. Council pass a resolution to amend the East Clayton NCP to redesignate the land from 22-45 u.p.a (High Density) to 30 to 70 u.p.a (High Density) when the project is considered for final adoption.

### **REFERRALS**

Engineering: The Engineering Department has no objection to the project,

subject to the completion of Engineering servicing requirements, as

outlined in Appendix II.

School District: **Projected number of students from this development:** 

8 Elementary students at Latimer Road Elementary School 8 Secondary students at Clayton Heights Secondary School

(Appendix IV)

The applicant has advised that the dwelling units in this project are

expected to be constructed and ready for occupancy by 2021.

Parks, Recreation &

Culture:

Parks supports the conveyance of land and monetary contribution

to the future Park improvements as the voluntary contribution for

the proposed OCP Text Amendment.

Surrey Fire Department: No concerns. Final approval required for Development Permit.

### **SITE CHARACTERISTICS**

<u>Existing Land Use:</u> Undeveloped acreage property.

### Adjacent Area:

Direction	<b>Existing Use</b>	NCP Designation	<b>Existing Zone</b>
North:	Single detached	22-45 u.p.a (High	RA
	house on large lot	Density)	
East (Across 196 Street):	Township of	NA	NA
	Langley, single		
	detached houses		
South (Across 65 Avenue):	4 storey apartment	30-70 u.p.a (High	RA/CD
	building and a	Density) and 22 to	
	single detached	45 u.p.a (High	
	house	Density).	
West:	Park and	Park/15-25 u.p.a	RA/RM-30
	Townhouses	Medium-High	
		Density	

### **DEVELOPMENT CONSIDERATIONS**

### Site Context:

- The subject site is located at 6529 196 Street on the edge of East Clayton and is adjacent to the Township of Langley to the east.
- The subject site is approximately 0.894 hectares (2.211 acres) in area and is zoned "One-Acre Residential Zone (RA)". The property is designated Urban in the Official Community Plan (OCP) and designated 22-45 u.p.a (High Density) and Public Open Space/Park in the East Clayton Neighbourhood Concept Plan (NCP).

### **Current Proposal**

- The subject development application proposes two (2), 5-storey apartment buildings on two (2) proposed lots. An additional lot (proposed Lot 3) is proposed to be conveyed to the City for a public Park.
- The proposal requires the following:
  - o Official Community Plan (OCP) Amendment from Urban to Multiple Residential;
  - o OCP Text Amendment to allow a higher density in the Multiple Residential designation;
  - o Neighbourhood Concept Plan (NCP) Amendment from 22-45 u.p.a (High Density) to 30 to 70 u.p.a (High Density);
  - o Rezoning from One Acre Residential Zone (RA) to CD (based on RM-70);
  - o Subdivision to create a total of three (3) lots; and
  - o Development Permit.
- An OCP Amendment from Urban to Multiple Residential is required in order to implement the land use, density, and built form anticipated in the East Clayton NCP.
- An OCP Text Amendment is also proposed to increase the maximum allowable floor area ratio (FAR) under the Multiple Residential designation for the subject site from 1.5 FAR to 2.2 FAR calculated on the net site area. The proposed FAR, based on the gross density, including the land to be dedicated to the City for Park use, is 1.3 FAR which is below the maximum 1.5 FAR. However, because the subject site is outside an Urban Centre or Frequent Transit Development Area, density is calculated on the net site area.
- The applicant proposes to subdivide the subject property into three (3) lots. Proposed Lot 1 and Lot 2 are proposed to be the building lots. Proposed Lot 3 will be conveyed to the City to be used for a public Park.
- Two (2) 5-storey residential apartment buildings are proposed. Building 1, on proposed Lot 1, is west of 195A Street. Building 2, on proposed Lot 2, is on the east portion of the property and adjacent to 196 Street.
- The proposed floor area of Building 1 is 5,069 sq. metres (54,562 sq. ft.) and Building 2 is 5,624 sq. metres (60,542 sq. ft.) for a total combined floor area of 10,693 sq. m (115,104 sq. ft.).

The floor area ratio (FAR) of Building 1, on Lot 1, is 2.21 and the FAR of Building 2, on Lot 2, is 2.01.

- There are 69 units proposed in Building 1 and 78 units in Building 2 for a total of 147 residential units. The majority of the units are one (1) bedroom units, with a total of 98 one (1) bedroom units and 46 two (2) bedroom units. There are three (3) studio units proposed. The proposed unit density is 67 units per acre (165 u.p.h.) based on the gross site area.
- Details regarding the permitted densities and use will be discussed under the CD By-law section below.

### **PRE-NOTIFICATION**

Pre-notification letters were sent on May 28, 2018. Staff received six (6) e-mails from nearby property owners in response to the pre-notification letters. The property owners expressed the following comments/concerns (with staff comments in italics):

 The Cloverdale Community Association provided a letter confirming that they have no concerns related to the proposal and are supportive of the sustainable design features of the project.

(Staff has received comments from the Cloverdale Community Association and are requiring the registration of a Section 219 Restrictive Covenant to ensure the implementation of the proposed energy efficiency measures).

• A resident of 6480 – 195A Street has requested that, during the construction of the project, residents in the building will require vehicular access to 65<sup>th</sup> Avenue to exit.

(Since the road works will be completed prior to the start of construction of the buildings on site, the local area residents will have the option to use the newly built half road on 65 Avenue eastbound from 195A Street to connect with 196 Street. Furthermore, during the construction of the development, the residents in the complex at 6480 195A will have access to the existing 65<sup>th</sup> Ave west bound, 195A Street onwards. The Engineering Consultant doesn't foresee any major or significant traffic obstruction during the construction of the above mentioned road works and the developer will work with the Engineering Consultant and city staff to minimize any temporary inconvenience to the residents of the area).

• The proposed development was referred to the Township of Langley (TOL) for comments. The TOL noted the two storey form of residential development along 196 Street within Langley and suggested that the proposed development be responsive to this scale. They requested that the notice of public hearing be forwarded to adjacent residents.

(The East Clayton NCP was approved in 2003 and designated the lands along 196 Street 22-45 u.p.a (High Density) which allows for a building of up to four storeys. The proposed development is generally reflective of this with the addition of a recessed fifth floor. There is a significant building setback of 11.6 metres (38 ft.) along 196 Street, which consists of a landscaped berm. The proposed interface is considered appropriate and reflective of the

approved NCP. Residents within the Township of Langley, who are also within 100 metres (328 ft.) notification area, will receive notice of the Public Hearing).

• Two letters were received from nearby property owners, who supported the new development, building design and the associated construction of 64<sup>th</sup> Avenue.

(Staff note the comments provided.)

• Two letters of opposition were received from nearby property owners, who expressed concerns related to the height of the building, the loss of green space, privacy, parking and schools.

(The subject site is designated 22-45 u.p.a (High Density) which allows for an apartment building of up to four (4) storeys. A portion of the property is designated Public Open Space/Park. This portion of the site is proposed to be dedicated to the City as a voluntary community benefits contribution associated with the project. The five (5) storey height does exceed the maximum four (4) storeys suggested in the NCP, however, the building has been designed to recess the fifth storey so it is not easily visible from the street. The proposal exceeds the required number of parking stalls by 7. Comments provided by the Surrey School District indicate that a total of 16 students are projected as a result of the proposed development. Although there are existing capacity issues, two (2) new schools are scheduled for opening by 2020 which will alleviate the capacity pressures. The project is not estimated to be completed prior to 2020.)

### PUBLIC CONSULTATION PROCESS FOR OCP AMENDMENT

Pursuant to Section 475 of the <u>Local Government Act</u>, it was determined that it was not necessary to consult with any persons, organizations or authorities with respect to the proposed OCP amendment, other than those contacted as part of the pre-notification process.

### **JUSTIFICATION FOR PLAN AMENDMENT**

- The subject property is currently designated Urban in the Official Community Plan (OCP) and 22-45 upa (High Density) in the East Clayton Neighbourhood Concept Plan (NCP).
- The proposed OCP amendment, to re-designate the subject site to Multiple Residential, complies with the intent of the NCP for the development of multiple residential apartments. In accordance with the East Clayton NCP, the OCP amendment is occurring as part of the rezoning application.
- The OCP Text Amendment is to increase the allowable FAR under the Multiple Residential designation from 1.5 to 2.2 (calculated on the net site area) which will allow for an increase in building height from 4 to 5 storeys as well as an increase in unit density in order to allow smaller, potentially more affordable, units.
- The applicant has volunteered to dedicate 599 square metres (6,448 sq. ft.) of land to the City to be used for Parks purposes, as well as a cash contribution of \$50,000 to be put towards park improvements as a voluntary community benefit associated with the proposal.

• The proposed NCP amendment from 22-45 upa (High Density) to 30-70 upa (High Density) is supportable for the following reasons:

- 1. The East Clayton NCP outlines that unit density is to be calculated on the gross site area.
- 2. Since the approval of the East Clayton NCP in 2003, the housing market has changed significantly in the Metro Vancouver area due to increases in land and housing prices. The proposed NCP amendment is intended to provide smaller and more affordable housing units.
- 3. The overall floor area ratio (FAR) based on the gross density of the site, before Park and road dedications, is less than 1.3.
- 4. The property is significantly affected by road and park dedications about 43% of the site will be dedicated to the City for road and park purposes.
- 5. The overall massing of the buildings is consistent with typical four (4) storey buildings with the 5<sup>th</sup> (fifth) storey recessed.
- 6. The proposed NCP amendment is compatible with the nearby development projects to the south (7909-0193-00 and 7911-0035-00) that received approval to amend the NCP from 22-45 upa (High Density) to 30-70 upa (High Density).
- 7. The proposed development includes 599 square metres (6,448 sq. ft.) of park dedication that contributes to improving livability of the East Clayton area.
- 8. The proposed development incorporates numerous sustainable features that are unique in the East Clayton NCP area.

### Proposed CD Bylaw

- A CD Zone, based on RM-70, is proposed to accommodate the proposed development.
- The density (floor area ratio and units per acre) of the proposed development in the CD
  By-law is calculated based on the net site area. It is noted, however, that the East Clayton NCP
  permits unit density to be calculated on the gross site area.
- The proposed CD Zone is based on the RM-45 Zone using net area of the site and is divided into three blocks (Block A Block B and Block C) to accommodate the proposed two buildings, which are separated by the dedication of 195A Street, and Block C which is the area to be conveyed to the City for Parks purposes:

CD By-law	Block A (West Building)	Block B (East	Block C (Park)
		Building)	
Permitted Uses	Multiple Residential	Multiple Residential	Open Space
FAR	2.22	2.02	N/A
Maximum No. of Units	69 units	78 units	N/A
Max. Lot Coverage	53%	57%	N/A

Maximum Building	<u>16.6 metres</u>	<u>17.1 metres</u>	N/A
Height			
Setbacks	Between 3.om and 6.om	Between 3.om and	N/A
		11.6m	

### CD By-law comparison to RM-45 and RM-70:

Regulations	CD	RM-70	RM-45
Floor Area Ratio (net)	Up to 2.22	1.50	1.30
Unit Density (net)	Up to 122 u.pa	N/A	45 u.p.a
Lot Coverage	Up to 57%	33%	45%
Height	Up to 17.1 m (56 ft.)	50 metres (164 ft.)	15 m (50 ft.)

- The proposed reduced setbacks achieve the following:
  - i. Ensure the preservation of trees on the neighbouring property to the north and adequate separation space between the future development;
  - ii. Creation of a buffer along 196 Street in accordance with the requirements of the East Clayton NCP;
  - iii. Establishment of an appropriate interface between Building 1 and the park/open space to the west; and
  - iv. Provision for better visual monitoring of a pedestrian friendly streetscape.

### Access and Roads

- The applicant is required to dedicate approximately (3,270 sq,m (35,199 sq. ft) of road as part of the project. This involves the dedication and construction of 195A Street and 65 Avenue and dedication along 196 Street.
- Vehicle access to Building 1 will be off of 195A Street to the east and vehicle access to Building 2 will be from 65 Avenue to the south.

### **DESIGN PROPOSAL AND REVIEW**

- A simple, modern architectural vernacular has been applied to the buildings, which creates a suitable backdrop to the contrasting and extensive existing and proposed vegetation surrounding the buildings.
- A colour palette of a white, textured cementitious panel system contrasts with a charcoal grey PVC horizontal siding system as the main building elements.
- This applique will be enhanced with a charcoal grey vinyl window system. These main contrasting textured and colour elements assist in breaking down the building's massing and provides an orderly rhythm to the facades.
- A third, contrasting wood-like material provides framing at key elements around the building such as highlighting corner elements, defining main pedestrian and parkade entry, as well as enhancing the stepped building facades terracing to match the site's natural topography.

• "U" shaped buildings have been developed with large central south-facing courtyards for both sites.

- Both buildings have been designed to terrace up the hill from the low point along 196th to the high point (west end) of the site, following the natural topography of the land.
- The height of the buildings read primarily as four storeys because of the natural grading conditions.
- A recessed 5th storey sits behind the four-storey facade, creating large roof-top decks for the fifth-floor units.
- The "U" shaped massing breaks down the scale of each building significantly when viewed from the main street (65th Ave.)
- Similarly, the end elevations (east and west elevations of each building) have been broken down in scale with symmetrical treatments and a void (representing decks) located in the middle of each facade. In other facades, the opposite solid / void ratio has been adopted.
- Finally, the rear (north) building massing breaks down the building length by creating two blocks with a central void (and setback) element.
- The buildings comply with the BC Building Access Handbook guidelines. They are designed
  for all to have access and move around within the building and the building facilities. All
  access points are level with connecting pathways for seamless movement throughout the
  buildings.

### Sustainable design features:

- The applicant is committing to a LEED certification equivalent rating for the project.
- All lighting in the building will be LED with common areas to be covered by motion sensor lighting for energy efficiency.
- A minimum of 20% of the parking stalls will be roughed in ready for EV chargers.
- Sewage Heat Recovery SHARC Energy Systems are proposed for both buildings, subject to final feasibility and Engineering review by civil consultants and the City.
- A green roof is proposed on each building and will include an outdoor amenity area.
- A section 219 Restrictive Covenant will be registered as a condition of approval to ensure the implementation of the sustainable design features.

### **Landscape and Amenity Areas**

• The landscape plan shows a total of 40 trees to be planted throughout the subject site including Red Maple, Chinese Dogwood and Japanese Snowbell.

- A significant number of shrubs and ground cover species are proposed including boxwood, laurel, cedars, ferns, rhododendrons, roses, azaleas, and decorative grasses.
- The proposed trees and landscaping will enhance the streetscape and create an urban, pedestrian-friendly environment.
- The two (2) proposed outdoor amenity courtyards will provide for green space and usable common areas.
- The landscape plan proposes contrasting surface treatments and raised planters to distinguish between private, public, shared spaces and pathways.
- A rooftop urban agriculture and amenity area are key features of the development for both buildings. Edible planting will form part of the design.
- The required indoor and outdoor amenity areas for Building 1 is 207 square metres (2,228 sq. ft). The indoor amenity area proposed exceeds the required amount at 223 square metres (2,409 sq. ft) and the outdoor amenity area exceeds the required amount at 220 sq. metres (2,376 sq. ft.).
- The required indoor and outdoor amenity areas for Building 2 is 234 square metres (2,519 sq. ft). The indoor amenity area proposed exceeds the required amount at 269 square metres (2,888 sq. ft) and the outdoor amenity area meets the required amount at 234 sq. metres (2,519 sq. ft.).
- Notwithstanding the above, the Advisory Design Panel (ADP) suggested an increase in the area of rooftop outdoor amenity area. The applicant has agreed to increase the amount of outdoor amenity area on the rooftop. This is subject to detailed design.

### **TREES**

 Monica Ardiel, ISA Certified Arborist of Mike Fadum and Associates prepared an Arborist Assessment for the subject property. The table below provides a summary of the tree retention and removal by tree species:

Table 1: Summary of Tree Preservation by Tree Species:

Tree Species	Existing	Remove	Retain	
Alde	Alder and Cottonwood Trees			
Alder/Cottonwood	66	66	0	
<b>Deciduous Trees</b> (excluding Alder and Cottonwood Trees)				
Birch, Paper	1	1	0	
Big Leaf Maple	2	2	0	
Coniferous Trees				
Cedar, Western Red	2	2	0	
Douglas-Fir	10	10	0	
Fir, Grand	2	2	0	

Tree Species	Existing	Remove	Retain
Pine, Austrian	1	1	0
Spruce, Norway	1	1	0
<b>Total</b> (excluding Alder and Cottonwood Trees)	19	19	O
Additional Trees in the proposed Open Space	3	o	3
Total Replacement Trees Proper (excluding Boulevard Street Trees		40	
Total Retained and Replaceme Trees	ent	40	
Contribution to the Green City	Fund	\$25,600	

- The Arborist Assessment states that there are a total of 19 protected trees on the site, excluding Alder and Cottonwood trees. There are 85 existing trees and 66 of the trees on the site are Alder and Cottonwood trees. It was determined that no trees can be retained as part of this development. The proposed tree retention was assessed taking into consideration the location of services, building footprints, road dedication and proposed lot grading.
- Table 1 includes an additional 3 protected trees that are located within the proposed open space to be dedicated to the City. The trees within the proposed open space will be retained. This will be determined at a later time, in consultation with the Parks, Recreation and Culture Department.
- For those trees that cannot be retained, the applicant will be required to plant trees on a 1 to 1 replacement ratio for Alder and Cottonwood trees, and a 2 to 1 replacement ratio for all other trees. This will require a total of 104 replacement trees on the site. Since only 40 replacement trees can be accommodated on the site the deficit of 64 replacement trees will require a cashin-lieu payment of \$25,600, representing \$400 per tree, to the Green City Fund, in accordance with the City's Tree Protection By-law.
- In addition to the replacement trees, boulevard street trees will be planted on 100 Street/Avenue. This will be determined by the Engineering Department during the servicing design review process.
- The new trees on the site will consist of a variety of trees including Red Maple, Chinese Dogwood and Japanese Snowbell.
- In summary, a total of 40 trees are proposed to be retained or replaced on the site with a contribution of \$25,600 to the Green City Fund.

The applicant prepared and submitted a sustainable development checklist for the subject site. The table below summarizes the applicable development features of the proposal based on the seven (7) criteria listed in the Surrey Sustainable Development Checklist.

Sustainability Criteria	Sustainable Development Features Summary
1. Site Context & Location (A1-A2)	The proposed development is within a planned medium/high density area of the East Clayton NCP.
2. Density & Diversity (B1-B7)	<ul> <li>The proposed development will add to a mix of different housing types in the East Clayton area and increase housing affordability for the City of Surrey.</li> <li>Housing units proposed are smaller and more affordable.</li> </ul>
3. Ecology & Stewardship (C1-C4)	<ul> <li>All lighting in the buildings will be LED.</li> <li>All common areas to be covered by motion sensor lighting for energy efficiency.</li> <li>Possible Sewage Heat Recovery SHARC Energy Systems for both buildings.</li> <li>Solar panels for some units.</li> <li>Substantial Green Roof area of around 3,800 sq. ft.</li> <li>Central Courtyard based partially passive design.</li> </ul>
4. Sustainable Transport & Mobility (D1-D2)	<ul> <li>EV Roughed in ready parking stalls for a minimum of 20% of the parking stalls.</li> <li>Possible Car Share / Car pool program for the development.</li> <li>Bicycle storage provided in the project.</li> <li>The project provides significant park and open space to the City as part of the overall greenway system in the East Clayton NCP area.</li> </ul>
5. Accessibility & Safety (E1-E3)	<ul> <li>EV Roughed in ready parking stalls for a minimum of 20% of the parking stalls.</li> <li>The building is accessible from all street entrances and circulation within.</li> <li>Possible Car Share / Car pool program for the development.</li> <li>Bicycle storage provided in the project.</li> <li>The project provides significant park and open space to the City as part of the overall greenway system in the East Clayton NCP area.</li> </ul>
6. Green Certification (F1) 7. Education & Awareness (G1-G4)	<ul> <li>No green certification is proposed.</li> <li>Pre-notification were sent and a development proposal sign was installed.</li> </ul>

The project was reviewed at the Advisory Design Panel (ADP) meeting on June 11, 2018. The DRAFT comments prepared by the panel are attached as Appendix VI. The panel was generally supportive of the project and had no significant comments to be addressed. The comments provided by the panel will form part of the detailed urban design review prior to final issuance of the Development Permit.

The Advisory Design Panel (ADP) suggested an increase in the rooftop outdoor amenity area. The applicant has agreed to increase the amount of rooftop outdoor amenity area.

### <u>INFORMATION ATTACHED TO THIS REPORT</u>

The following information is attached to this Report:

Appendix I. Lot Owners and Action Summary (Confidential) and Project Data Sheets

Appendix II. Engineering Summary

Appendix III. Draft Development Permit Drawings

Appendix IV School District Comments

Appendix V Summary of Tree Survey and Tree Preservation

Appendix VI Advisory Design Panel Comments

Appendix VII NCP Amendment Plan Appendix VIII OCP Redesignation Map Appendix IX Proposed CD By-law

### **INFORMATION AVAILABLE ON FILE**

• Complete Set of Architectural and Landscape Plans prepared by Ankeman Marchand and Durante Kruek Ltd dated July 4, 2018.

Jean Lamontagne General Manager Planning and Development

IM/cm

### <u>Information for City Clerk</u>

Legal Description and Owners of all lots that form part of the application:

1. (a) Agent: Name: Gurrjit Daara

1034786 B.C. Ltd.

Address: 7337 - 137 Street, Unit 306

Surrey, BC V<sub>3</sub>W <sub>1</sub>A<sub>4</sub>

2. Properties involved in the Application

(a) Civic Address: 6529 - 196 Street

(b) Civic Address: 6529 - 196 Street Owner: 1034786 B.C. Ltd.

<u>Director Information:</u>

Gurrjit Daara

Officer Information as at April 27, 2018:

Gurrjit Daara (President)

PID: 001-461-184

The South Half of Lot 15 Section 15 Township 8 New Westminster District Plan 2468

- 3. Summary of Actions for City Clerk's Office
  - (a) Introduce a By-law to amend the Official Community Plan to re-designate the site and the OCP Text Amendment;
  - (b) Introduce a By-law to rezone the site.

## **DEVELOPMENT DATA SHEET**

# **Block A Proposed Zoning: CD**

Required Development Data	Minimum Required / Maximum Allowed	Proposed
LOT AREA* (in square metres)		
Gross Total		8,949 sq. m
Road Widening area		3,268 sq. m
Undevelopable area		599 sq. m
Net Total Overall Site		5,083 sq.m
Net Total Block A		2,289 sq.m
LOT COVERAGE (in % of net lot area)		
Buildings & Structures		53%
Paved & Hard Surfaced Areas		5%
Total Site Coverage		58%
SETBACKS ( in metres)		
Front (South)		4.5m
Rear (North)		6.om
Side (West)		3.om
Side (East)		4.5m
		1.9
BUILDING HEIGHT (in metres/storeys)		
Principal		16.6m/ 5-storeys
Accessory		
NUMBER OF RESIDENTIAL UNITS		
Bachelor		1
One Bed		45
Two Bedroom		23
Total		69
FLOOR AREA: Residential		5,069 sq.m
FLOOR AREA: Commercial		N/A
Retail		· .
Office		
Total		
FLOOR AREA: Industrial		N/A
FLOOR AREA: Institutional		N/A
TOTAL BUILDING FLOOR AREA  * If the development site consists of more th		5,069 sq.m

<sup>\*</sup> If the development site consists of more than one lot, lot dimensions pertain to the entire site.

# Development Data Sheet cont'd

Required Development Data	Minimum Required / Maximum Allowed	Proposed
DENSITY		
# of units/ha /# units/acre (gross)		67 u.p.a
# of units/ha /# units/acre (net)		122 u.p.a
FAR (gross)		1.3
FAR (net)		2.2
AMENITY SPACE (area in square metres)		
Indoor	207 sq.m	224 sq,m
Outdoor	207 sq.m	220 sq.m
PARKING (number of stalls)		
Commercial		
Industrial		
Residential Bachelor + 1 Bedroom		60
2-Bed		35
3-Bed		0
Residential Visitors		14
Institutional		
Total Number of Parking Spaces	109	116
Number of accessible stalls		
Number of small cars		1
Tandem Parking Spaces: Number / % of Total Number of Units		0
Size of Tandem Parking Spaces width/length		

# **DEVELOPMENT DATA SHEET**

## **Block B Proposed Zoning: CD**

Required Development Data	Minimum Required / Maximum Allowed	Proposed
LOT AREA* (in square metres)		
Gross Total		8,949 sq. m
Road Widening area		3,268 sq. m
Undevelopable area		599 sq. m
Net Total Overall Site		5,083 sq.m
Net Total Block B		2,790 sq.m
LOT COVERAGE (in % of net lot area)		
Buildings & Structures		57%
Paved & Hard Surfaced Areas		5%
Total Site Coverage		62%
SETBACKS ( in metres)		
Front (South)		4.5m
Rear (North)		6.om
Side (West)		4.5m
Side (East)		11.62m
BUILDING HEIGHT (in metres/storeys)		
Principal		17.1m/ 5 storeys
Accessory		17.11117 ) 5001035
NUMBER OF RESIDENTIAL UNITS		
Bachelor		2
One Bed		53
Two Bedroom		23
Total		78
FLOOR AREA: Residential		5,625 sq.m
FLOOR AREA: Commercial		N/A
Retail		•
Office		
Total		
FLOOR AREA: Industrial		N/A
FLOOR AREA: Institutional		N/A
22 2 2 2 2 2 2 2 2 2 2 2 2 2 2 2 2 2 2 2		- 1/- 2
TOTAL BUILDING FLOOR AREA		5,625 sq.m

# Development Data Sheet cont'd

Required Development Data	Minimum Required / Maximum Allowed	Proposed
DENSITY		
# of units/ha /# units/acre (gross)		63 u.p.a
# of units/ha /# units/acre (net)		113 u.p.a
FAR (gross)		1.3
FAR (net)		2.0
AMENITY SPACE (area in square metres)		
Indoor	234 sq.m	269 sq,m
Outdoor	234 sq.m	234 sq.m
PARKING (number of stalls)		
Commercial		
Industrial		
Residential Bachelor + 1 Bedroom		72
2-Bed		35
3-Bed		0
Residential Visitors		16
Institutional		
Total Number of Parking Spaces	123	131
Number of accessible stalls		
Number of small cars		1
Tandem Parking Spaces: Number / % of Total Number of Units		0
Size of Tandem Parking Spaces width/length		_

Heritage Site NO Tree Survey/Assessment Pr	ovided YES
--	------------



# INTER-OFFICE MEMO

TO:

Manager, Area Planning & Development-North Surrey Division

Planning and Development Department

FROM:

Development Engineer, Engineering Department

FILE COPY

DATE:

Jun 29, 2018

PROJECT FILE:

7818-0072-00

RE:

Engineering Requirements Location: 6529 196 Street

### NCP AMENDMENT/ OCP AMENDMENT

The existing sanitary sewer downstream infrastructure does not have adequate capacity to service the increase in density for the proposed development. The following upgrades must be completed at the developers' expense as a condition of the NCP Amendment/OCP Amendment:

- 72.1-metres of 450mm sewer to be upgraded to 525mm along 195B Street and 63A Avenue.
- 16.6-metres of 450mm sewer to be upgraded to 525mm along 195B Street and 62A Avenue.
- 138.6-metres of 450mm sewer to be upgraded to 525mm along 196 Street south of Fraser Hwy.

### REZONE/SUBDIVISION

### Property and Right-of-Way Requirements

- dedicate 9.883-metre along 196 Street, for the 30.0-metre arterial road standard.
- dedicate minimum 10.0-metres west of 195A Street and 11.5-metre east of 195 Street, along 65 Avenue.
- dedicate 18.0-metre along 195A Street for the through local road standard.
- dedicate corner cuts at the intersections.
- register 0.5-metre statutory right-of-way along all property lines.

### **Works and Services**

- construct 65 Avenue, and 195A Street.
- pay 50% cash-in-lieu for a traffic circle at the 195A Street and 65 Avenue intersection.
- construct storm mains to provide road drainage and service the development and provide service connections.
- meet sustainable drainage principles as outlined in the East Clayton NCP.
- construct water mains and sanitary sewer mains to service the development and provide service connections.

A Servicing Agreement is required prior to Rezone/Subdivision.

### **DEVELOPMENT PERMIT**

There are no engineering requirements relative to issuance of the Development Permit.

Tommy Buchmann, P.Eng.

Development Engineer

SK<sub>2</sub>

NOTE: Detailed Land Development Engineering Review available on file

ARCHITECTS

# 6529 196 St, Surrey, BC

File no: 7918-0072-00

# Submission to ADP - June 21st 2018

1034786 BC Ltd. 306-7337 137 St Surrey, BC V3W 1A4 Contact: Jit Daara Email: jitdaara@gmail.com Tel: 604.355.2269

1645 West 5th Avenue Vancouver, BC V6J 1N5 Contact: Daniel Martins Email: daniel@amarchitects.com Tel: 604.872.2595 Fax: 604.872.2505

Ankenman Marchand Architects

### Surveyor

Grewal & Associates 204-15299 68th Ave Surrey, BC, V35 2C1 Contact: Name Email: office@GrewalSurveys.com

### Landscape

Durante Kreuk Address 102-1637 West 5th Ave Vancouver, BC V6J 1N5 Email: itavlor@dkl.bc.ca

Aplin & Martin Consultants Ltd. 201-12488 82nd Ave Surrey, BC V3W 3E9 Contact: Derek Hull Email: dhull@aplinmartin.com Tel: 604.597.9058 Fax: 604.597.9061

Mike Fadum & Associates Ltd. 105-8277 129 St Surrey, BC V3W 0A6 Contact: Mike Fadum
Email: mfadum@fadum.ca
Tel: 778.593.0300 Fax: 778.593.0302



SHEET NUMBER	SHEET NAME
A001	COVER PAGE & DRAWING LIST
A003	GENERAL NOTES
A004	DESIGN RATIONAL
A030	CONTEXT
A035	STREET ELEVATIONS
A036	STREET ELEVATIONS
A037	STREET ELEVATIONS
A100	SURVEY
A105	OVERALL SITE PLAN
A106	BUILDING 1/BLOCK A (WEST) SITE PLAN
A107	BUILDING 2/BLOCK B (EAST) SITE PLAN
A110	BUILDING 1/ BLOCK A (WEST) UNDERGROUND LEVEL 3 PLAN

	SHEET NUMBER	SHEET NAME
	A111	BUILDING 1/ BLOCK A (WEST) UNDERGROUND LEVEL 2 PLAN
	A112	BUILDING 1/BLOCK A (WEST) UNDERGROUND LEVEL PLAN
	A115	BUILDING 1/BLOCK A (WEST) SITE PLAN / GROUND FLOOR PLAN
1	A120	BUILDING 1/ BLOCK A (WEST) LEVEL 2 PLAN
1	A125	BUILDING 1/BLOCK A (WEST) LEVEL 3 PLAN
1	A130	BUILDING 1/ BLOCK A (WEST) LEVEL 4 PLAN
1	A135	BUILDING 1/BLOCK A (WEST) LEVEL 5 PLAN
1	A140	BUILDING 1/ BLOCK A (WEST) ROOF PLAN
	A150	BUILDING 2/BLOCK B (EAST) UNDERGROUND LEVEL 3 PLAN

SHEET NUMBER	SHEET NAME
A151	BUILDING 2/BLOCK B (EAST) UNDERGROUND LEVEL 2 PLAN
A152	BUILDING 2/BLOCK B (EAST) UNDERGROUND LEVEL 1 FLOOR PLAN
A155	BUILDING 2/BLOCK B (EAST) SITE PLAN / GROUND FLOOR PLAN
A160	BUILDING 2/BLOCK B (EAST) LEVEL 2 PLAN
A165	BUILDING 2/BLOCK B (EAST) LEVEL 3 PLAN
A170	BUILDING 2/BLOCK B (EAST) LEVEL 4 PLAN
A175	BUILDING 2/BLOCK B (EAST) LEVEL 5 PLAN
A180	BUILDING 2/BLOCK B (EAST) ROOF PLAN

SHEET NUMBER	SHEET NAME
A210	BUILDING 1/BLOCK A (WEST) - ELEVATIONS NORTH 8 SOUTH
A215	BUILDING 1/BLOCK A (WEST) - ELEVATIONS EAST & WEST
A250	BUILDING 2/BLOCK B (EAST) - ELEVATIONS NORTH & SOUTH
A255	BUILDING 2/BLOCK B (EAST) - ELEVATIONS EAST & WEST
A310	BUILDING 1/BLOCK A (WEST) - SECTIONS
A350	BUILDING 2/BLOCK B (EAST) - SECTIONS
A710	BUILDING 1/BLOCK A (WEST) - 3D VIEWS
A750	BUILDING 2/BLOCK B (EAST) - 3D VIEWS
L-1	Landscape- Overall Site Plan
L-2	Landscape- West Building Ground Plan
L-3	Landscape- East Building Ground Plan
L-4	Landscape- West Building Roof Plan
L-5	Landscape- East Building Roof Plan
L-6	West Planting
L-7	East Planting
L-8	Details

West 5th Avenu couver, BC V6J

Project: 1744

Owner 6529 196 St

Drawing: **COVER PAGE & DRAWING** LIST

Project Status REZONING

SUBMISSION		
Date (YYYY-MM-DD)	Description	
2018-04-05 Issued fo	r DP	
2018-06-07 Re-Issue	e for DP	

### REVISION

No.	Date	Description

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Scale:

DWG. NO: A001

**MARCHAND** 

# STATISTICS

Legal Description

Lot 15 Section 15 Township 8 Plan 2468 NWD S 1/2

Civic Address:

6529 196 St, Surrey, BC

Zoning:

Existing: RA (One Acre Residential Zone)

Proposed: CD-

**Existing NCP Designation:** 

22-45 UPA (High Density), East Clayton NCP

Proposed NCP Designation: 30-70 UPA (High Density), East Clayton NCP

**Existing OCP Designation:** 

**Proposed OCP Designation:** 

Multiple Residential

Site Area:

96,326.23 sf / 8,949 m2 / 2.211 ac / 0.895 ha Gross Site Area:

Road/Park Dedications: 41,645.57 sf / 3,869 m2 / 0.956 ac / 0.386 ha

Site Coverage:

30,136.48 / 96,326.23 = **31.3**% Total Site Coverage:

Density:

70 UPA x 2.211 ac = 154.77 = **155 units** With NCP Amendment:

Proposed number of units: 147 units

FAR: Proposed:

54,562 sf + 60,543 sf = 115,105 sf Total Floor Area:

115,105 sf / 96,326.23 sf = 1.1949 or **1.2 FAR** 

**BUILDING 1 WEST** 

Units:

Proposed: 69 units

Floor Area:
Residential + Circulation = 54,562 SF

Building Height:

Maximum height of Building 1 is as follows: 16.52 m (54.23 ft) measured to a maximum height of 62.49 m (205.05 ft) geodetic up from a starting point of 45.97m (150.82 ft) geodetic elevation.

Parking: Required:

Residents 46 x 1 Bed Units x 1.3 Spaces/Unit = 60 spaces 23 x 2 Bed + Units x 1.5 Spaces/Unit = 35 spaces

95 spaces Total= Visitors 69 units x 0.2 spaces = 14 spaces Total 95 Residential + 14 Visitor = 109 spaces

**Bicycles** 69 units x 1.2 spaces = 83 spaces

plus 6 visitor spaces

Not more than 35% of parking spaces shall be small car spaces, clearly marked as "small car only" 1 Parking spaces for Disabled persons parking, clearly marked as per BC Building Code Requirements.

Proposed: Residents 102 Spaces

Total

(72 Regular + 29 Small + 1 Disability) 14 Spaces Visitors

(12 Regular + 1 Small + 1 Disability)

116 Spaces

84 spaces + 8 visitor spaces **Bicycles** 

**Amenity Space:** 

Outdoor: 69 units x 3 m2 = 207 m2 / 2.228 sf Required:

Indoor: 69 units x 3 m2 = 207 m2 / 2,228 sf

Outdoor: 220.7 m2 / 2,376 sf Proposed: Indoor: 223 8 m2 / 2 409 sf

Refuse Space

15 x 360 L Bin (Compost & Recyclables)

1 x 6 Yard Bin (Garbage)

1 x 4 Yard Bin (Garbage)



### **BUILDING 2 EAST**

Units:

Proposed: 78 units

Floor Area:
Residential + Circulation = 60,543 SF

**Building Height:** 

Maximum height of Building 2 is as follows: 17.10 m (56.12 ft) measured to a maximum height of 56.81 m (186.40 ft ) geodetic up from a starting point of 39.71 m (130.28 ft ) geodetic elevation.

Parking: Required:

Residents 55 x 1 Bed Units x 1.3 Spaces/Unit = 72 spaces 23 x 2 Bed + Units x 1.5 Spaces/Unit = 35 spaces

107 spaces Total= Visitors 78 units x 0.2 spaces = 16 spaces Total 107 Residential + 16 Visitor = 123 spaces

Bicycles 78 units x 1.2 spaces = 94 spaces

plus 6 visitor spaces

Not more than 35% of parking spaces shall be small car spaces, clearly marked as "small car only" 1 Parking spaces for Disabled persons parking, clearly marked as per BC Building Code Requirements.

Proposed: Residents 115 Spaces

(98 Regular + 16 Small + 1 Disabled)

16 Spaces Visitors

(7 Regular + 8 Small + 1 Disabled)

Total 131 Spaces

101 spaces + 8 visitor spaces **Bicycles** 

53 23 **78** 

**Amenity Space:** 

Outdoor: 78 units x 3 m2 = 234 m2 / 2.519 sf Indoor: 78 units x 3 m2 = 234 m2 / 2,519 sf

Outdoor: 234.5 m2 / 2,525 sf

Proposed: Indoor: 269 0 m2 / 2 888 sf

Refuse Space

17 x 360 L Bin (Compost & Recyclables)

2 x 6 Yard Bins (Garbage)

### **UNIT MATRIX**

Studio

1 Bed 2+ Bed

Total

Building 1	
Studio	1
1 Bed	45
2+ Bed	23
Total	69
Building 2	

West ouver, BC BC Aven V6J

Project: 1744 Owner

> 6529 196 St Surrey

Drawing:

**GENERAL NOTES** 

Project Status REZONING

5	SUBMISSION
Date (YYYY-MM-DD)	Description
2018-04-05 Issued for	DP
2018-06-07 Re-Issue	for DP
-	

REVISION Description

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Scale:

DWG. NO: A003

### **DESIGN RATIONAL**

### Site Description

This very large (> 2 acre) site is to be bisected by a new N/S road (195 A) which consequently splits the site into two projects (Building's 1 & 2). It is a relatively steep site and fronts onto 65th Avenue on the South side and 196 Street on the East, located in the East Clayton neighbourhood in Surrey. Approximately 40% of the land area is being dedicated to the City of Surrey, leaving relatively small remaining footprints for each of the two building sites.

The Neighbourhood of East Clayton has witnessed significant densification in the last few years with High Density Multifamily Townhouse and Apartment Projects being built.

Such is the case to the north and south of the Site where 4-5 story apartment buildings also exist across 65th Ave. A large ROW/setback has been reserved along 196th for future road widening /pedestrian pathway.

### Underground Parkade Access:

On both the western and eastern sites, due to the step grading, parkade access has been located at each site's lowest point:

- The parkade access for the western site (Building 1) is being proposed at the site's lowest point accessed from the newly created 195A.
- Building 2 does not have the advantage of an undeveloped, benign road at its lowest point from which to access the parkade, as this portion of the site fronts onto 196th, an arterial. Accordingly, this parkade access has been located around the corner, along 65th Avenue, set back from 196th a suitable distance to ensure no conflicts nor stacking conflicts arise. The planning team studied providing the parkade access point for Building 2 at the site's high point along 195A so the parkade access points could be shared, but due to Building 2's steep site topography (approx. 26 feet) from the western part of the site (195A) to the lowest, eastern part of the site (196th), this proved impossible without raising the parkade above grade, resulting in unsightly conditions

### **Building Massing:**

As both sites are similar in size and topography, a similar massing approach has been implemented for both sites:

"U" shaped buildings have been developed with large central south-facing courtyards for both sites.

- Both buildings have been designed to terrace up the hill from the low point along 196th to the high point (west end) of the site, following the natural topography of the land.
- The height of the buildings are read primarily as four stories and a datum line has been established for each.
- A subordinate 5th story sits behind the four-story facade, creating large roof-top decks for the fifth-floor units.

  The "U" shaped massing being proposed breaks down the scale of each building significantly when read from the main street (65th Ave.)
- Similarly, the end elevations (east and west elevations of each building) have been broken down in scale with symmetrical treatments and a void (representing decks) located in the middle of each facade. In other facades, the opposite solid / void ratio has been adopted. Finally, the rear (north) building's massing has also been broken down by creating two blocks with a central void (and setback) element that assists in each building reading as two.

**Landscaping:**Please refer to the Landscape Design Rationale on Drawing L1 of 5.

The "U" shaped buildings, by their shape, create tremendous livability opportunities as this building typology creates an inordinate number of corner units relative to more conventional building forms. Corner units are desirable not just because they create natural, cross-thru ventilation opportunities, but they also provide ample natural light to a larger number of units. Accessibility is an important objective to create a diverse community with direct connections from several units to the adjacent sidewalks. This creates more eyes on the street and the surrounding neighbourhood

Other livability features within each building include:

- Ample exterior and interior amenity space.
- Windows in each elevator, allowing natural surveillance onto the courtyards as well as allowing natural light into the elevators. The glass elevators also provide a level of interest from both the streetscape as well as in the courtyard when they are in use.
- Both buildings also offer natural light into the main corridors at the elevator lobbies.
- This project proposes a very wide variety of unit typologies and sizes catering to the same variety of socio-economic opportunities for future residents A host of further livability features can also be found below under the heading "Sustainability Features".

### Courtyards:

- Each central courtyard's primary use is to define the pedestrian entry for each building while sharing the space with a outdoor amenity patios, lawns and the like.
- At the end of the entry axis are the building's main elevators, making the pedestrian approach simple and distinctive.

  A waterfall feature has been located at the center of the courtyard which further celebrates entry, while creating "white noise" to drown the sound of existing and future traffic along 65th Ave.
- Courtyards are activated by the moving glass elevators located at the end of each axis.

Sustainability Features: Sustainability features in this project include

- 1. LEED Certification The project commits LEED Certification.
- 2. LED Lighting All lighting in the building will be LED and common areas to be covered by motion sensor lighting for energy efficiency.
- 3. EV Roughed In Ready Parking Stalls A minimum of 20% of the parking stalls roughed in ready for EV chargers, however, this is contingent on our appointed Electrical Consultant
- 4. Sewage Heat Recovery SHARC Energy Systems for both buildings Subject to final feasibility and Engineering review by our Civil consultants regarding the depth of the City Sewage Service connections etc.
- 5. Green Roof Substantial Green Roof area
- 6. Car Share / Carpool We are in dialogue with MODO to bring their services to that area and also looking at other options subject to feasibility.
- 7. Central Courtyard based partially passive design
- 8. Substantial Natural Landscaping, Community Outdoor Amenity, and Parkland Dedications.
- 9. Bicycles Secured all-weather bicycle parking and storage lockers provided inside the project

The buildings comply with the BC Building Access Handbook guidelines so that they are designed for all to have access and move around within the building and the building facilities.

All access points are level with connecting pathways for seamless movement throughout the buildings.

A simple, modern architectural vernacular has been applied to the buildings, which creates a suitable backdrop to the contrasting and extensive surrounding existing and proposed vegetation surrounding the buildings. A very simple colour palette of a white, textured cementitious panel system contrasts with a charcoal grey PVC horizontal siding system as the main building elements.

This applique will be enhanced with a charcoal grey vinyl window system. These main contrasting textured and colour elements assist in breaking down the building's massing and provides an orderly rhythm to the facades A third, contrasting wood-like material provides framing at key elements around the building providing a variety of celebrations such as highlighting corner elements, defining main pedestrian and parkade entry,

as well as enhancing the stepped building facades terracing to match the site's natural topography

### Summarv:

In summary, this project will provide its future residents with all the tools necessary to create a new and complete community, while offering a complete list of all relevant and current sustainability features.

It is a project that will set an extremely good, high quality precedent for this area in transition.

West BC Sth Aven V6J

**MARCHAND** 

Te

Project: 1744

Owner

6529 196 St

Surrev

Drawing: **DESIGN RATIONAL** 

Project Status

### REZONING

SUBMISSION

Date (YYYY-MM-DD)	Description	
2018-06-07 Re-Issue	for DP	

REVISION


No.	Date	Description

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Scale:

DWG. NO:

A004

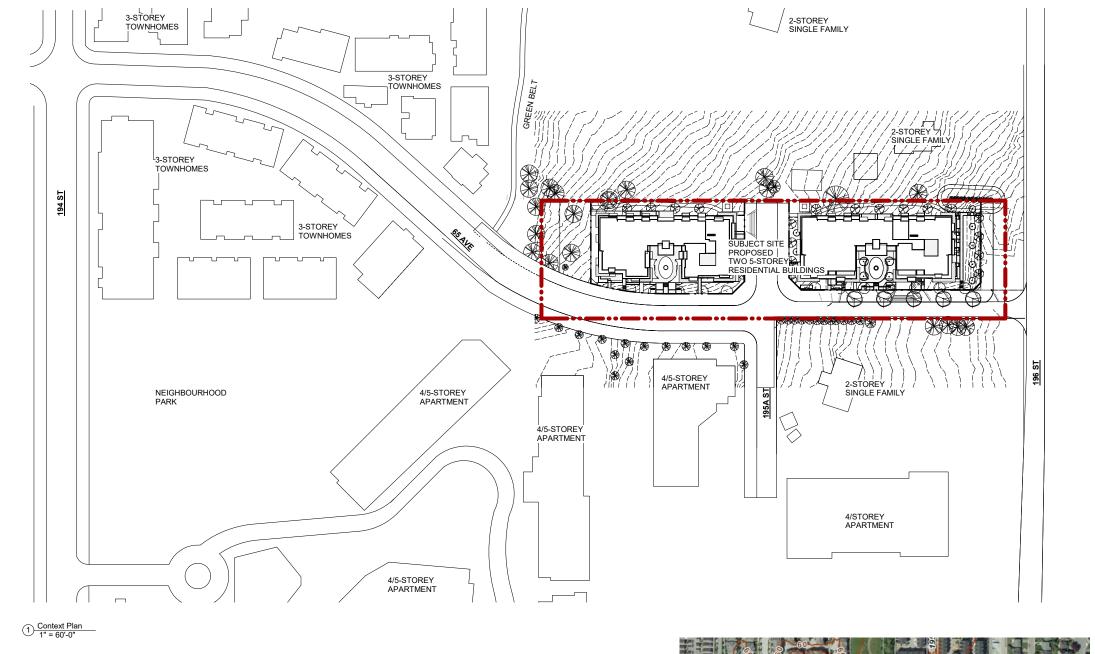

CONTEXT KEY PLAN

ARCHITECTS

1645 West 5th Avenue Vancouver, BC V6J 1N5 ANKENMAN MARCHAND

il: office@AMArchitects.com

Project:

Owner

**6529 196 St** Surrey

Drawing: CONTEXT

Project Status: REZONING

011011100

D-4-	Description
Date (YYYY-MM-DD)	Description
2018-04-05 Issued for	DP
2018-06-07 Re-Issue	for DP

REVISION

No. Date Description

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Scale: As indicated

DWG. NO:
A030

Project:

Scale: DWG. NO: 3/64" = 1'-0"

A034



### CONTEXT PHOTOS































65 AVE EXISTING STREETSCAPE - FACING SOUTH

1645 West 5th Avenue Vancouver, BC V6J 1N5

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Scale: DWG. NO: 3/64" = 1'-0"

A035

2 195A STREET ELEVATION 3/64" = 1'-0"

### CONTEXT PHOTOS









195A ST EXISTING STREETSCAPE - FACING WEST

1645 West 5th Avenue Vancouver, BC V6J 1N5

Scale: DWG. NO: 3/64" = 1'-0"

A036



2 195A ST ELEVATION FACING EAST 3/64" = 1'-0"

### CONTEXT PHOTOS









195A ST EXISTING STREETSCAPE - FACING EAST

# BUILDING 2/BLOCK B (EAST) 4/5 -STOREY APARTMENT SINGLE-FAMILY RESIDENCE SINGLE-FAMILY RESIDENCE

196 STREET ELEVATION
3/64" = 1'-0"

### CONTEXT PHOTOS









196 ST EXISTING STREETSCAPE

1645 West 5th Avenue Vancouver, BC V6J 1N5

Tel: (604) 872-2595Fax: (604) 872-2505 Email: office@AMArchitects.com

Project:

Owner

6529 196 St

Surrey

Drawing:

STREET ELEVATIONS

Project Status: **REZONING** 

SUBMISSION		
Date (YYYY-MM-DD)	Description	
2018-06-07 Re-Issue	for DP	

### REVISION


lo.	Date	Description


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Scale: DWG. NO: 3/64" = 1'-0"

A037



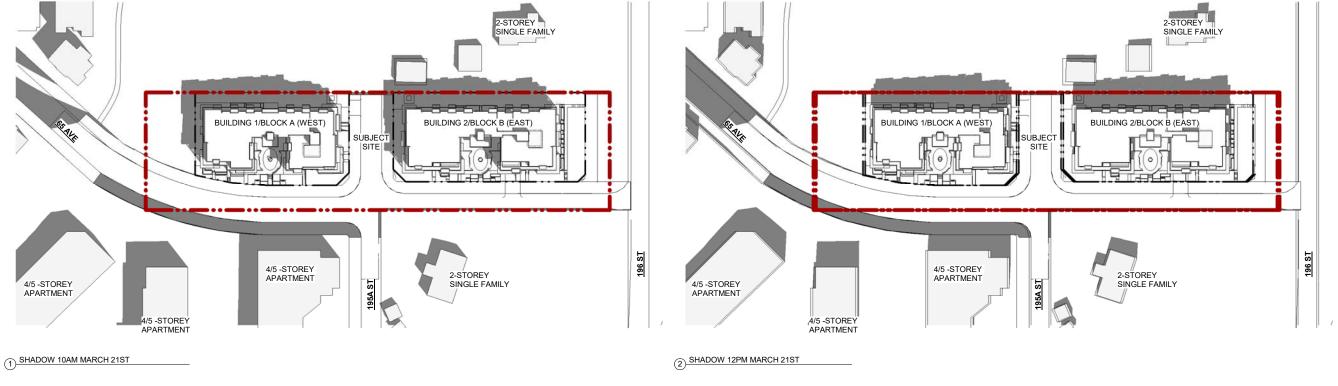

3 SHADOW 2PM MARCH 21ST

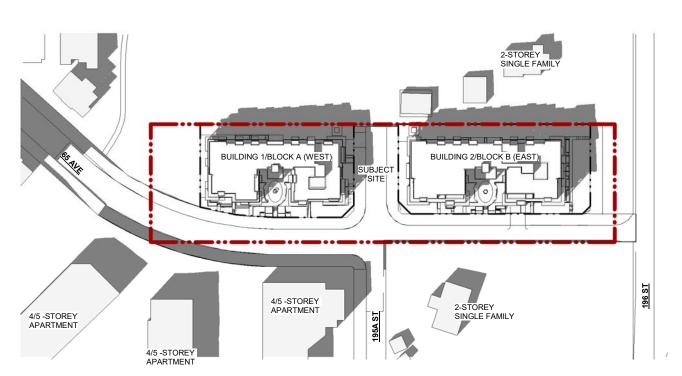ANKENMAN MARCHAND

ARCHITECTS

Project: 1744

5 West 5th Avenu couver, BC V6J

Tel: Email:

l: (604) 872-2595Fax: (604) 872-2505 il: office@AMArchitects.com

Owner

6529 196 St Surrey

Drawing:

SHADOW ANALYSIS MARCH

Project Status: **REZONING** 

SUBMISSION Description Date

REVISION

No. Date Description


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1" = 60'-0"


DWG. NO:

A040



2-STOREY SINGLE FAMILY BUILDING 1/BLOCK A (WEST) BUILDING 2/BLOCK B (EAST) SUBJECT 4/5 -STOREY APARTMENT 2-STOREY 195A ST SINGLE FAMILY

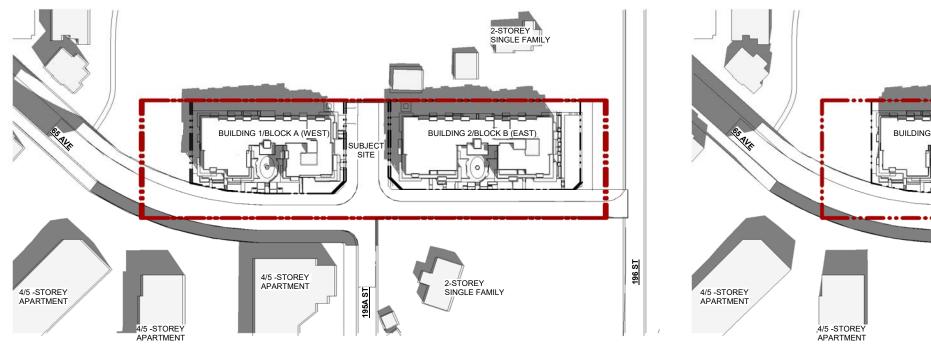2 SHADOW 12PM SEPTEMBER 21ST

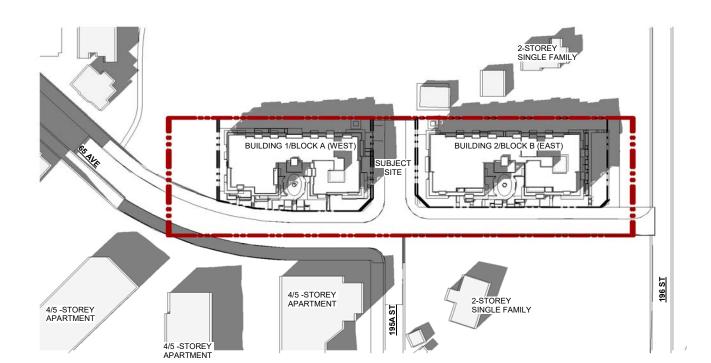

(3) SHADOW 2PM SEPTEMBER 21ST

1 SHADOW 10AM SEPTEMBER 21ST



SHADOW ANALYSIS SEPTEMBER Project Status: **REZONING** SUBMISSION Description Date REVISION No. Date All Drawings in this set to be read in conjunction with each other. Any errors or discrepancies to be reported to the Architect before commencing work.
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Description

DWG. NO:

A041

ARCHITECTS


1645 West 5th Avenu Vancouver, BC V6J 1N5

Tel: Email:

l: (604) 872-2595Fax: (604) 872-2505 il: office@AMArchitects.com

Project: 1744 Owner 6529 196 St Surrey Drawing:

ANKENMAN MARCHAND

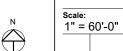



ARCHITECTS

Tel: (604) 872-2595Fax: (604) 872-2505 872-2505 Email: office@AMArchitects.com

Project: 1744 Owner

6529 196 St Surrey

Drawing: **OVERALL SITE PLAN** 

Project Status: **REZONING** 

SUBMISSION	
Date (YYYY-MM-DD)	Description
2018-04-05 Issued for I	DP
2018-06-07 Re-Issue f	or DP
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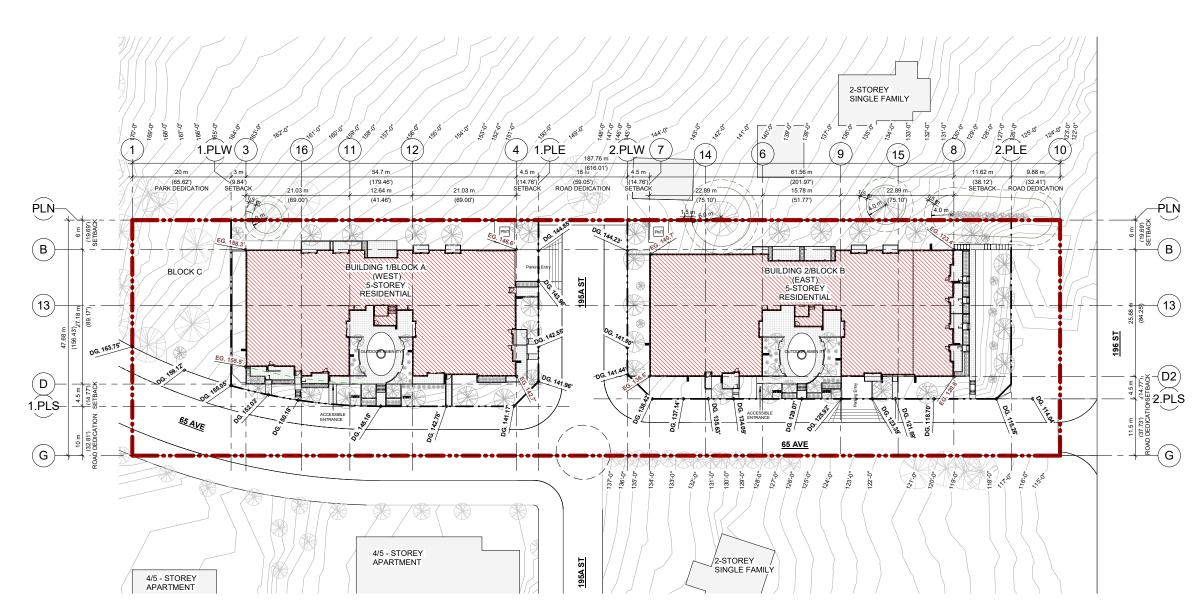
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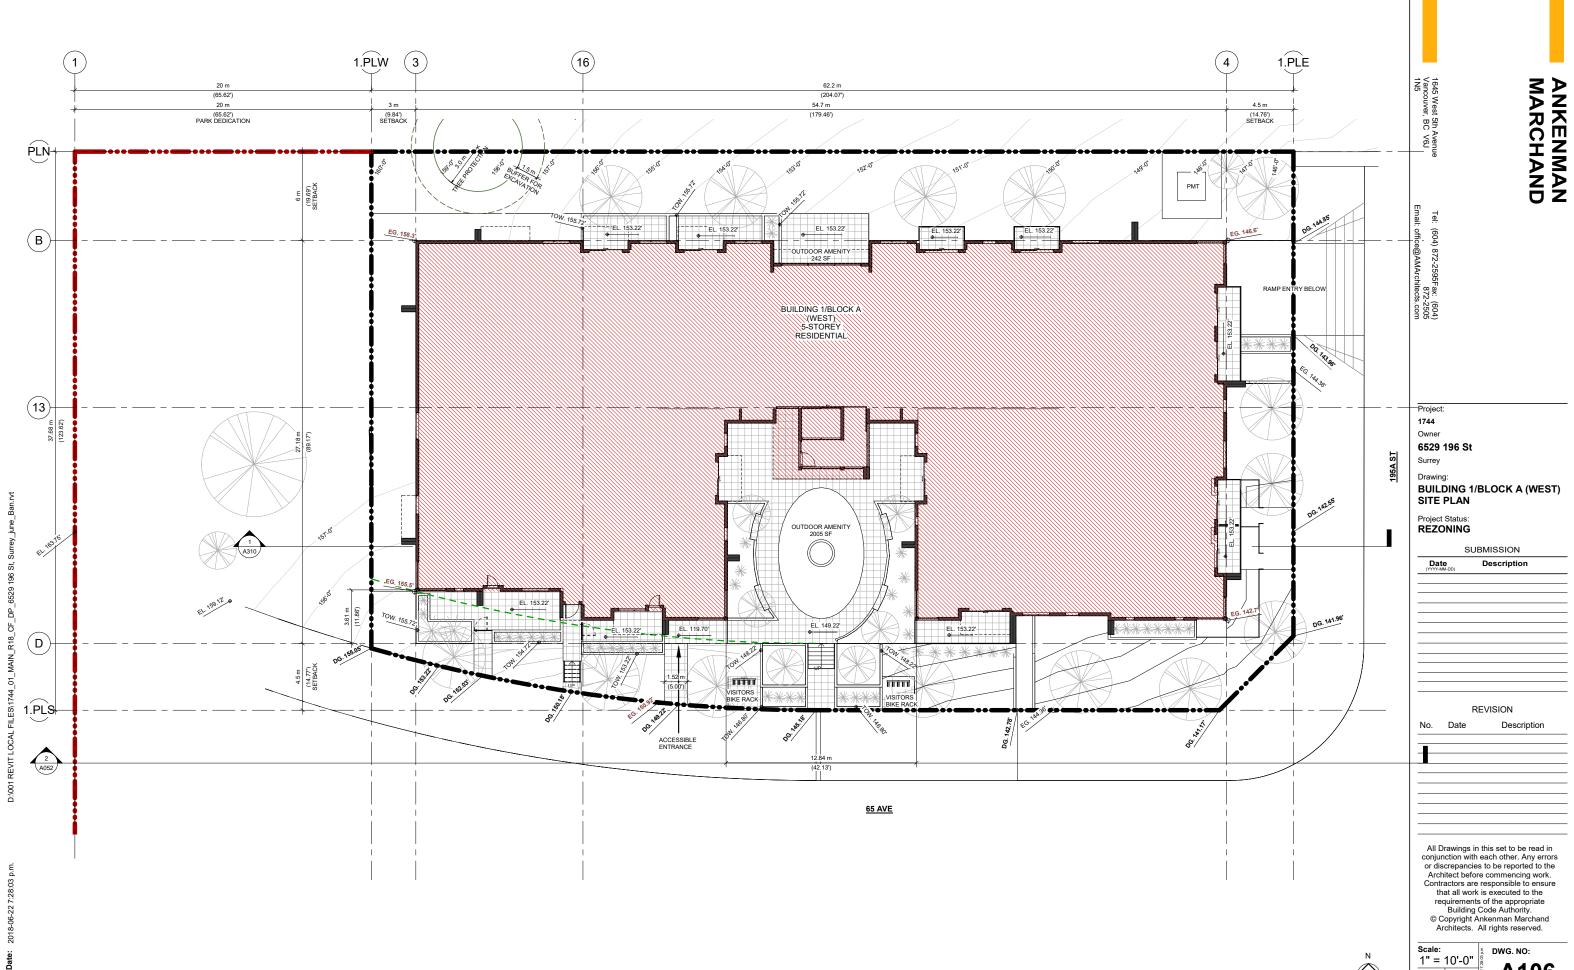
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DWG. NO: A105




See also A106 and A107 for more detailed Site Plans



A106

ARCHITECTS

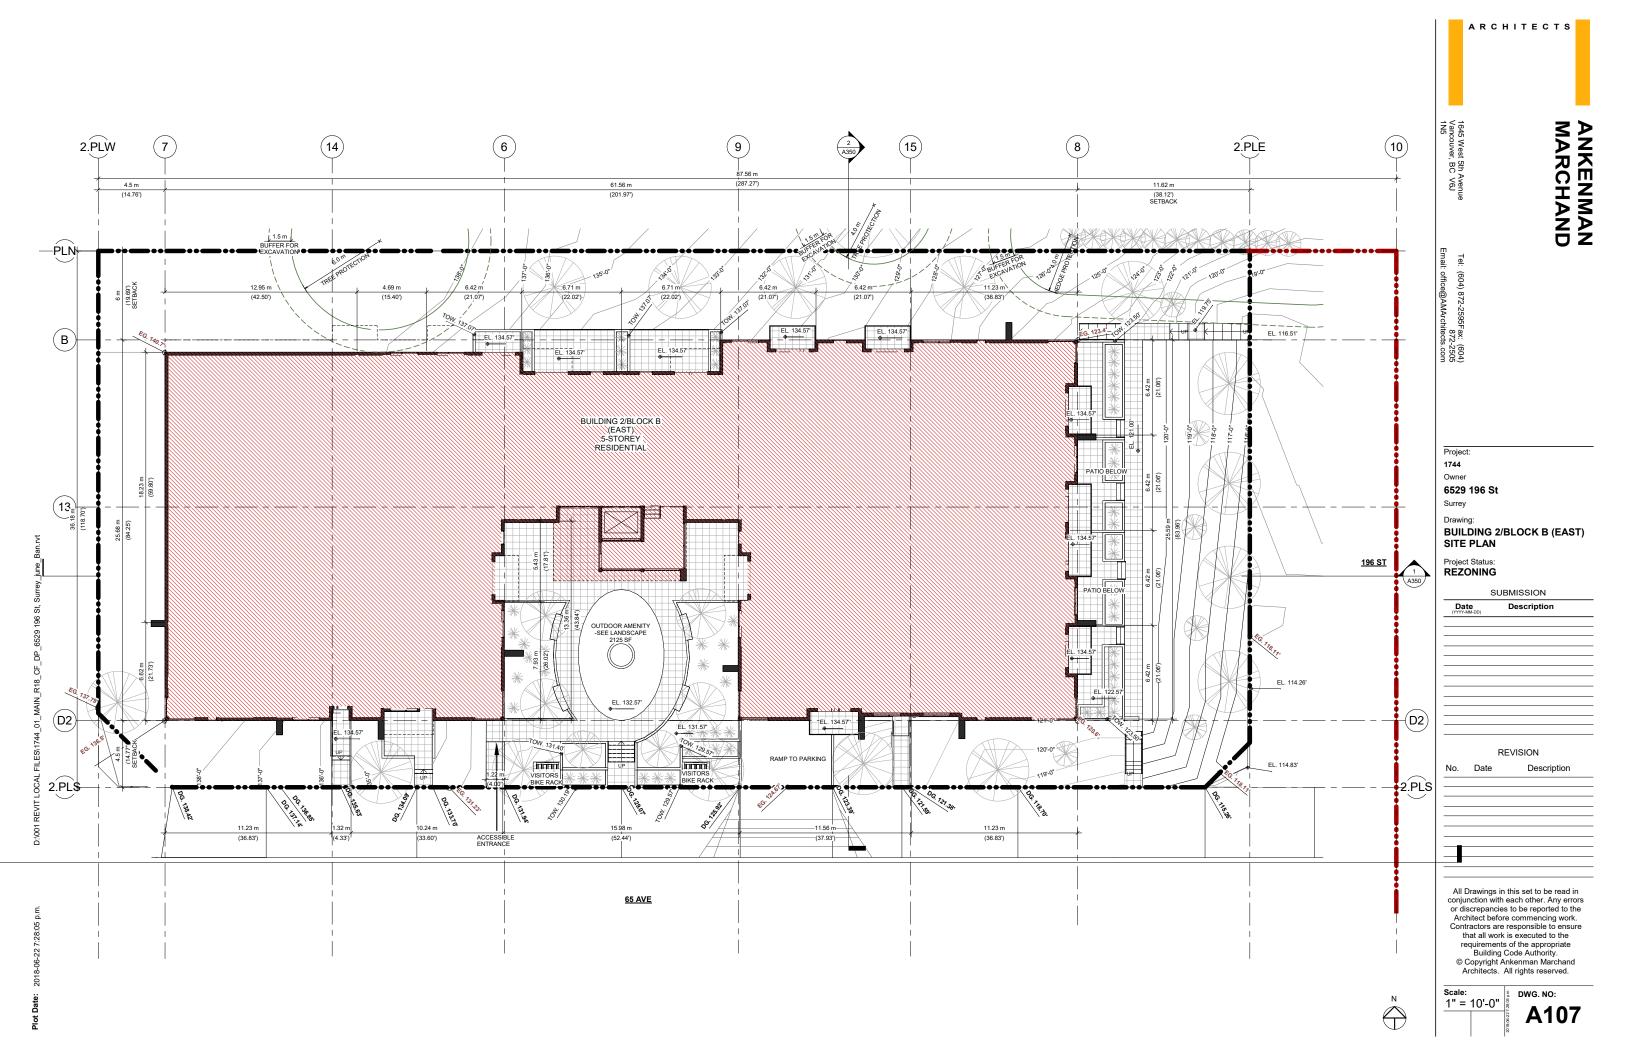

ANKENMAN MARCHAND

ARCHITECTS

5 West 5th Avenue couver, BC V6J

Project: 1744

6529 196 St

Surrey

Drawing: BUILDING 1/ BLOCK A (WEST) UNDERGROUND LEVEL 3 PLAN REZONING

SUBMISSION Date (CONTROL OF CONTROL OF CONTR Description 2018-06-07 Re-Issue for DP

REVISION No. Date Description

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Scale: 1" = 10'-0"

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A110

### REZONING

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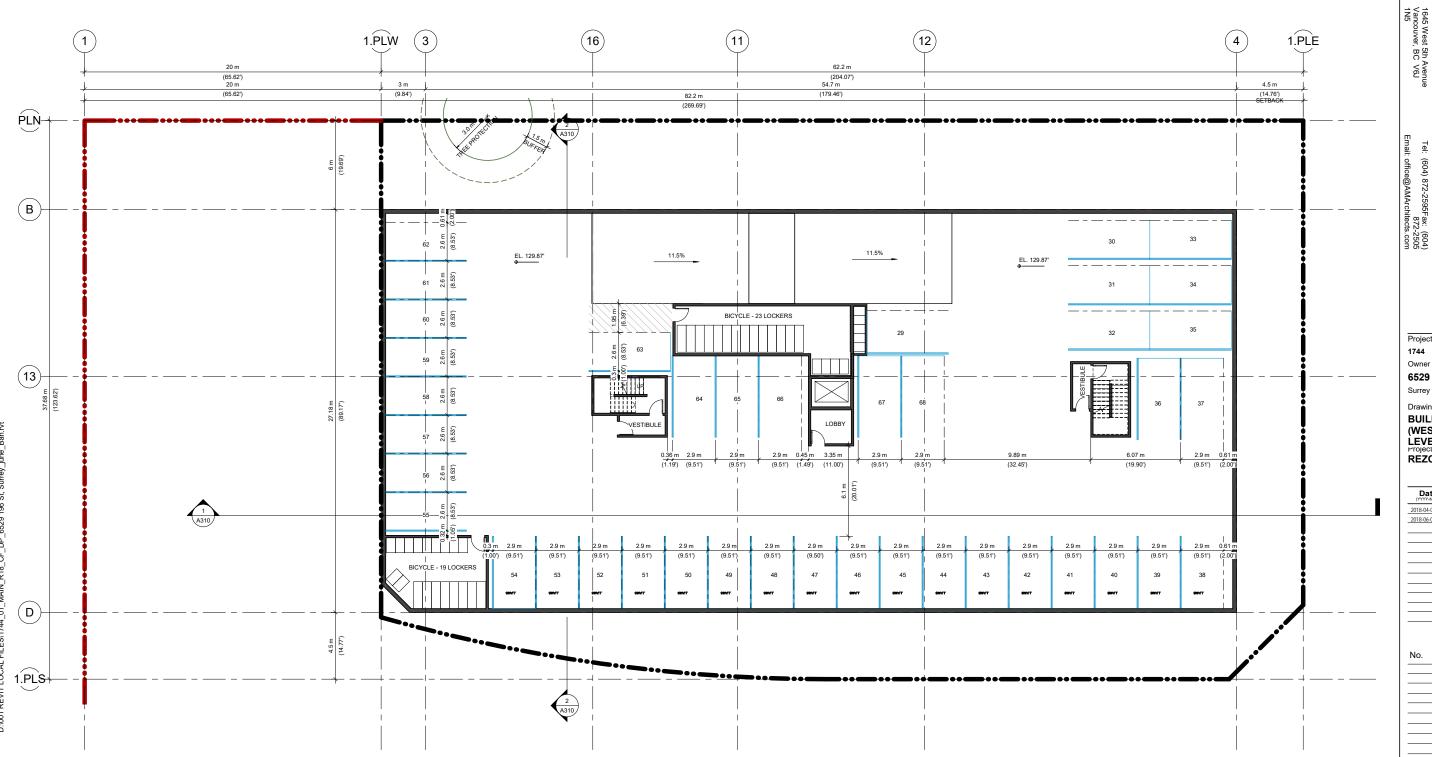
REVISION No. Date Description


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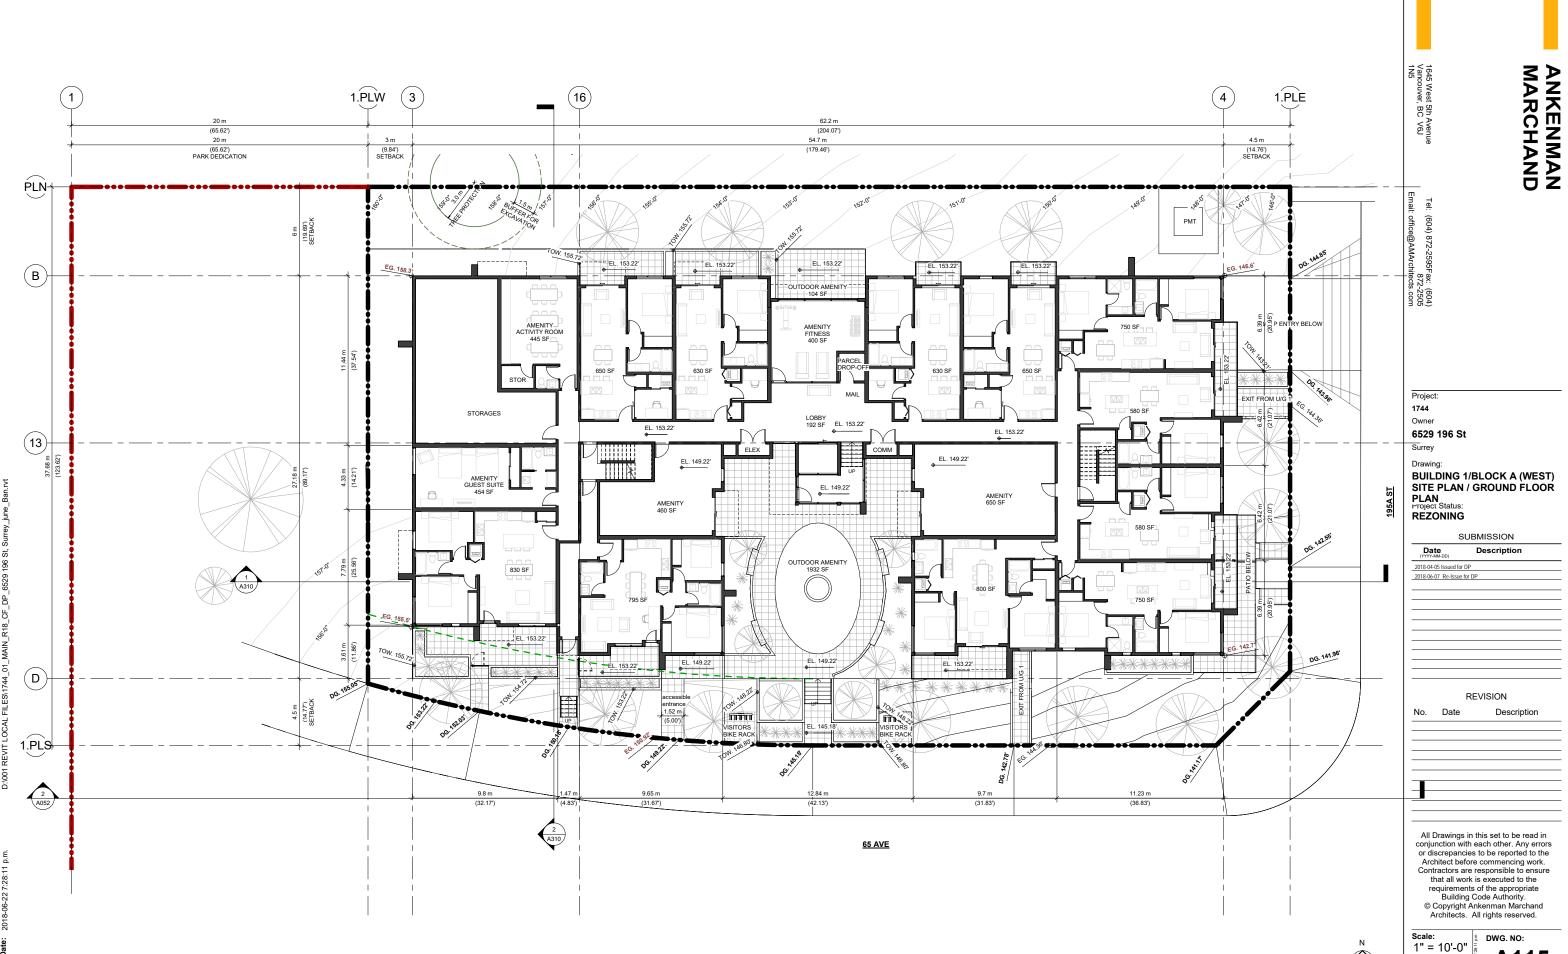
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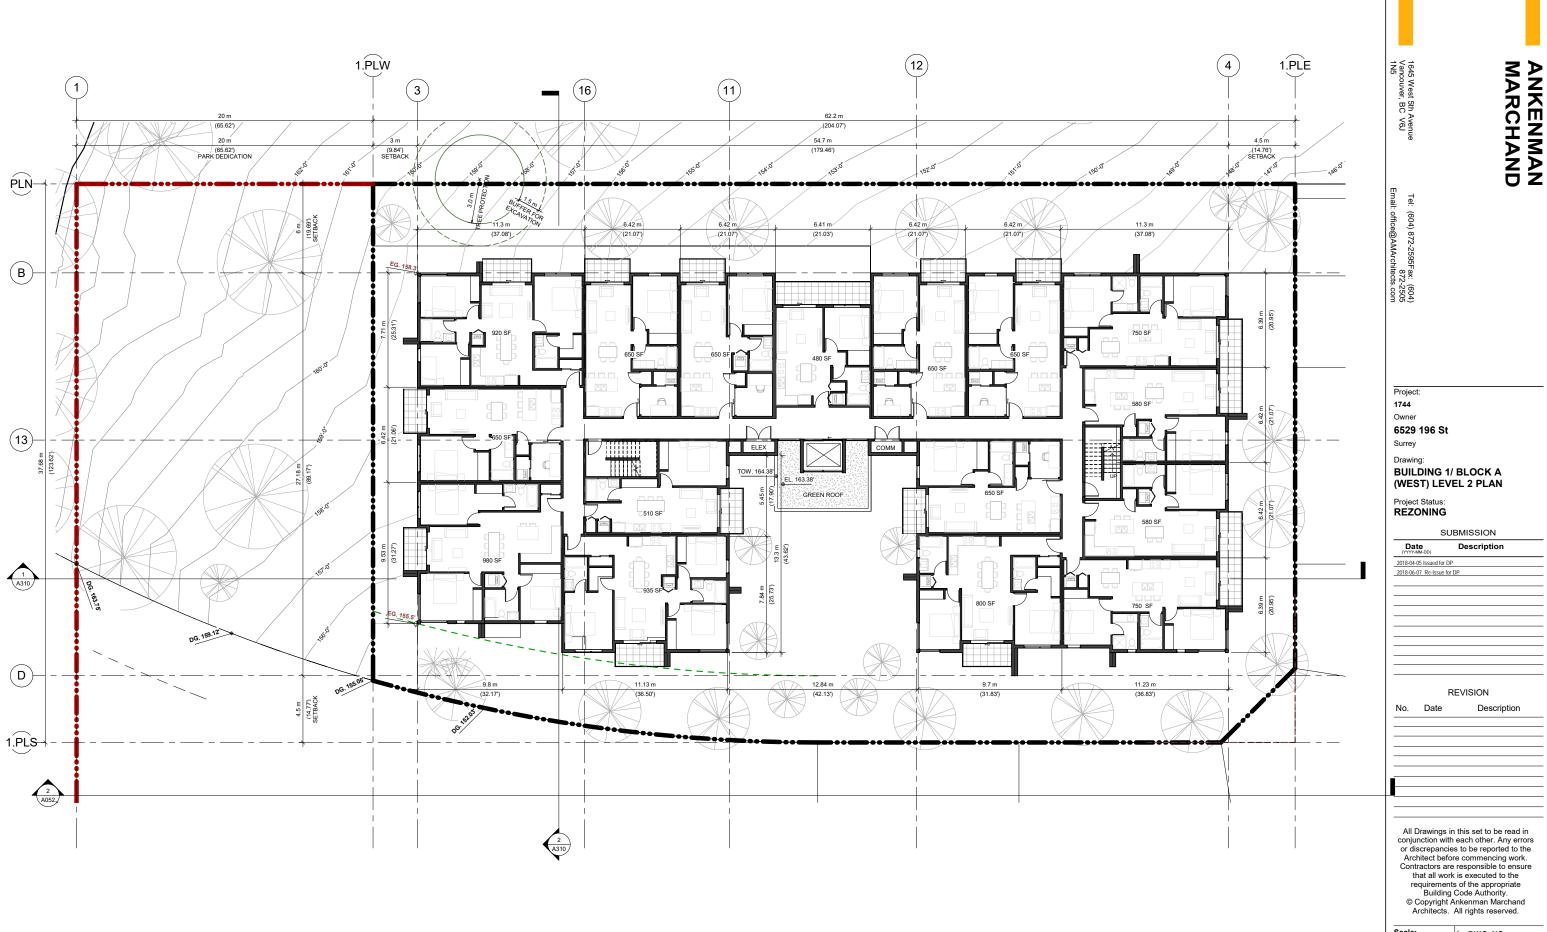
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ARCHITECTS



A115

ARCHITECTS

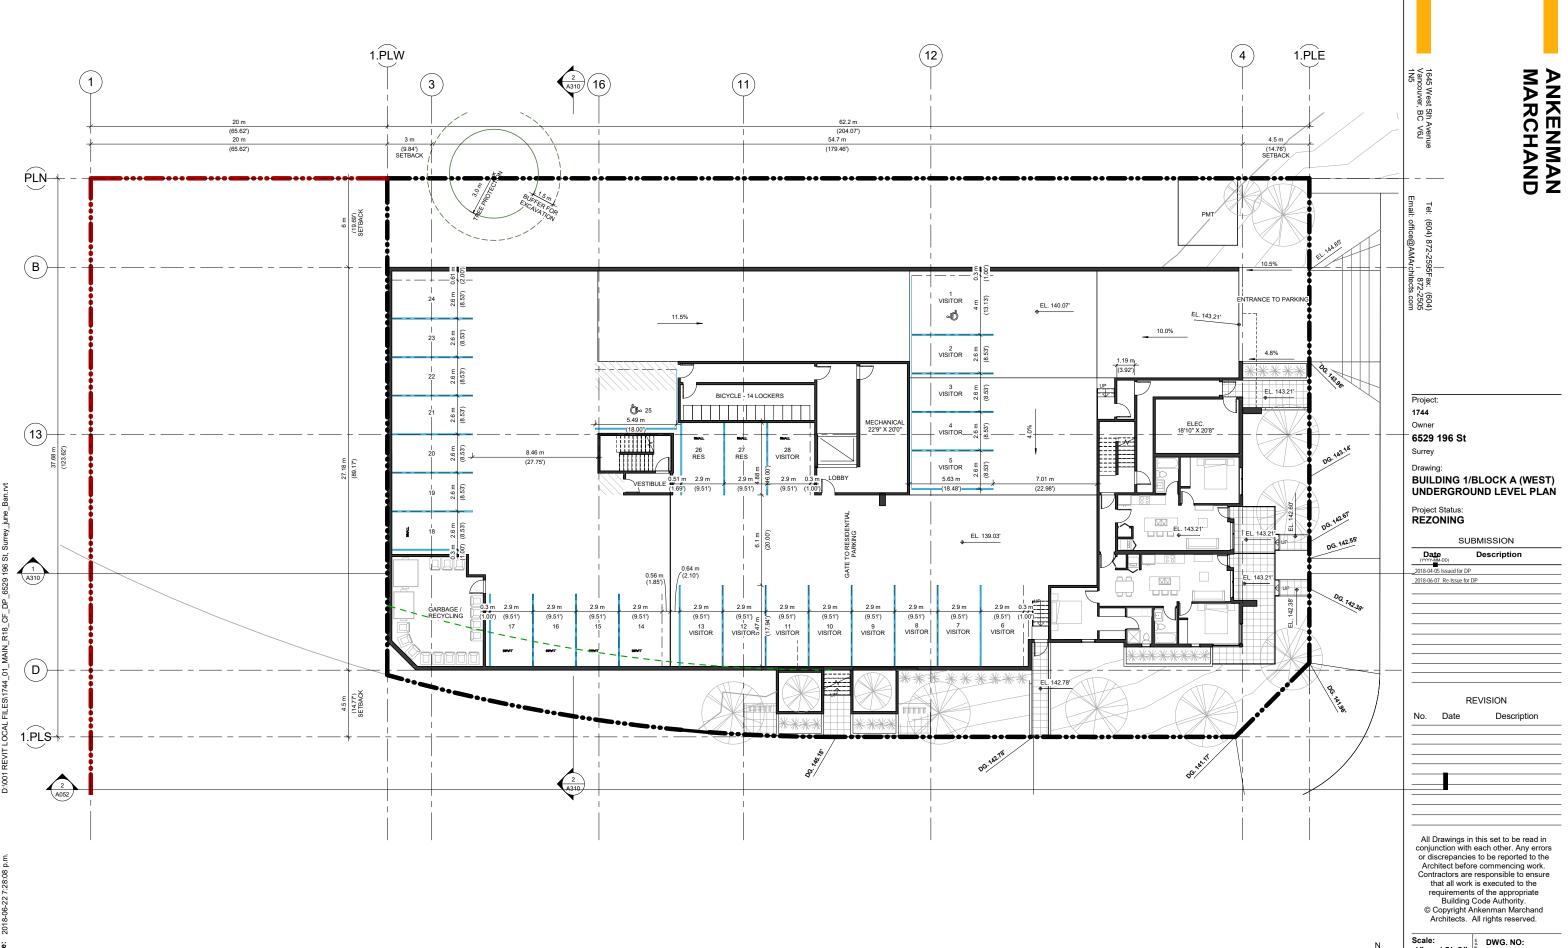

Scale: 1" = 10'-0"

Project Status: REZONING

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Description Date (YYYY-MM-DD) 2018-04-05 Issued for DP 2018-06-07 Re-Issue for DP

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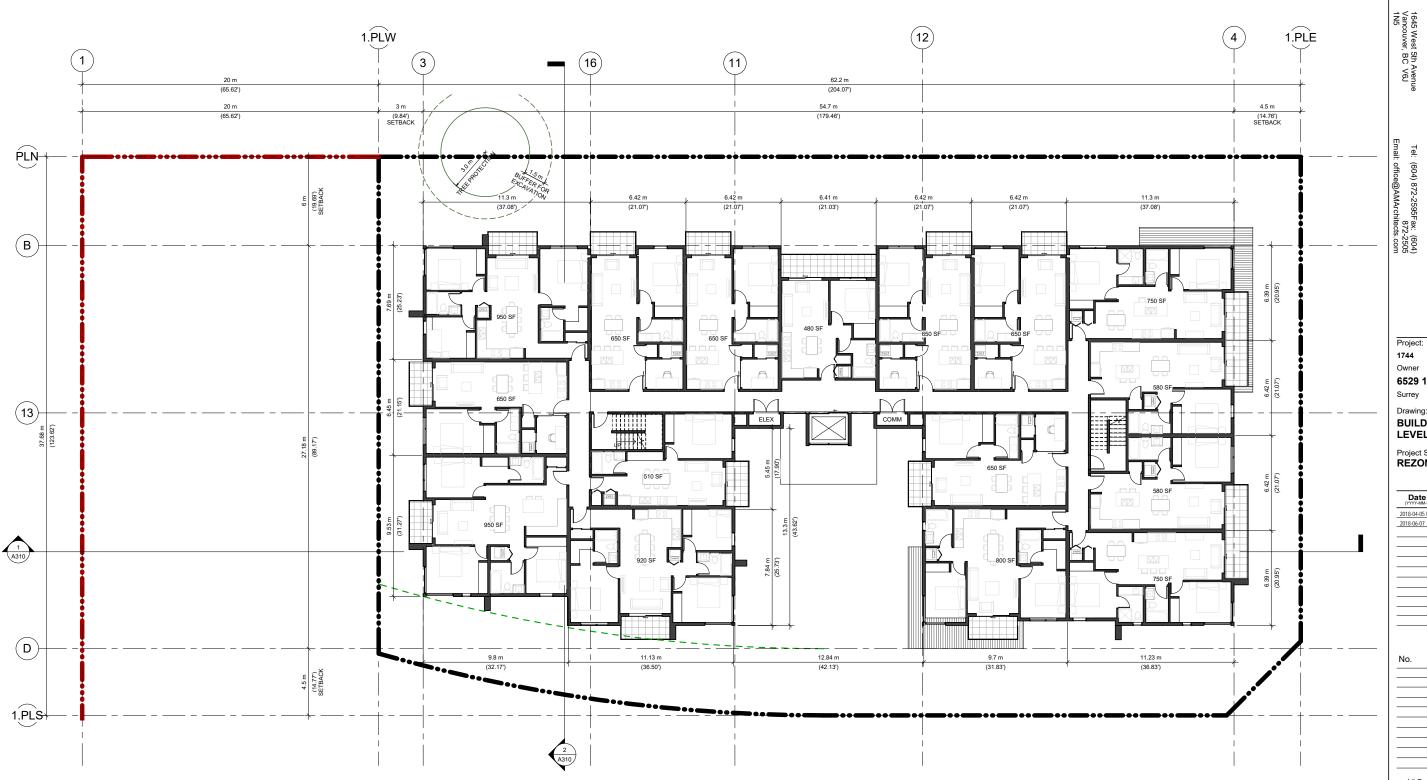
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SUBMISSION Description


Date (YYYY-MM-DD) 2018-04-05 Issued for DP 2018-06-07 Re-Issue for DP

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Scale: 1" = 10'-0"



6529 196 St Surrey

Drawing: **BUILDING 1/BLOCK A (WEST)** LEVEL 5 PLAN

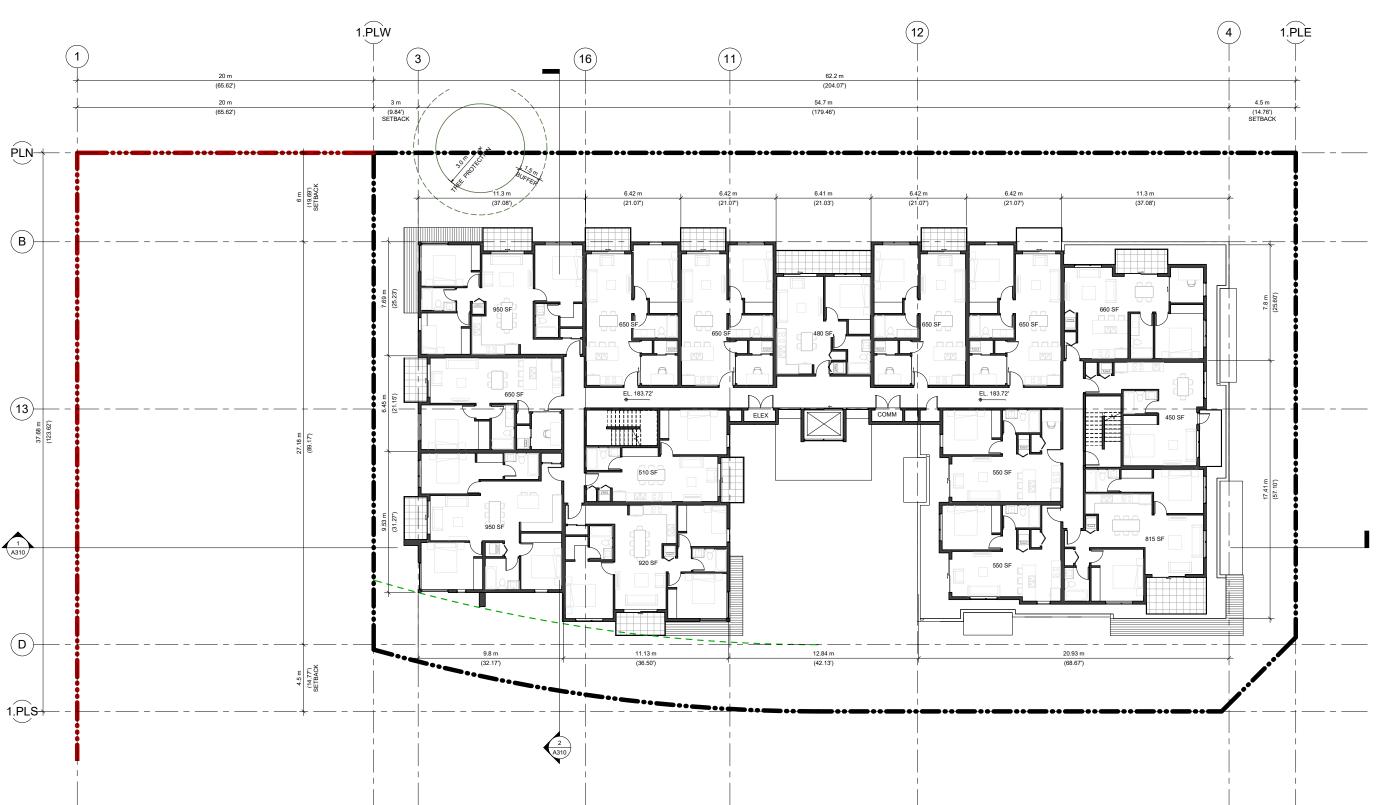Project Status: REZONING

SUBMISSION

Description Date (YYYY-MM-DD) 2018-04-05 Issued for DP 2018-06-07 Re-Issue for DP


REVISION


No. Date Description

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Scale: 1" = 10'-0"



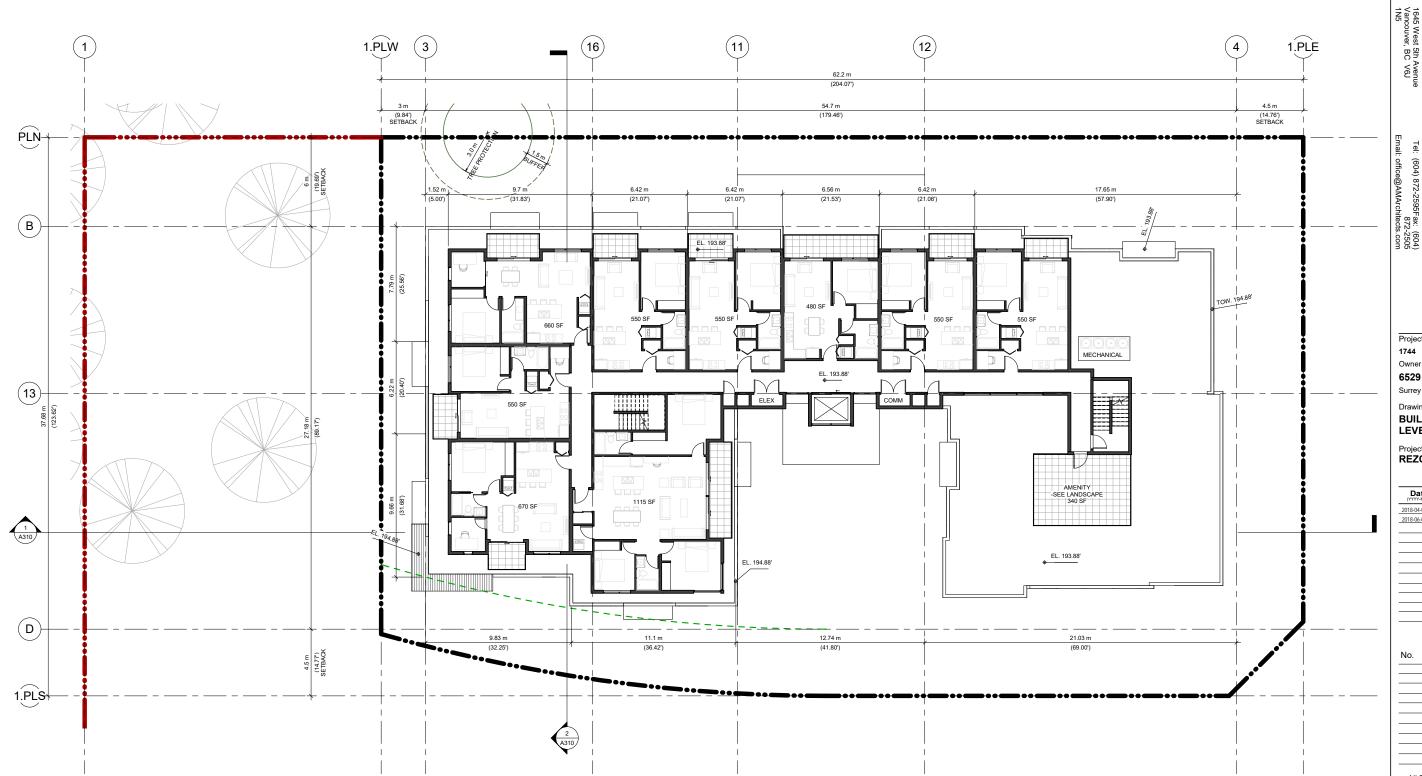


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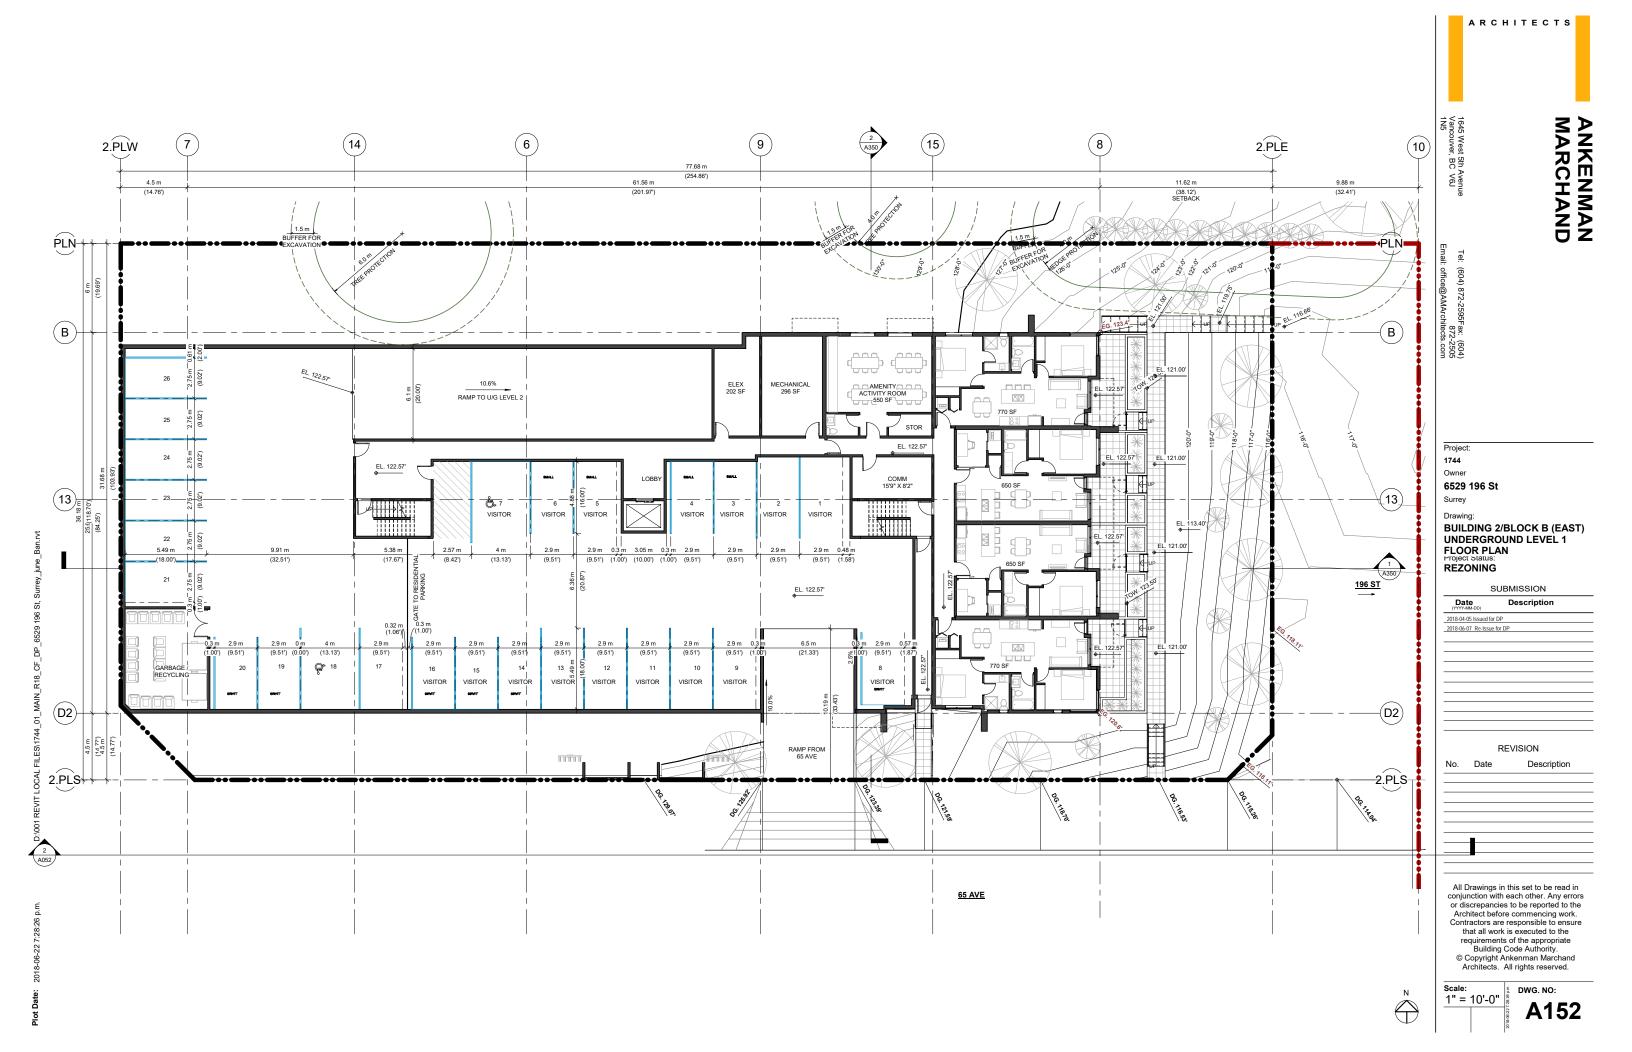
10'-0" DWG. NO:

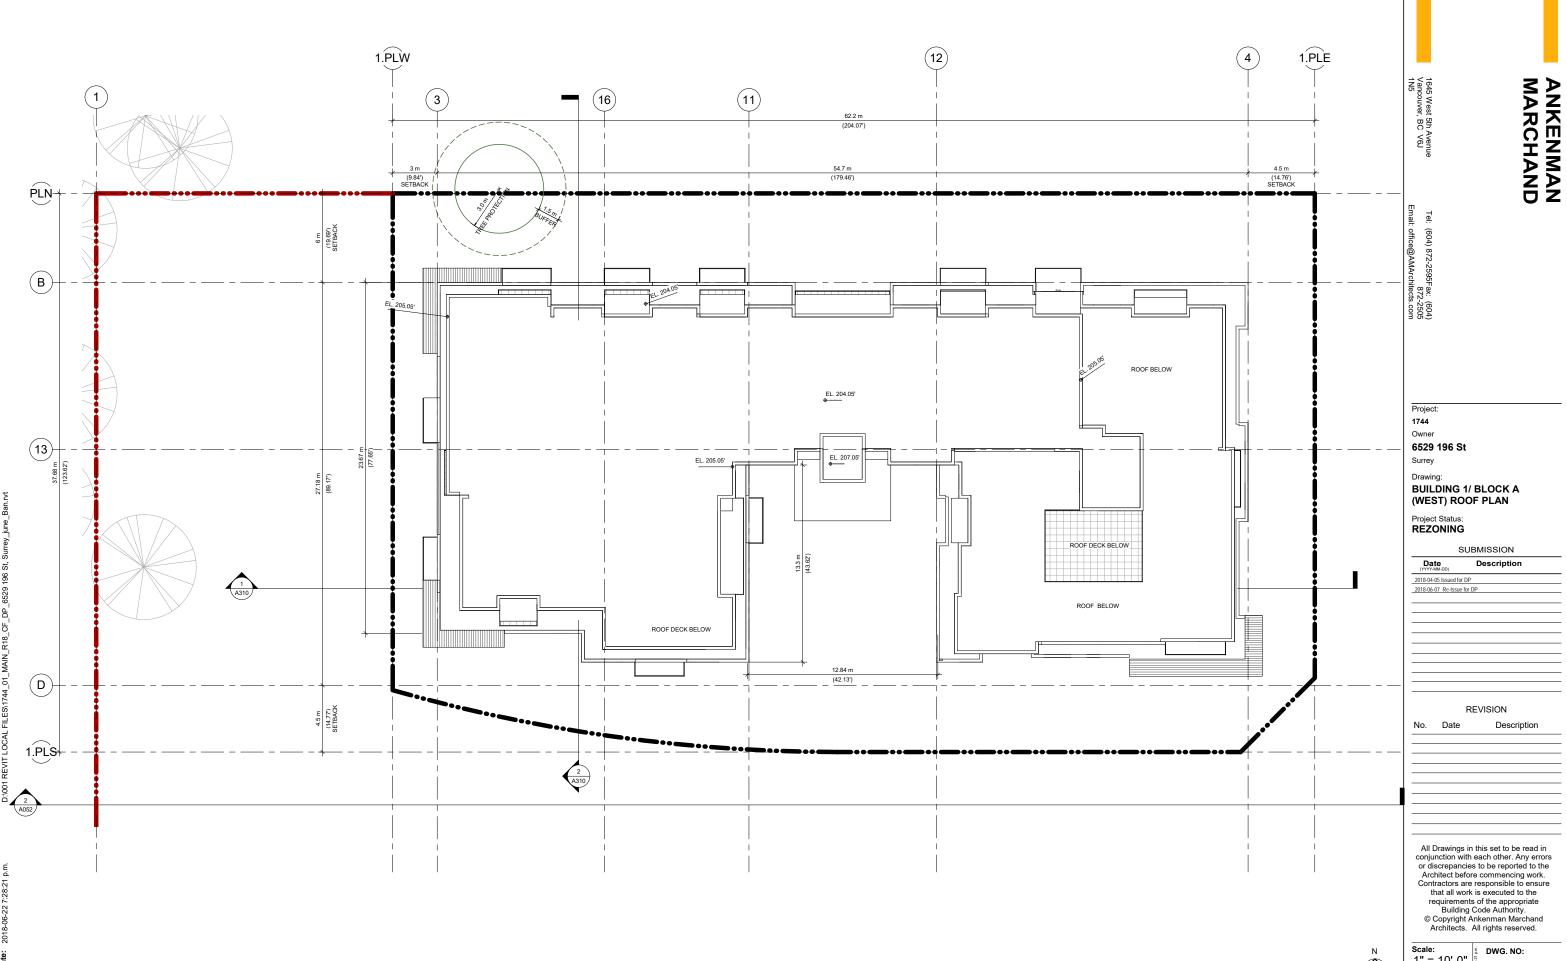
ARCHITECTS


A150


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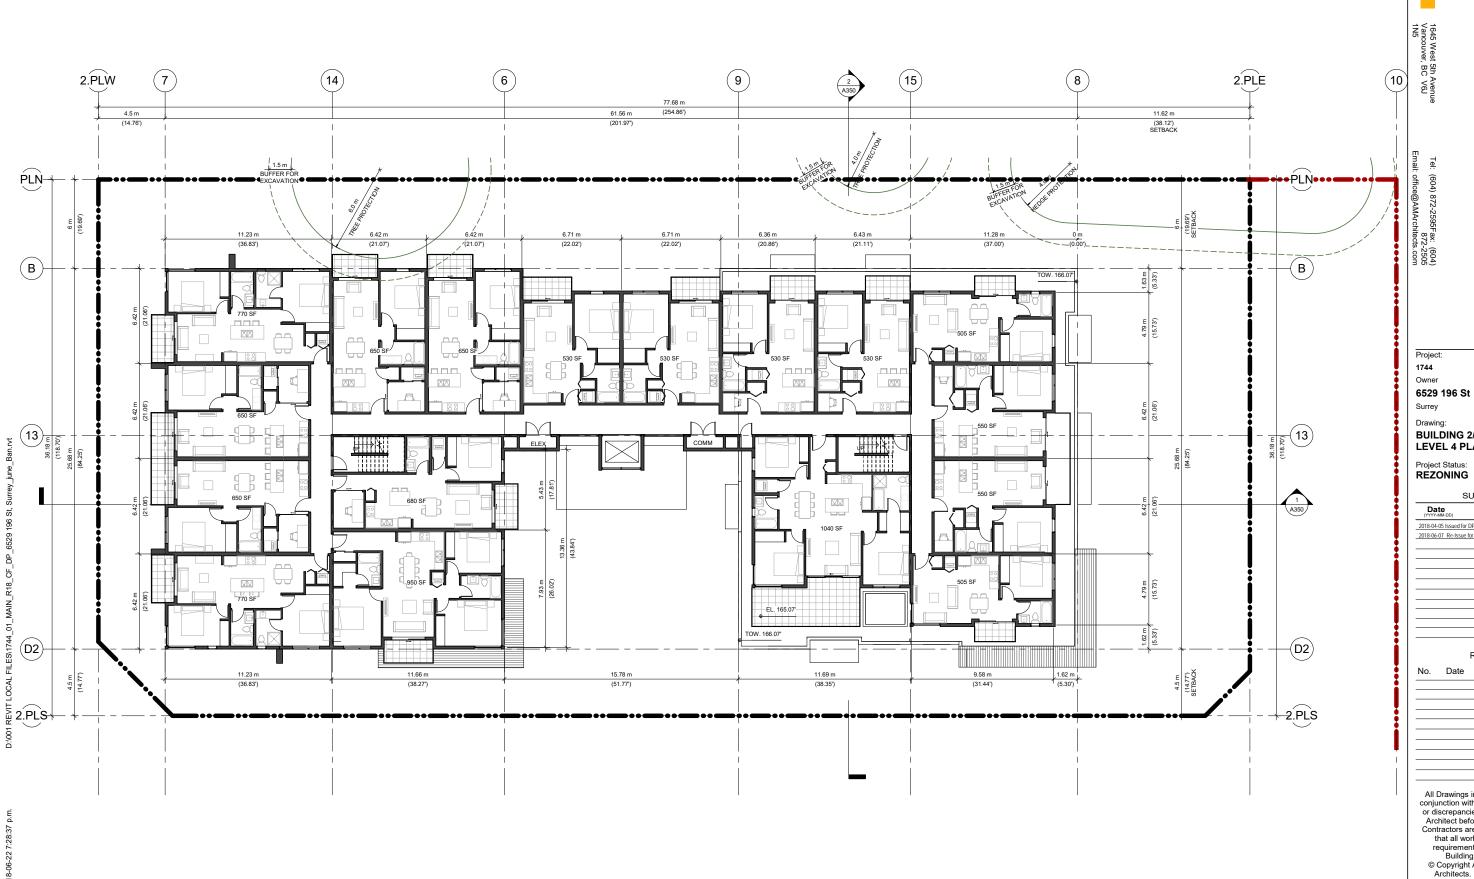




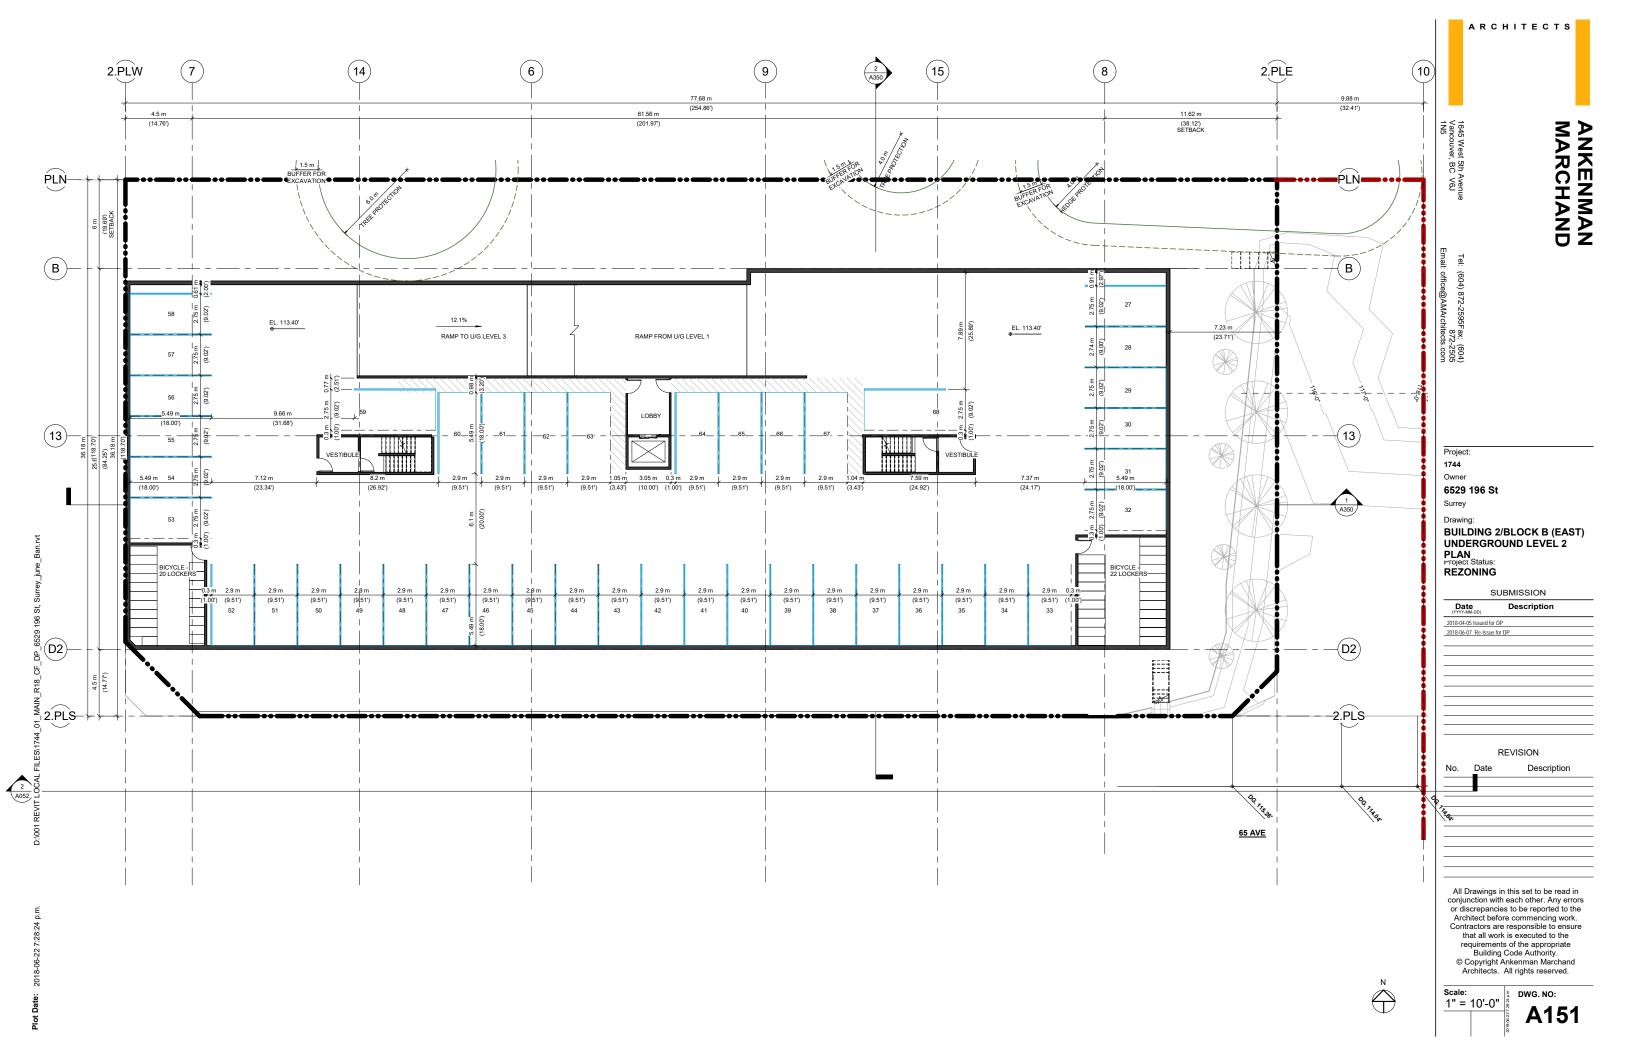

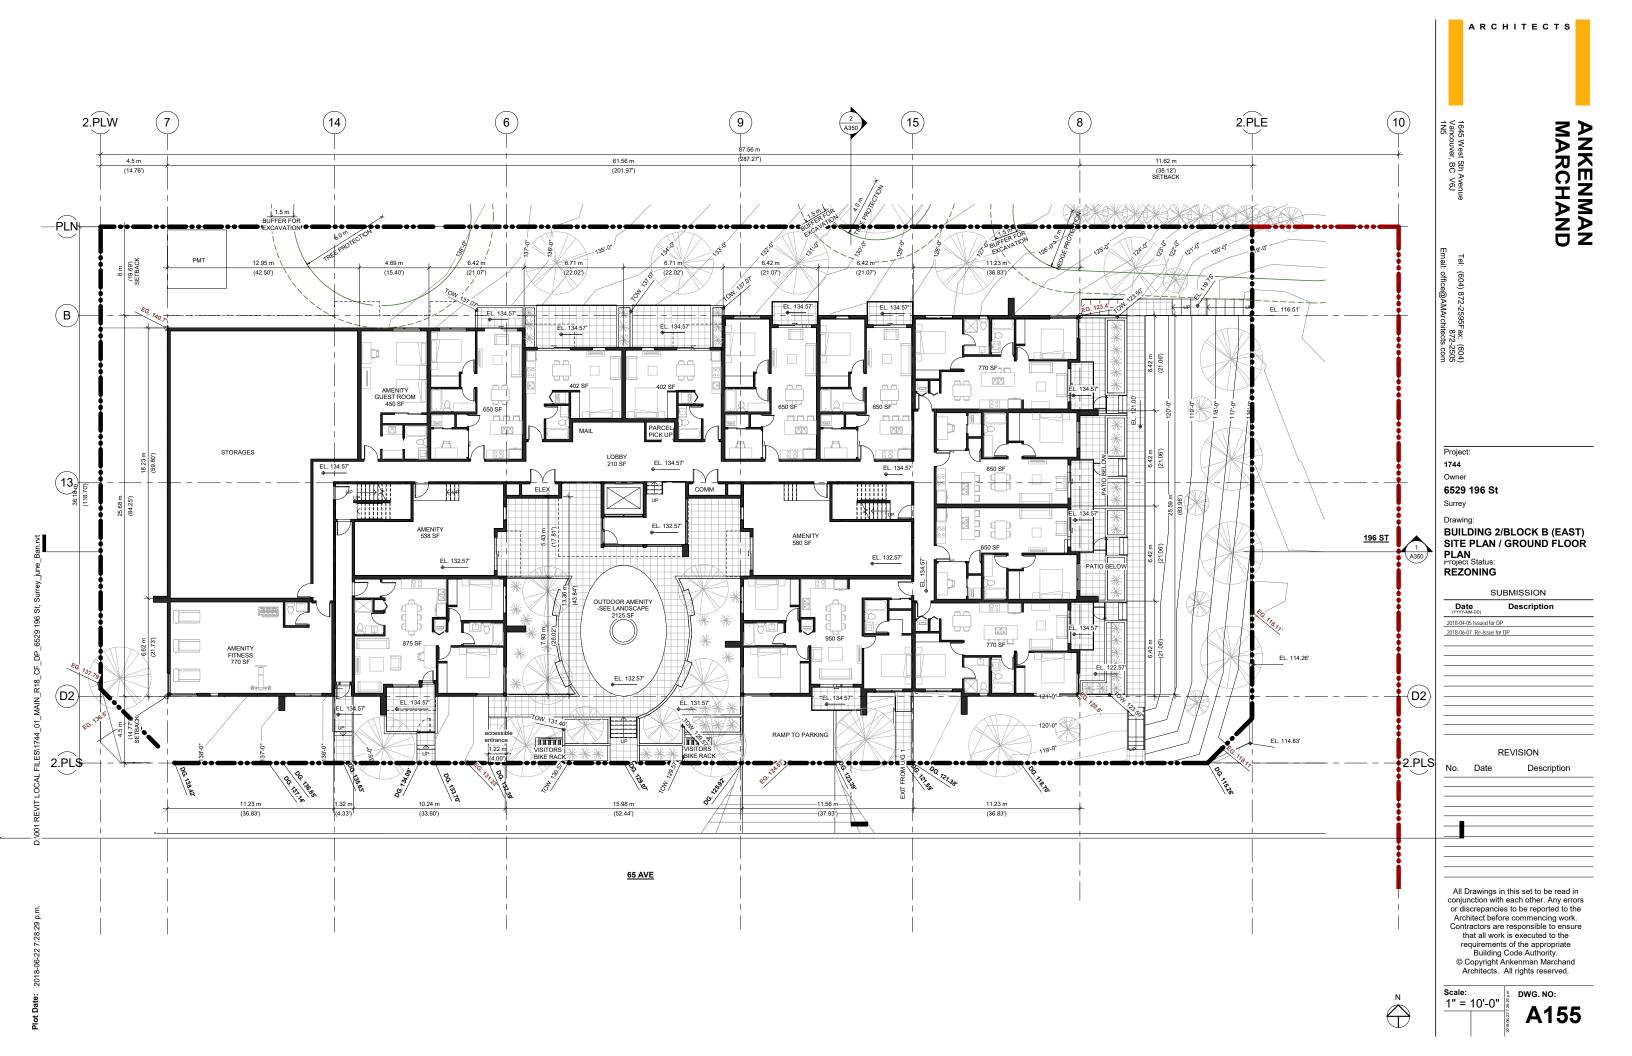

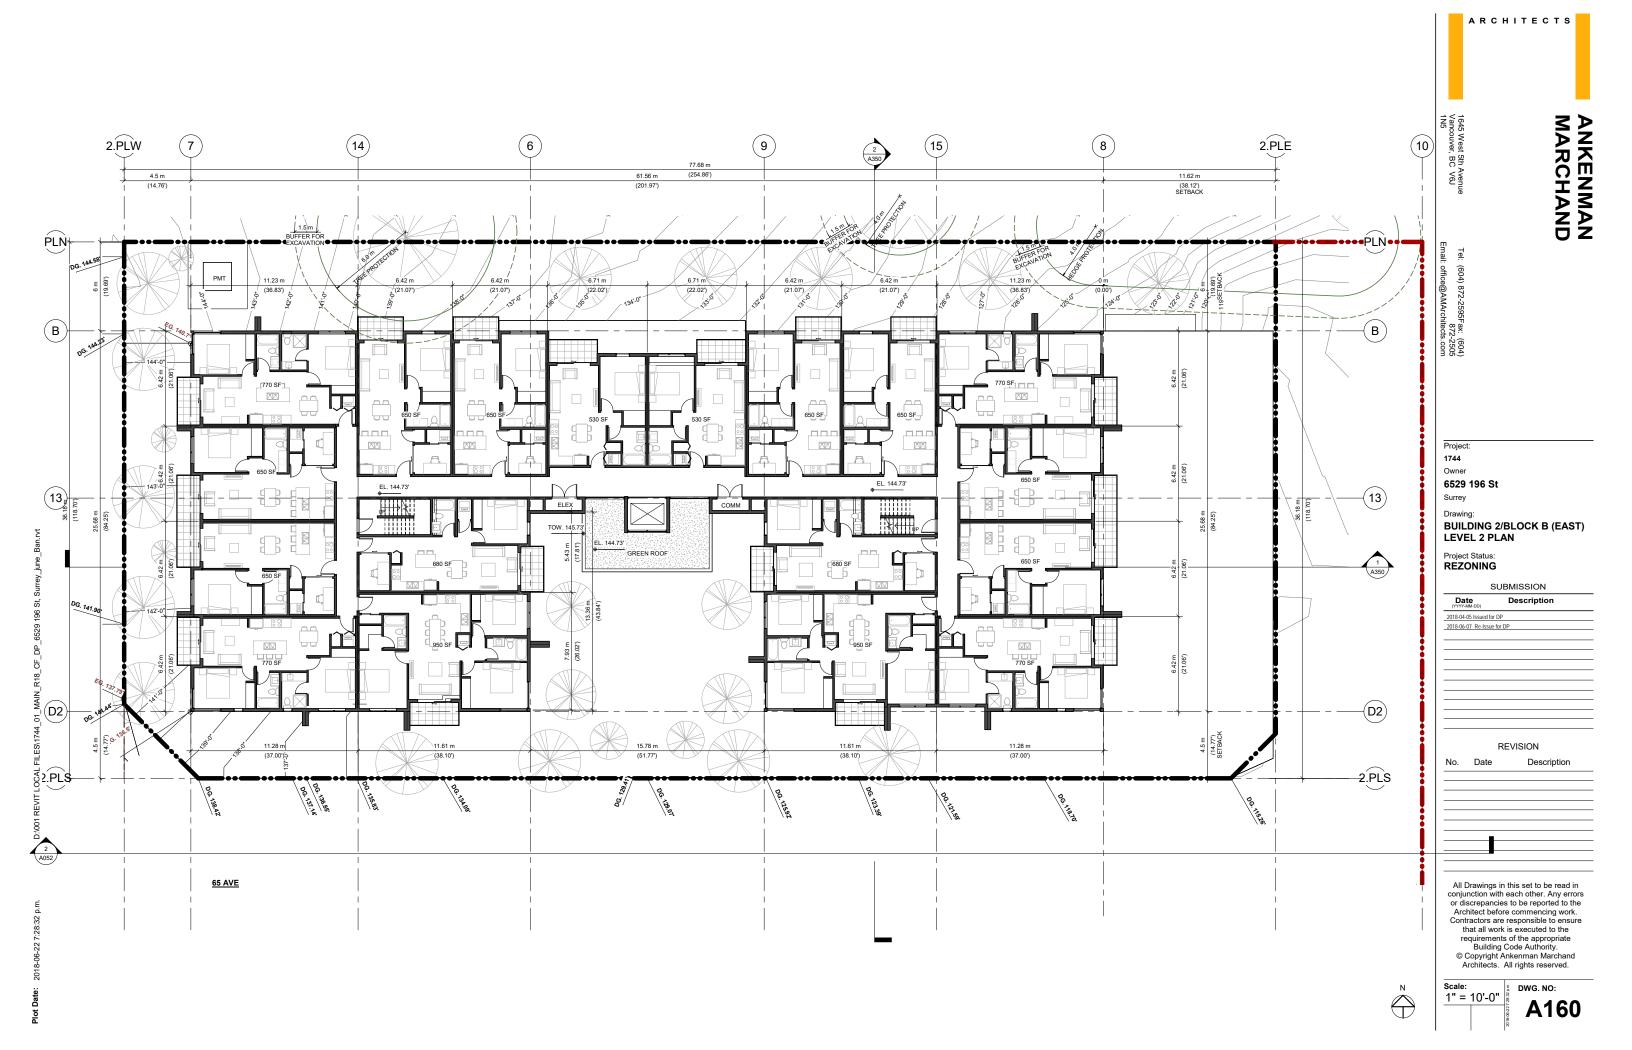

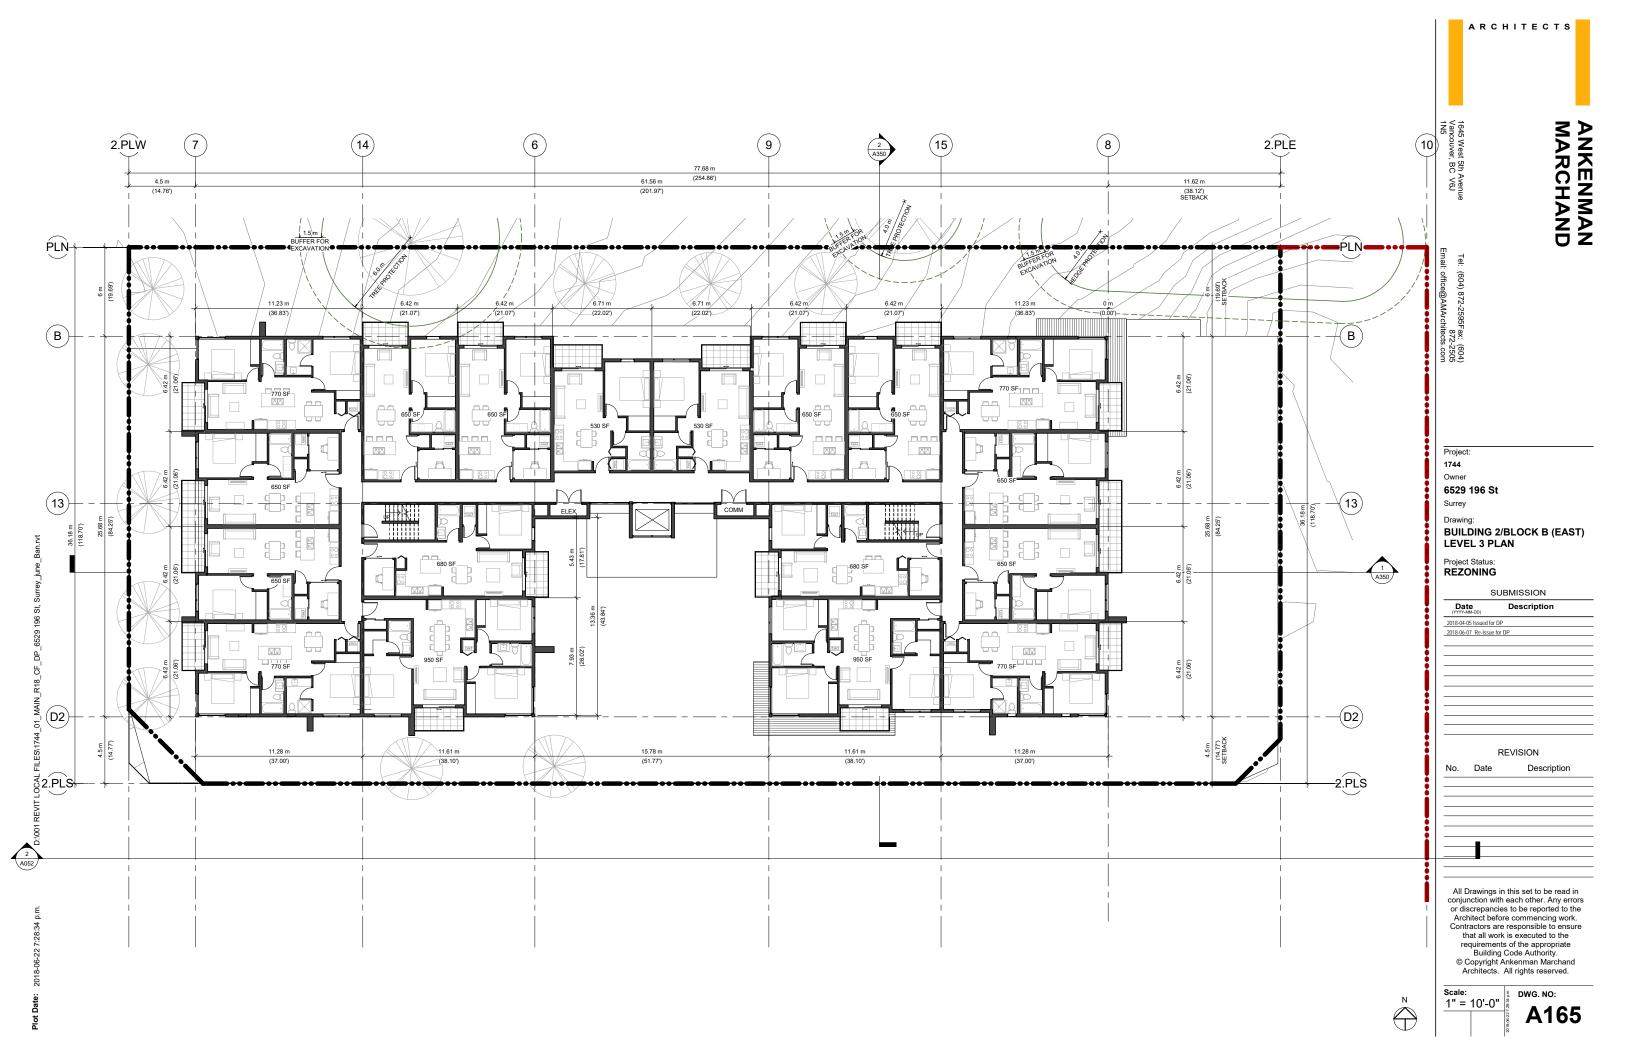

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ARCHITECTS

**BUILDING 2/BLOCK B (EAST)** LEVEL 4 PLAN

SUBMISSION


Date (YYYY-MM-DD)	Description
2018-04-05 Issued for DP	
2018-06-07 Re-Issue for DI	P

REVISION Description

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Scale: 1" = 10'-0"



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Scale: 1" = 10'-0"

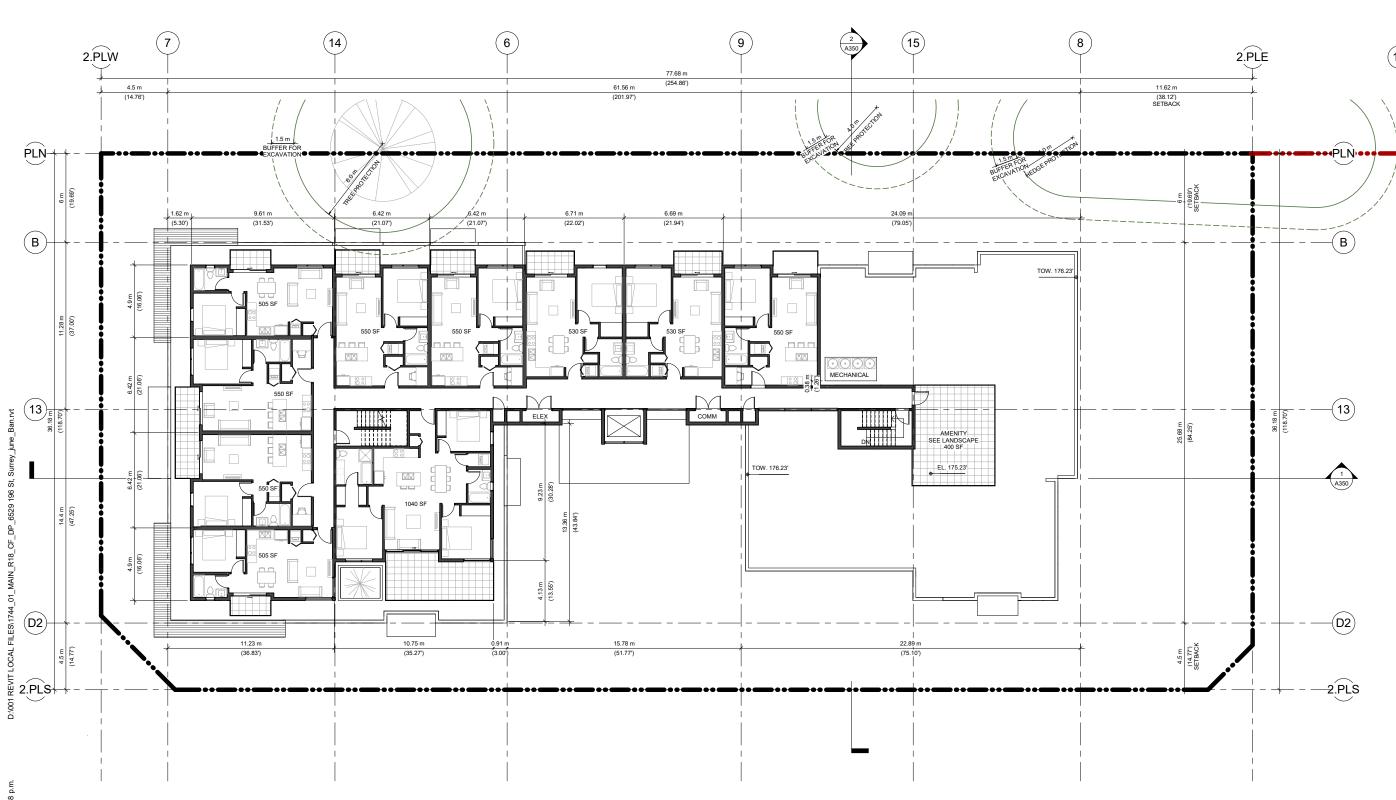1645 West 5th Avenue Vancouver, BC V6J 1N5

**6529 196 St** Surrey

Drawing:
BUILDING 2/BLOCK B (EAST)
ROOF PLAN

Project Status: REZONING

SUBMISSION

Date Description
(YYYAMAD)
2018-04-05 Issued for DP
2018-06-07 Re-issue for DP

REVISION


No. Date Description

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Scale: 1" = 10'-0"

DWG. NO: **A180** 



Date: 2018 06 22 7:28:40 p.m.
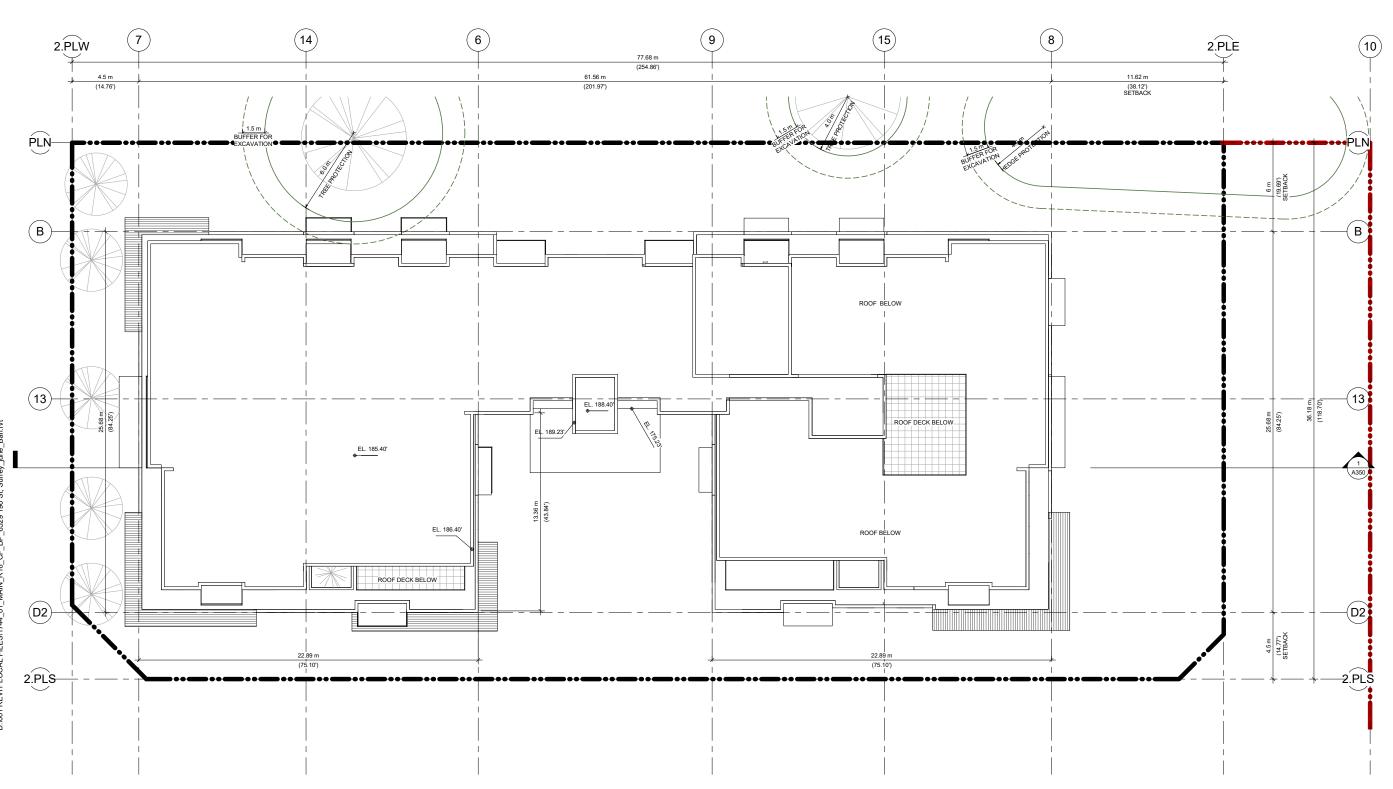
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(3)

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1.PLW

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ARCHITECTS

BC BC

Project: 1744

Owner 6529 196 St

Surrey

Drawing: **BUILDING 1/BLOCK A (WEST)** 

- ELEVATIONS NORTH & SOUTH Project Status: REZONING

Date (YYYY-MM-DD)	Description	
2018-04-05 Issued for	DP	
2018-06-07 Re-Issue	for DP	

REVISION

No. Date Description

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1" = 10'-0"

DWG. NO:

BC Sth.

Project: 1744 Owner

6529 196 St Surrey

> Drawing: **BUILDING 1/BLOCK A (WEST)** - ELEVATIONS EAST & WEST

Project Status REZONING

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2018-04-05 Issued for DP	
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# REVISION

No.	Date	Description

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Scale: 1" = 10'-0"

DWG. NO: **A215** 



① BUILDING 1/BLOCK A (WEST) EAST ELEVATION
1" = 10'-0"



(13)

 $\underbrace{ \text{4-} \frac{\text{BUILDING 1/BLOCK A (WEST) COURTYARD ELEVATION FACING EAST}}_{1"=10"\text{-}0"} }$ 

1.PLS

( D )



MATERIAL LEGEND	
Key Value Keynote Text	
1	LAP SIDING FIBRE CEMENT PLANK - COLOUR: CHARCOAL
2	SMOOTH FIBRE CEMENT PANEL - COLOUR: IVORY
3	METAL PANEL, COATING WITH WOOD GRAIN - COLOUR: CEDAR
3A	PREFINISHED METAL FLASHING - COLOUR: CEDAR
4	FASCIA FIBRE CEMENT BOARD- COLOUR: CHARCOAL



(2)(4)(7)

	WATERIAL LEGEND		
Key Value	lue Keynote Text		
5	CAST-IN-PLACE ARCHITECTURAL CONCRETE WITH CLEAR SEALER:		
	WALLS, PLANTERS AT GRADE		
6	VINYL WINDOW - FRAME COLOUR: CHARCOAL		
7	7 VINYL FULLY GLAZED PATIO SLIDING DOOR - FRAME COLOUR: CHARCOAL		
8	VINYL WINDOW - FROSTED GLASS - FRAME COLOUR: CHARCOAL		

	With Elime EEGEND		
Key Value	/alue Keynote Text		
5	CAST-IN-PLACE ARCHITECTURAL CONCRETE WITH CLEAR SEALER: WALLS, PLANTERS AT GRADE		
6	VINYL WINDOW - FRAME COLOUR: CHARCOAL		
7	VINYL FULLY GLAZED PATIO SLIDING DOOR - FRAME COLOUR: CHARCOAL		
8	VINYL WINDOW - FROSTED GLASS - FRAME COLOUR: CHARCOAL		

	WATERIAL ELOCIAD
Key Value	Keynote Text
9	PAINTED STEEL AND WIRED GLASS SWING DOOR - COLOUR: CHARCOAL
10	ALUMINUM PIPE GUARD - COLOUR: CHARCOAL
11	VINYL FULLY GLAZED FRONT SWING DOOR - FRAME COLOUR: CHARCOAL
12	ALUMINUM GARDEN GATE

(B)

ΡĹΝ

BLDG 1 ROOF 202.88

BLDG 1 LEVEL 5 (193.88°)

BLDG 1 LEVEL 4 (183.72)

BLDG 1 LEVEL 3 (173.55°)

BLDG 1 LEVEL 2 (163.38')

BLDG 1 GROUND 153.22

BLDG 1 U/G 1 (143.21')



ARCHITECTS **ANKENMAN MARCHAND** 

6529 196 St

**BUILDING 2/BLOCK B (EAST)** - ELEVATIONS NORTH & SOUTH

# REZONING

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2018-04-05 Issued for	DP
2018-06-07 Re-Issue	for DP

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1" = 10'-0"

DWG. NO:



Sth.

Aveni V6J

Project: 1744 Owner

6529 196 St

Surrey Drawing:

**BUILDING 2/BLOCK B (EAST)** - ELEVATIONS EAST & WEST

Project Status REZONING

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Date (YYYY-MM-DD)	Description
2018-04-05 Issued for DP	
2018-06-07 Re-Issue for DI	Р

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NO.	Date	Description	

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1" = 10'-0"

DWG. NO: **A255** 



MATERIAL LEGEND					
Key Value	Keynote Text				
1	LAP SIDING FIBRE CEMENT PLANK - COLOUR: CHARCOAL				
2	SMOOTH FIBRE CEMENT PANEL - COLOUR: IVORY				
3	METAL PANEL, COATING WITH WOOD GRAIN - COLOUR: CEDAR				
3A	PREFINISHED METAL FLASHING - COLOUR: CEDAR				

FASCIA FIBRE CEMENT BOARD- COLOUR: CHARCOAL

2 BUILDING 2/BLOCK B (EAST) WEST ELEVATION
1" = 10'-0"

MATERIAL LEGEND						
Key Value Keynote Text						
5	CAST-IN-PLACE ARCHITECTURAL CONCRETE WITH CLEAR SEALER: WALLS, PLANTERS AT GRADE					
6	VINYL WINDOW - FRAME COLOUR: CHARCOAL					
7	VINYL FULLY GLAZED PATIO SLIDING DOOR - FRAME COLOUR: CHARCOAL					
8	VINYL WINDOW - FROSTED GLASS - FRAME COLOUR: CHARCOAL					


MATERIAL LEGEND					
Key Value	Keynote Text				
5	CAST-IN-PLACE ARCHITECTURAL CONCRETE WITH CLEAR SEALER: WALLS, PLANTERS AT GRADE				
6	VINYL WINDOW - FRAME COLOUR: CHARCOAL				
7	VINYL FULLY GLAZED PATIO SLIDING DOOR - FRAME COLOUR: CHARCOAL				
8	VINYL WINDOW - FROSTED GLASS - FRAME COLOUR: CHARCOAL				

BUILDING 2/BLOCK \$ (EAST) COURTYARD ELEVATION FACING EAST

Keynote Text Key Value PAINTED STEEL AND WIRED GLASS SWING DOOR - COLOUR: CHARCOAL ALUMINUM PIPE GUARD - COLOUR: CHARCOAL VINYL FULLY GLAZED FRONT SWING DOOR - FRAME COLOUR: 12 ALUMINUM GARDEN GATE

MATERIAL LEGEND



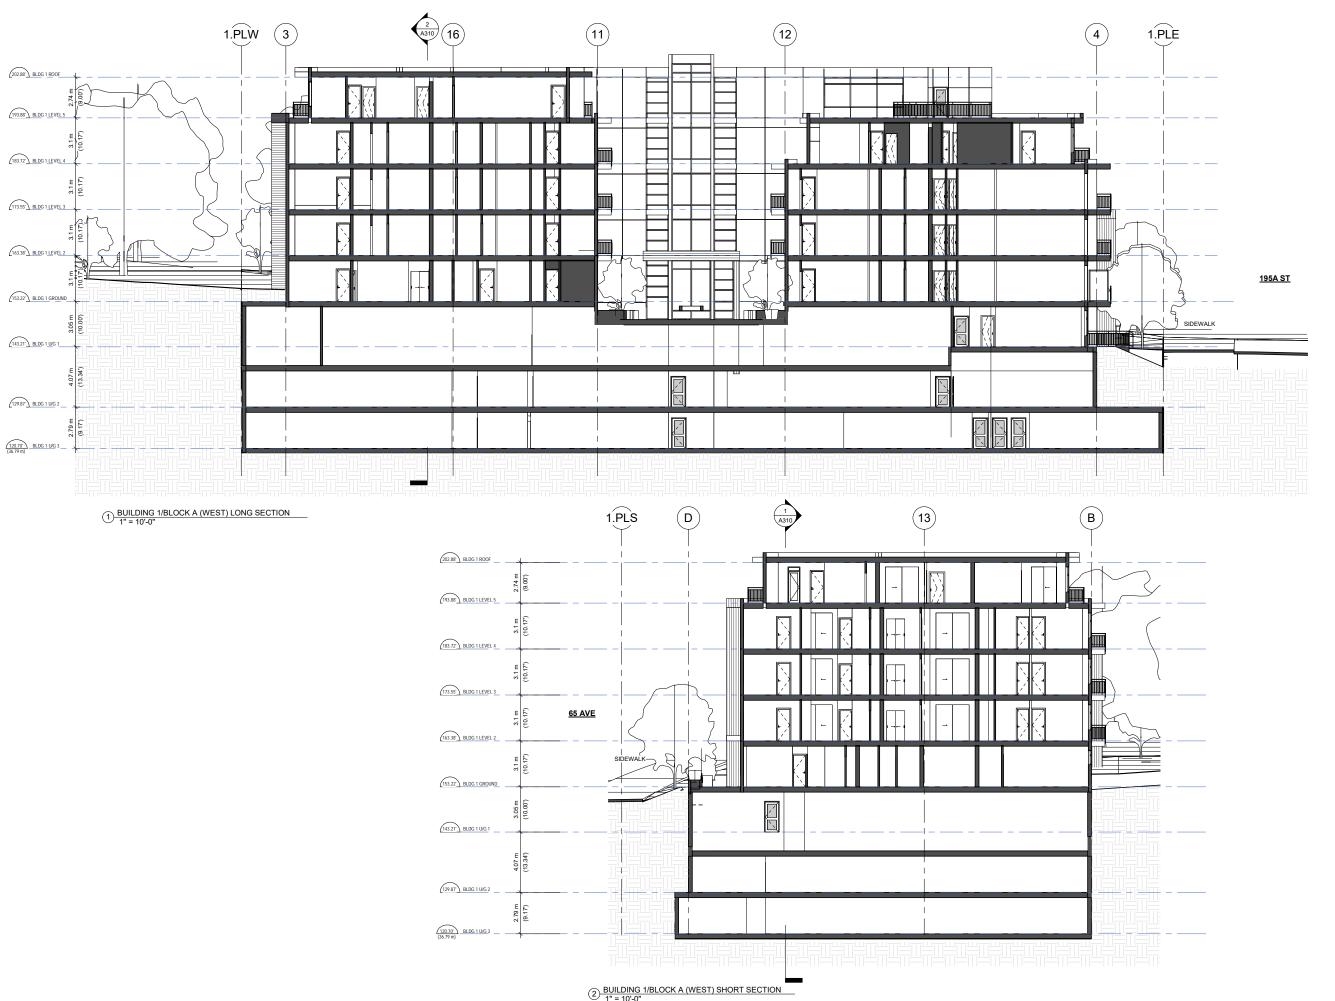

5 West 5th Avenue couver, BC V6J

ANKENMAN MARCHAND

Project: 1744

Owner

6529 196 St Surrey

Drawing:

**BUILDING 1/BLOCK A (WEST)** - SECTIONS

Project Status: REZONING

SUBMISSION						
Date (YYYY-MM-DD)	Description					
2018-04-05 Issued for	DP					
2018-06-07 Re-Issue	for DP					

REVISION

lo.	Date	Description

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Scale: 1" = 10'-0"


DWG. NO:

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(14)

**6** 



9

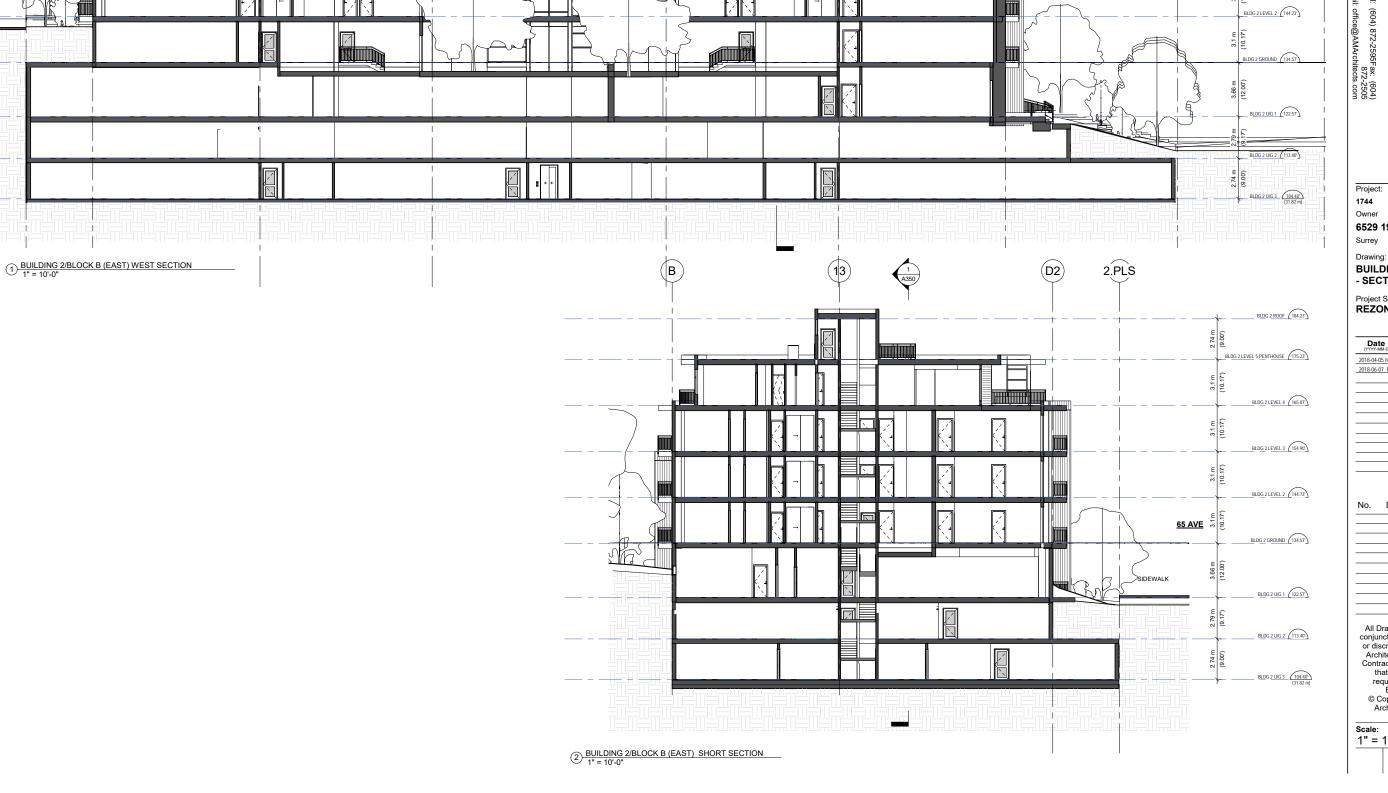(15)

(8)

ARCHITECTS ANKENMAN MARCHAND 5th / Avenue V6J

(10)

BLDG 2 ROOF (184.23')

BLDG 2 LEVEL 4 165.07

BLDG 2 LEVEL 3 (154.90')

BLDG 2 LEVEL 2 144.73

BLDG 2 LEVEL 5 PENTHOUSE (175.23')

2.PLE

6529 196 St

BUILDING 2/BLOCK B (EAST) - SECTIONS

Project Status: **REZONING** 

SUBMISSION Description Date (YYYY-MM-DD) 2018-04-05 Issued for DP 2018-06-07 Re-Issue for DP

REVISION

No. Date Description

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Scale: 1" = 10'-0"

DWG. NO:

# VIEW FROM 195A ST





VIEW FROM 65 AVE TO ENTRY AND COURTYARD VIEW FROM THE TOP OF 65 AVE 1645 West 5th Avenue Vancouver, BC V6J 1N5

Project:

Owner

6529 196 St

Surrey

Drawing:
BUILDING 1/BLOCK A (WEST)
- 3D VIEWS

Project Status: REZONING

SUBMISSION

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Date (YYYY-MM-DD)	Description
2018-04-05 Issued for D	P
2018-06-07 Re-Issue fo	r DP

Date	Description

REVISION

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Scale:

DWG. NO:



VIEW FROM 65 AVE TO ENTRY AND COURTYARD



VIEW FROM CORNER OF 65 AVE AND 196 ST



VIEW FROM CORNER OF 65 AVE AND 195A ST

1645 West 5th Avenue Vancouver, BC V6J 1N5

Email: office@AMArchitects

ANKENMAN MARCHAND

Project:

Owner

6529 196 St

Surrey

Drawing:

BUILDING 2/BLOCK B (EAST) - 3D VIEWS

Project Status: REZONING

INING

Date (YYYY-MM-DD)	Description
018-04-05 Issued for	DP
018-06-07 Re-Issue	for DP

No. Date Description

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Scale:

DWG. NO:

# **LEGENDS**

·											
HARDS	IARDSCAPE LEGEND SOFTSCAPE LEGEND										
KEY	GRAPHIC	DESCRIPTION	DETAIL KEY	KEY	GRAPH	IC	DESCRIPTION			DETAIL KEY	
(T-1)		CIP Concrete Paving to CoS standard Colour: Integral coloured Finish: Light Broom Pattern: Saw-cut (as shown on L-1 Ground Plan)	Ld-XX L-X	<b>₹</b> -8			Planting (Average #2 pots 46cm spacing) w/ 4'-0"ht. Privacy Hedging		Ld-XX L-X		
<b>₹</b> -2		'UNILOCK 'Senzo' Concrete Unit Pavers Size: 20 x 40 x 7 cm Colour: 'Cremo' & 'Nuvola' Pattern: Staggered Running Bond	Ld-XX L-X	1-9			Sodded Lawn (at Great Lawn on Podium)  No-Mow Gasses w/ Step-stones (at South-West Rock Gardens)			Ld-XX L-X	
(T-3)		'UNILOCK 'Senzo' Concrete Unit Pavers Size: 20 x 40 x 7 cm Colour: 'Cremo' & 'Nuvola' Pattern: Staggered Running Bond	Ld-XX L-X	(T-10)	^^^^	^^^ ^^^ ^^^	Extensive Green Roof Assembly			Ld-XX L-X	
(T-4)		Decorative River Rock Size: 10-20 cm Colour: Ebony Black Supplier: Northwest Landscape & Stone	Ld-XX L-X			)	Proposed Trees   7cm calliper minimum (Refer to L-2 Planting List)		L-X L-X		
<b>1-5</b>		lpe Wood Deck Assembly	Ld-XX L-X		Proposed Multi-stem Trees   3m ht. min (Refer to L-2 Planting List)			Ld-XX L-X			
<b>T-6</b>		Decomposed Granite Crush & Stone Fines Size: 1/2" minus Colour: Cream/Tan/Brown	Ld-XX L-X		Existing Trees to be Retained w/ CRZ Protection & Excavation Buffer (Refer to Arbourist Report for Full Demo/Protection)						
<b>(1-7)</b>		Basalt Bulk Boulders Size: 10"-15" (30-70lbs) & 20"-24" (250-500lbs) Supplier: Northwest Landscape & Stone Supply	Ld-XX L-X	LIGHT	ING	<u></u>	Wall Mounted	<del> </del>	Bollard Lighting Spot Lighting	*	In-Grade Lighting Outdoor Strip Lighting

# LANDSCAPE RATIONALE

# GENERAL

The landscape design of the proposed two-property development is comprised of five conceptually distinct yet physically interconnected areas, derived from the basic principles of spatial planning from the Hindu tradition of Vaatsu Shastra. While the practicalities of devleopment requirements provide some contraint to the ideal spatial arrangement of various project element, largely the development as a whole still responds to the foundational principles as follows:

(West& North) **Air** is reresented through the playful openess of the Park dedication and extended with a publically accessible corridor that allows a continuous flow of pedestrian circulation around the entire site.

(NE & East) The vehicular flow at 196th Ave will be attenuated by a hill of layered planting with shades of blues that speaks to the aspect of **Water** on the site. Given the significant sloping this development encounters, all the water will be directed toward & detained in this area.

(SE & South) The residential streetscape begins here with a progression of street trees in a boulevard (Streetscape Design TBD in conjuntion with CoS). A second row of trees in layered planting on the sloping grade, provides additional shade to the public walk, while privacy hedging helps visually screen ground level windows & attenuate sound. The planting in this area will transition to hues of reds and oranges to reflect the element of **Fire**.

(Centres) Given the slope of the site, the central areas are delineated with a procession of stairs bordered by stepped planters with layered planting in an appropriate colouring. This leads to a large amenity space that is unencumbered by large trees to allow a large amount of sunlight into the open **Space** and a potential for children to play. Some ornamental trees are provided for shade at the seating area, and a water feature is located in the direct centre of each building, to further centre and enhance the restorative quality of this passive space.

(South & SW) These areas provide a grounding to each building through rock gardens. With a distinct shift from the heavy planting through the rest of the site, a mix of grasses and perennials will be used in conjunction with large basalt boulders and large river rocks to anchor the buildings into the **Earth.** Given the significant slope of the site, the units at these corners a partial sunken, as such, appropriate screening & safety measures will be implemented.

# **AMENITY AREAS & PLANTING**

The landscape plan proposes contrasting surface treatments and raised planters to distinguish private patios from shared pathways and amenity spaces. Much attention has been paid to the comfort of residents & visitors (both in immediately noticable physical features as well as those that may perhaps be subconsiously registered). This design will continue to evolve to further refine all usable spaces of this site, and so we request both trust and input in the continued development of the grading, planting design, lighting design, and parklette design development.


The plant list (Refer to L-2) currently reflects a preliminary selection of the plant material to be used on the site. The plant selection is a mixture of both native and other species, from ornamental grasses to flowering shrubs and trees, creating an attractive and vivid environment. However, apart from the Trees (which will affect the streetscape) quantities and a detailed planting plan are not given as further consideration is required to provide a considered approach to a somewhat complex design. We would like the transitions of the colour palette around the site (as dictated by the principles of Vaatsu, Refer to indicative massing on L-3) to not only be smooth when all flowering perennials are in bloom, but also to emphasize and accentuate the appropriate areas through different seasons.

Rooftop urban agriculture gardens are located to recieve full sun, and are a key feature of the development, as edible planting is an important aspect of Vaatsu. Indicated as large pre-fabricated metal planters with potting tables, tool storage, & hose bibs, they will be maintained by Strata.

# CEPTED & ASPECT

Safety is one of our biggest concerns & attention has been paid to physical comfort and use of the outdoor spaces past dusk. In addition to architectural lighting at outdoor amenities, a generous amount of step lighting has been added to provide wayfinding at the paths, and various amounts of accent lighting has been provided to add animation and comfort to the various amenity spaces and mass plantings. In addition, some measure of fencing has provided where necessary to deliniate and create defensible space for residents (Refer to L-8 Lighting & Fencing Plan)

The sun aspect has been studied to determine areas of shade throughout the year that may affect planting. All planting has taken the sun position into consideration. Appropriate buildups & maintencen will be provided to ensure a high quality finished product

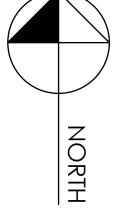

05
 04 Jun 14, 2018 Issued for ADP
 03 Jun 08, 2018 Issued for DRG Review
 02 May 25, 2018 Re-Issued for DP

01 Mar 06, 2018 Issued for Rezoning/DP no.: | date: | item:

Revisions:

Durante Kreuk Ltd. 102 - 1637 West 5th Avenue Vancouver BC V6J 1N5 t: 604 684 4611 f: 604 684 0577 www.dkl.bc.ca

Project:

6529 196th Street, Surrey, BC

Checked by: PK

Date: January 30, 2018

Scale: 3/32" = 1'-0"


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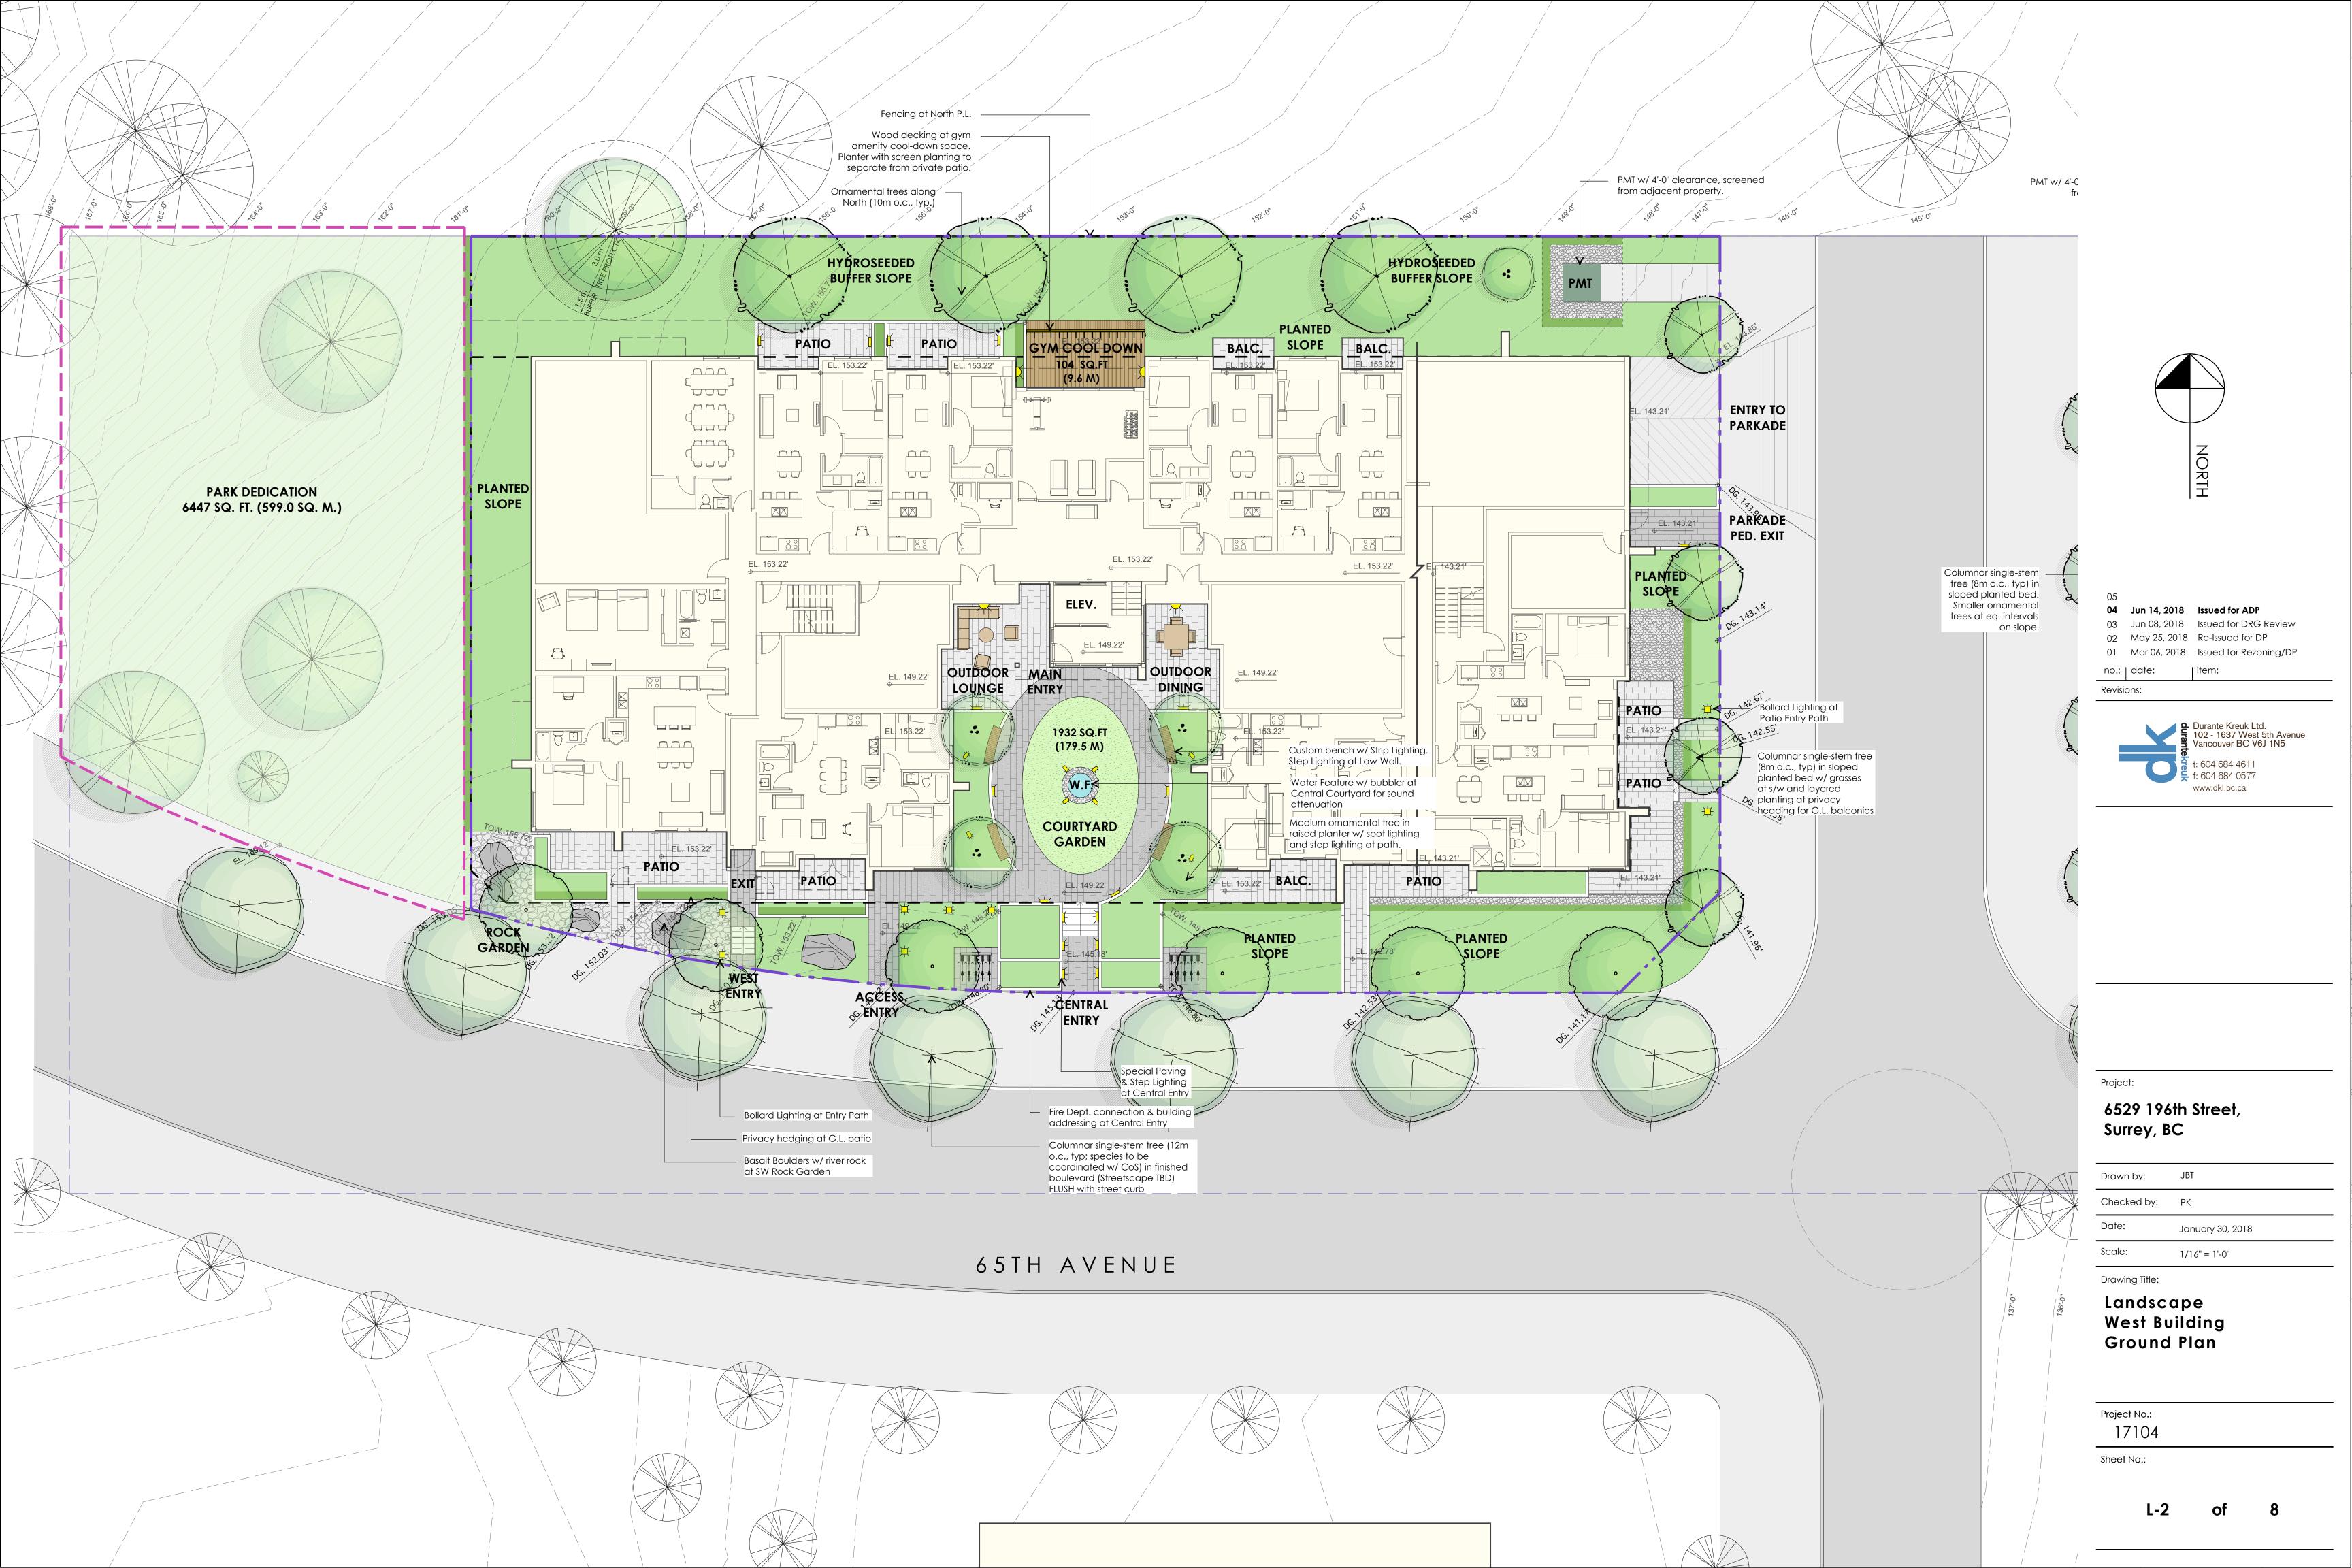
Landscape Overall Site Plan


Project No.: 17104


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04 Jun 14, 2018 Issued for ADP 03 Jun 08, 2018 Issued for DRG Review 02 May 25, 2018 Re-Issued for DP 01 Mar 06, 2018 Issued for Rezoning/DP


> Durante Kreuk Ltd. 102 - 1637 West 5th Avenue Vancouver BC V6J 1N5 : 604 684 4611 f: 604 684 0577 www.dkl.bc.ca


# 6529 196th Street,

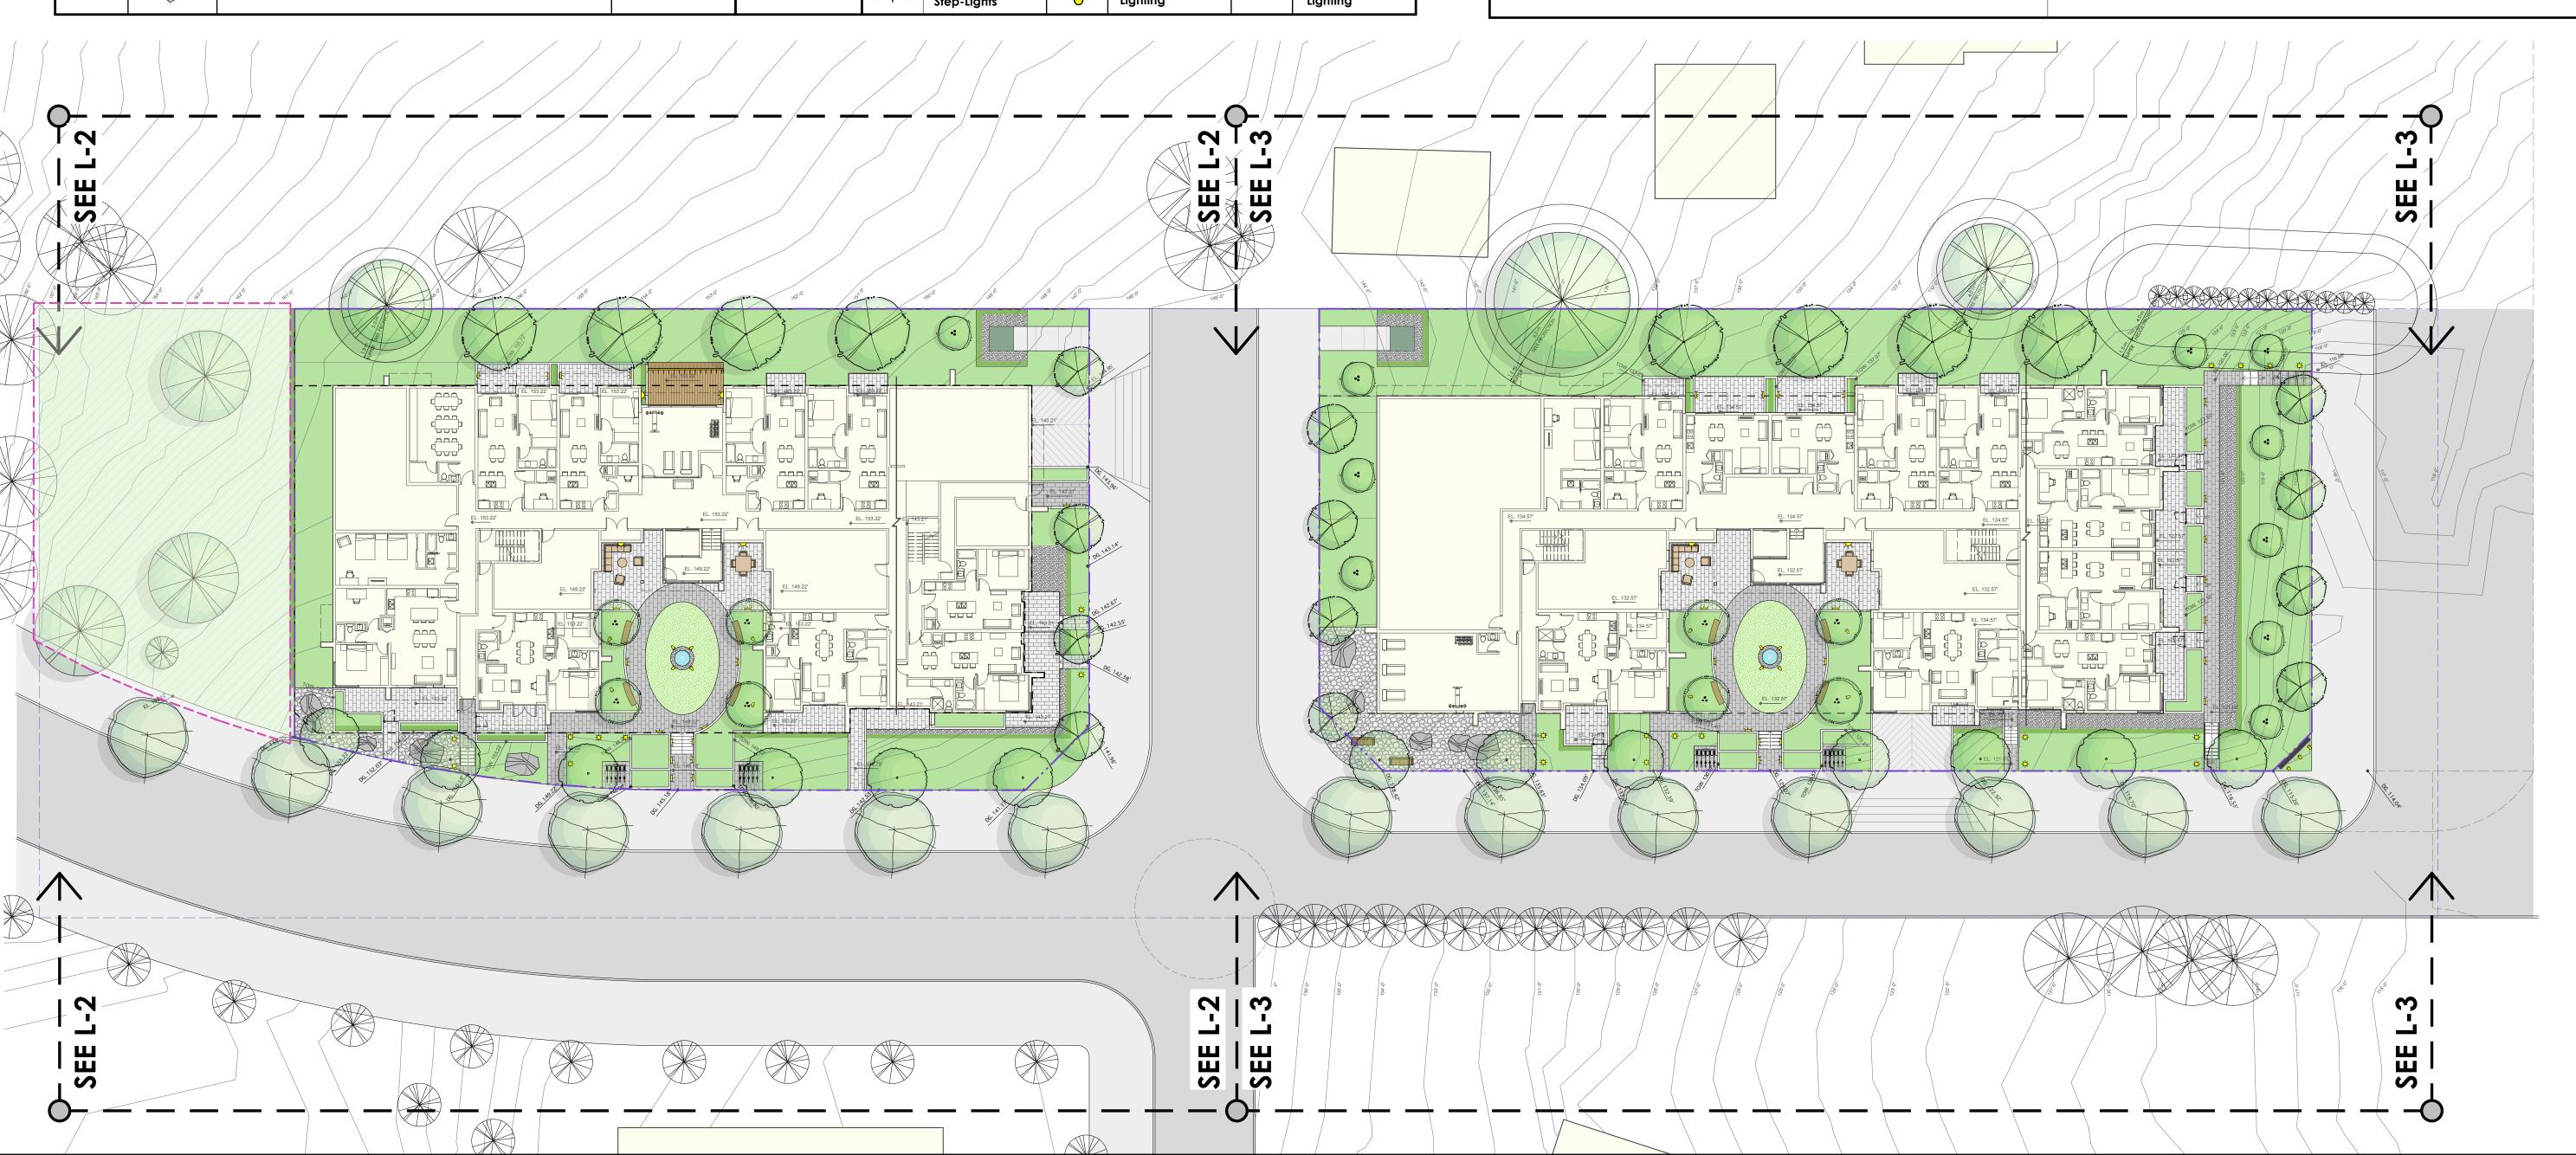Drawn by: JBT Checked by: PK January 30, 2018

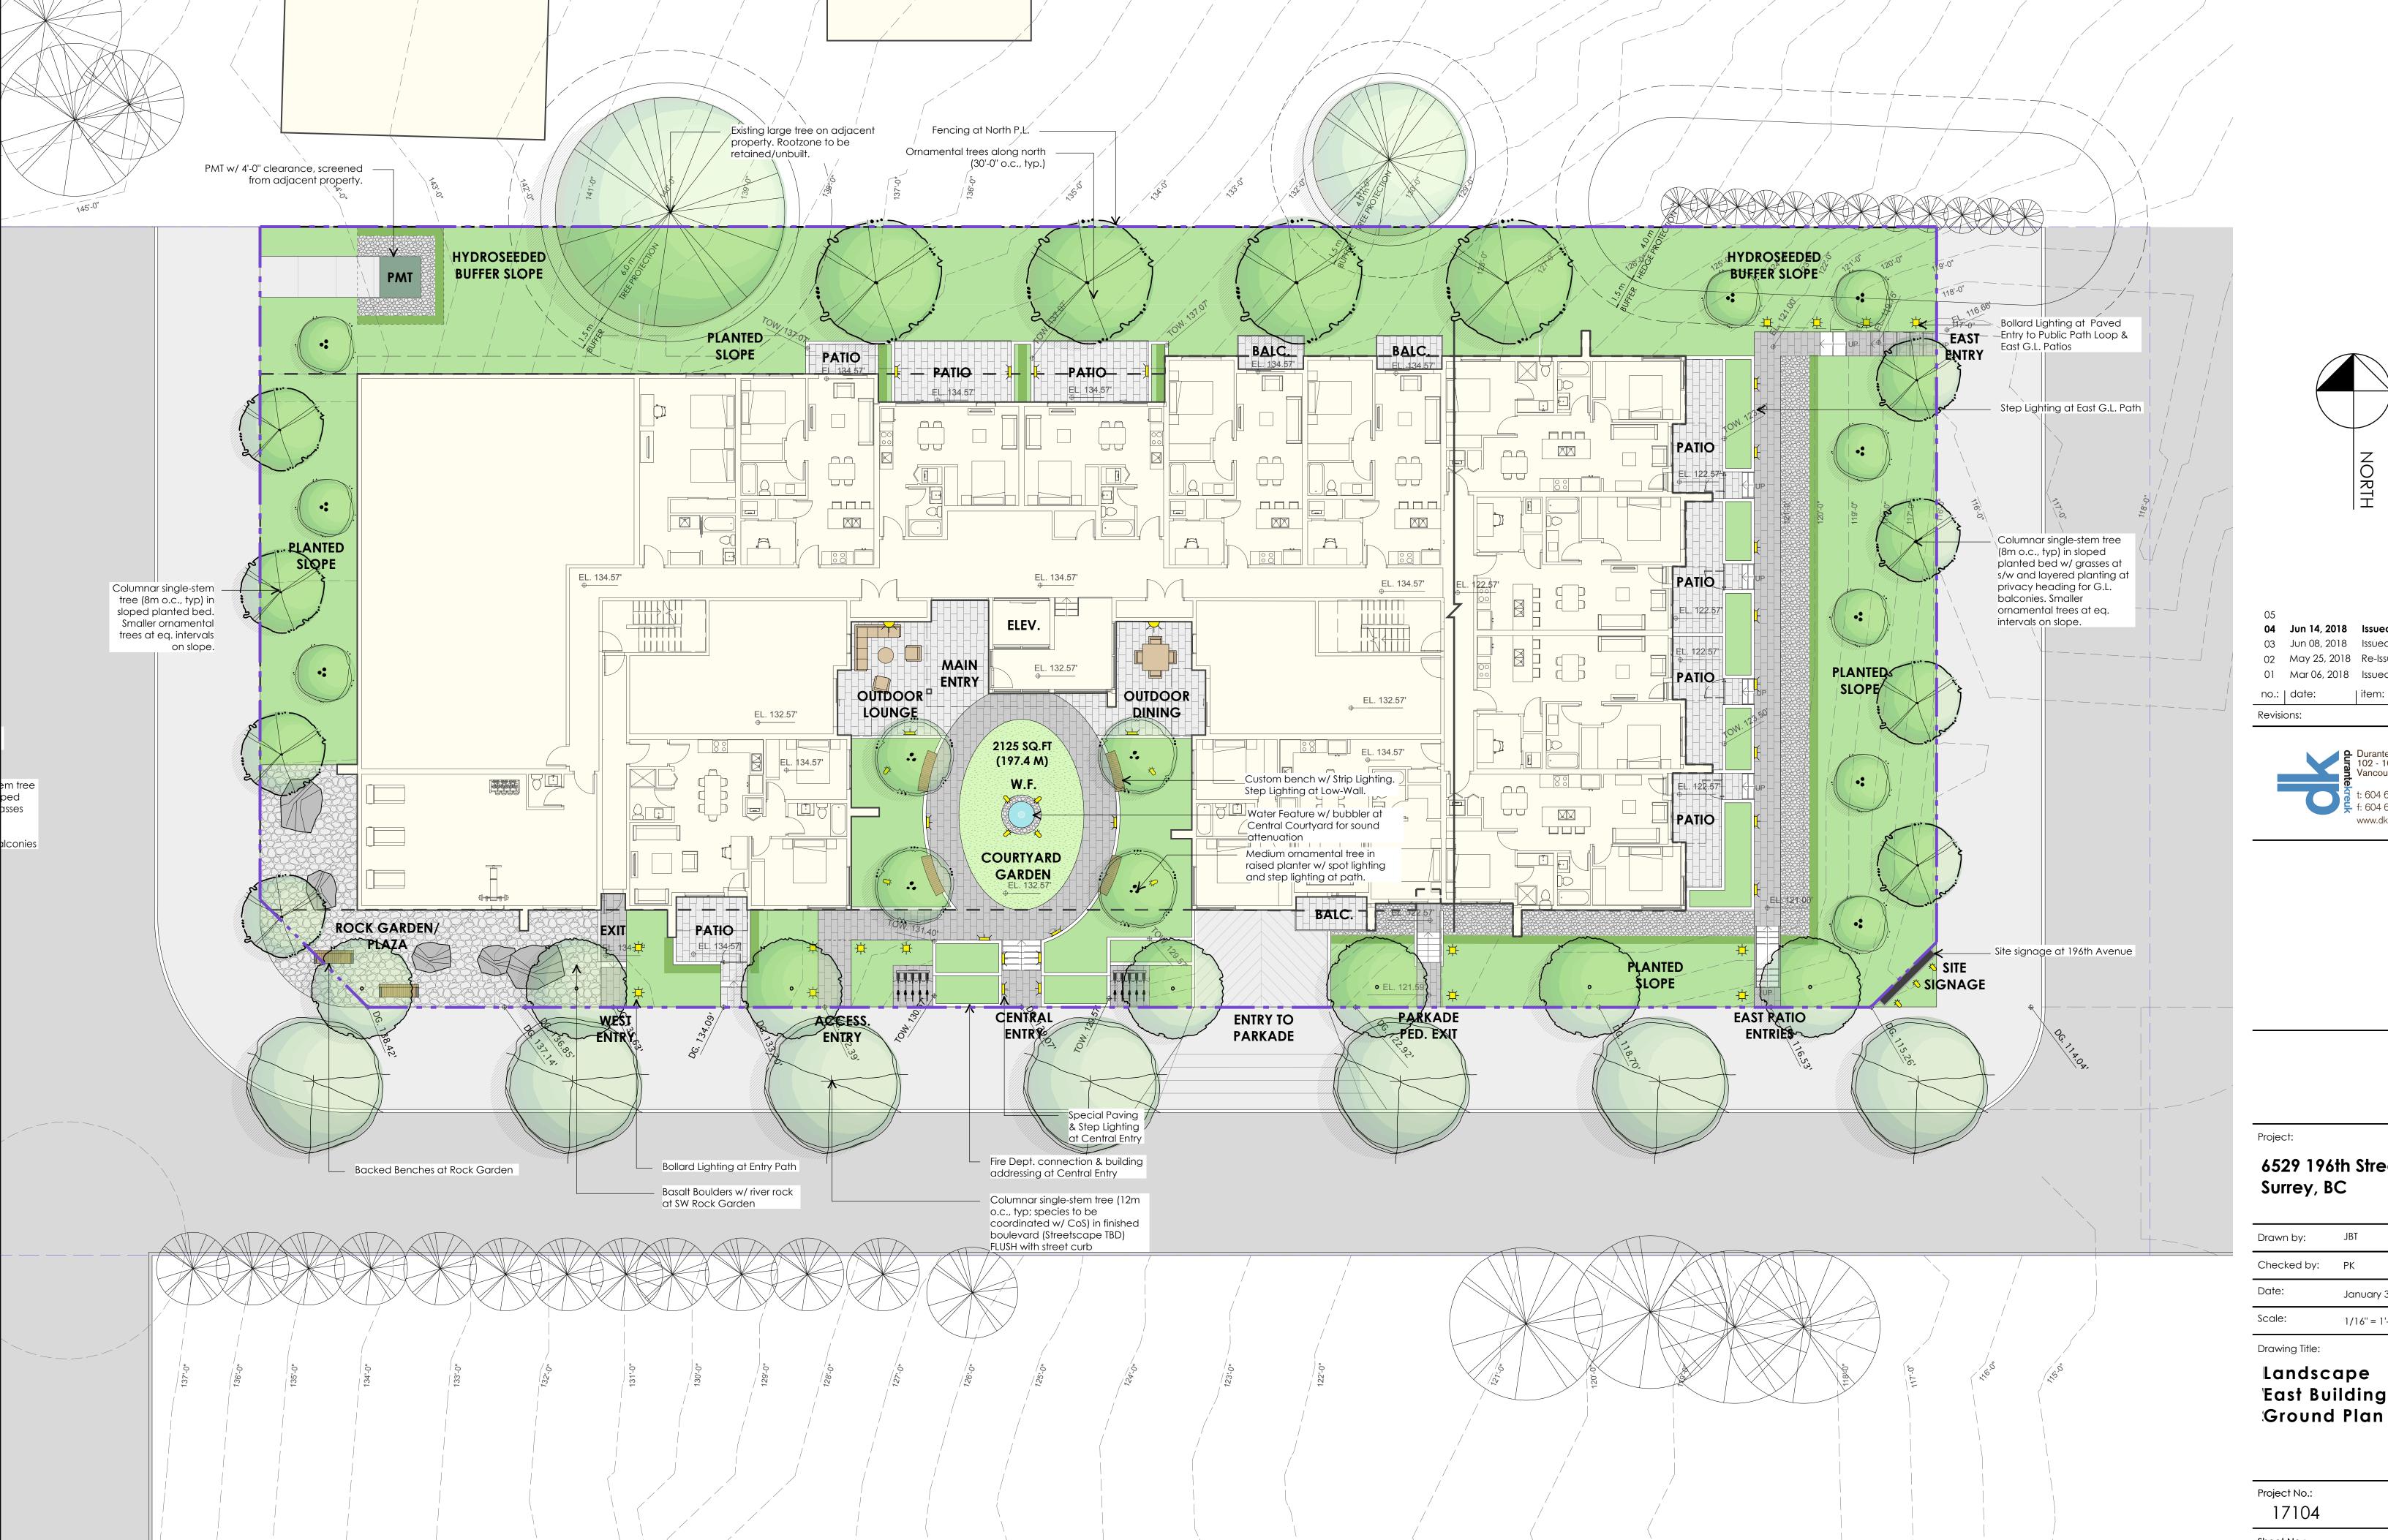1/16" = 1'-0"
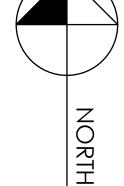
# Landscape **East Building**

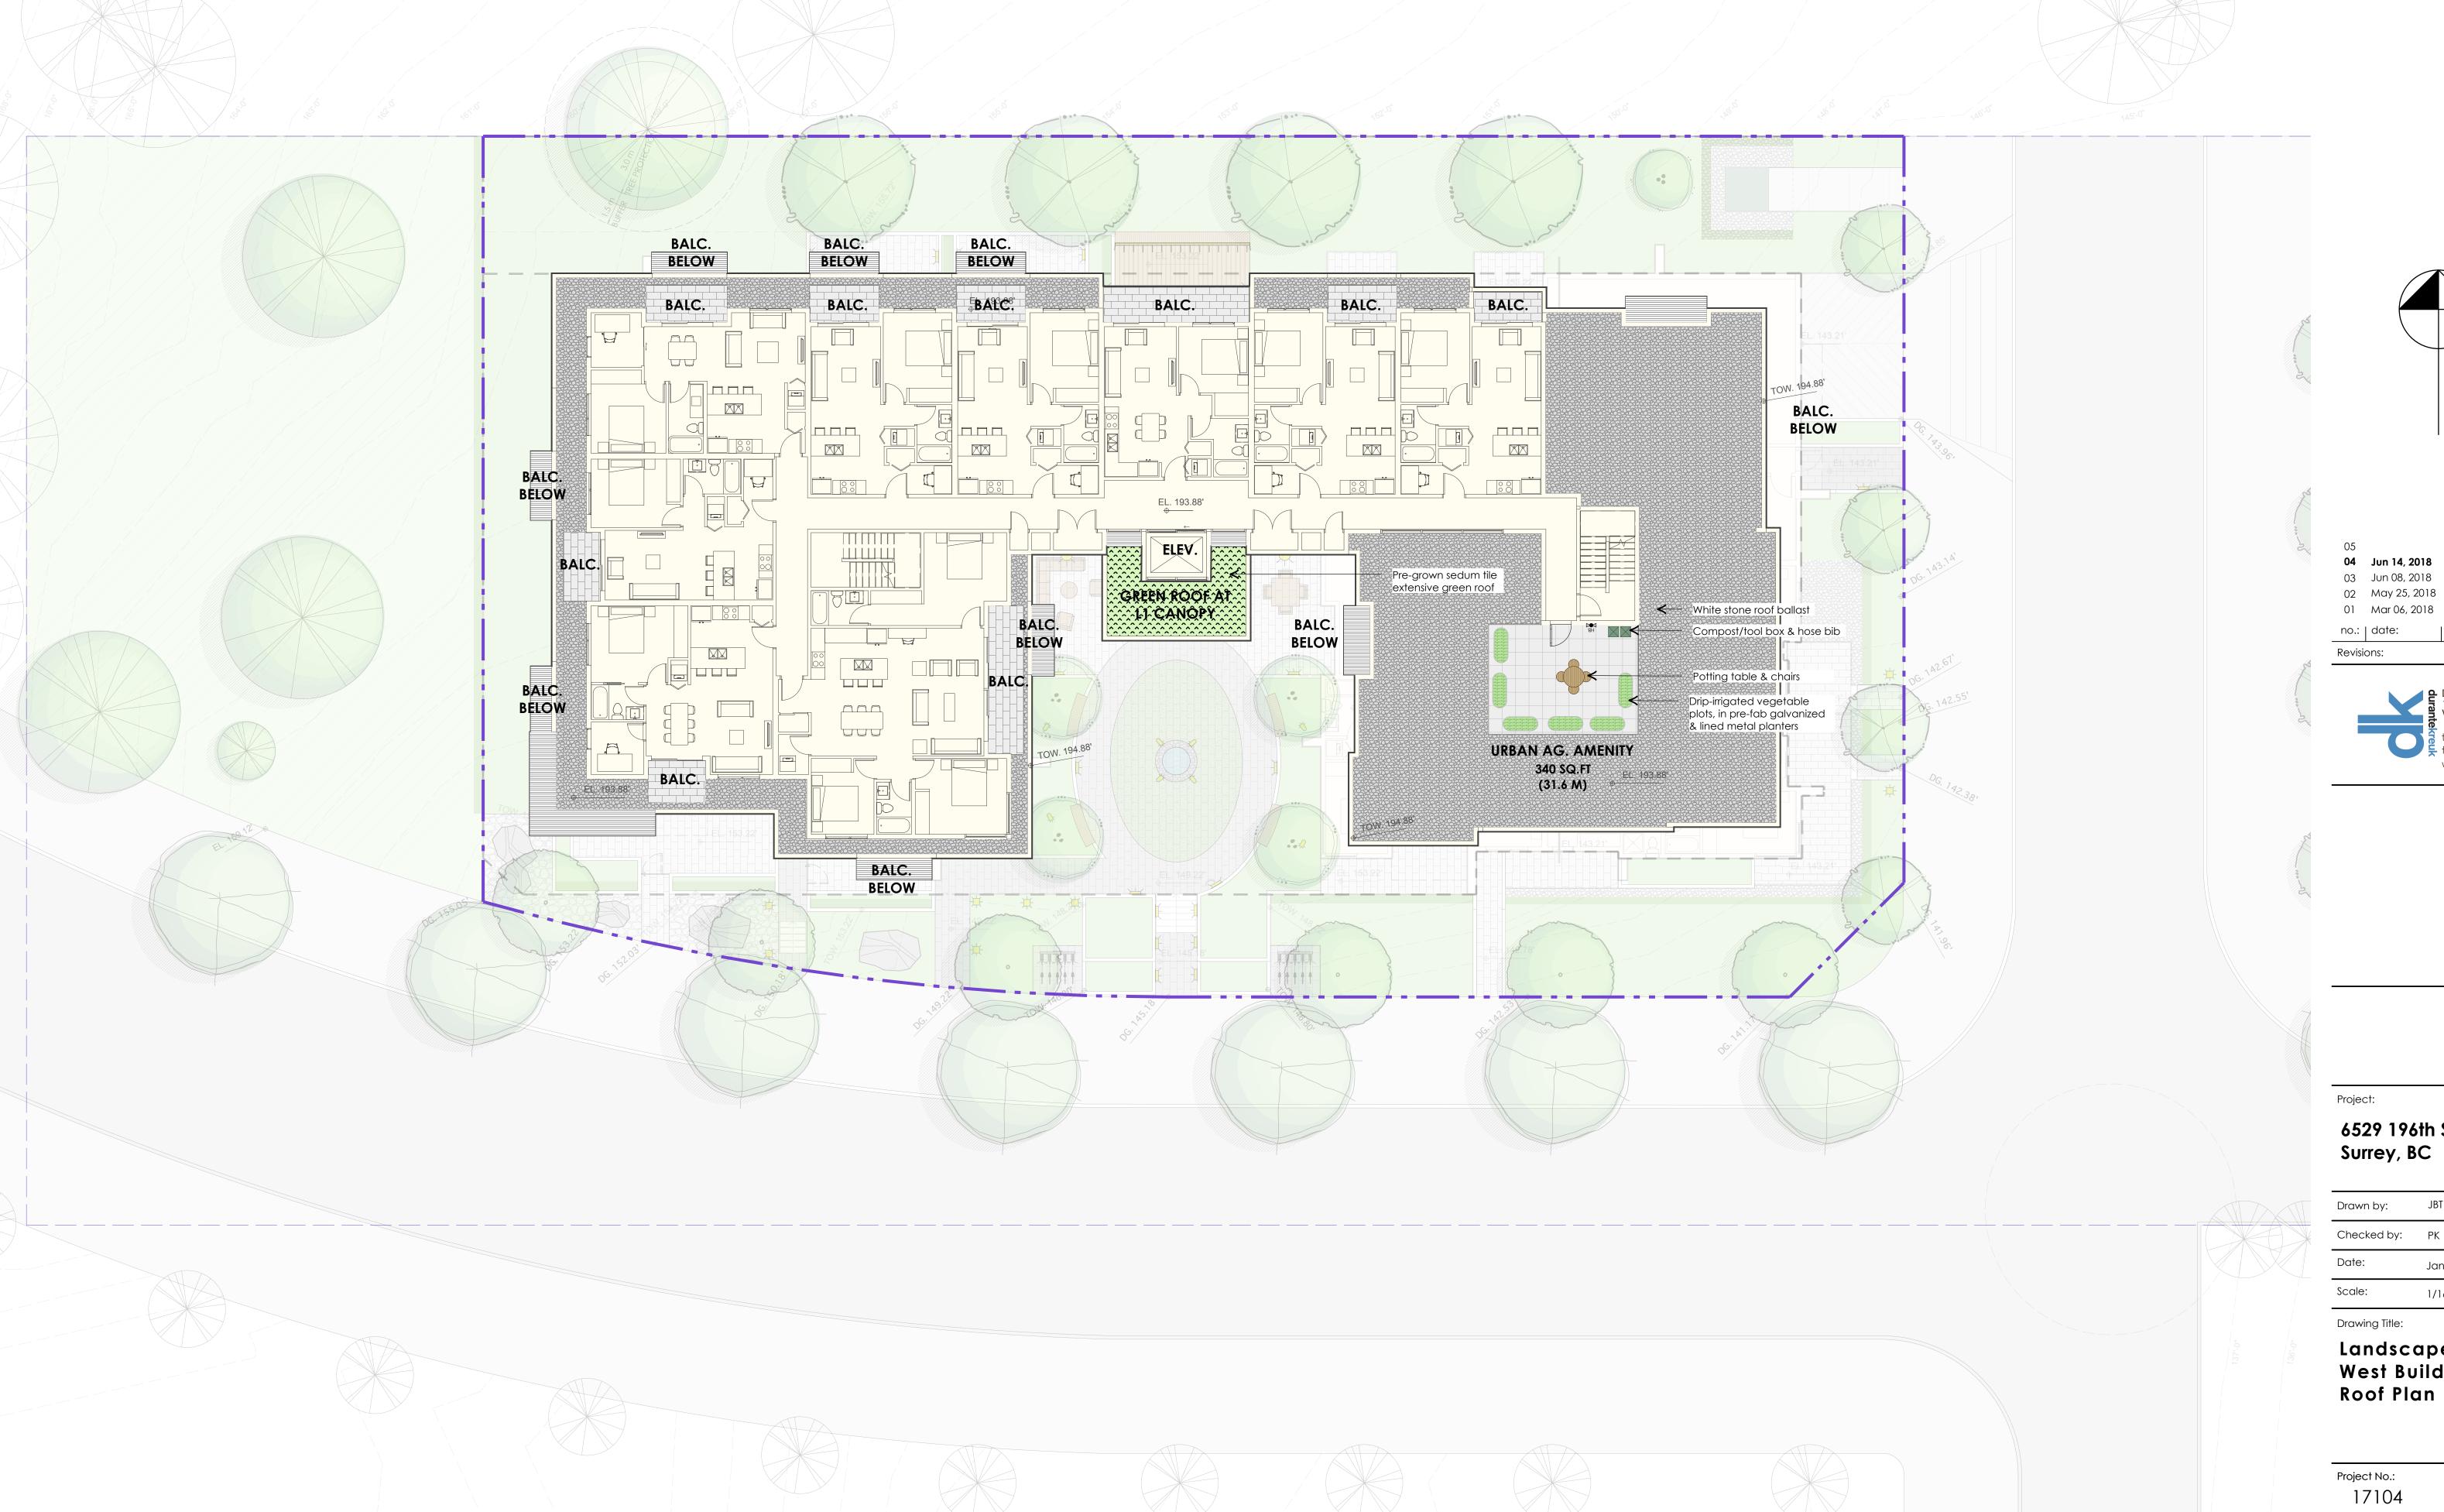

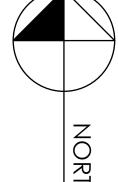

04 Jun 14, 2018 Issued for ADP 03 Jun 08, 2018 Issued for DRG Review 02 May 25, 2018 Re-Issued for DP 01 Mar 06, 2018 Issued for Rezoning/DP





6529 196th Street, Surrey, BC

Drawn by: JBT Checked by: PK January 30, 2018

1/16" = 1'-0"

Landscape West Building

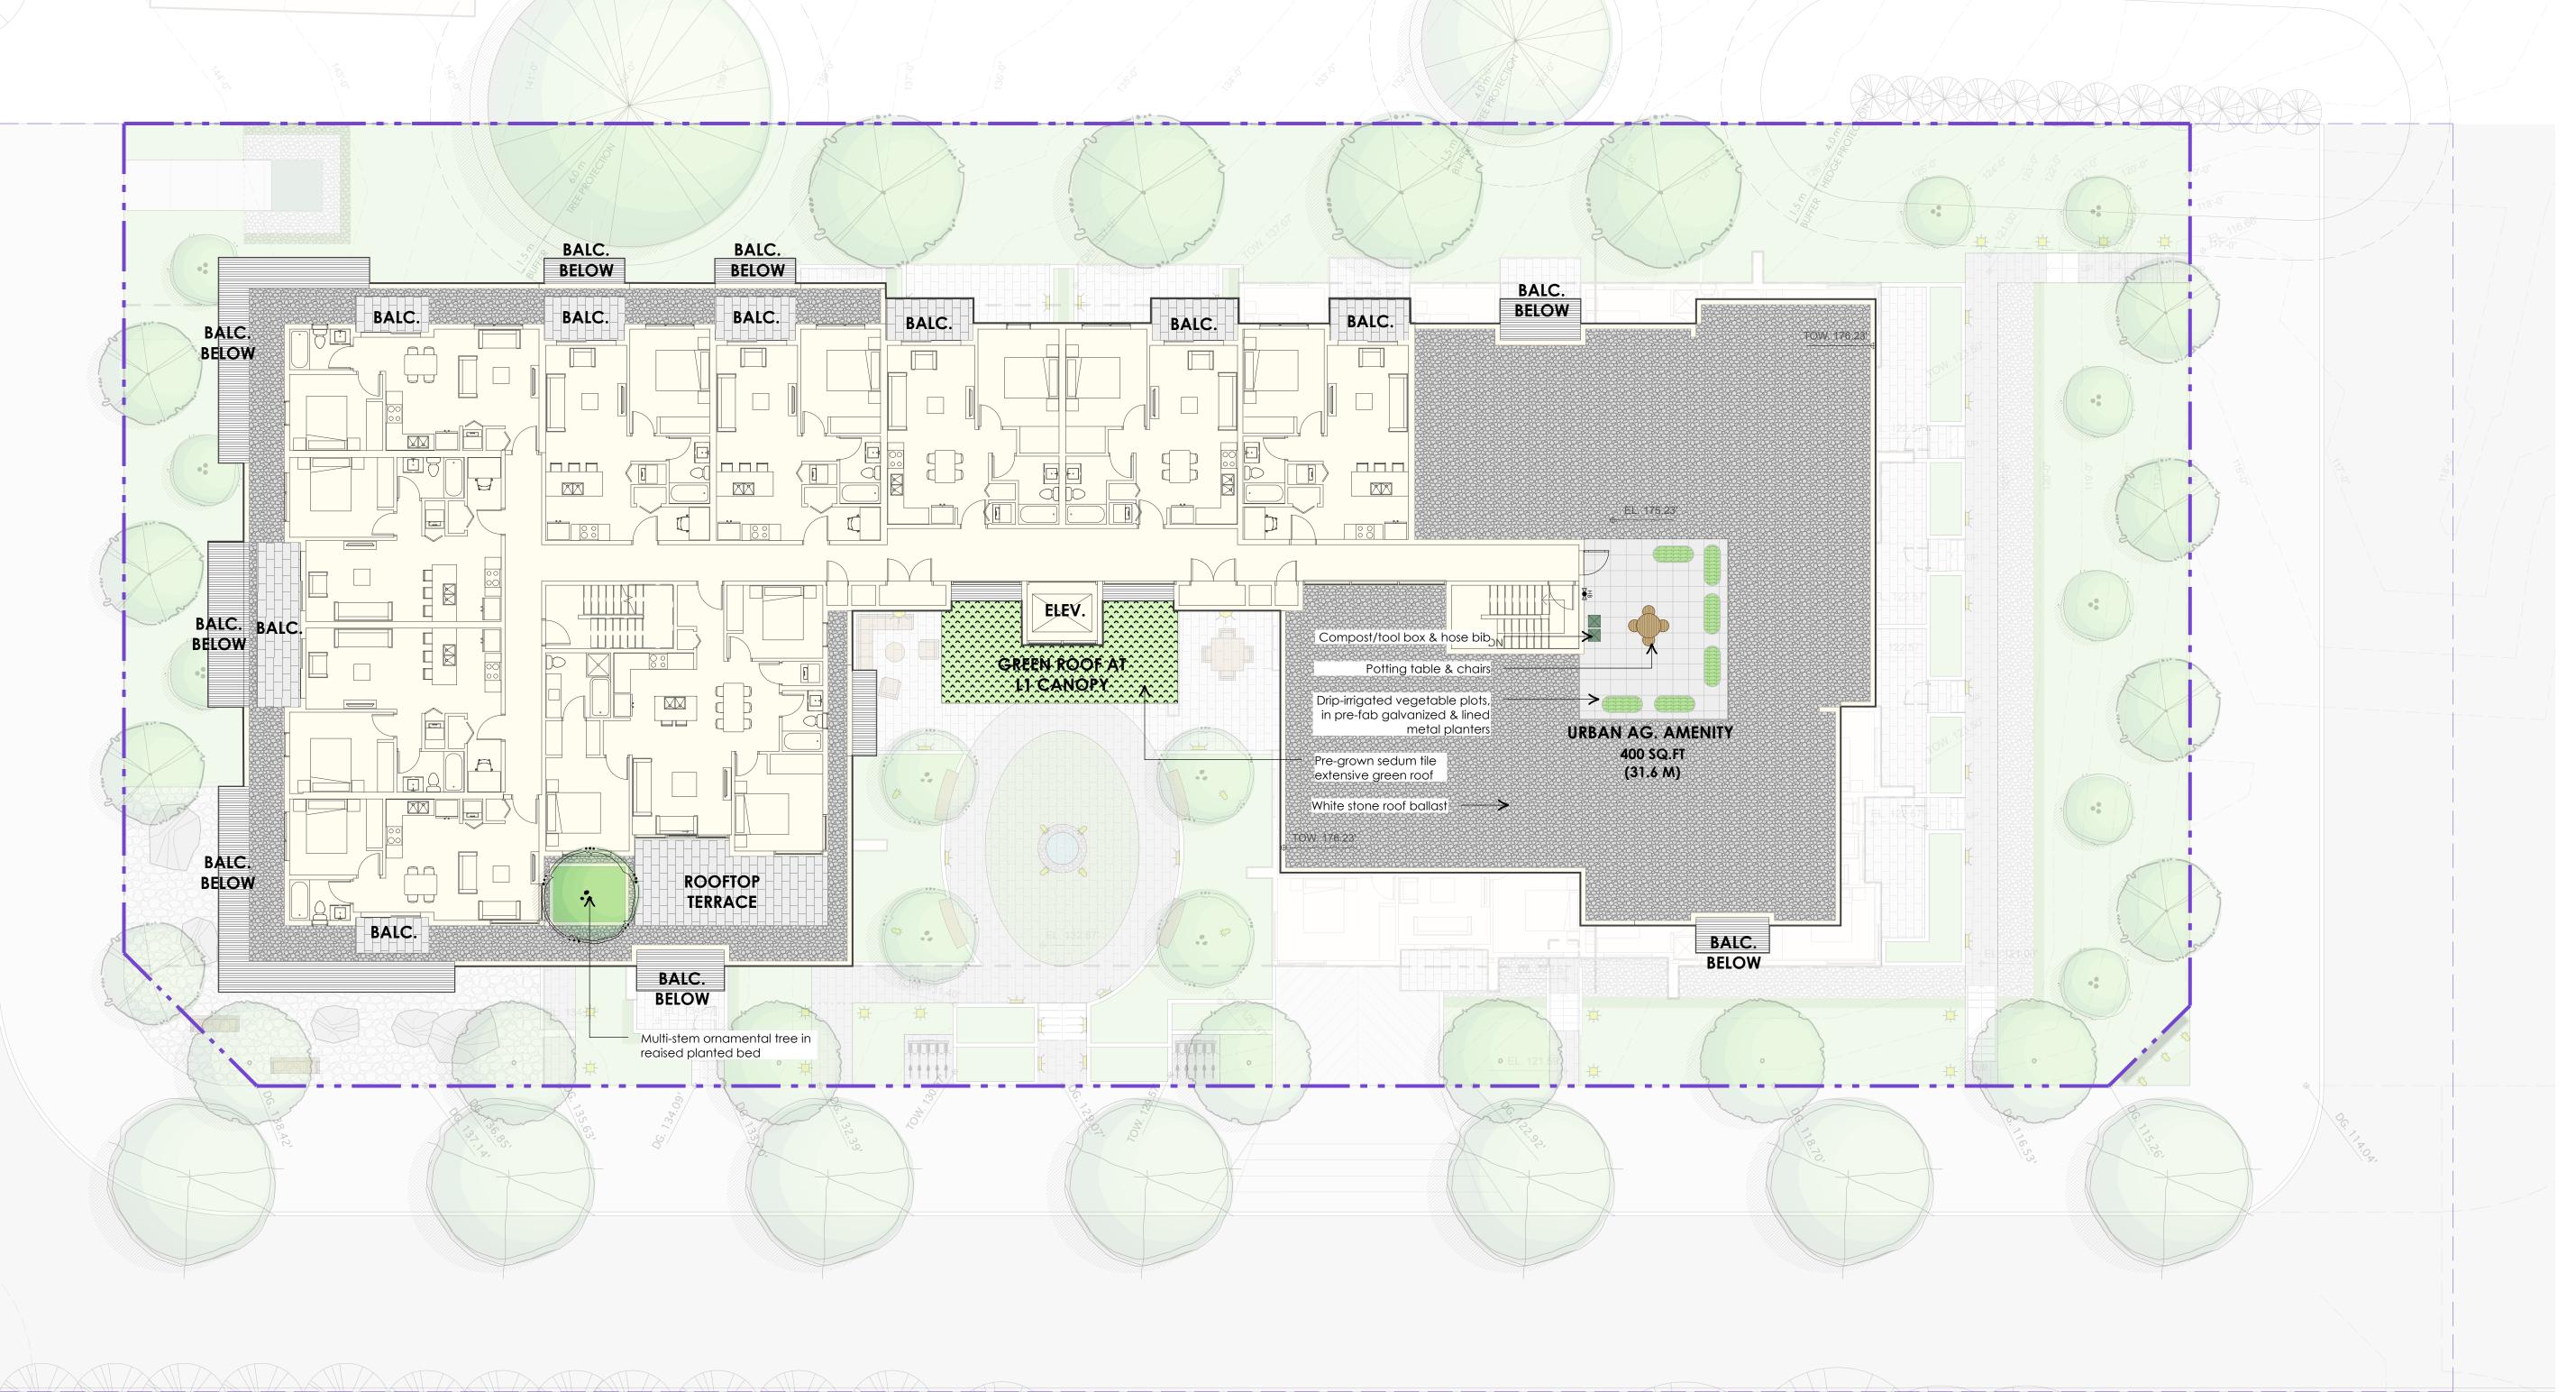

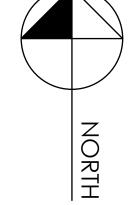

04 Jun 14, 2018 Issued for ADP 03 Jun 08, 2018 Issued for DRG Review 02 May 25, 2018 Re-Issued for DP 01 Mar 06, 2018 Issued for Rezoning/DP

Revisions:



Project:

# 6529 196th Street, Surrey, BC


Drawn by: JBT Checked by: PK Date: January 30, 2018

Scale: 1/16" = 1'-0"

Drawing Title:

# Landscape **East Building** Roof Plan

Project No.: 17104

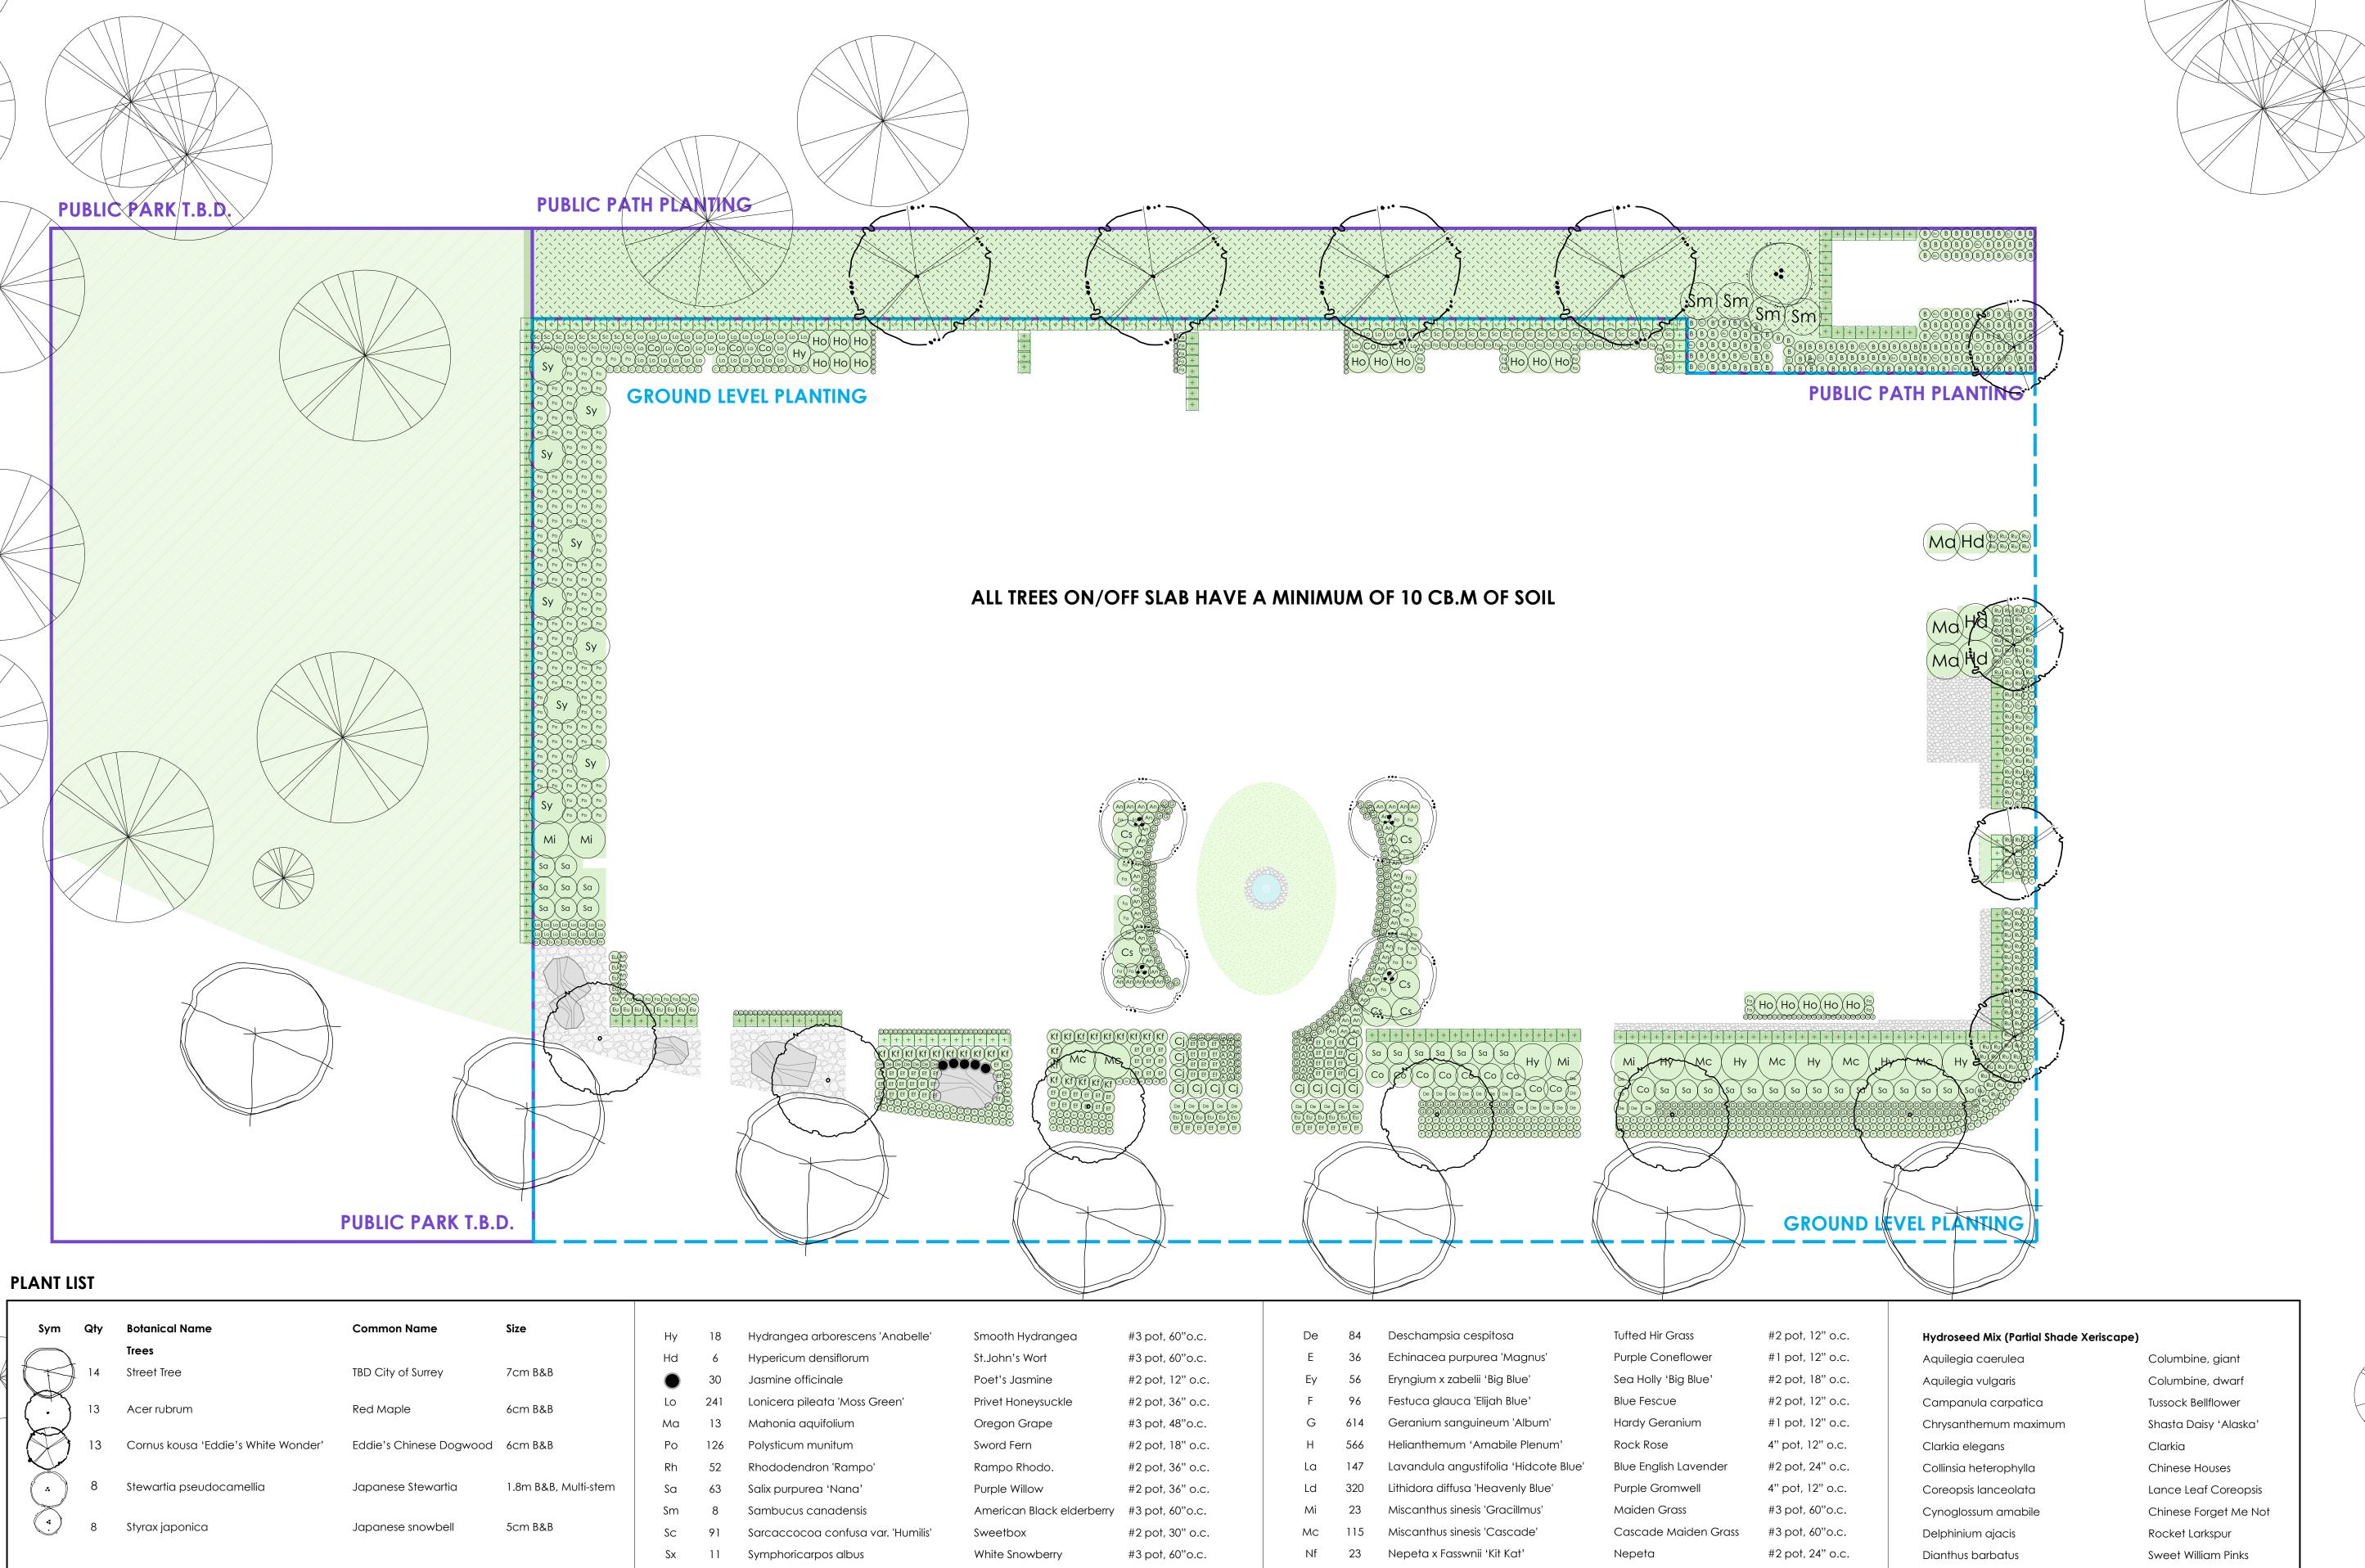

Syringa pubescens 'Miss Kim'

Perennials/Groundcover/Grasses

Agastache foeniculum 'Blue Fortune'

Calamagrotis x acutiflora 'Karl Foerster'

Agipanthus africanus 'Big Blue'

Armeria maritima "Splendens"

Carex oshimensis 'Evergold'

Taxus media x Hicksii

#3 pot, 48" o.c.

#3 pot, 48" o.c.

#3 pot, 36" o.c.

#2 pot, 14" o.c.

#2 pot, 24" o.c.

#2 pot, 24" o.c.

#2 pot, 24" o.c.

#2 pot, 36" o.c.

Camellia

Blood twig Dogwood

Red-Osier Dogwood

Rose Daphne

Fireglow Spurge

Japanese Aralia

Dwarf Spurge

Hosta

Shrubs/Ferns

Camellia japonica

Cornus sericea 'Cardinal'

Euphorbia griffithii 'Fireglow'

Euphorbia wulfenii 'Shorty'

Fatsia japonica

Cornus sanguinea 'Midwinter Fire'

Daphne cneorum 'Ruby Glow'

Hosta Tardiana Group 'Halcyon'

Manchurian lilac

Hicks Yew Hedge

Blue Lily of the Nile

Feather Reed Grass

Evergold Sedge

Giant Hyssop

Thrift

#3 pot, 60"o.c.

#2 pot, 18" o.c.

#2 pot, 18" o.c.

#2 pot, 12" o.c.

#2 pot, 24" o.c.

#2 pot, 12" o.c.

4' ht., B&B; RB-to-RB

Nepeta 'Six Hills Giant'

Potentilla tridentina 'Nuuk'

Ocimum basilicum

Rudbeckia hirta

100

Giant Nepeta

Black-eyed Susan

Sweet Basil

Cinquefoil

#2 pot, 24" o.c.

#21 pot, 18" o.c.

4" pot, 12" o.c.

#2 pot, 18" o.c.

Echinacea purpurea

Gypsophila elegans

Iberis umbellata


Papaver rhoeas

Viola tricolor

Linaria maroccana


Nemophila menziesii

Eschscholzia californica

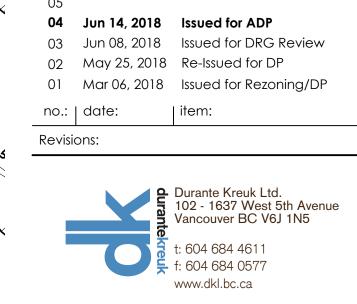

Project:

6529 196th Street, Surrey, BC

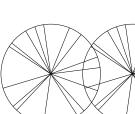

Purple Coneflower

California Poppy

Spurred Snapdragon

Baby's Breath

Baby Blue Eyes

Johnny Jump-Ups

Corn Poppy

Candytuft

Drawn by: JBT

Checked by: PK

Date: January 30, 2018

Scale: 1/16" = 1'-0"

Drawing Title:


Landscape West Building Planting Plan


Project No.: 17104

Sheet No.:

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03 Jun 08, 2018 Issued for DRG Review 02 May 25, 2018 Re-Issued for DP 01 Mar 06, 2018 Issued for Rezoning/DP

Revisions:

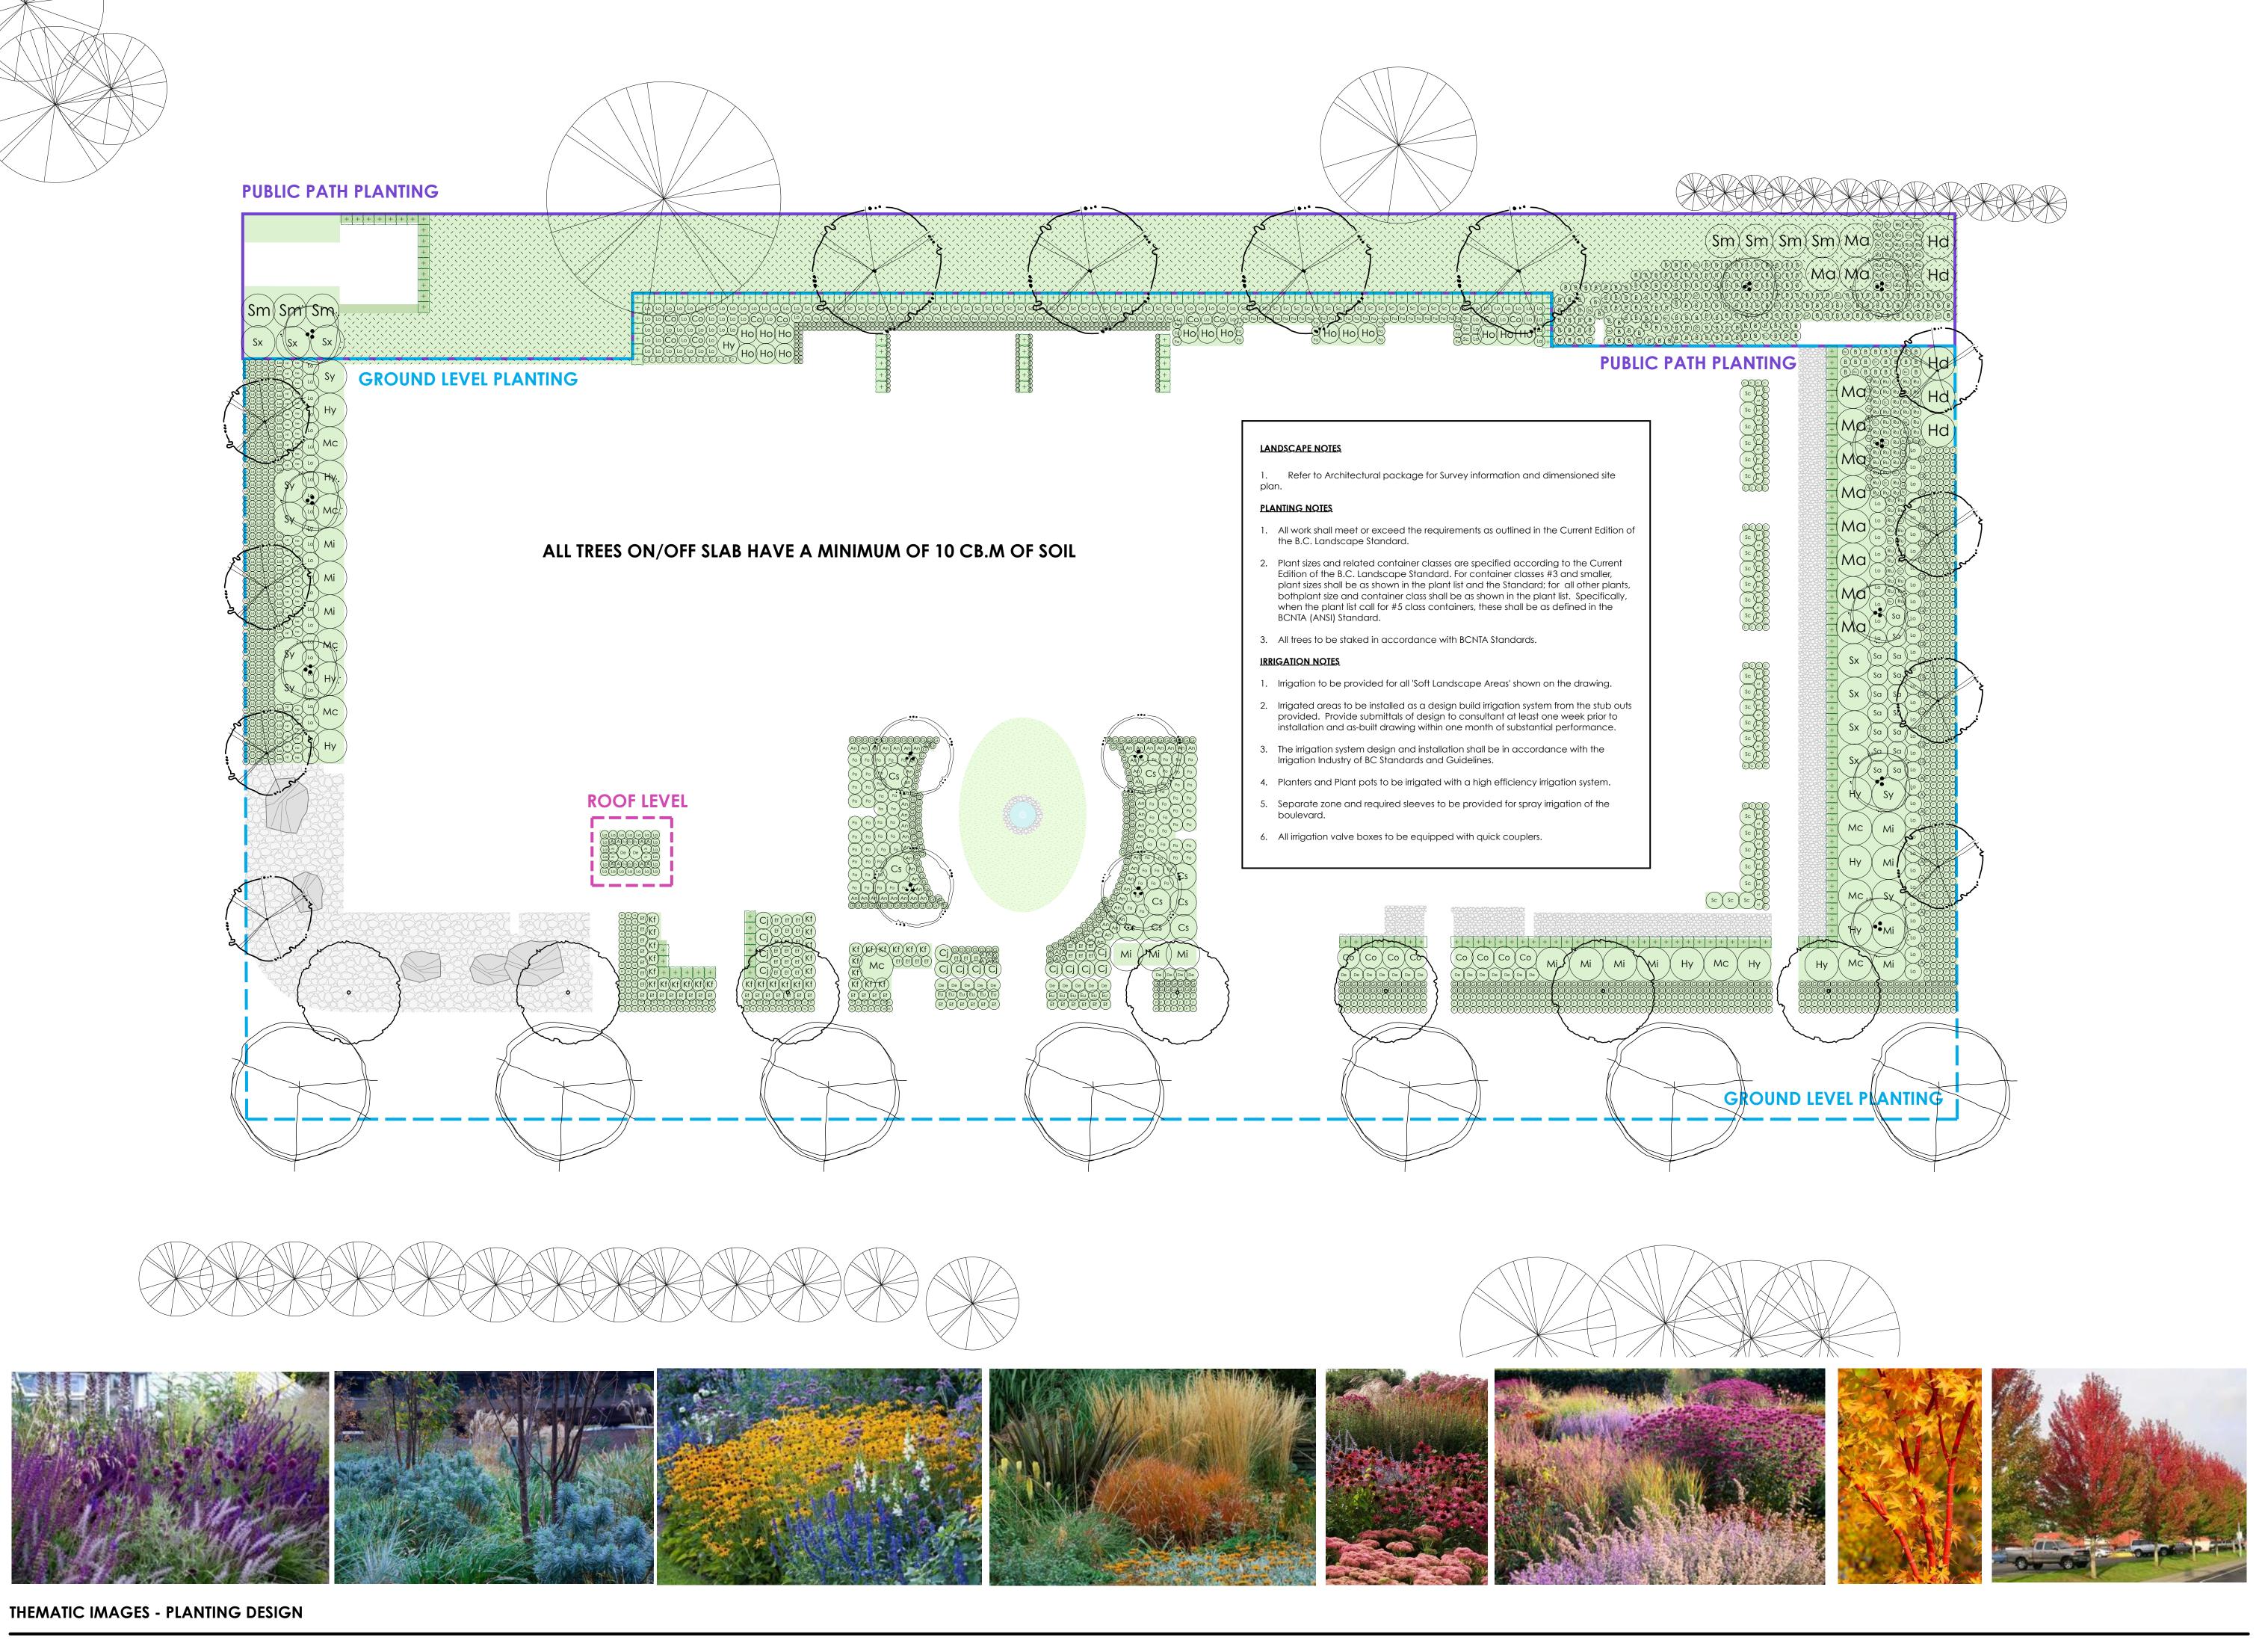Durante Kreuk Ltd. 102 - 1637 West 5th Avenue Vancouver BC V6J 1N5 www.dkl.bc.ca

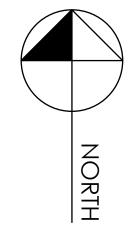Project:

6529 196th Street, Surrey, BC

Drawn by: JBT Checked by: PK


January 30, 2018

Scale: 1/16" = 1'-0"

Drawing Title:

Landscape **East Building** Roof Plan

Project No.: 17104

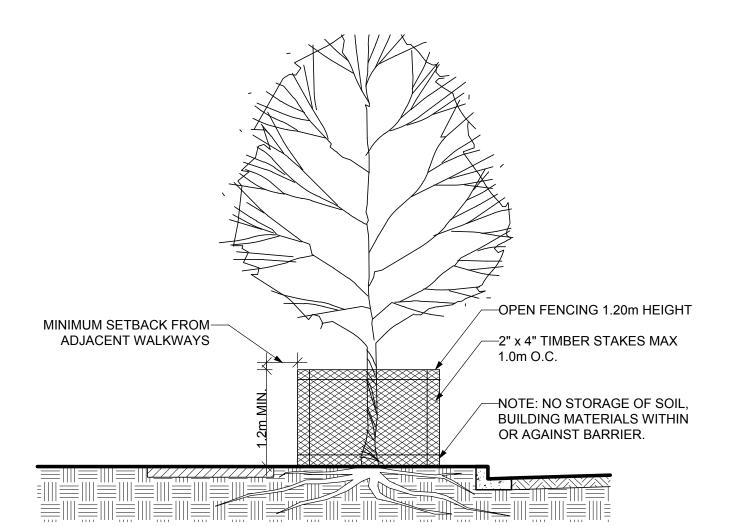


# SCHEDULE A - TREE PROTECTION BARRIER TREE PROTECTION DISTANCE TABLE TRUNK DIAMETER | MINIMUM DISTANCE FROM TRUNK (METERS)


TREE PROTECTION BARRIERS MUST BE AT LEAST 1.20m IN HEIGHT AND CONSTRUCTED OF EITHER SNOW FENCING SECURELY FASTENED TO 2x4 TIMBER STAKES, OR METAL STAKES SPACED NO FURTHER THAN 1.00m APART.




# TREE PROTECTION BARRIER FENCING

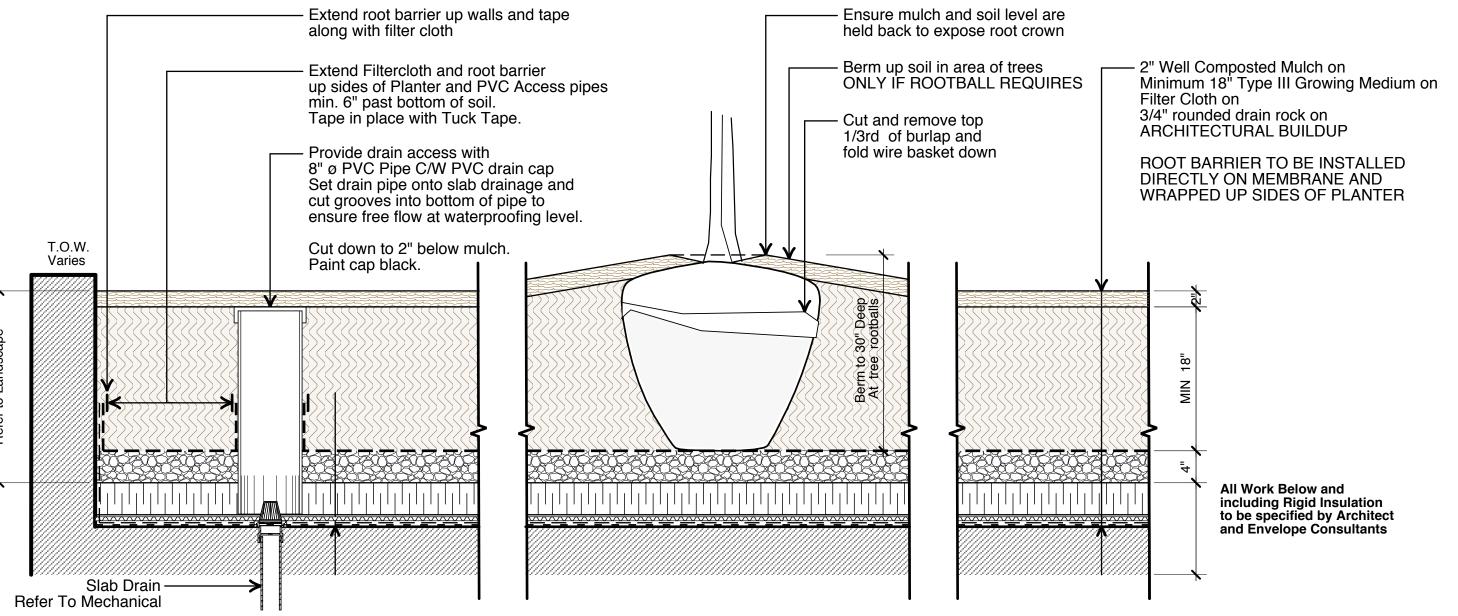



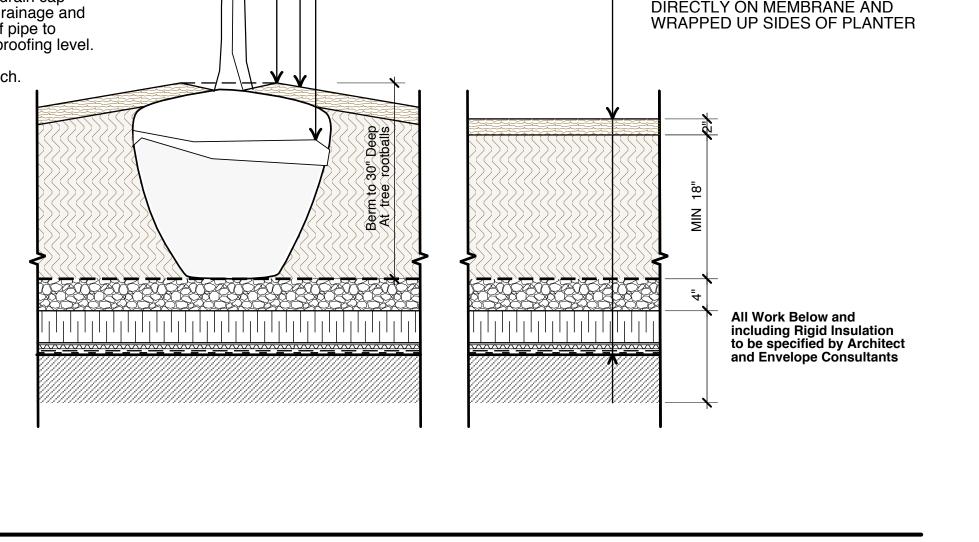

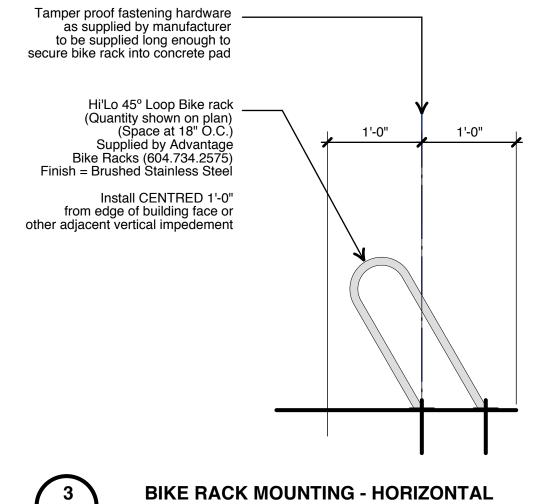

- TYPE B1-1 Bench

Colour = Black

In Ground Mount

By Frances Andrew

12" Diameter sonotube footing

set below grade on ARCHITECTURAL BUILDUP





04 Jun 14, 2018 Issued for ADP


02 May 25, 2018 Re-Issued for DP

03 Jun 08, 2018 Issued for DRG Review

01 Mar 06, 2018 Issued for Rezoning/DP

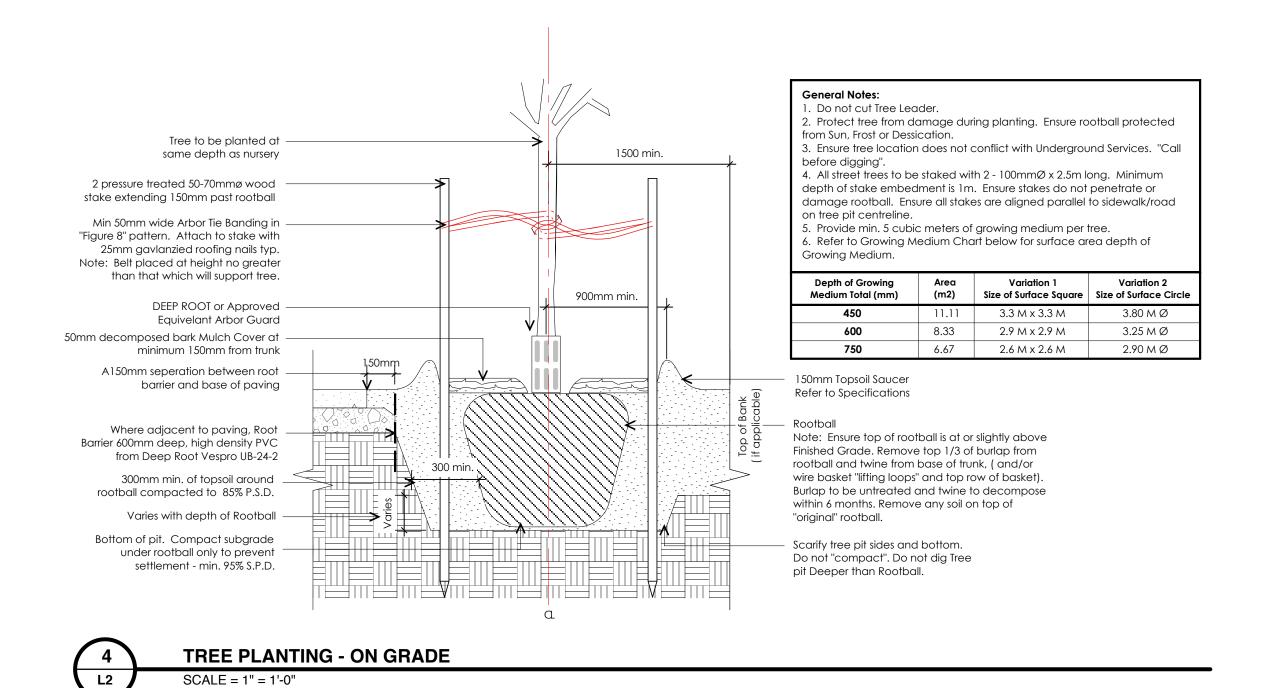

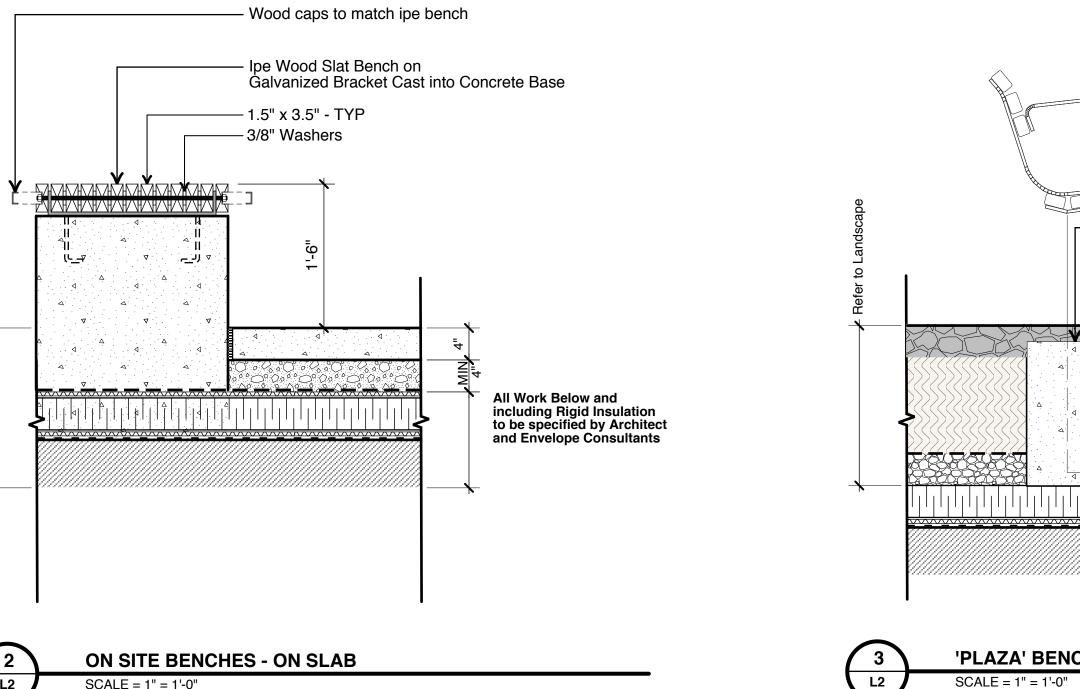

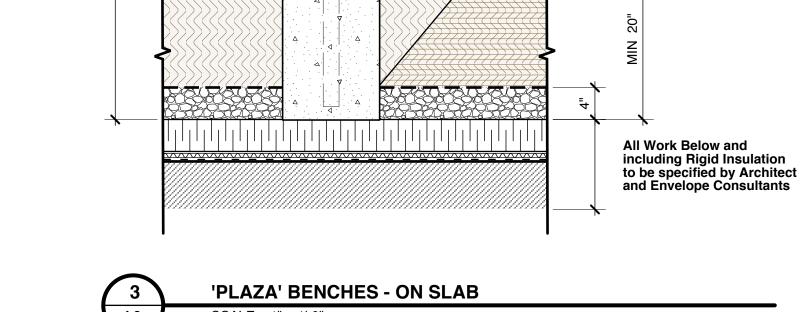

Project:

6529 196th Street, Surrey, BC

Drawn by: JBT Checked by: PK Date: January 30, 2018

Scale: As Noted-0"

Drawing Title:

Landscape **Preliminary Details** 

Project No.: 17104



May 29, 2018

Planning

## THE IMPACT ON SCHOOLS APPLICATION #:

### SUMMARY

The proposed 154 lowrise units are estimated to have th on the following schools:

# Projected # of students for this development:

Elementary Students:	8
Secondary Students:	8

# September 2017 Enrolment/School Capacity

atimer Road Elementary	
nrolment (K/1-7)	

74 K + 401 Operating Capacity (K/1-7) 38 K + 442

# Clayton Heights Secondary Enrolment (8-12):

1406 Capacity (8-12): 1000

# School Enrolment Projections and Planning Update:


The following tables illustrate the enrolment projections (with current/approved ministry capacity) for the elementary and secondary schools serving the proposed development.

Latimer Road enrolment has been significantly growing over the last 3 years because of a boundary change in 2015 which started to move new families in the area from Katzie elementary to Latimer Road. The effects of the boundary change have increased the upward growth curve in the 10 year projection trend from last years projection of 559 to this years 693 in 2027. Moreover, in 2013, a Montessori program was offered at the school which has also continued to increase projected future growth even higher.


In the fall of 2019, the District will be opening Maddaugh Elementary, a new 655 capacity school; and then in September 2020, another new elementary school, Regent Road, will be opened, also a 655 capacity school. Prior to the opening of the schools, the District will do a public consultation to discuss boundary and program changes for the area. We anticipate that the opening of the new schools will relieve the enrolment pressure in the Clayton area.

École Salish Secondary will be open for September 2018/19 school year. This school has been built to relieve enrolment pressure at both Lord Tweedsmuir and Clayton Heights Secondary. A 500 capacity addition for Clayton Heights Secondary is on the District's current 5 year Capital Plan.

### **Latimer Road Elementary**

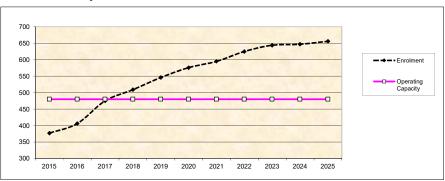

# Clayton Heights Secondary

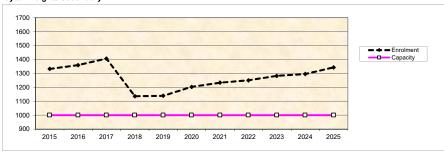

<sup>\*</sup> Nominal Capacity is estimated by multiplying the number of enrolling spaces by 25 students. Maximum operating capacity is estimated by multipying the number of enrolling spaces by 27 students.

# MIKE FADUM AND ASSOCIATES LTD. VEGETATION CONSULTANTS

# **Tree Preservation Summary**

Surrey Project No: 18-0072-00 Address: 6529 - 196 Street

**Registered Arborist: Monica Ardiel** 


On-Site Trees	Number of Trees
Protected Trees Identified  (on-site and shared trees, including trees within boulevards and proposed streets and lanes, but excluding trees in proposed open space or riparian areas)  Protected Trees to be Removed  Protected Trees to be Retained	85 85
<ul> <li>(excluding trees within proposed open space or riparian areas)</li> <li>Total Replacement Trees Required:         <ul> <li>Alder &amp; Cottonwood Trees Requiring 1 to 1 Replacement Ratio</li> <li>66 X one (1) = 66</li> </ul> </li> <li>All other Trees Requiring 2 to 1 Replacement Ratio</li> <li>19 X two (2) = 38</li> </ul>	104
Replacement Trees Proposed Replacement Trees in Deficit Protected Trees to be Retained in Proposed [Open Space / Riparian Areas]	32 72 3

Off-Site Trees	Number of Trees
Protected Off-Site Trees to be Removed	13
Total Replacement Trees Required:	
- Alder & Cottonwood Trees Requiring 1 to 1 Replacement Ratio 9 X one (1) = 9	17
<ul> <li>All other Trees Requiring 2 to 1 Replacement Ratio</li> <li>4 X two (2) = 8</li> </ul>	
Replacement Trees Proposed	NA
Replacement Trees in Deficit	NA

Summary report and plan prepared and submitted by: Mike Fadum and Associates Ltd.				
Signature of Arborist:	and _	Date: June 25, 2018		





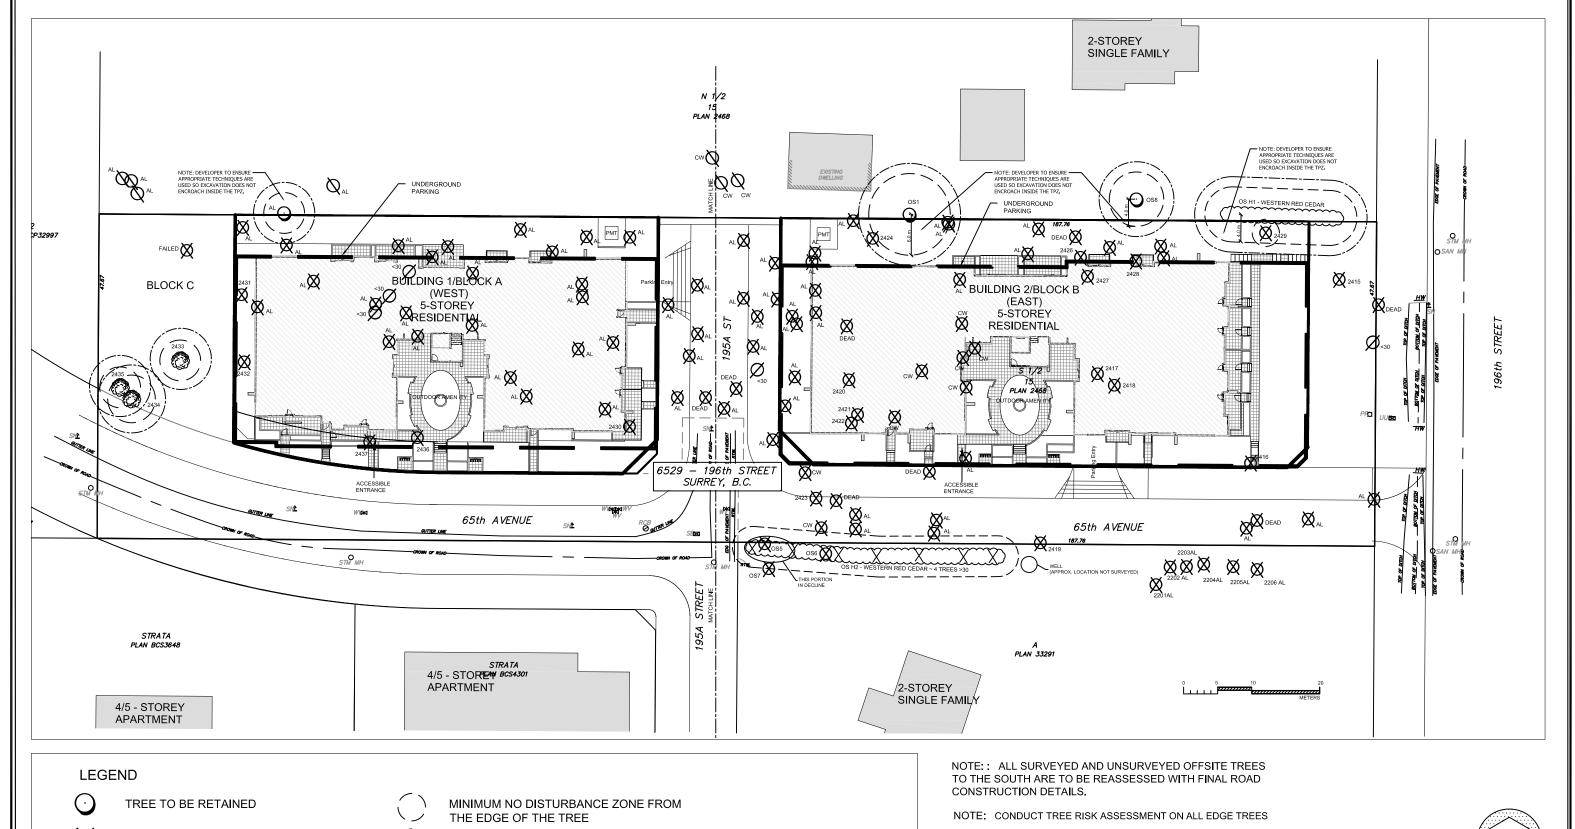

 $\boxtimes$ 

TREE TO BE REMOVED

Ø

ALDER/COTTONWOOD NOT ASSESSED



1.5m EXCAVATION ZONE



TO BE ASSESSED BY SURREY PARKS, REC & CUL. DEPT



ı	NO.	DATE	BY	REVISION	NO.	DATE	BY	REVISION
ı	1	JAN17/18	MK	SITE PLAN REVISED	6	JUN07/18	MK	SITE PLAN REVISED
ı	2	FEB15/18	MK	SITE PLAN REVISED	7	JUN25/18	MK	SITE PLAN REVISED
ı	3	APR04/18	MK	SITE PLAN REVISED				
ı	4	MAY11/18	MK	SITE PLAN REVISED				
ı	5	MAY16/18	MK	SITE PLAN REVISED				

MIKE FADUM AND ASSOCIATES LTD. VEGETATION CONSULTANTS

#105, 8277 129 St. Surrey, British Columbia V3W 0A6 Ph: (778) 593-0300 Fax: (778) 593-0302

Email: mfadum@fadum.ca

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PROJECT TITLE

6529 196 STREET


SURREY, B.C.


AND PRESERVATION PLA	N
SHEET TITLE KEY PLAN - TREE REMOV	


DRAWN
SGL

SCALE
AS SHOWN
SHEET 1 OF 5

DATE
MAY 05, 2016

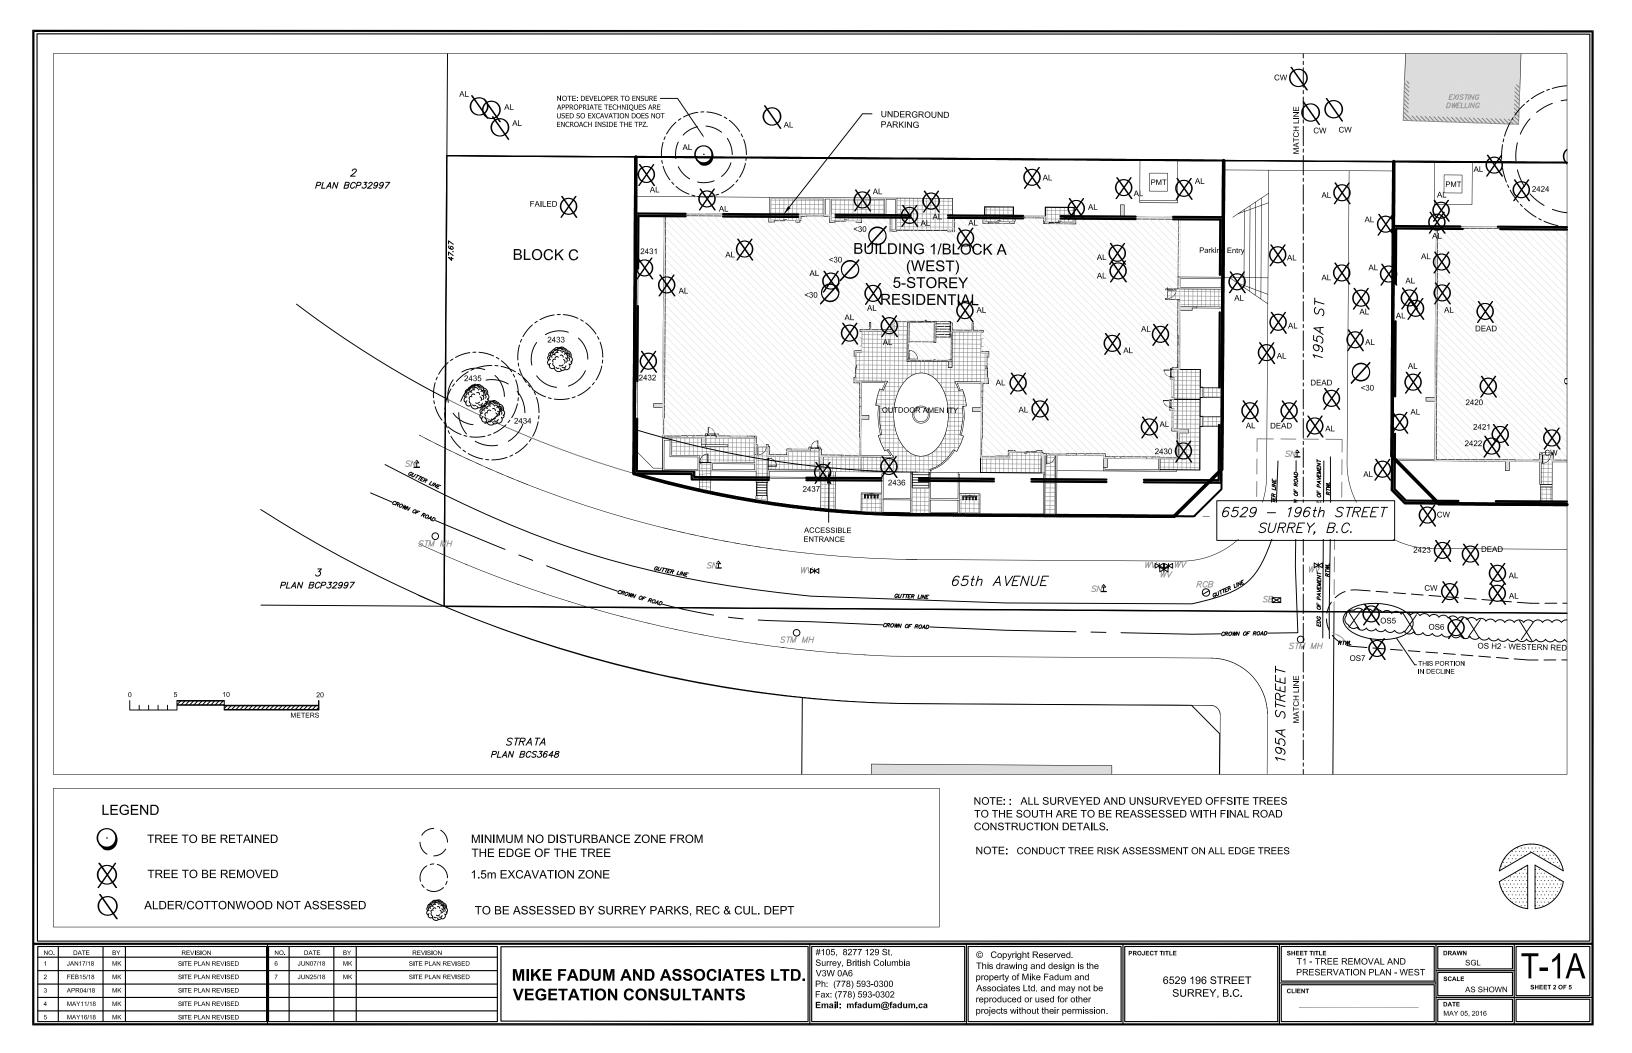

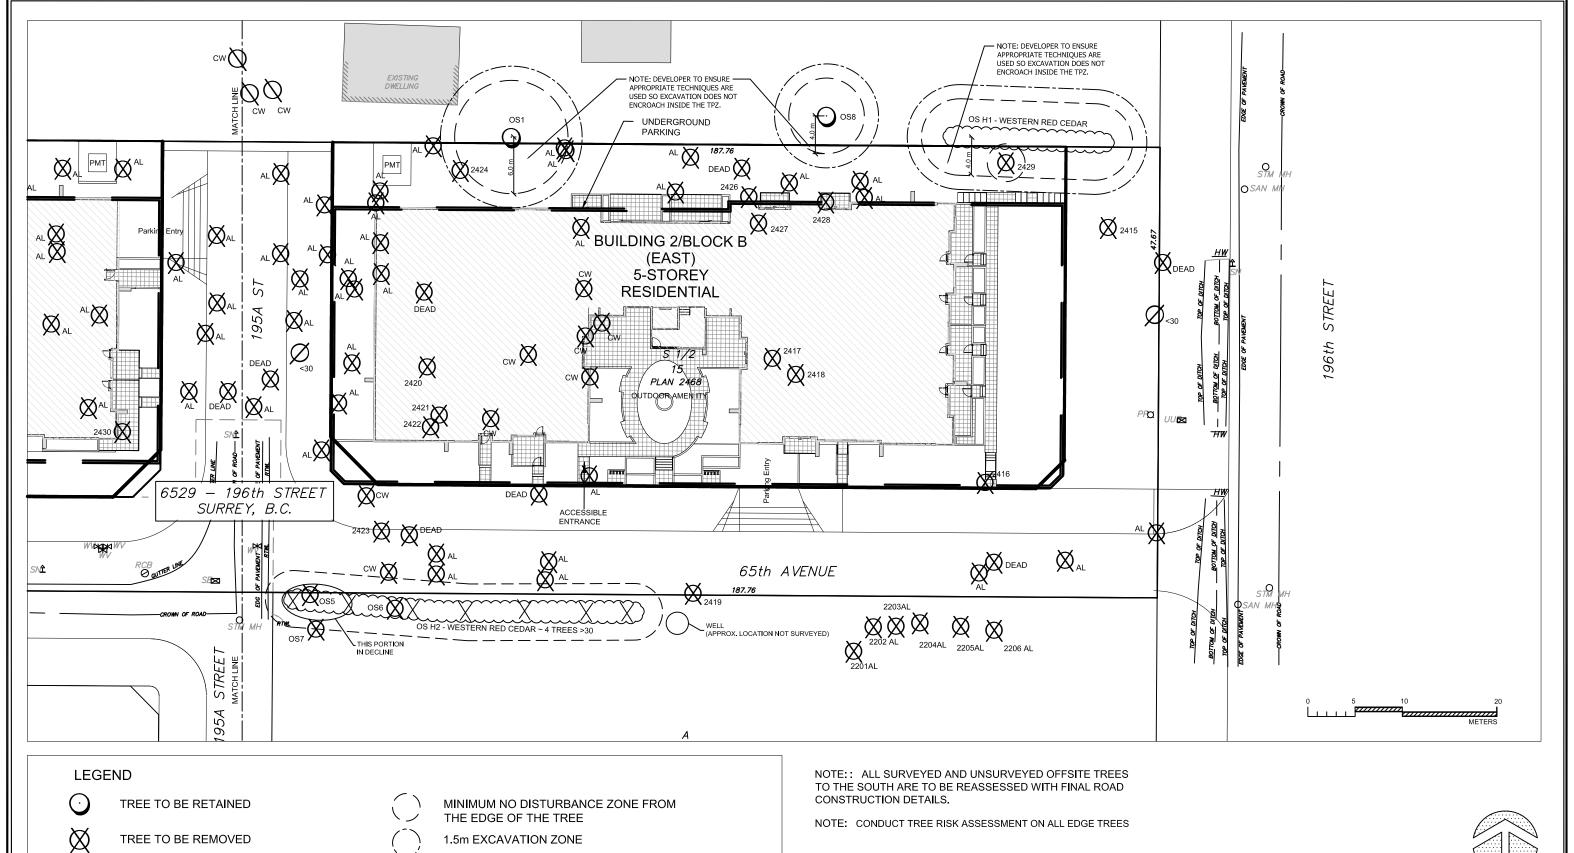

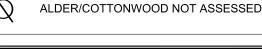



1.5m EXCAVATION ZONE



TO BE ASSESSED BY SURREY PARKS, REC & CUL. DEPT



ı	NO.	DATE	BY	REVISION	NO.	DATE	BY	REVISION
ı	1	JAN17/18	MK	SITE PLAN REVISED	6	JUN07/18	MK	SITE PLAN REVISED
ı	2	FEB15/18	MK	SITE PLAN REVISED	7	JUN25/18	MK	SITE PLAN REVISED
ı	3	APR04/18	MK	SITE PLAN REVISED				
ı	4	MAY11/18	MK	SITE PLAN REVISED				
ı	5	MAY16/18	MK	SITE PLAN REVISED				

MIKE FADUM AND ASSOCIATES LTD. **VEGETATION CONSULTANTS** 

#105, 8277 129 St. Surrey, British Columbia V3W 0A6 Ph: (778) 593-0300 Fax: (778) 593-0302 Email: mfadum@fadum.ca

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0JECT TITLE 6529 196 STREET	SHEET TITLE T1 - TF PRESE
SURREY, B.C.	CLIENT

HEET TITLE T1 - TREE REMOVAL AND PRESERVATION PLAN - EAST
LIENT

DRAWN SGL	T_1F
SCALE AS SHOWN	SHEET 3 OF 5
DATE	



# Advisory Design Panel DRAFT Minutes

2E - Community Room B

City Hall

13450 - 104 Avenue Surrey, B.C.

THURSDAY, JUNE 21, 2018

Time: 4:00 p.m.

Present:

Chair - J. Leger
Panel Members:

A. Scott D. Tyacke M. Younger **Guests:** 

Anya Paskovic, Aplin Martin Jessie Arora, DF Architecture Inc.

Mary Chan-Yip, PMG Landscape Architects

Samira Khayambashi, Aplin Martin Stephen Vincent, Durante Kruek Ltd.

Tim Ankenman, Ankenman Marchand Architect

Zubin Billimoria, DF Architecture Inc.

**Staff Present:** 

A. McLean, City Architect

C. Eagles, Administrative Assistant N. Chow, Urban Design Planner

## 3. 5:30 p.m.

File No.: 7918-0072-00

New or Resubmit: New Last Submission Date: N/A

Description: OCP amendment from Urban to Multiple

Residential and NCP amendment from max. 45 upa

to max 70 upa. Rezoning and DP to permit 2 residential apartment buildings for a total of 151

units with parking below grade.

Address: 6529 196 Street

Developer: 1034786 BC Ltd. (Jit Daara)

Architect: Tim Ankenman, Architect AIBC, Ankenman

**Marchand Architects** 

Landscape Architect: Stephen Vincent, Durante Kruek Ltd.

Planner: Ingrid Matthews Urban Design Planner: Ann Mclean

The City Architect advised that staff have no specific issues. Staff noted that 65 Avenue will be extended to 196 Street and that the Planning and Development Department generally support the project.

The Project Architect presented an overview of the site and building plans, streetscapes and elevations. An effect was made to break down building massing and it was noted the size of the originally proposed units became too large for the current area, as such, an amendment to the OCP was required. The building is exploring the provision of a Sewerage Heat Recovery system for the buildings.

The Landscape Architect presented an overview of the general concept for the Landscape plans.

#### ADVISORY DESIGN PANEL STATEMENT OF REVIEW

It was Moved by A. Scott Seconded by D. Tyake

That the Advisory Design Panel (ADP):

- 1. Support the project and recommends that the applicant address the following issues to the satisfaction of the Planning & Development Department.
- 2. Recommend that the landscaping submission return to staff for further development.

#### Carried

The Panel noted the project material lacked detail, in particular the landscaping details and amenity spaces.

#### Site

• The Panel noted the good massing reduction toward the north east neighbours.

#### Form and Character

- Consider the rooftop amenity area be larger, particularly the windows in the hallway could be doors accessing the deck; and include a covered area.
- Consider relocating the bedroom over of the vehicle access ramp of a proposed three bedroom unit.
- Consider relocating the closet and storage spaces adjacent to the exterior in favour of providing more natural light.
- Consider more wood elements.
- The panel supports the architectural expression and the "U" shaped building typology.

## Landscape

• Recommend additional trees on the north side for future screening.

#### Sustainability


• The panel encourages efforts for sustainability.


#### **CPTED**

No specific issues were identified.

# Accessibility

Recommend the entry level lobby area be accessible.

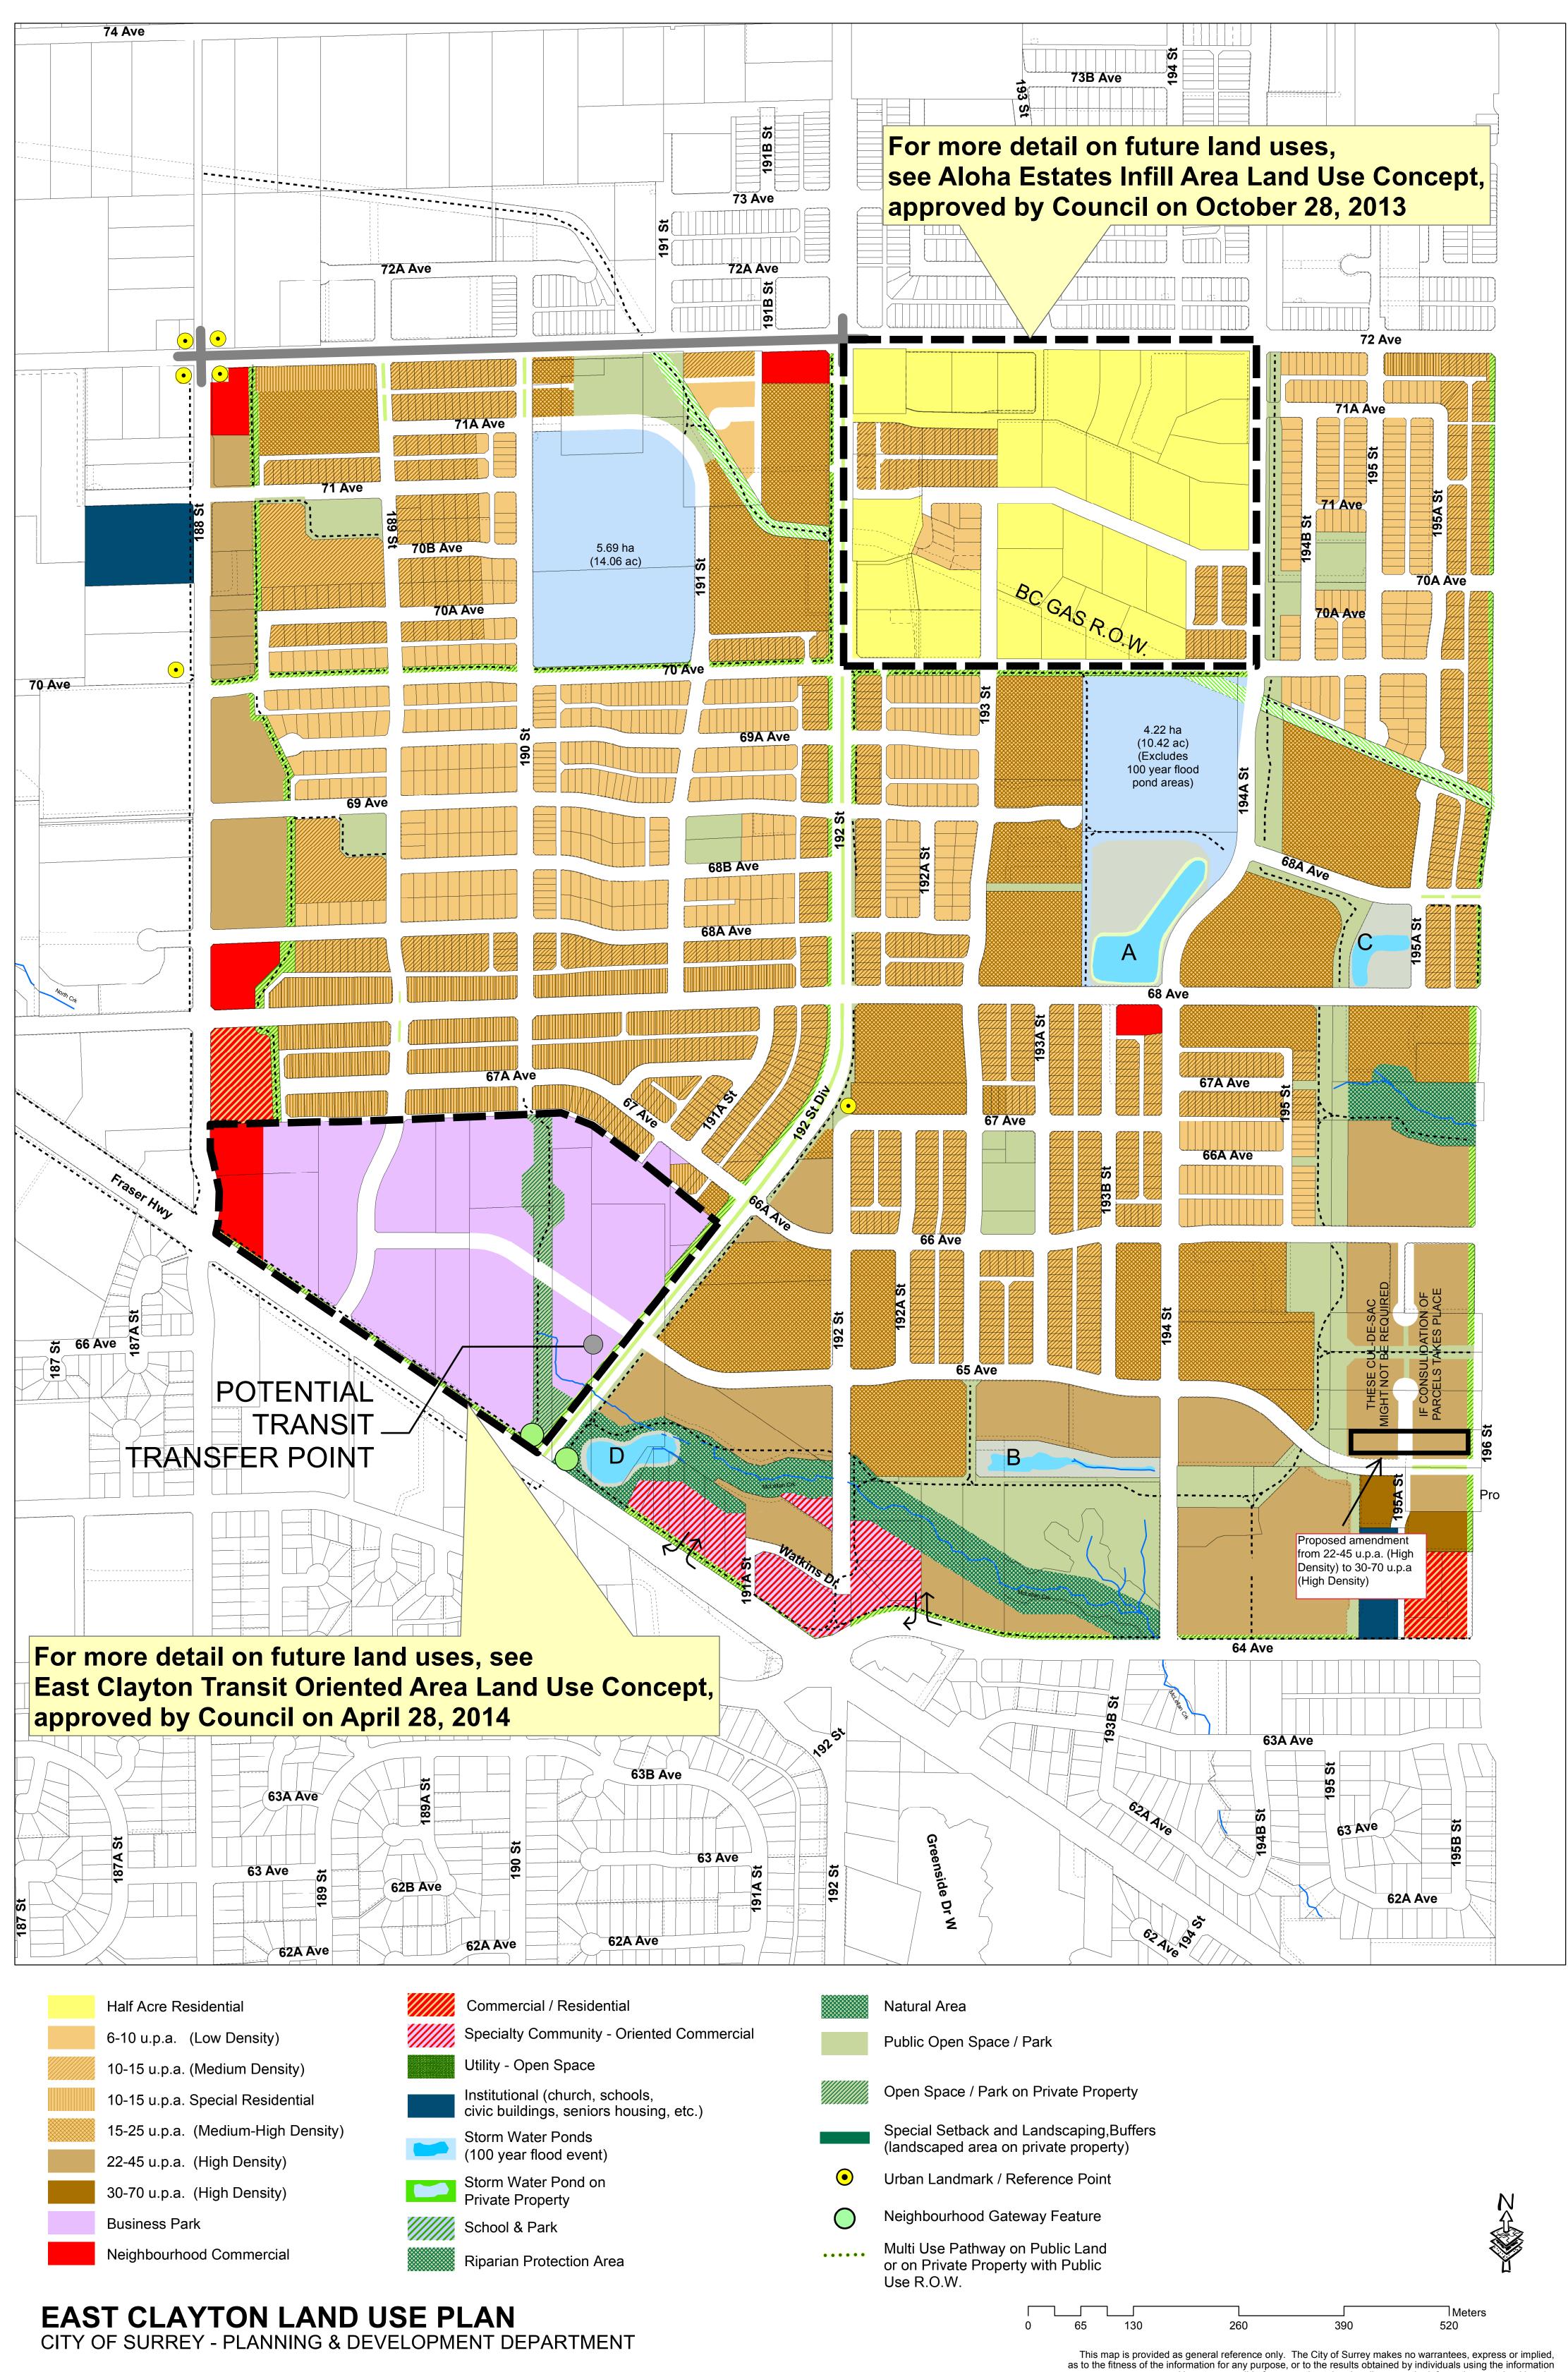

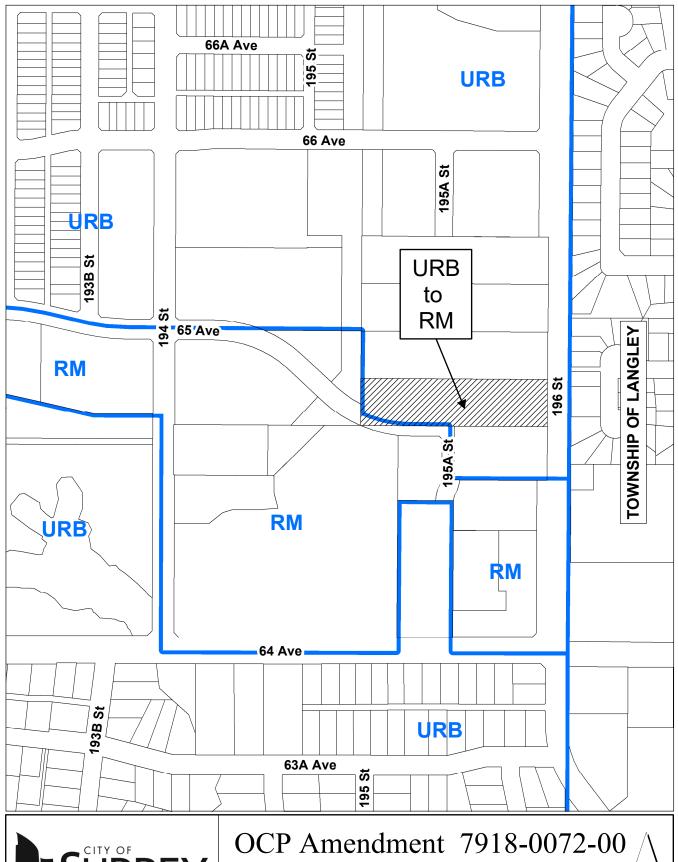



Proposed amendment from Urban to Multiple Residential



## **CITY OF SURREY**

## BYLAW NO.

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THE CITY COUNCIL of the City of Surrey ENACTS AS FOLLOWS:

1. Surrey Zoning By-law, 1993, No. 12000, as amended, is hereby further amended, pursuant to the provisions of Section 479 of the <u>Local Government Act</u>, R.S.B.C. 2015 c. 1, as amended by changing the classification of the following parcels of land, presently shown upon the maps designated as the Zoning Maps and marked as Schedule "A" of Surrey Zoning By-law, 1993, No. 12000, as amended as follows:

FROM: ONE-ACRE RESIDENTIAL ZONE (RA)

TO: COMPREHENSIVE DEVELOPMENT ZONE (CD)

Parcel Identifier: 001-461-184 The South Half of Lot 15 Township 8 New Westminster District Plan 2468

6529 - 196 Street

(hereinafter referred to as the "Lands")

2. The following regulations shall apply to the *Lands*:

## A. Intent

This Comprehensive Development Zone is intended to accommodate and regulate the development of medium *density*, medium-rise, *multiple unit residential buildings*, *ground-oriented multiple unit residential buildings* and related *amenity spaces*, which are to be developed in accordance with a *comprehensive design* and where *density* bonus is provided.

The *Lands* are divided into Blocks A, B, and C and as shown on the Survey Plan attached hereto and forming part of this Bylaw as Schedule A, certified correct by Lakhjot S. Grewal, B.C.L.S. on the 18th day of June, 2018.

#### B. Permitted Uses

Lands and *structures* shall be used for the following uses only, or for a combination of such uses, provided such combined uses are part of a *comprehensive design*:

### 1. BLOCKS A and B

Multiple unit residential buildings and ground-oriented multiple unit residential buildings.

#### 2. BLOCK C

Open space.

#### C. Lot Area

Not applicable to this Zone.

## D. Density

#### 1. BLOCK A

- (a) For the purposes of *building* construction, the *floor area ratio* shall not exceed 0.1. The maximum *density* may be increased to that prescribed in Section D.1.(b) of this Zone if amenities are provided in accordance with Schedule G of Surrey Zoning By-law, 1993, No. 12000, as amended;
- (b) The *floor area ratio* shall not exceed 2.22 and the *unit density* shall not exceed 301 units per hectare (122 u.p.a); and
- (c) The indoor *amenity space* required in Sub-section J.1(b) is excluded from the calculation of *floor area ratio*.

## 2. BLOCK B

- (a) For the purposes of *building* construction, the *floor area ratio* shall not exceed 0.1. The maximum *density* may be increased to that prescribed in Section D.2 (b) of this Zone if amenities are provided in accordance with Schedule G of Surrey Zoning By-law, 1993, No. 12000, as amended;
- (b) The *floor area ratio* shall not exceed 2.02 and the *unit density* shall not exceed 280 units per hectare (113 u.p.a); and
- (c) The indoor *amenity space* required in Sub-section J.1 (b) is excluded from the calculation of *floor area ratio*.

## 3. BLOCK C

Not applicable to this **Block**.

## E. Lot Coverage

#### 1. BLOCK A

Lot coverage shall not exceed 53%.

## 2. BLOCK B

Lot coverage shall not exceed 57%.

## 3. BLOCK C

Not applicable to this Block.

## F. Yards and Setbacks

1. Buildings and structures shall be sited in accordance with the following minimum setbacks:

Setback Use	South Yard	North Yard	West Yard	East Yard
BLOCK A				
Principal Buildings Accessory Buildings and Structures	4.5 m (15 ft.)	6.0 m (20 ft.)	3.0 m (10 ft.)	4.5 m (15 ft.)
BLOCK B				
Principal Buildings Accessory Buildings and Structures	4.5 m (15 ft.)	6.0 m (20 ft.)	4.5 m (15 ft.)	11.6 m (38 ft.)
BLOCK C	Not applicable to this Block.			

Measurements to be determined as per Part 1 Definitions of Surrey Zoning By-law, 1993, No. 12000, as amended.

2. Notwithstanding Sub-section E.17(b) of Part 4 General Provision of Surrey Zoning By-law, 1993, No. 12000, as amended, stairs with more than three risers may encroach into the *setbacks*.

## G. Height of Buildings

Measurements to be determined as per Part 1 Definitions of Surrey Zoning By-law, 1993, No. 12000, as amended.

## **BLOCK A**

- 1. <u>Principal buildings</u>: The building height shall not exceed 16.6 metres [54 ft.].
- 2. <u>Accessory buildings and structures</u>: The building height shall not exceed 4.5 metres [15 ft.].

#### **BLOCK B**

- 1. <u>Principal buildings</u>: The building height shall not exceed 17.1 metres [56 ft.].
- 2. <u>Accessory buildings and structures</u>: The building height shall not exceed 4.5 metres [15 ft.].

#### BLOCK C

Not applicable to this Block.

## H. Off-Street Parking

- 1. Resident and visitor *parking spaces* shall be provided in accordance with Part 5 Off-Street Parking and Loading/Unloading of Surrey Zoning By-law, 1993, No. 12000, as amended.
- 2. All required resident *parking spaces* shall be provided as *underground parking* or as *parking within building envelope*.
- 3. A maximum of thirteen percent (13%) of the required resident parking spaces may be provided as tandem parking spaces.
- 4. Notwithstanding Sub-section A.3(d) of Part 5 Off-Street Parking and Loading/Unloading of Surrey Zoning By-law, 1993, No. 12000, as amended, the *Parking Facility Underground* may be located up to 0.5 metres [2 ft.] from the *front lot line* or *lot line* along a *flanking street*.

## I. Landscaping

1. All developed portions of the *lot* not covered by *buildings*, *structures* or paved areas shall be landscaped including the retention of mature trees. This *landscaping* shall be maintained.

- 2. Along the developed sides of the *lot* which abut a *highway*, a continuous *landscaping* strip of not less than 1.5 metres [5 ft.] in width shall be provided within the *lot*.
- 3. The boulevard areas of *highways* abutting a *lot* shall be seeded or sodded with grass on the side of the *highway* abutting the *lot*, except at *driveways*.
- 4. Garbage containers and *passive recycling containers* shall be located within the *underground parking* or within a *building*.

## J. Special Regulations

- 1. *Amenity space* shall be provided on the *lot* as follows:
  - (a) Outdoor *amenity space*, in the amount of 3.0 square metres [32 sq.ft.] per *dwelling unit* and shall not be located within the required *setbacks*; and
  - (b) Indoor *amenity space*, in the amount of 3.0 square metres [32 sq.ft.] per *dwelling unit*.
- 2. Balconies are required for all dwelling units which are not ground-oriented and shall be a minimum of 5% of the dwelling unit size or 4.6 square metres [50 sq.ft.] per dwelling unit, whichever is greater.

#### K. Subdivision

*Lots* created through subdivision in this Zone shall conform to the following minimum standards:

Lot Size	Lot Width	Lot Depth
590 sq.m.	20 metres	25 metres
[ 0.15 acre]	[ 66 ft.]	[ 82 ft.]

Dimensions shall be measured in accordance with Section E.21 of Part 4 General Provisions of Surrey Zoning By-law, 1993, No. 12000, as amended.

## L. Other Regulations


In addition to all statutes, bylaws, orders, regulations or agreements, the following are applicable, however, in the event that there is a conflict with the provisions in this Comprehensive Development Zone and other provisions in Surrey Zoning By-law, 1993, No. 12000, as amended, the provisions in this Comprehensive Development Zone shall take precedence:

1. Definitions are as set out in Part 1 Definitions of Surrey Zoning By-law, 1993, No. 12000, as amended.

2.	Prior to any use, the <i>Lands</i> must be serviced as set out in Part 2 Uses
	Limited, of Surrey Zoning By-law, 1993, No. 12000, as amended and in
	accordance with the servicing requirements for the RM-70 Zone as set
	forth in the Surrey Subdivision and Development By-law, 1986, No. 8830, as
	amended

- 3. General provisions are as set out in Part 4 General Provisions of Surrey Zoning By-law, 1993, No. 12000, as amended.
- 4. Additional off-street parking requirements are as set out in Part 5 Off-Street Parking and Loading/Unloading of Surrey Zoning By-law, 1993, No. 12000, as amended.
- 5. Sign regulations are as set out in Surrey Sign By-law, 1999, No. 13656, as amended.
- 6. Special *building setbacks* are as set out in Part 7 Special Building Setbacks, of Surrey Zoning By-law, 1993, No. 12000, as amended.
- 7. *Building* permits shall be subject to the Surrey Building Bylaw, 2012, No. 17850, as amended.
- 8. *Building* permits shall be subject to Surrey Development Cost Charge Bylaw, 2017, No. 19107, as may be amended or replaced from time to time, and the development cost charges shall be based on the RM-70 Zone.
- 9. Tree regulations are set out in Surrey Tree Protection Bylaw, 2006, No. 16100, as amended.
- 10. Development permits may be required in accordance with the Surrey *Official Community Plan* By-law, 2013, No. 18020, as amended.

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3.	This By-law shall be c Amendment By-law,		ses as "Surrey Zoi ."	ning By-law,	1993, No. 1200	00,
PASSE	D FIRST READING on	the th da	y of	, 20 .		
PASSE	D SECOND READING	on the th	day of	, 20 .		
PUBLI	C HEARING HELD the	ereon on the	th day of		, 20 .	
PASSE	D THIRD READING or	n the th d	ay of	, 20 .		
	NSIDERED AND FINA rate Seal on the	LLY ADOPTED, th day of	signed by the May	yor and Clerk	s, and sealed	with the
						MAYOR
						CLERK

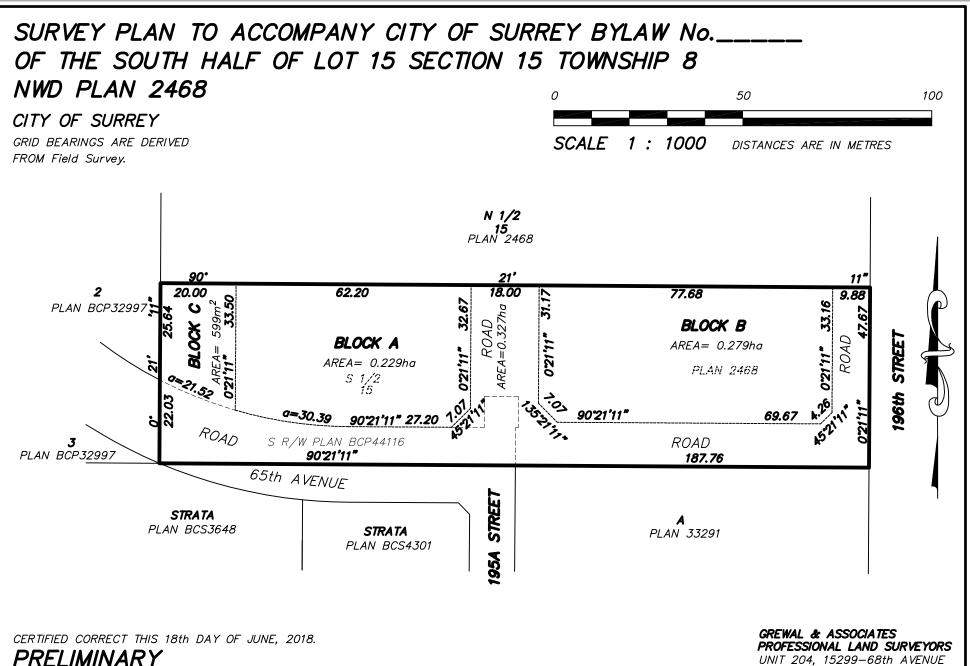

B.C.L.S. LAKHJOT S. GREWAL

# LEGEND:

DENOTES HECTARE

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