

City of Surrey PLANNING & DEVELOPMENT REPORT File: 7917-0255-00

Planning Report Date: September 11, 2017

PROPOSAL:

Development Permit

• Development Variance Permit


to permit the development of a contractor's office and industrial storage building.

LOCATION: 9788 - 186 Street

OWNER: 1897 Holdings Ltd.

ZONING: IL

OCP DESIGNATION: Industrial

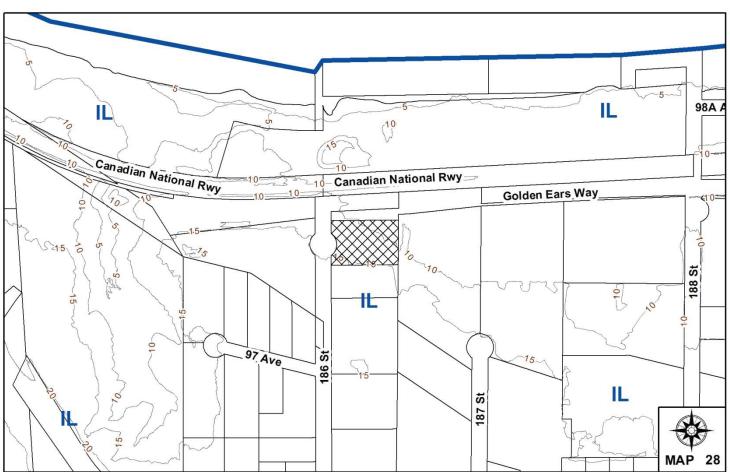

RECOMMENDATION SUMMARY

- Approval to draft Development Permit.
- Approval for Development Variance Permit to proceed to Public Notification.

DEVIATION FROM PLANS, POLICIES OR REGULATIONS

• The applicant is seeking to reduce the rear yard setback for an accessory building in the IL Zone from 7.5 metres (25 ft.) to 3.6 metres (12 ft.).

RATIONALE OF RECOMMENDATION

- Complies with the Industrial designation in the OCP and supports the City's Employment Lands Strategy through more efficient use of industrial land.
- The proposed building incorporates high quality materials and design, which is appropriate as Golden Ears Way is considered a gateway location into the City.
- The applicant has created a high quality landscaped interface between the Golden Ears Greenway and the proposed building.
- It is the applicant's intent to relocate their business from Vancouver to this site.
- The proposed variance allows for a more efficient industrial layout and for better grading of the site.

RECOMMENDATION

The Planning & Development Department recommends that:

- 1. Council authorize staff to draft Development Permit No. 7917-0255-00 generally in accordance with the attached drawings (Appendix II).
- 2. Council approve Development Variance Permit No. 7917-0255-00 (Appendix V), to reduce the minimum rear yard setback of the IL Zone for an Accessory Building from 7.5 metres (25 ft.) to 3.6 metres (12 ft.), to proceed to Public Notification.
- 3. Council instruct staff to resolve the following issues prior to final approval:
 - (a) ensure that all engineering requirements and issues including restrictive covenants, dedications, and rights-of-way where necessary, are addressed to the satisfaction of the General Manager, Engineering;
 - (b) submission of a sealed letter from a Geotechnical Engineer:
 - i. outlining how the storage shed will be constructed at close proximity to the south property line and neighbouring buildings; and
 - ii. providing the assurance that the proposed design and construction methods for the construction of the storage shed will substantially comply with all the requirements of the applicable codes, legislation and bylaws and will be safe for their intended purpose.
 - (c) input from the Ministry of Transportation & Infrastructure;
 - (d) submission of a finalized tree survey and a statement regarding tree preservation to the satisfaction of the City Landscape Architect;
 - (e) submission of a landscaping plan and landscaping cost estimate to the specifications and satisfaction of the Planning and Development Department; and
 - (f) resolution of all urban design issues to the satisfaction of the Planning and Development Department.

REFERRALS

Engineering: The Engineering Department has no objection to the project

subject to the completion of Engineering servicing requirements as

outlined in Appendix III.

Translink: TransLink has no concerns with the project.

SITE CHARACTERISTICS

Existing Land Use: Vacant lot.

Adjacent Area:

Direction	Existing Use	OCP Designation	Existing Zone
North (Across Golden Ears Way and Greenway as well as Canadian National Railway):	Sawmill.	Industrial	IL
East:	Vacant lot.	Industrial	IL
South:	Game bird processor.	Industrial	IL
West (Across 186 Street cul-desac):	Vacant lot under Development Permit application No. 7916-0320-00 to permit an industrial building.	Industrial	IL

DEVELOPMENT CONSIDERATIONS

- The subject lot is located on the east side of 186 Street cul-de-sac and borders Golden Ears Way to the north. The site was created through subdivision application No. 7990-0079-00 as part of a 5-lot industrial subdivision.
- The 4,637 square-metre (49,912 sq.-ft.) property is designated Industrial in the Official Community Plan (OCP) and is zoned "Light Impact Industrial Zone (IL)".
- Development Permit and Development Variance Permit Nos. 7913-0099-00 were previously issued on December 16, 2013 to allow for a truck company dispatch office. Both permits have since expired and the property has been sold to the current applicant.
- The proposed Development Permit and Development Variance Permit are for a contractor's office and storage shed for Smith Brothers and Wilson Ltd. which is relocating their offices and approximately 20 to 25 employees from Vancouver.
- The proposed site includes a 1,163-square metre (12,519 sq. ft.) 3-storey contractor's office, a 465-square metre (5,000 sq. ft.) storage building and parking and outdoor storage as well as a staging area.
- The proposed development complies with all requirements of the IL Zone with the exeption of the rear yard setback to the accessory storage building, which is proposed to be reduced from 7.5 metres (25 ft.) to 3.6 metres (12 ft.). See By-law Variances Section.

DESIGN PROPOSAL AND REVIEW

Office Building

- At the northwest corner of the site, the applicant proposes a 1,138-square metres (12,245 sq. ft.) 3-storey contractor's office. The dimensions of the building are approximately 43 metres (141 ft.) in length, 10 metres (33 ft.) in width and 11 metres (36 ft.) in height. The proposed design includes cantilevering of portions of the second and third floors.
- The proposed building is of a high quality design. Smith Brothers and Wilson Ltd. (SBW) is a contractor that specializes in the use of concrete. The design of the building reflects this by using substantial concrete in the building design and retaining walls on site.
- The proposed building will be accented with blue metal panels, wood, substantial glazing and architectural concrete.
- All three floors are designed with an east-west corridor with offices off of the north and south sides of the corridor. Each of the three floors is approximately 364 square metres (3,900 sq. ft.) to 406 square metres (4,370 sq. ft.) in area.

Accessory Building

- At the southeast corner of the site is a proposed 465-square metre (5,000 sq. ft.) storage building that is approximately 26 metres (85 ft.) wide and 17.5 metres (57 ft.) deep and is proposed to be 6 metres (20 ft.) in height.
- The proposed pre-engineered storage shed will be primarily blue with grey and white accents to match the contractor's office building. Along the north elevation is a large sliding door.
- The proposed shed is proposed to be constructed at a zero setback to the south property line. Due to the complexities of constructing at the property line, the applicant will be required to provide a letter from a Geotechnical Engineer outlining how construction of the proposed building and retaining wall will occur.
- The applicant is proposing a reduced rear yard setback for the proposed shed of 3.6 metres (12 ft.). See variance section for further details.

Outside Storage

- Outside storage is located in the northeastern portion of the site. The applicant proposes a storage area incorporating approximately eight storage containers that will be double stacked along the centre of the east property line.
- The northeast corner will be used for the periodic transitioning and staging area for construction supplies and equipment required for off-site projects.

Parking, Access and Circulation

• One driveway access is proposed off of the 186 Street cul-de-sac. The proposed driveway is 6 metres (20 ft.) wide and has an approximate five percent slope as it enters the site.

• The applicant proposes a total of 37 employee and customer parking spaces which exceeds the 34 employee and customer parking spaces required under Surrey Zoning By-law No. 12000 for both the office building and accessory building.

• Employee and customer parking is located in the southwest portion of the site. Four (4) of the proposed parking spaces are in a parallel arrangement.

Trees, Landscaping and Retaining Walls

- The site slopes downward approximately 7.5 metres (25 ft.) from the southwest corner to the northeast corner. The proposed grading requires the use of substantial lock-block retaining walls along the north, east and south property lines as well as a retaining wall through the parking area in the middle of the site to assist with leveling the site.
- Along the east side of the site, the applicant proposes an approximate 1.7-metre (5.5 ft.) high lock block retaining wall that is setback approximately 4.5 metres (15 ft.) from the property line. The proposed wall is approximately 20 metres (65 ft.) in length and will be screened by a 1.5 metre (5 ft.) wide cedar hedge adjacent to an existing a 3-metre (10 ft.) wide drainage easement.
- Along the north property line, along both Golden Ears Way and Golden Ears Greenway, an approximate 1-metre (3 ft.) tall retaining wall is proposed. The proposed wall will be setback 3-metres and will be screened the full length of the property line by retaining existing undersized trees along the north property line and augmenting these trees with an additional 9 maple trees and shrubs.
- Along the 186 Street cul-de-sac, the applicant proposes a 3-metre (10 ft.) wide landscaping area which includes four tulip trees and shrubs. Decorative saw cut concrete is proposed across the entrance.
- To the south of the contractor's office building, the applicant proposes four stepped retaining walls from the main floor of the building to the parking lot. The main entrance to the building will be the second floor which has a pathway and ramp leading up to it from the parking lot.
- A retaining wall is proposed within the parking lot to assist with leveling the grades.
- A 2.4-metre (8 ft.) high security fence is proposed around the eastern portion of the site to primarily protect the outside storage and staging area. The fencing will primarily be high quality omega fencing with chain link proposed along the non-visible east property line.
- A staff patio area is proposed to the north of the office building.

Signage

• The applicant is proposing one single-sided free-standing monument sign located to the north of the driveway along the 186 Street cul-de-sac. The proposed oval sign is approximately 2.1 metres (7 ft.) wide and 1.1 metre (3.5 ft.) tall on a 0.35-metre (1 ft.) base. The proposed signage complies with the Sign By-law.

• The concrete sign will have the company letters of SBW and addressing. All lettering will be aluminum and lined with LED lighting and mounted to the concrete base.

TREES

 Austin Peterson, ISA Certified Arborist of van der Zalm and Associates Inc. prepared an Arborist Assessment for the subject property. The table below provides a summary of the tree retention and removal by tree species:

Table 1: Summary of Tree Preservation by Tree Species:

Tree Species	Existing	Remove	Retain						
Cottonwood Tree									
Cottonwood 4 4 o									
Total (excluding Cottonwood Trees)	О	o o							
Total Replacement Trees Prop (excluding Boulevard Street Trees		13							
Total Retained and Replaceme Trees	ent	13							
Contribution to the Green City	Fund	nil							

- The Arborist Assessment states that all four (4) of the existing trees on-site are Cottonwood tree and that no trees can be retained as part of this development proposal. The proposed tree retention was assessed taking into consideration the location of services, building footprints, road dedication and proposed lot grading. The applicant is proposing to retain 15 off-site trees.
- For those Cottonwood trees that cannot be retained, the applicant will be required to plant trees on a 1 to 1 replacement ratio. This will require a total of 4 replacement trees on the site, and the applicant is proposing 13 replacement trees.
- In summary, a total of 13 trees are proposed to be planted on the site.

PRE-NOTIFICATION

• In accordance with Council policy, a development proposal sign was erected on the property. To date, staff have not received any comments with respect to the proposal.

SUSTAINABLE DEVELOPMENT CHECKLIST

The applicant prepared and submitted a sustainable development checklist for the subject site on July 17, 2017. The table below summarizes the applicable development features of the proposal based on the seven (7) criteria listed in the Surrey Sustainable Development Checklist.

Sustainability	Sustainable Development Features Summary
Criteria	
1. Site Context & Location	The proposed development complies with the Industrial designation in the OCP.
2. Density & Diversity	• N/A
3. Ecology & Stewardship	 The applicant will plant and maintain landscaping throughout the site. Along the north property line there are groupings of six and four undersized cedar trees that will be retained through development.
4. Sustainable Transport & Mobility	The site is within 300m of a bus stop to bus numbers 388 and 501 and is directly adjacent to the Golden Ears Greenway.
5. Accessibility & Safety	The current design has incorporated CPTED strategies and included continuous perimeter fencing, exterior directed lighting and landscaping to establish a comfortable and safe work environment.
6. Green Certification	• N/A
7. Education & Awareness	 The current design of the Smith Bros Wilson Head Office celebrates the companies 120th anniversary and reflects their projects, through construction materials and a strong sustainable vision. The project incorporates and makes visible heavy timber (Glulam beams and columns, NLT floors and roof) and advanced wood systems (CLT walls) into the construction and incorporates sustainable mechanical and electrical systems.

BY-LAW VARIANCE AND JUSTIFICATION

(a) Requested Variance:

• To reduce the rear yard setback in the IL Zone from 7.5 metres (25 ft.) to 3.6 metres (12 ft.) for an accessory building.

Applicant's Reasons:

- Site topography and grading has made development of the site difficult. The relaxed setback assists in providing a better site layout.
- The proposed setback relaxation allows for a shed size that is equivalent in size to the
 existing operation in Vancouver. A smaller shed would not allow for the area to safely
 operate.

Staff Comments:

• The proposed variance allows for reduced setback along a rear property line which borders a vacant industrial lot.

- Due to existing sloping grades, the site is difficult and inefficient to design. The reduced setback helps with grading transition and site design while making the site more efficient.
- Staff support the requested variance.

INFORMATION ATTACHED TO THIS REPORT

The following information is attached to this Report:

Appendix I. Lot Owners, Action Summary and Project Data Sheets

Appendix II. Site Plan, Building Elevations, Landscape Plans and Perspective

Appendix III. Engineering Summary

Appendix IV. Summary of Tree Survey and Tree Preservation Appendix V. Development Variance Permit No. 7917-0255-00

original signed by Ron Gill

Jean Lamontagne General Manager Planning and Development

JKS/da

Information for City Clerk

Legal Description and Owners of all lots that form part of the application:

1. (a) Agent: Name: Jeff Musialek

1897 Holdings Ltd.

Address: 8729 - Aisne Street

Vancouver, BC V6P 3P1

2. Property involved in the Application

(a) Civic Address: 9788 - 186 Street

(b) Civic Address: 9788 - 186 Street
Owner: 1897 Holdings Ltd.

<u>Director Information:</u> James Clark Campbell Timothy Harrington

Jeff Musialek

H. Murray Saunders

No Officer Information Filed

PID: 016-676-645

Lot 5 District Lot 388A Group 2 New Westminster District Plan 87305 Except Plans BCP25789 and BCP23778.

- 3. Summary of Actions for City Clerk's Office
 - (a) Proceed with Public Notification for Development Variance Permit No. 7917-0255-00 and bring the Development Variance Permit forward for an indication of support by Council. If supported, the Development Variance Permit will be brought forward for issuance and execution by the Mayor and City Clerk in conjunction with the issuance of the associated Development Permit.
 - (b) Remove Notice of Development Permit No. 7913-0099-00 from title.
 - (c) Remove Notice of Development Variance Permit No. 7913-0099-00 from title.

DEVELOPMENT DATA SHEET

Existing Zoning: IL

Requir	red Development Data	Minimum Required / Maximum Allowed	Proposed
LOT AREA	(in square metres)	4,637 m²	
Gross Tot			
Ro	oad Widening area		
Uı	ndevelopable area		
Net Total		4,637 m ²	
LOT COVERAGE	(in % of net lot area)	60%	
Buildings	& Structures		19%
	Hard Surfaced Areas		53%
Total Site	Coverage		72%
SETBACKS (in m	etres)		
Front		7.5 m	7.5 m
Rear		7.5 m	3.6 m *
Side #1 (N	· · · · · · · · · · · · · · · · · · ·	7.5 m	7.5 m
Side #2 (S	outh)	o m	o m
BUILDING HEIG Principal	HT (in metres/storeys)	18 m	11 m
Accessory		6 m	6 m
7 icccssory		OH	O III
NUMBER OF RES	SIDENTIAL UNITS		
Bachelor			
One Bed			
Two Bedr	oom		
Three Bec	lroom +		
Total			
FLOOR AREA: R	esidential		
FLOOR AREA: Co	ommercial		
Retail			
Office			1,163 m ²
То	otal		1,163 m ²
FLOOR AREA: In	ndustrial		464.5 m ²
FLOOR AREA: In	nstitutional		
TOTAL BUILDIN	G FLOOR AREA	4,637 m ²	1,627.8 m ²

^{*} Development Variance Permit required for relaxation to rear setback for accessory building

Development Data Sheet cont'd

Required Development Data	Minimum Required / Maximum Allowed	Proposed
DENSITY		
# of units/ha /# units/acre (gross)	N/A	N/A
# of units/ha /# units/acre (net)	N/A	N/A
FAR (gross)	1.0	0.36
FAR (net)	1.0	0.36
AMENITY SPACE (area in square metres)		
Indoor		
Outdoor		
PARKING (number of stalls)		
Office	29	32
Industrial	5	5
Residential Bachelor + 1 Bedroom		
2-Bed		
3-Bed		
Residential Visitors		
Institutional		
Total Number of Parking Spaces	34	37
Number of accessible stalls	1	1
Number of small cars		3
Tandem Parking Spaces: Number / % of Total Number of Units		
Size of Tandem Parking Spaces width/length		

Heritage Site	NO	Tree Survey/Assessment Provided	YES
---------------	----	---------------------------------	-----

Smith Bros & Wilson Ltd. - New Head Office

9788 186 Street, Surrey, B.C., V4N 3N7

Development Permit - COS file # 7917-0255-00

May 25, 2017: re Submission: August 10, 2017





106 – 2893 West 41st Avenue Vancouver BC, V6N 3C5 tel: (604) 724-7602

PROJECT DATA

Legal Address:

LOT 5 DISTRICT LOT 388A PLAN 87305 NWD GROUP 2, EXCEPT PLAN BCP25789, & EXC PL BCP23778 P.I.D.: 016-678-645

Land Use: Industrial Present Zone: IL

Site Area: 4,639 m²

F.S.R.: 1.0

Lot Coverage: 60% max Proposed: 19% Bidgs & Storage Shed

Setbacks:

Front = 7.5m

Rear = 7.5m (existing)
 * 3.6m (variance)

Side = 7.5m - north ,0.0m south (if abuts commercial or industrial land)

Mex. Height:

Principal Bidg. = 18m
 Proposed - 11m

Accessory Bidg. = 6m

Floor Area:

Office. = 1,161.3 m2

Industrial = 464.5 m2

Total Bidg Floor Area = 1, 625.8m2

Density

FAR (gross) allowed = 1.0

FAR (gross) proposed = 0.36

FAR (net) allowed = 1.0

FAR (net) proposed = 0.36


Perkin

Commerical = 33


Disabled Stalls = 1 (Incl)

Small Cars = 8 (incl)

Total # Parking Stalls - 33

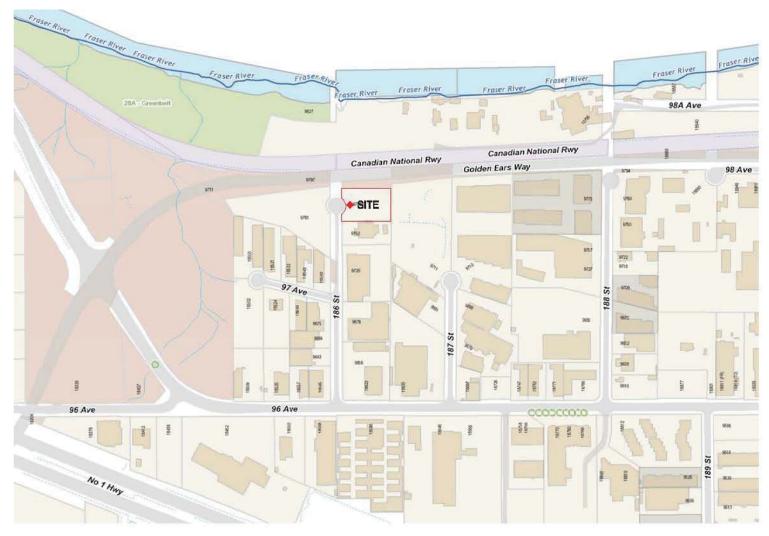


1 / Location Map / n.t.s

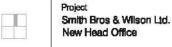

phase	
Development	Permit

sheet titk			
LOCATIO	ON MAP		
ecale	n.t.s.	dete	Aug 18, 2017

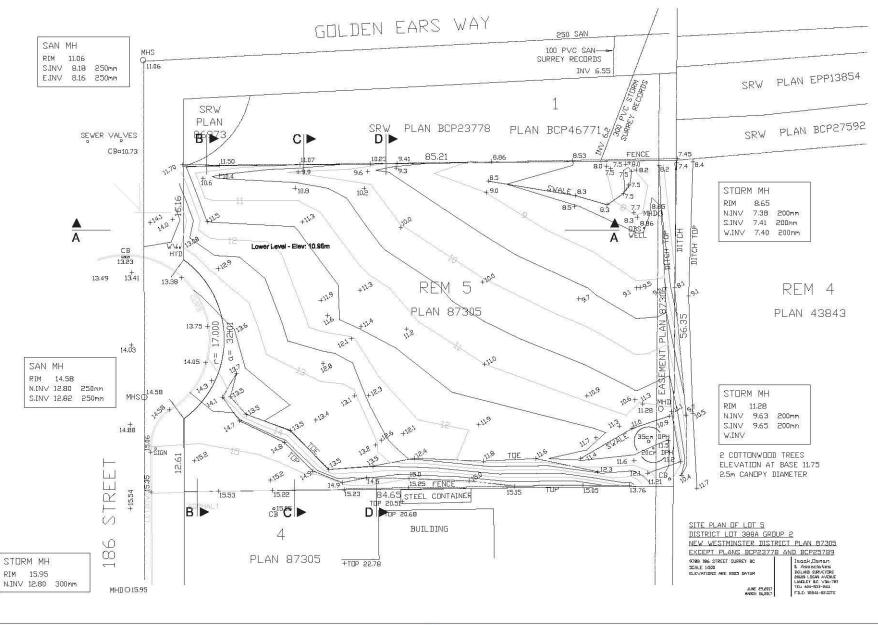

submission	YY-Mo-DD
BP Submission	17-08-21
DP re-Submission	17-07-18
internal BP Review re-Submission	17-07-28

Consultant:


Permit Seal: m² Architecture inc. 106 - 2893 West 41st Avenue Vancouver BC, V&N 3C5




Smith Bros & Wilson Ltd. **New Head Office** 9788 186 Street, Surrey, B.C., V4N 3N7 copyright reserved


sheet title Survey Plan - w/ Level 1-2 - Reference Only

date Aug 15, 2017

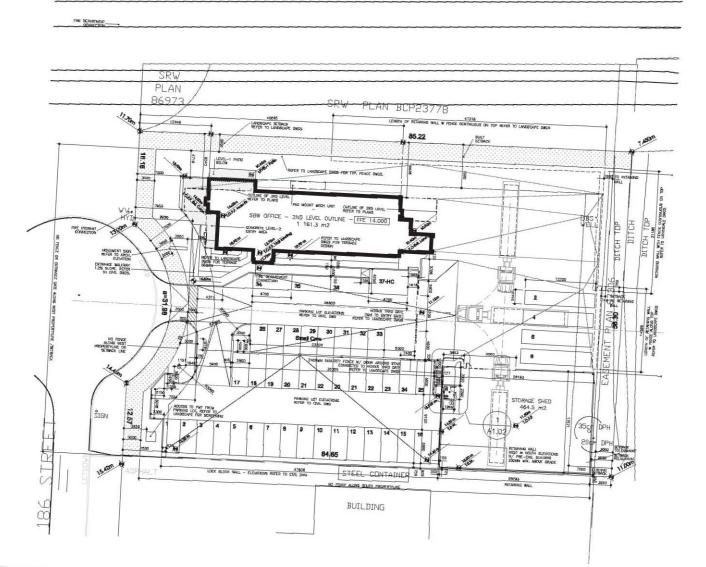

submission YY-Mo-DD	Consultant					
BP Submission 17-08-21 DP re-Submission 17-07-18 Internal BP Review re-Submission 17-07-28		m² Architecture inc. 106 - 2993 West 41st Avenue Vancauver BC, V&N 3CS	Project Smith Bros & Wilson Ltd. New Head Office 9788 188 Street, Surrey, B.C., V4N 3N7	DO NOT scale the clouding - only arrite or or before that be	sheet title SITE PLAN scale 1:200 date Aug 15, 2017	sheer no.

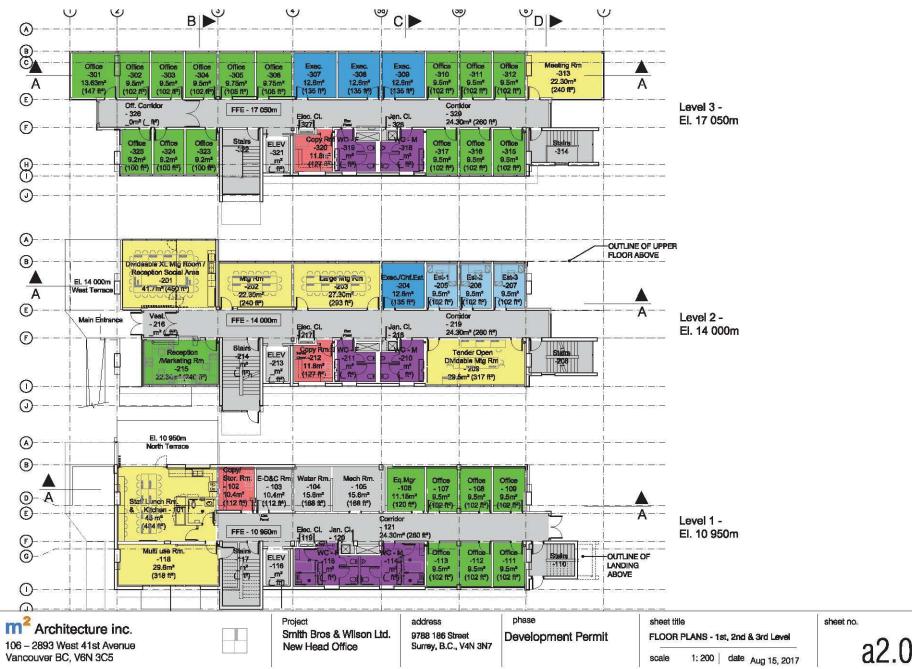

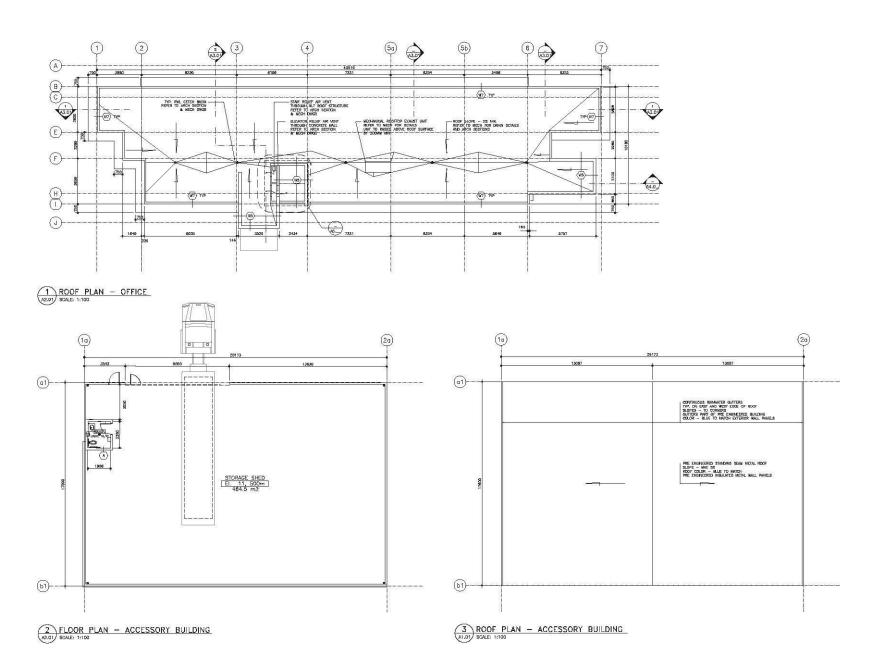

submission	YY-Mo-DD	Consultant:
BP Submission	17-08-21	8
DP re-Submission	17-07-18	
internal BP Review re-Submission	17-07-28	

Permit Seal:



Project
Smith Bros & Wilson Ltd.
New Head Office
9788 186 Street, Surrey, B.C., V4N 3N7

Copyright reserved:

The Contector shall welly creditar responsible for all discussions.

DO RET can't had thready: any excess or critistics in collate recovered in an apparative dividence without collains.

The content of the content of the content collains.

The content of the content of the content collains.


The content collains are increased and content collains.

The content collains are increased and content collains are content collains.


sheet title
ROOF PLAN - Office
ROOF & FLOOR PLAN - Accessory Bldg

1:100 date Aug 15, 2017


a2

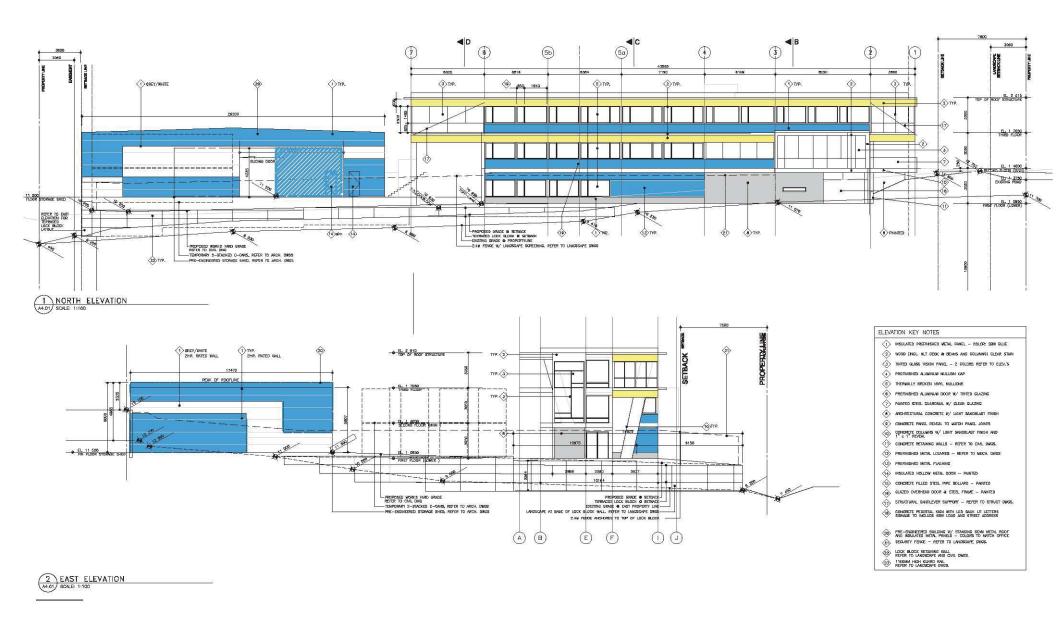



submission	YY-Mo-DD	Consultant:	Permit Seal:		N	Project	copyright reserved	sheet til	le		sheet no.
BP Submission	17-08-21			m ² Architecture inc. 106 – 2893 West 41st Avenue		Smith Bros & Wilson Ltd. New Head Office	The Contraction had welfly and be responsible for all dimensions. BO NOT scale the drawing- any eros or artistics shall be reported to as equated Architecture without delay.	ELEV	ATIONS - I	North & East	-4.04
DP re-Submission	17-07-18			Vancouver BC, VéN 3C5	 		The Copyright to all divigins and showings are the property of an approach Another; but, the production or up for any purpose or from that sufficient by an assured Anothershap is facilitation.	2:		E9	12/111
internal BP Review re-Sub	mission 17-07-28		l _k			9798 186 Street, Surrey, B.C., V4N 3N7		scale	1:100	date Aug 15, 2017	at.UI

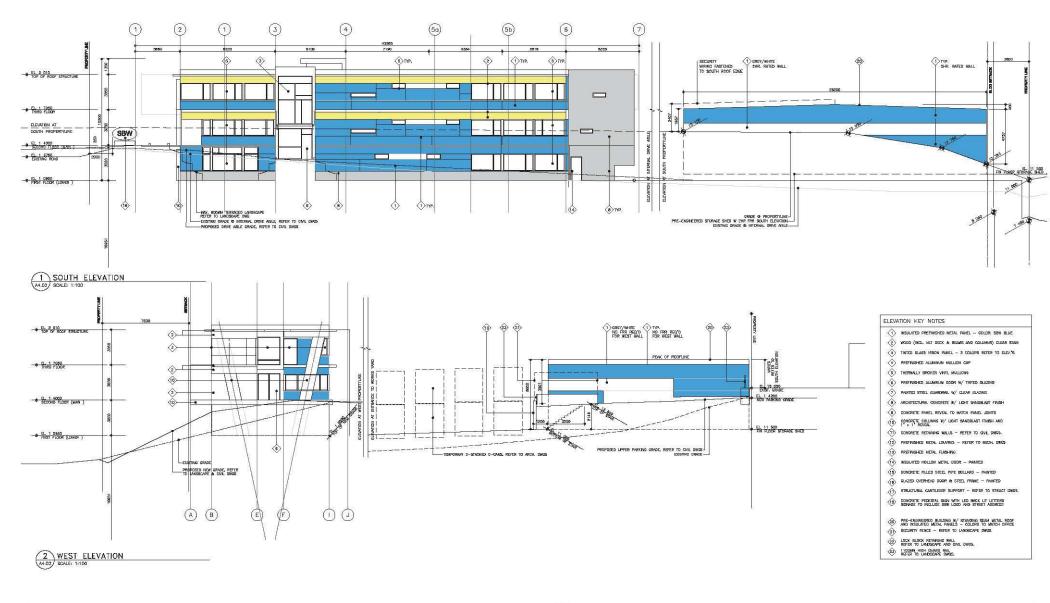

submission	YY-Mo-DD	Consultant:	Permit Seal:	¥	N	Project	copyright reserved	sheet title		aheet no.
BP Submission	17-08-21			m ² Architecture inc. 106 – 2893 West 41st Avenue		Smith Bros & Wilson Ltd. New Head Office	The Contection had welly and be responsible for all discretions. BO ROT accile the discretion are easier or antisture shall be recorded to magazine Architecture without delay.	ELEVATION	NS - South & West	4.00
DP re-Submission	17-07-18			Vancouver BC, V&N 3C5			The Copyrights to all designs and strontings are the property of an exposed Architecture, Represendation or up for any purpose or than that sufficient by measured Architecture is flatisticities.			12/1 III
internal BP Review re-Sub	mission 17-07-28		į,			9788 186 Street, Surrey, B.C., V4N 3N7		scale 1:1	00 date Aug 15, 2017	UT.UZ

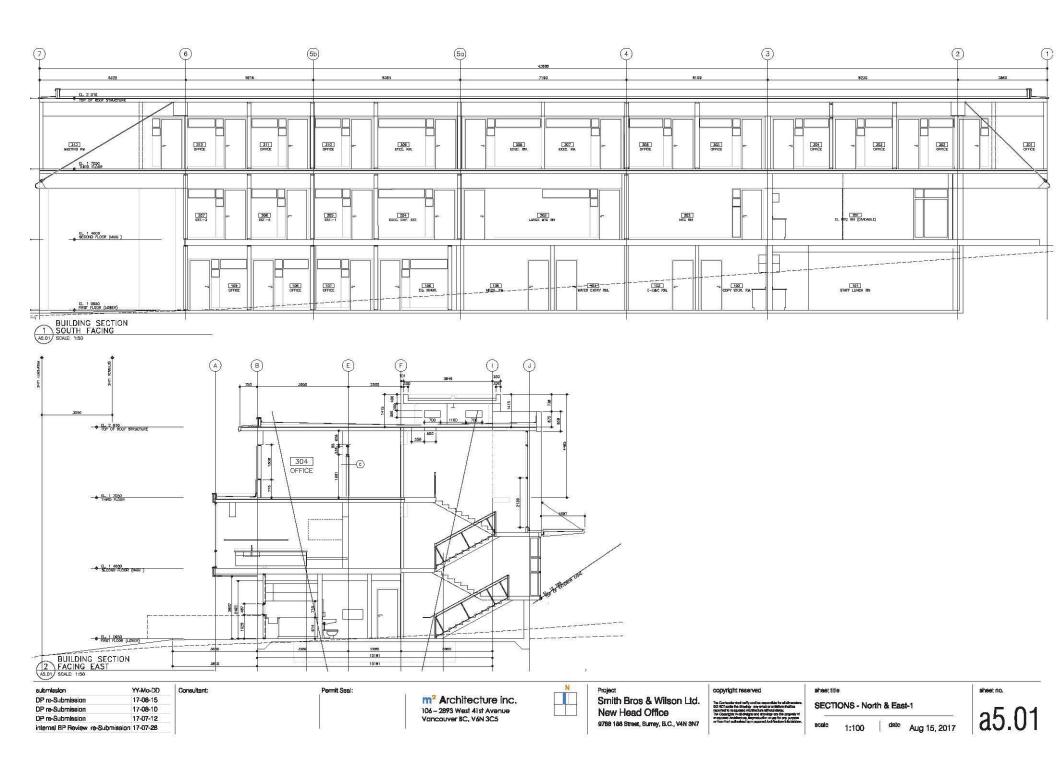

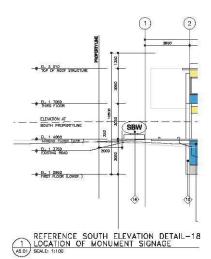

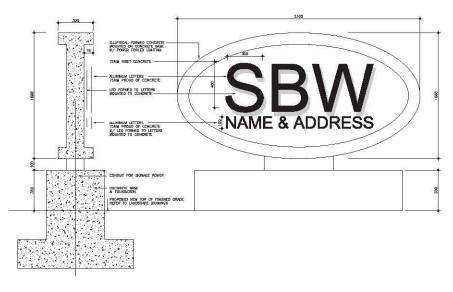

SIGNAGE ELEV. DETAIL - 18

MONUMENT SIGN

SCALE: 110

submission	YY-Mo-DD
DP re-Submission	17-08-15
DP re-Submission	17-08-10
DP re-Submission	17-07-12
internal BP Review re-Submission	17-07-28

Consultant:

Permit Seal:


m² Architecture inc. 106 – 2893 West 41st Avenue Vancouver BC, V6N 3C5



Project
Smith Bros & Wilson Ltd.
New Head Office
9788 186 Street, Surrey, B.C., V4N 3N7

co	ryright reserved	1
The C	contention what welfly condition responsibile for self offeren Offereign fine disturbing - any extension contentions shall be self for an expected diversion between without delays, opposition to all diversion and storage one the proposi- quest between the management of the copy page.	

sheet titl	sheet title							
SIGN	AGE DETAI	LS						
scale	1:100	date	Aug 15, 2017					

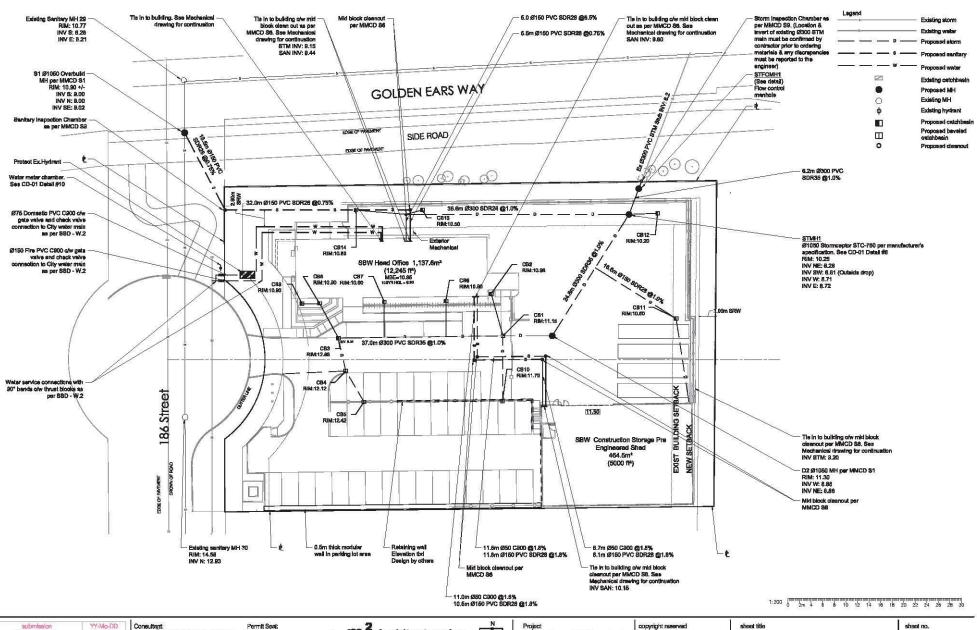

lasued for DP 15-08-17

Van der Zalm + sasociatee Inc.

Pada A Reseation - Ohr Brydnachte
Uden Dodge - Lundquarke
Uden Dodge - Lundquarke
1 - Mark 1,000 I Period Cale
1 - Mark 1,000 I P

m² Architecture inc. 106 – 2893 West 41st Avenue Vancouver BC, V6N 3C5

Project
Srnith Bros & Wilson Ltd.
New Head Office
9788 186 Street, Surrey, B.C., V4N 3N7
VDZ job NO.: CV 2017-02

SERVICING PLAN
scale AS SHOWN | data AUG 15, 2017

CV-01

Smith Bros & Wilson Ltd. - New Head Office

9788 186 Street, Surrey, B.C., V4N 3N7

Issued for Development Permit

Contact Information	Other Key Contacts:			
van der Zalm + associates Inc. Project Landscape Architecture	Smith Bros. & Wilson Ltd. Project Owner	m² Architecture inc. Project Building Architecture	Bush, Bohlman & Partners Structural Engineer	
Suite 1 - 20177 97th Avenue Langley, British Columbia, V1M 4B9 1. 604 882 0024 f. 604 882 0042	8729 Aisne St, Vancouver, BC V6P 3P1 t. 604 324-1155	106 – 2893 West 41st Avenue Vancouver BC, V6N 3C5 t. 604 724 7602	1500 W Georgia St #1550, Vancouver, BC V6G 2Z6 t. 604 688-9861	
Primary project contact: Travis Martin travis@vdz.ca o. 604 882 0024 x25				
Alternate contacts (incase away): Mark van der Zalm	van der Zalm + associates Project Civil Engineer	Legal Address and Description:		
Principal Landscape Architect mark@vdz.ca o. 604 882 0024 x22	Suite 1 - 20177 97th Avenue Langley, British Columbia, V1M 4B9 t. 604 882 0024	LOT S DISTRICT LOT 388A PLAN 87305 NWD GROUP 2, EXCEPT PLAN BCP25789 & EXC PL BCP23778 P.I.D.: 016-676-645		



Sheet List Table

Sheet Number	Sheet Title
L-00	COVER SHEET
L-01	TREE PROTECTION PLAN
L-02	SITE AND FENCING PLAN
L-03	PLANTING PLAN
LD-01	LANDSCAPE DETAILS
LD-02	LANDSCAPE SECTIONS
LD-03	LANDSCAPE SECTIONS
LN-01	LANDSCAPE NOTES

submission	DD-Mo-YY
Issued for DP Resubmission	10-08-17
Issued for DP Resubmission	15-08-17
Issued for Building Permit	16-08-17
Jeeuard for DP Regulamiseion	20_08_17




m² Architecture inc. 106 - 2893 West 41st Avenue Vancouver BC, V6N 3C5



Smith Bros & Wilson Ltd. New Head Office 9788 186 Street, Surrey, B.C., V4N 3N7 VDZ job no: DP2017-13 copyright reserved

sheet title

scale AS SHOWN date Aug 29, 2017

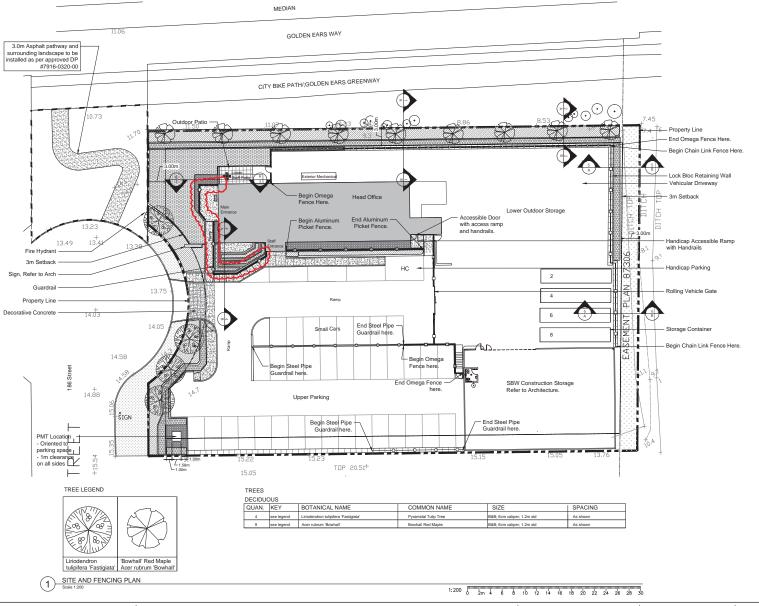

MATERIALS LEGEND

KEY	REF.	DESCRIPTION
	4 LD-01	CONCRETE SIDEWALK
	3 LD-01	HYDRAPRESED SLAB Colour: Natural Pattern: Running Bond Manufacturer: Abbotsford Concrete
	6 LD-01	ALLAN BLOCK RETAINING WALL
		CONCRETE RETAINING WALL Finish: Sack Finish Colour: Natural
		LOCK-BLOCK WALL
a	5 LD-01	PICNIC TABLE Model:EP2850 Colour: Black Finish, IPE Wood Manufacturer: Equipare Oty: 1
	7 LD-01	DRIP STRIP See Critical Landscape Notes for Specifications
		PERENNIAL AND SHRUB PLANTING
		EVERGREEN HEDGE
00000		WILDFLOWER SEED MIX Supplier: Premier Pacific Product Name: Coastal Wildflower Mix with Hard Fescue
		TURF SEED MIX Supplier: Premier Pacific
* * * * * *		SOD

FENCE LEGEND

KEY	REF.	DESCRIPTION
	9 LD-01	OMEGA FENCE Location: North and East Colour: Black Height: 2.4 M
	8 LD-01	CHAIN LINK SECURITY FENCE Location: West Colour: Black viryl coated chain link Height: 2.4 M All Metal to be Hot Dipped Galvanized
		STEEL PIPE GUARDRAIL All Metal to be Hot Dipped Galvanized Colour: Black Mount: Surface Height: 1070mm
		ALUMINUM PICKET GUARDRAIL Cotour: Black Moure: Surface Height: 1070mm

submission	DD-Mo-YY
Issued for DP Resubmission	10-08-17
Issued for DP Resubmission	15-08-17
Issued for Building Permit	16-08-17
Issued for DP Resubmission	29-08-17



Permit Seal:

m² Architecture inc. 106 – 2893 West 41st Avenue Vancouver BC, V6N 3C5 Project
Smith Bros & Wilson Ltd.
New Head Office
9788 186 Street, Surrey, B.C., V4N 3N7
VDZ job no: DP2017-13


copyright reserved


The Contractor shall verify and be responsible for a dimension DO NOT scale the drawing—any encolor amissions shall be reported for misqueed Actifieither without delay. The Copplight to of bedger and detenting are the property of misquand Arctifiecture, Reproduction or use for any purpose or than the durinteed by misqueed Architecture for other hard undersed by misqueed Architecture.


sheet title


SITE AND FENCING PLAN


scale AS SHOWN date Aug 29, 2017

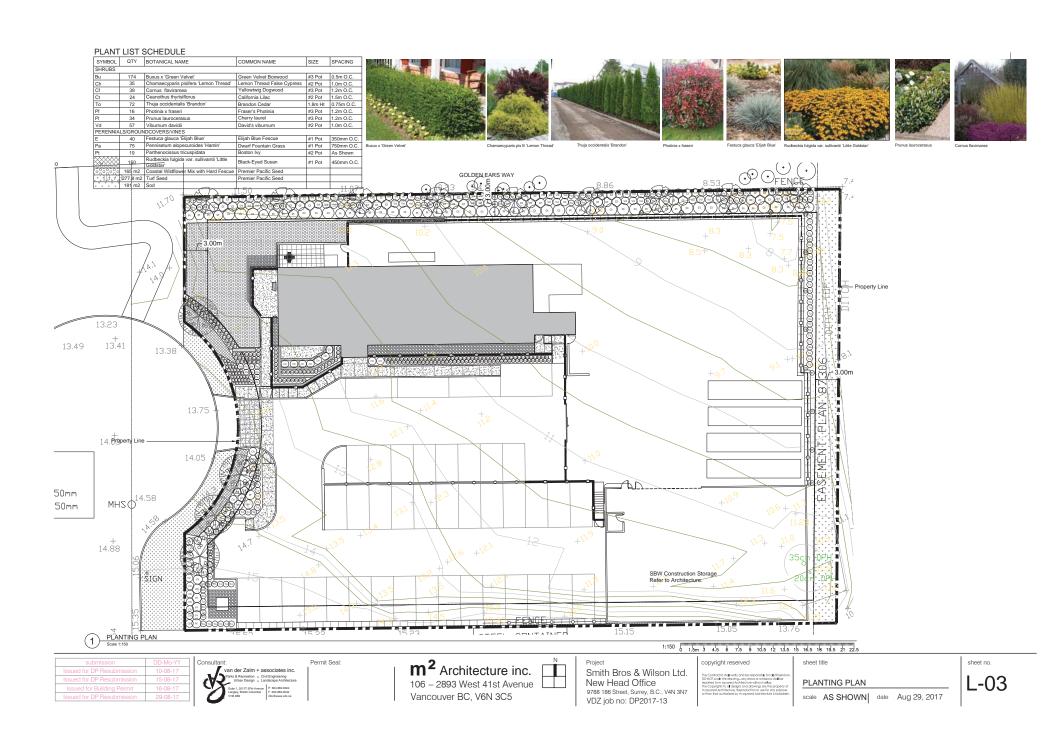


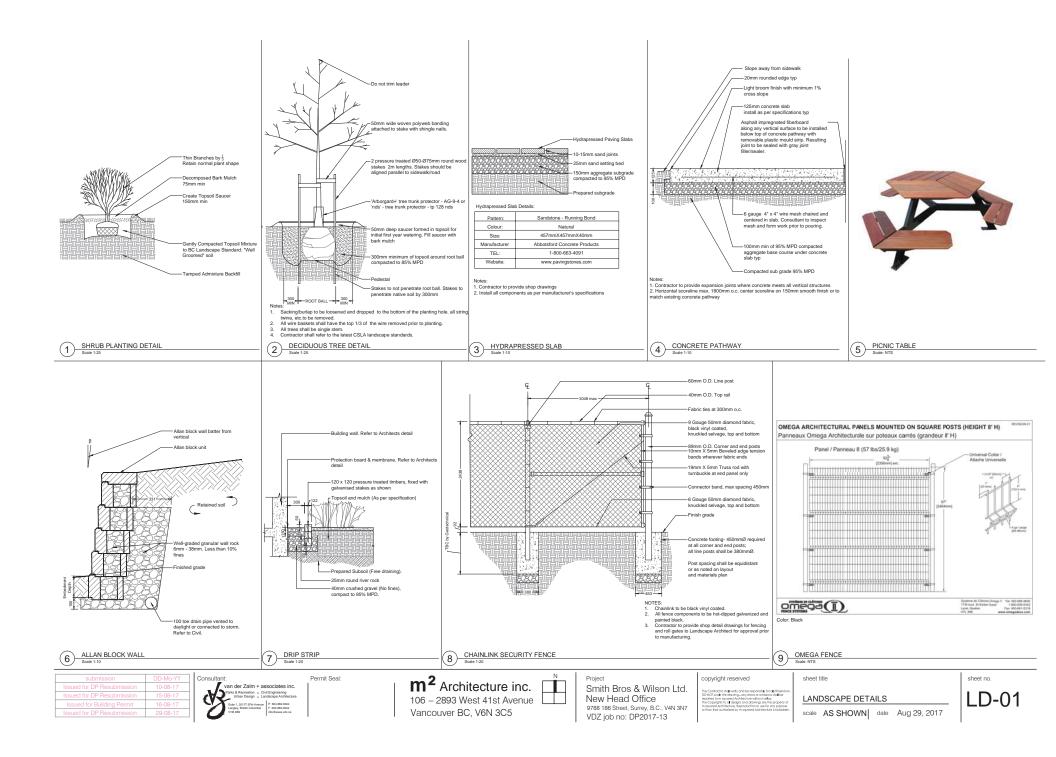

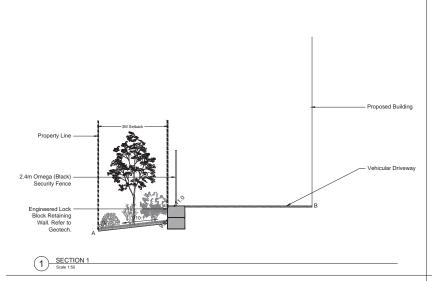

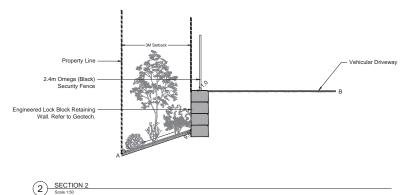

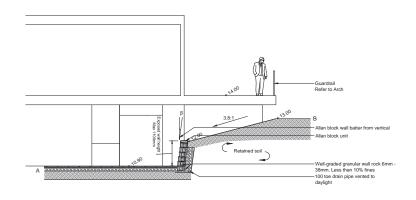

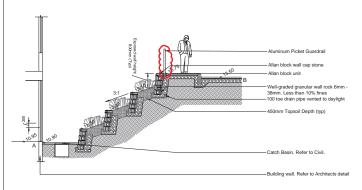

4 SECTION 4

van der Zalm + associates inc.
Parls & Roccation + Cult Engineering
Unter Delign + Landscoper*
Sode 1 **

Permit Seal:

m² Architecture inc. 106 - 2893 West 41st Avenue Vancouver BC, V6N 3C5

Smith Bros & Wilson Ltd. New Head Office 9788 186 Street, Surrey, B.C., V4N 3N7 VDZ job no: DP2017-13 copyright reserved


The Controctor shall verify and be responsible for a dimension DO NOT scale the drawing—any encour or anisons shall be reported for misqueed Architecture without debuy. The Copplight to of bedger and detening are the property of misquand Architecture, Reproduction or use for any purpose or than that durinteed by misqueed Architecture for footbody or of them that durinteed by misqueed Architecture for footbody.


sheet title

LANDSCAPE SECTIONS

scale AS SHOWN date Aug 29, 2017

sheet no. LD-02

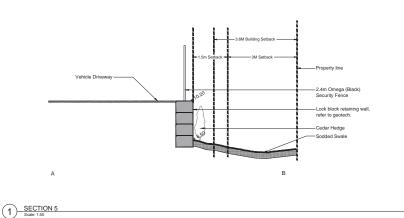

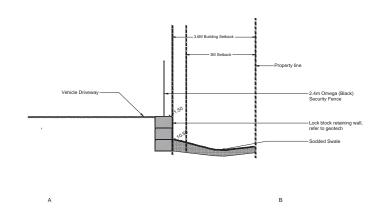

submission	DD-Mo-YY
Issued for DP Resubmission	10-08-17
Issued for DP Resubmission	15-08-17
Issued for Building Permit	16-08-17
Issued for DP Resubmission	29-08-17

Consultant:

van der Zalm + associates inc.

Peres & Rocession - Cult Engineering
Untern Dezign + Landscape Antoniscuse
Landscape Landscape Landscape
Landscape Landscape of Pol. MEZIGNE
Landscape Landscape of Pol. MEZIGNE
File Mezigne File Mezigne File Mezigne of Pol. MEZIGNE
File Mezigne F

Permit Seal:

M² Architecture inc. 106 – 2893 West 41st Avenue Vancouver BC, V6N 3C5

e I

2 SECTION 6
Scale: 1:50

Smith Bros & Wilson Ltd. New Head Office 9788 186 Street, Surrey, B.C., V4N 3N7 VDZ job no: DP2017-13 copyright reserved

The Contractor that werfy and be responsible for all dimensions. Do NOT scale the diawing- any errors or amissions shall be reported for in squared Architecture without debut for Ecopylist's to a diseign and denings are the property of in squared Architecture. Reproduction or use for any purpose or their health of schools of their shall otherwise the sound of their health of schools of their shall otherwise the sound of their health of their schools.

sheet title

LANDSCAPE SECTIONS

scale AS SHOWN date Aug 29, 2017

sheet no.

LD-03



INTER-OFFICE MEMO

TO:

Manager, Area Planning & Development

- North Surrey Division

Planning and Development Department

FROM:

Development Services Manager, Engineering Department

DATE:

July 17, 2017

PROJECT FILE:

7817-0255-00

RE:

Engineering Requirements (Commercial/Industrial)

Location: 9788 186 Street

DEVELOPMENT PERMIT

The following Works and Services must be completed as a condition of the Development Permit and subsequent Building Permit issuance:

Property and Right-of-Way Requirements

Dedicate Pcl 1 of Pcl 'A' Bylaw Plan 66776.

Works and Services

- Construct the east half of 186 Street to the Industrial Limited Local Road Standard.
- Construct an 11.0 meter concrete driveway letdown at the cul-de-sac.
- Construct a 3.0 meter wide asphalt Multi-use Pathway (MUP) and letdown to connect the cul-de-sac and the Golden Ears Way MUP.
- Provide water, sanitary, and storm service connections to service the proposed development.
- Provide stormwater management features (quality and quantity measures along with detention to meet the ISMP) and register corresponding Restrictive Covenants.

DEVELOPMENT VARIANCE PERMIT

There are no engineering requirements relative to issuance of the Development Variance Permit.

Rémi Dubé, P.Eng.

Development Services Manager

CE₄



Table 1: Summary of Tree Preservation by Tree Species:

Tree Species	Existing	Remove	Retain
Alder a	nd Cottonwood Tre	ees	
Alder	3	0	3
Cottonwood	4	4	0
	eciduous Trees der and Cottonwood	d Trees)	
Big Leaf Maple	2	0	2
C	oniferous Trees		
Red Cedar	10	0	10
Total (excluding Alder and Cottonwood Trees)	12	0	12
Additional Trees in the proposed Open Space / Riparian Area			
Total Replacement Trees Proposed (excluding Boulevard Street Trees)			4
Total Retained and Replacement Trees			4

LANDSCAPE ARCHITECTURE

URBAN DESIGN RECREATION

PARKS &

Tel: 604 882 0024

Avenue

Fax: 604 882 0042

V1M 4B9

www.vdz.ca Suite 1, 20177 97

Langley, BC



Tree Preservation Summary

Surrey Project No:

Address: 9788 - 186 St. Surrey, BC

Registered Arborist: Austin Peterson PN 1570A

On-Site Trees	Number of Trees		
	Trainibor or Troop		
Protected Trees Identified	4		
(on-site and shared trees, including trees within boulevards and proposed streets			
and lanes, but excluding trees in proposed open space or riparian areas)			
Protected Trees to be Removed	4		
Protected Trees to be Retained	2		
(excluding trees within proposed open space or riparian areas)			
Total Replacement Trees Required:			
Alder & Cottonwood Trees Requiring 1 to 1 Replacement Ratio			
2 X one (1) = 2			
All other Trees Requiring 2 to 1 Replacement Ratio			
X two (2) =			
Replacement Trees Proposed	4		
Replacement Trees in Deficit	0		
Protected Trees to be Retained in Proposed [Open Space / Riparian Areas]			
	1		
Off-Site Trees	Number of Trees		
Protected Off-Site Trees to be Removed	0		
Total Replacement Trees Required:	-		
Alder & Cottonwood Trees Requiring 1 to 1 Replacement Ratio			
X one (1) = 0			
All other Trees Requiring 2 to 1 Replacement Ratio			
X one $(2) = 0$			
Replacement Trees Proposed	0		
Replacement Trees in Deficit	0		

Summary, report and plan prepared and submitted by: Austin Peterson PN 1570A

Date: July 10, 2017

(Signature of Arborist)

LANDSCAPE ARCHITECTURE

RECREATION

URBAN DESIGN

Tel: 604 882 0024 www.vdz.ca Suite 1, 20177 97


Avenue

Fax: 604 882 0042


V1M 4B9

Langley, BC

PARKS &

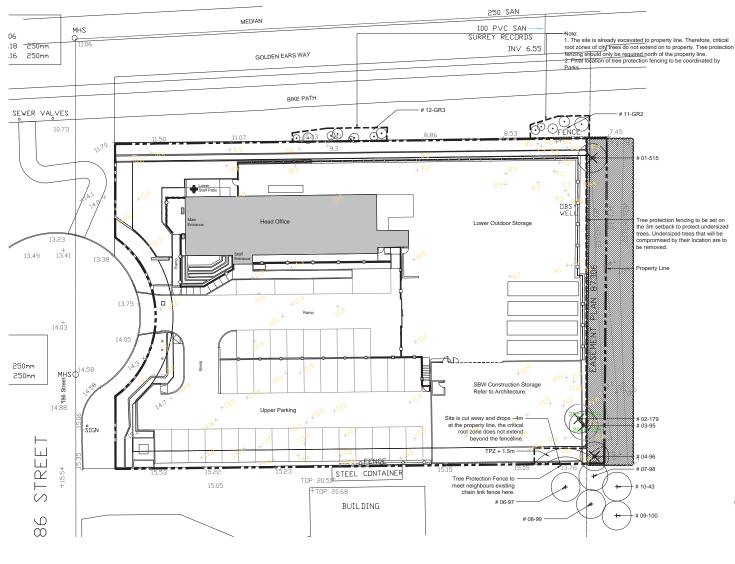

LEGEND

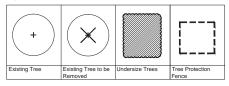

Specifications for Construction
Failure to meet these specifications will result in inspection failure and subsequent delay in issuance of other permits:

- of other permits:

 1. 12 m ("4") height

 2. 2"s 4"s to be used for vertical posts, top and bottom rails and cross-bracing (in an "X"); round, un-tented vertical posts may be used with a minimum diameter of 9 cm

 3. Spacing between vertical posts to be no further apart than 3.7 m (12") on centre


 4. Structure must be study with vertical posts driven frully into the ground

 5. Continuous plastic mesh screening (e.g. orange snow fencing)

 6. Posted with visible signage and vising that encrocantener timide the protected area is forbidden

 7. Located at distances based on tree diameter, use table below:

Trunk Diameter (DBH) measured at 1.4 m from the ground	Critical Root Zone minimum fence distance from the tree
20 cm (7.9")	1.2 m (3.9°)
25 cm (9.8")	1.5 m (4.9°)
30 cm (11.8°)	1.8 m (5.9°)
35 cm (13.8")	2.1 m (6.9°)
40 cm (15.7°)	2.4 m (7.9°)
45 cm (17.7°)	2.7 m (8.9°)
50 cm (19.7")	3.0 m (9.8°)
55 cm (21.7°)	3.3 m (10.8°)
60 cm (23.6°)	3.6 m (11.8°)
75 cm (29.5°)	4.5 m (14.8°)
90 cm (35.4°)	5.4 m (17.7°)
100 cm (39.4°)	6.0 m (19.7°)

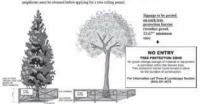

CITY OF SURREY TREE PROTECTION FENCING

TREE PROTECTION PLAN

1:200 0 2m 4 6 8 10 12 14 16 18 20 22 24 26 28 30

submission	DD-Mo-YY
Issued for DP Resubmission	10-08-17
Issued for DP Resubmission	15-08-17
Issued for Building Permit	16-08-17
leguard for DP Regulamission	20,08,17



Permit Seal:

m² Architecture inc. 106 - 2893 West 41st Avenue Vancouver BC, V6N 3C5



copyright reserved The Controctor shall verify and be responsible for a dimension DO NOT scale the drawing—any encour or anisons shall be reported for misqueed Architecture without debuy. The Copplight to of bedger and detening are the property of misquand Architecture, Reproduction or use for any purpose or than that durinteed by misqueed Architecture for footbody or of them that durinteed by misqueed Architecture for footbody. sheet title

TREE PROTECTION PLAN

sheet no. L-01

scale AS SHOWN date Aug 29, 2017

CITY OF SURREY

(the "City")

DEVELOPMENT VARIANCE PERMIT

NO.: 7917-0255-00

Issued To: 1897 HOLDINGS LTD.

(the "Owner")

Address of Owner: 8729 - Aisne Street

Vancouver BC V6P 3P1

- 1. This development variance permit is issued subject to compliance by the Owner with all statutes, by-laws, orders, regulations or agreements, except as specifically varied by this development variance permit.
- 2. This development variance permit applies to that real property including land with or without improvements located within the City of Surrey, with the legal description and civic address as follows:

Parcel Identifier: 016-676-645 Lot 5 District Lot 388A Group 2 New Westminster District Plan 87305 Except Plans BCP25789 and BCP23778

9788 - 186 Street

(the "Land")

3. Surrey Zoning By-law, 1993, No. 12000, as amended is varied as follows:

In Section F. Yards and Setbacks, of Part 48 "Light Impact Industrial Zone (IL)", the minimum rear yard setback for an accessory building is reduced from 7.5 metres (25 ft.) to 3.6 metres (12 ft.).

- 4. This development variance permit applies to only that portion of the buildings and structures on the Land shown on Schedule A which is attached hereto and forms part of this development variance permit. This development variance permit does not apply to additions to, or replacement of, any of the existing buildings shown on attached Schedule A, which is attached hereto and forms part of this development variance permit.
- 5. The Land shall be developed strictly in accordance with the terms and conditions and provisions of this development variance permit.

6.	This development variance permit shall lapse if the Owner does not substantially start any construction with respect to which this development variance permit is issued, within two (2) years after the date this development variance permit is issued.			
7.	The terms of this development variance permit or any amendment to it, are binding on all persons who acquire an interest in the Land.			
8.	This development variance permit is not a building permit.			
AUTHORIZING RESOLUTION PASSED BY THE COUNCIL, THE DAY OF , 20 . ISSUED THIS DAY OF , 20 .				
		Mayor – Linda Hepner		
	-	City Clerk – Jane Sullivan		