#### 112 AVE 104 AVE GUILDFORD, 96 AVE **88 AVE** FLEETWOOD 80 AVE **72 AVE** NEWTON CLOVERDALÉ **64 AVE** 56 AVE **48 AVE** 120 ST 40 AVE 32 AVE SOUTH SURREY 24 AVE 16 AVE 144 ST 152 ST 136 ST 8 AVE 160 ST 0 AVE 168 ST 176 ST ST 184

# City of Surrey PLANNING & DEVELOPMENT REPORT File: 7917-0186-00

Planning Report Date: July 24, 2017

#### PROPOSAL:

#### • Development Permit

to permit the development of a two-storey industrial building in Bridgeview.


LOCATION: 13099 - 116 Avenue

OWNER: Abdul Hamid

Salikat Hamid

ZONING: IL

**OCP DESIGNATION:** Industrial

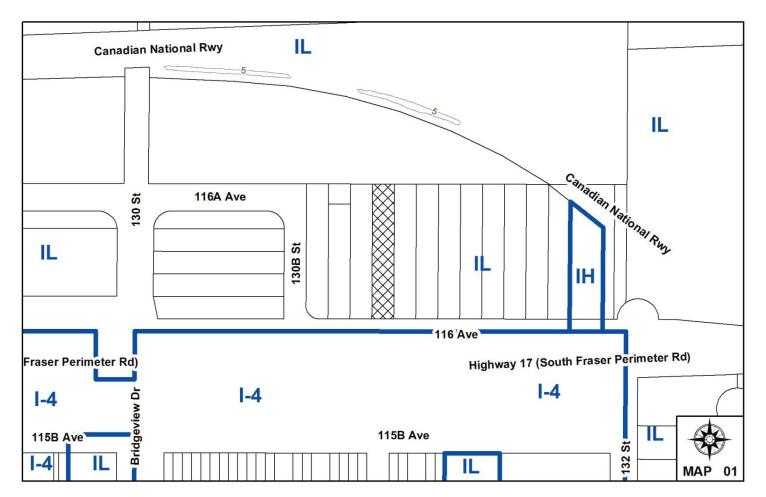

#### **RECOMMENDATION SUMMARY**

 Approval to draft Form and Character, Hazard Lands and Sensitive Ecosystems Development Permit.

#### **DEVIATION FROM PLANS, POLICIES OR REGULATIONS**

None.

#### **RATIONALE OF RECOMMENDATION**

- Complies with the Industrial designation in the OCP.
- The proposed building form and land use are appropriate for this industrial area.
- The proposal supports the City's Economic Development and Employment Lands Strategies.
- The proposal includes consideration for the streamside setback area associated with an A/O class ditch on an adjacent property.
- The applicant has submitted a geotechnical report which includes completion of drill exploration and comments pertaining to site preparation and foundation design. The Geotechnical Report addresses the Development Guidelines for Hazard Lands outlined in the Official Community Plan (OCP), and will be incorporated into the proposed Development Permit.

#### **RECOMMENDATION**

The Planning & Development Department recommends that:

- 1. Council authorize staff to draft Form and Character, Hazard Lands and Sensitive Ecosystems Development Permit No. 7917-0186-00 generally in accordance with the attached drawings (Appendix II) and the Geotechnical Report prepared by Braun Geotechnical Ltd.
- 2. Council instruct staff to resolve the following issues prior to approval:
  - (a) Registration of a 15 metre (49 ft.) wide combined Restrictive Covenant/Right-of-Way at the rear of the property to ensure safeguarding and maintenance of the streamside protection area.

#### **REFERRALS**

Engineering: The Engineering Department has no objection to the project.

Ministry of Transportation & Infrastructure (MOTI):

A referral to MOTI is not required since the proposed building is under 4,500 square metres (48,435 sq.ft.) in size, and the proposal

does not require a rezoning

Surrey Fire Department: The Surrey Fire Department has no objection to the project.

#### **SITE CHARACTERISTICS**

<u>Existing Land Use:</u> Existing trailer to be removed.

#### **Adjacent Area:**

Direction	Existing Use	OCP Designation	<b>Existing Zone</b>
North:	Trucking and	Industrial	IL
Worth.	cartage company,	maastrar	IL
	CN railway line		
	and CN Intermodal		
	Yard.		
East:	Truck and truck	Industrial	IL
	part storage.		
South (Across 116 Avenue):	South Fraser	Industrial	I-4 (By-law No.
	Perimeter Road.		5942)
West:	Warehouse	Industrial	IL
	building		

#### **DEVELOPMENT CONSIDERATIONS**

- The subject site is located at 13099 116 Avenue in Bridgeview, and is designated Industrial in the Official Community Plan (OCP) and zoned "Light Impact Industrial Zone (IL)".
- The subject property is approximately 2,020 square metres (0.5 acre) in size.
- The applicant is proposing to construct a two-storey, industrial warehouse building approximately 410 square metres (4,415 sq.ft.) in size on the subject site. The proposed building will have a floor area ratio (FAR) of 0.20 and lot coverage of 14.5%, which is consistent with the maximum FAR of 1.0 and lot coverage of 60% in the IL Zone. Building setbacks are also consistent with the IL Zone requirements.
- Development Permit 7914-0051-00 was previously issued for this proposal in 2014. It has since expired. The current proposal has not changed from the 2014 application with the exception of landscaping modifications to accommodate the Sensitive Ecosystem Development Permit requirements. These requirements were not present in 2014.

#### **PRE-NOTIFICATION**

• In accordance with Council policy, a Development Proposal Sign was erected on the property. To date, staff have not received any comments with respect to the proposal.

#### **DESIGN PROPOSAL AND REVIEW**

- The subject site must be filled and raised approximately 1.2 metres (4 ft.) in order to comply with flood proofing requirements.
- The proposed building is primarily constructed of concrete block with hardie panels and metal cladding. The primary colours of the proposed building are light gray and muted blue.
- The main floor of the proposed building will consist of a showroom and a warehouse. Ancillary office space is located on the second floor.
- The south building elevation, which faces 116 Avenue and South Fraser Perimeter Road, will include significant glazing.
- The architect proposes to extend the second floor of the proposed building approximately 2.4 metres (8 ft.) outward from the first storey, resulting in a building overhang that creates a weather-protected outdoor patio on the first floor adjacent to the main entrance of the proposed building.
- A pedestrian walkway will connect the main building entrance with the parking lot and the sidewalk along 116 Avenue. The sidewalk, as well as a boulevard and street lights, will be installed as part of the subject development proposal, at the Building Permit stage.
- The site accommodates a total of seven (7) parking stalls, including one (1) for the disabled, which complies with the Zoning By-law.

• Two (2) loading bays, accessed by metal overhead doors, are located along the north and west building elevations. The north loading bay will accommodate larger (9 metre / 30 ft. long) trucks, while the west loading bay will accommodate smaller vehicles.

- Proposed outdoor lighting includes soffit lighting along the south and west building elevations, as well as wall-mounted LED lighting along the north building elevation.
- The applicant proposes to install metal decorative fencing, attached to concrete block posts that match the proposed building, on the subject site. The fence will be installed along the east and west property lines, south of the proposed building, as well as at the south end of the parking lot, and will include a gate at the vehicular driveway and the pedestrian walkway to 116 Avenue.
- A pad-mounted transformer will be installed near the south property line adjacent to the vehicular driveway off 116 Avenue. The transformer will be installed outside (south) of the proposed metal fence, but will be screened by landscaping (cedars and roses).

#### Trees and Landscaping

- There are no existing trees on the subject site.
- The applicant proposes to install landscaping along the south lot line and along the southern portion of the east and west lot lines, in front of the proposed building.
- The proposed landscaping includes a number of low-level species including of junipers, roses, feather grass and laurels. Four (4) red maple trees will also be installed.

#### Development Permit for Sensitive Ecosystems

- A previously existing red coded ditch is identified along the south lot line of the neighbouring property to the north. The ditch was illegally infilled by the neighboring tenant sometime between April 2009 and December 2010. On January 12, 2011, City staff issued a letter to the property owners, instructing them to take immediate action to remove the fill material from the ditch. The ditch has since been illegally infilled a second time. The City has initiated a process to have the watercourse re-opened.
- City staff have confirmed that the infilled watercourse on the neighbouring property was previously identified as a Class A/O ditch, which requires a 10-metre (33 ft.) setback from top-of-bank under Part 7A Streamside Protection of the Zoning By-law No. 12000. In addition, the subject site falls within a Development Permit Area (DPA) for Sensitive Ecosystems.
- The applicant retained a Qualified Environmental Professional (QEP) from SER Environmental Management Ltd. who confirmed that the previously existing ditch had been infilled and as such it was not possible to prepare a Riparian Areas Regulation (RAR) report or an Ecosystem Development Plan. However, in anticipation of the future re-opening of the watercourse the applicant is proposing to protect 10-metres (33 ft.) at the rear of the property and plant the area with native vegetation. The area will also be fenced. The proposed planting and fencing plan will be included in the Development Permit.

• The proposal meets Part 7 Streamside Protection of the Zoning By-law No. 12000 by protecting a 10-metre (33 ft.) wide setback area at the rear of the property. The applicant is also required to register a 15-metre (49 ft.) wide no-build restrictive covenant and statutory right-of-way for drainage access to further protect the setback area prior to Development Permit issuance.

#### Development Permit for Hazard Lands (Flood Prone Areas)

- The site is subject to a Development Permit (DP) for Hazard Lands for flood prone areas under the Official Community Plan (OCP) as the site is within the 200-year flood plain of the Fraser River.
- The applicant has submitted a geotechnical report prepared by Braun Geotechnical Ltd. which
  includes completion of drill exploration and comments pertaining to site preparation and
  foundation design. The Geotechnical Report addresses the Development Guidelines for
  Hazard Lands outlined in the Official Community Plan (OCP), and will be included in the
  proposed Development Permit.

#### Proposed Signage

- The applicant proposes one (1) non-illuminated, channel letter fascia sign along the south building elevation facing 116 Avenue. The proposed sign complies with the Sign By-law.
- No free-standing signs are proposed.

#### SUSTAINABLE DEVELOPMENT CHECKLIST

The applicant prepared and submitted a sustainable development checklist for the subject site, on June 4, 2014. The table below summarizes the applicable development features of the proposal based on the seven (7) criteria listed in the Surrey Sustainable Development Checklist.

Sustainability	Sustainable Development Features Summary
Criteria	
1. Site Context &	The subject site is located in an industrial area in Bridgeview near
Location	South Fraser Perimeter Road and Bridgeview Drive.
(A1-A2)	
2. Density & Diversity	The proposed density is 0.20 FAR
(B1-B7)	The proposed two-storey industrial building supports the City's
	Economic Development and Employment Land Strategies
3. Ecology &	The following Low Impact Development Standards are utilized:
Stewardship	Absorbent soils (greater than 300mm in depth); Roof downspout
(C1-C4)	disconnection; On-site infiltration trenches / sub-surface chambers;
	and Staff recycling bins are provided
4. Sustainable	The project will result in the construction of the sidewalk and
Transport &	boulevard along the lot frontage
Mobility	An on-site bicycle rack is provided
(D <sub>1</sub> -D <sub>2</sub> )	• A bus stop is located approximately 500 metres (0.3 mile) from the
	subject site
5. Accessibility &	The following Crime Prevention Through Environmental Design

Safety (E1-E3)	(CPTED) principles are incorporated: A ramp will provide wheelchair access to the building entrance; The site will be well-lit areas with exterior LED lighting; Security gates; and On-site security and monitoring
6. Green Certification (F1)	Not applicable
7. Education & Awareness (G1-G4)	Not applicable

#### **INFORMATION ATTACHED TO THIS REPORT**

The following information is attached to this Report:

Appendix I. Lot Owners, Action Summary and Project Data Sheets

Appendix II. Site Plan, Building Elevations, Landscape Plan, Streamside Protection Area

Planting and Fencing Plan, and Perspective

#### **INFORMATION AVAILABLE ON FILE**

• Geotechnical Report prepared by Braun Geotechnical Ltd. dated July 22, 2014.

original signed by Ron Gill

Jean Lamontagne General Manager Planning and Development

KL/da

#### Information for City Clerk

Legal Description and Owners of all lots that form part of the application:

1. (a) Agent: Name: Gerry Blonski

Address: Unit 1A, 12468 - 82 Avenue

Surrey, BC V<sub>3</sub>W<sub>3</sub>E<sub>9</sub>

2. Properties involved in the Application

(a) Civic Address: 13099 - 116 Avenue

(b) Civic Address: 13099 - 116 Avenue

Owner: Salikat Hamid

Abdul Hamid

PID: 011-237-228

Lot 32 Section 4 Block 5 North Range 2 West New Westminster District Plan 6630

### **DEVELOPMENT DATA SHEET**

#### Proposed/Existing Zoning: IL

Required Development Data	Minimum Required / Maximum Allowed	Proposed
LOT AREA* (in square metres)		
Gross Total		
Road Widening area		
Undevelopable area		
Net Total		2,022 sq.m.
LOT COVERAGE (in % of net lot area)		
Buildings & Structures	60%	14.5%
Paved & Hard Surfaced Areas		
Total Site Coverage		
SETBACKS ( in metres)		
Front (south)	7.5 meters	26.5 meters
Rear (north)	7.5 meters	53 meters
Side #1 (west)	7.5 meters	7.5 meters
Side #2 (east)	7.5 meters or o.o meters	o.o meters
BUILDING HEIGHT (in metres/storeys)		
Principal	18 meters	9.2 meters
Accessory	6 meters	N/A
NUMBER OF RESIDENTIAL UNITS	1	0
Bachelor		
One Bed		
Two Bedroom		
Three Bedroom +		
Total		
FLOOR AREA: Residential		N/A
FLOOR AREA: Commercial		
Retail		
Office		
Total		N/A
FLOOR AREA: Industrial		410 sq.m.
FLOOR AREA: Institutional		N/A
TOTAL BUILDING FLOOR AREA		410 sq.m.

<sup>\*</sup> If the development site consists of more than one lot, lot dimensions pertain to the entire site.

## Development Data Sheet cont'd

Required Development Data	Minimum Required / Maximum Allowed	Proposed
DENSITY		
# of units/ha /# units/acre (gross)		
# of units/ha /# units/acre (net)		
FAR (gross)		
FAR (net)	1.0	0.20
AMENITY SPACE (area in square metres)		N/A
Indoor		·
Outdoor		
PARKING (number of stalls)		
Commercial		N/A
Industrial	4	7
Residential Bachelor + 1 Bedroom		N/A
2-Bed		
3-Bed		
Residential Visitors		N/A
Institutional		N/A
Total Number of Parking Spaces	4	7
Number of accessible stalls	1	1
Number of small cars		
Tandem Parking Spaces: Number / % of Total Number of Units		N/A
Size of Tandem Parking Spaces width/length		N/A

Heritage Site NO	Tree Survey/Assessment Provided	NO
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#### **Drawing List**

DWG. NO. DRAWING TITLE

Architectural

SHEET LIST				
SHEET NUMBER	SHEET NAME			
01	COVER			
02	SURVEY PLAN			
03	BUILDING CODE SYNOPSIS			
A1	SITE PLAN & ZONING SYNOPSIS			
A2	FIRST FLOOR PLAN			
A3	SECOND FLOOR PLAN			
A4	ROOF PLAN			
A5	ELEVATIONS			
A6	ELEVATIONS			
A7	BUILDING SECTIONS			
A8	BUILDING SECTION			
A9	BUILDING SECTION			
A10	DETAILS			
A11	DETAILS			
A12	CONSTRUCTION ASSEMBLIES / DOOR SCHEDULE			

DWG. NO. DRAWING TITLE

STRUCTURAL

S1	PILE LOCATION
S2	STRUCTURAL DETAILS
S3	STRUCTURAL DETAILS
S4	STRUCTURAL DETAILS
S5	STRUCTURAL DETAILS

DWG. NO. DRAWING TITLE

MECHANICAL

M1	MECHANICAL PLAN
M2	MECHANICAL PLANS
M3	MECHANICAL PLANS
M4	MECHANICAL DETAILS

DWG. NO. DRAWING TITLE

ELECTRICAL
E1 SITE PLAN
E2 POWER LAYOUT
E3 LIGHTING LAYOUT
E4 SPECIFICATION

DWG. NO.

DRAWING TITLE

CIVIL

C1 SITE GRADING & UTILITIES PLAN

DWG. NO.

DRAWING TITLE

LANDSCAPE L1 PLAN VIEW

SURVEY

DWG. NO. SURVEY PLAN





#### INDUSTRIAL BLDG

13099 - 116 AVE SURREY

Abdul Hamid

GERRY BLONSKI ARCHITECT SUITE 1A - 12468 - 82 AVE., SURREY, B.C. V3W 3E9

TEL: (604) 572 3608 FAX: (604) 572 3760 EMAIL: gerry@gerryblonskiarchitect.com WEB: www.gerryblonskiarchitect.com CONTACT: Gerry Blonski, m.a.i.b.c.

KONTROL ENGINEERING 1090 AUGUSTA AVE BURNABY BC V5A 2V4

604-291-7434 SHARAT.CHANDE@GMAIL.COM

Clover Mechanical / Electrical Engineering 6100-163B Street, Surrey, BC V3S 3W2 Email: cam.clovercontracting@nmail.com Clover Mechanical / Electrical Engineering

6100-163B Street, Surrey, BC V3S 3W2 Email: cam.clovercontracting@gmail.com

TRILLIUM ENGINEERING LTD #7-100 WOOD ST NEW WESTMINSTER B.C. V3M 0H6 604-722-0881


Braun Geotechnical

Landscaping: C. KAVOLINAS & ASSOCIATES INC.

2462 JONQUIL COURT ABBOTSFORD BC. V3G 3E8 PHONE: 604-857-2376 Surveyor:

Cameron Land Surveying Ltd. Unit 206 - 16055 Fraser Highway Surrey, B.C. V4N OG2

Phone: 604-597-3777 Fax: 604-597-3783

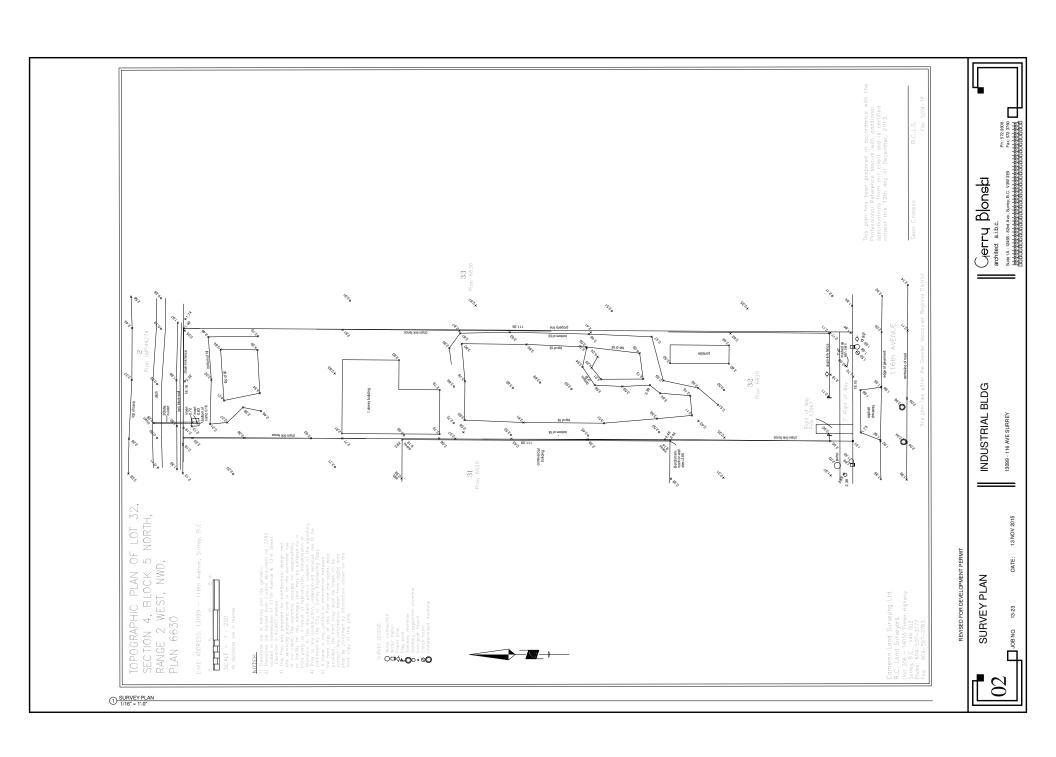

1.3.3.3.(1)
BUILDING AREA IS LESS THAN 600 SQ.M.
BUILDING HEIGHT IS 2 STORIES
OCCUPANCIES ARE GROUP 'D' AND 'F3'

BUILDING IS ONLY BEOLIBED TO COMPLY WITH PART 9 BUT IT IS DESIGNED TO PART 3

2. MAJOR OCCUPANCIES

TABLE 3.1.2.1
GROUP D BUSINESS & PERSONAL SERVICE
GROUP F2 MEDIUM HAZARD INDUSTRIAL

3. BUILDING SIZE / DESCRIPTION

3.2.2 BUILDING AREA BUILDING HEIGHT BUILDING FACES 3406 SQ. FT. (316 SQ. M) 2 STORIES 2 STREETS NOT SPRINKLED BUILDING IS

4. BUILDING CLASSIFICATION

A.) GROUP 'D' 3.2.2.60 - MAXIMUM BUILDING AREA PERMITTED 1 000 SO M 1 000 SQ. M 2 - STORIES PERMITTED NOT REQUIRED 34 HR. FIRE SEPARATION COMBUSTIBLE MAXIMUM BUILDING HEIGHT COMBUSTIBLE CONSTRUCTION SPRINKLERS FLOOR ASSEMBLIES

ROOF ASSEMBLY

GROUP 'F2' GROUP 'F2' 3.2.2.76 MAXIMUM BUILDING AREA PERMITTED 750 SQ. M MAXIMUM BUILDING HEIGHT COMBUSTIBLE CONSTRUCTION 2 - STORIES PERMITTED SPRINKI FRS NOT REQUIRED FLOOR ASSEMBLIES 45 MINS HR. F.R.R. NO RATING BOOF ASSEMBLY

45 MINS HR FRR

5. SEPARATION BETWEEN MAJOR OCCUPANCIES

LOADBEARING WALL COLUMNS

TABLE 3.1.3.1 D TO F2 - NO RATING

6. SPATIAL SEPARATION

NORTH WALL WALL AREA 887 SQ.FT. (82.4 SQ.M.) 3.2.3.2.(1)
LIMITING DISTANCE
UNPROTECTED OPENINGS PERMITTED 172 FT. (52.4M) TABLE 3.2.3.1.B WALL CONSTRUCTION 100% NO RATING

SOUTH WALL

887 SQ.FT. (82.4 SQ.M.) WALL AREA TOTAL WALL AREA FROM GRADE TO U/S ROOF

GRADE TO US ROOF

3.23.2.(1)

LIMITING DISTANCE TO CENTER LINE 116 AVE

LINPROTECTED OPENINGS PERMITTED

TABLE 3.2.3.1.B

100%

NO RATING

EAST WALL WALL AREA 2752.7 SQ.FT. (255.7

SQ M) SQ.M.) TOTAL WALL AREA FROM GRADE TO U/S ROOF

3.2.3.2.(1) WALL RATIO WALE BATIO LIMITING DISTANCE TO GLASS 3.2.3.1.(4) UNPROTECTED OPENINGS PERMITTED 6.67 FT. (2.0M)

TABLE 3.2.3.1.B 2752.7X0.08 = 220 SQ.FT.
UNPROTECTED OPENINGS PROVIDED 68.76 SQ.FT.

WALL CONSTRUCTION AT GLASSLINE

WALL CONSTRUCTION

REQUIRED PROVIDED 1-HR F.R.R. 1-HR

WALL CLADDING REQUIRED PROVIDED NON-COMBUSTIBLE

WALL CONSTRUCTION AT PROPERTY LINE TABLE 3.2.3.7 WALL CONSTRUCTION

REQUIRED PROVIDED WALL CLADDING

REQUIRED PROVIDED NON-COMBUSTIBLE NON-COMBUSTIBLE

1-HR F.R.R.

2518.8 SO FT (234 SO M.)

WEST WALL WALL AREA TOTAL WALL AREA FROM GRADE TO U/S ROOF

LIMITING DISTANCE TO GLASS 25.7 FT. (7.8M)

2752.7X0.258 = 650 SF

3.2.3.1.(4) UNPROTECTED OPENINGS PERMITTED 25.8% UNPROTECTED ( TABLE 3.2.3.1.B

UNPROTECTED OPENING PROVIDED 557 4 SQ FT

7. FIRE ALARM SYSTEM

3.2.4.1(4) FIRE ALARM SYSTEM IS NOT REQUIRED.

8. FIRE DETECTORS

NOT REQUIRED 9. SMOKE DETECTORS

NOT REQUIRED.

10. MANUAL PULL STATION NOT REQUIRED

11. SMOKE ALARM

NOT REQUIRED

12. FIRE TRUCK ACCESS

3.2.5.5(2)(B)
DISTANCE FROM FIRE HYDRANT TO MOST REMOTE ENTRANCE IS 62 M.

13. STANDPIPE SYSTEM

3.2.5.8 BUILDING AREA AND HEIGHT IS LESS THAN MINIMUM REQUIRED. STANDPIPE SYSTEM IS NOT REQUIRED.

14. EMERGENCY LIGHTING

3.2.7.3(1) TO BE PROVIDED.

15. EMERGENCY POWER FOR EMERGENCY LIGHTING

3.2.7.4(1)(B)(III) POWER TO BE PROVIDED FOR 30 MINUTES.

16. EMERGENCY POWER FOR FIRE ALARM SYSTEM

17. FIRST FLOOR EXIT

GROUP D

3.4.2.1(2)
A.) MAXIMUM FLOOR AREA IS 748 SQ. FT (69 SQ. M). LESS THAN 200 SQ.M. TRAVEL DISTANCE IS NO MORE THAN 25 M. MAXIMUM OCCUPANT LOAD (TABLE 3.1.17.1) BASED ON NET AREA, EXCLUDING WASHROOM IS 31 PERSONS.

MAXIMUM OCCUPANT LOAD IS LESS THAN 60. ONE EXIT PROVIDED

B.) EXIT WIDTH.
TABLE 3.4.3.2.A
MINIMUM WIDTH PERMITTED 2'8" (800 MM)
PROVIDED 6'7" (2010 MM)

A.) MAXIMUM FLOOR AREA IS 2088 SQ. FT (193 SQ. M).
TRAVEL DISTANCE IS NO MORE THAN 25 M.
MAXIMUM OCCUPANT LOAD IS SUPPOSED TO BE 4 PERSONS.

B) NUMBER OF EXITS

3.4.2.1(2) REQUIRED 1 PROVIDED

C.) DISTANCE BETWEEN EXITS

3.4.2.3 DISTANCE BETWEEN EXITS EXCEEDS ½ DIAGONAL DISTANCE.

D.) LOCATION OF EXITS

TRAVEL DISTANCE FROM ANY POINT TO AN EXIT IS LESS THAN 30 M.

E.) EXIT WIDTH

TARI F 3 4 3 2 4

MINIMUM WIDTH PERMITTED 2' 8" (800 MM)
PROVIDED 5' 4" (1624 MM)

18. SECOND FLOOR EXIT

3.4.2.12
A) MAXIMUM FLOOR AREA IS 1178 SC, FT, (109 SO, M), LESS THAN 200
A) MAXIMUM FLOOR AREA IS 1178 SC, FT, (109 SO, M), LESS THAN 200
A) M. TRAVEL DISTANCE IS NO MORE THAN 25 M.
MAXIMUM OCCUPANT LOAD (TABLE 2.1.17.1) BASED ON NET AREA,
EXCLUDING WASHROOM AND CORRIDOR IS 11 PERSONS.
MAXIMUM OCCUPANT LOAD IS LESS THAN 62.

ONE EXIT PROVIDED

B) EXIT WIDTH

TABLE 3.4.3.2.A MINIMUM WIDTH PERMITTED

2' 8" (800 MM) 3' 0" (914 MM)

19. PLUMBING FACILITIES

FIRST FLOOR

A.1.17.1.(2)
A.) ACTUAL STAFF IS NO MORE THAN 4, MAXIMUM OCCUPANT LOAD IS SUPPOSED TO BE 4 PERSONS.

3.7.2.2.(4) B.) BOTH SEXES ARE SERVED BY A SINGLE WATER CLOSET.

3.8.2.3.(2)(A)
C.) WATER CLOSET IS UNIVERSAL TOILET ROOM

GROUP F3

A.) ACTUAL STAFF IS NO MORE THAN 4, MAXIMUM OCCUPANT LOAD IS SUPPOSED TO BE 4 PERSONS.

3.7.2.2.(4)
B.) BOTH SEXES ARE SERVED BY A SINGLE WATER CLOSET.

3.8.2.3.(2)(A)
C.) WATER CLOSET IS UNIVERSAL TOILET ROOM.

20. ACCESSIBILITY TO DISABILITIES

FIRST FLOOR

ACCESSIBILITY PROVIDED

EXISTING GRADE @P.L

208 00 SQ F

181.40 SQ.FT.

SECOND FLOOR

3.8.2.1 (2)(A) MAXIMUM FLOOR AREA IS 1176 SQ. FT. (109 SQ. M), LESS THAN 600 SQ. M

BLDG INDUSTRIAL

TOP COURSE 37" - 9 5/8"

SECOND FLOOR

FIRST FLOOR 12' - 5 5/8"

TOP COURSE

SECOND FLOOR 25' - 5 1/4"

116 AVE SURREY

erry Blonski

SYNOPSI ш CODE

DATE

S


BUILDING


② WEST ELEVATION SPATIAL SEPARATION
1/8" = 1'-0"


168.00 SQ.FT


68.76 SQ.FT.


1/8" - 1'-0"

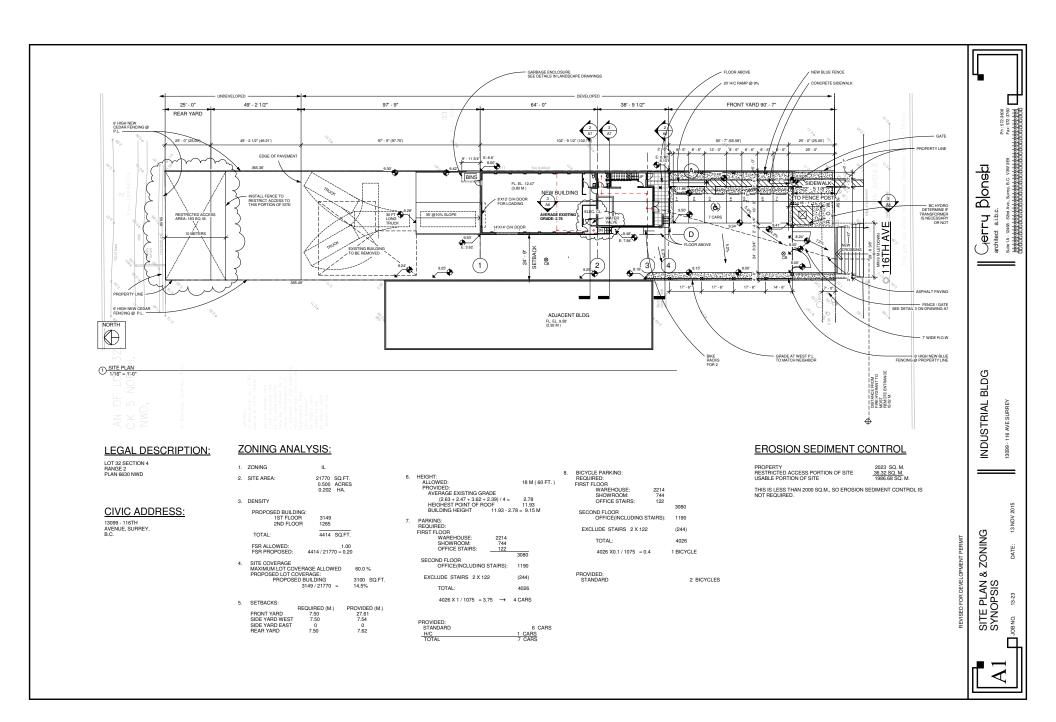


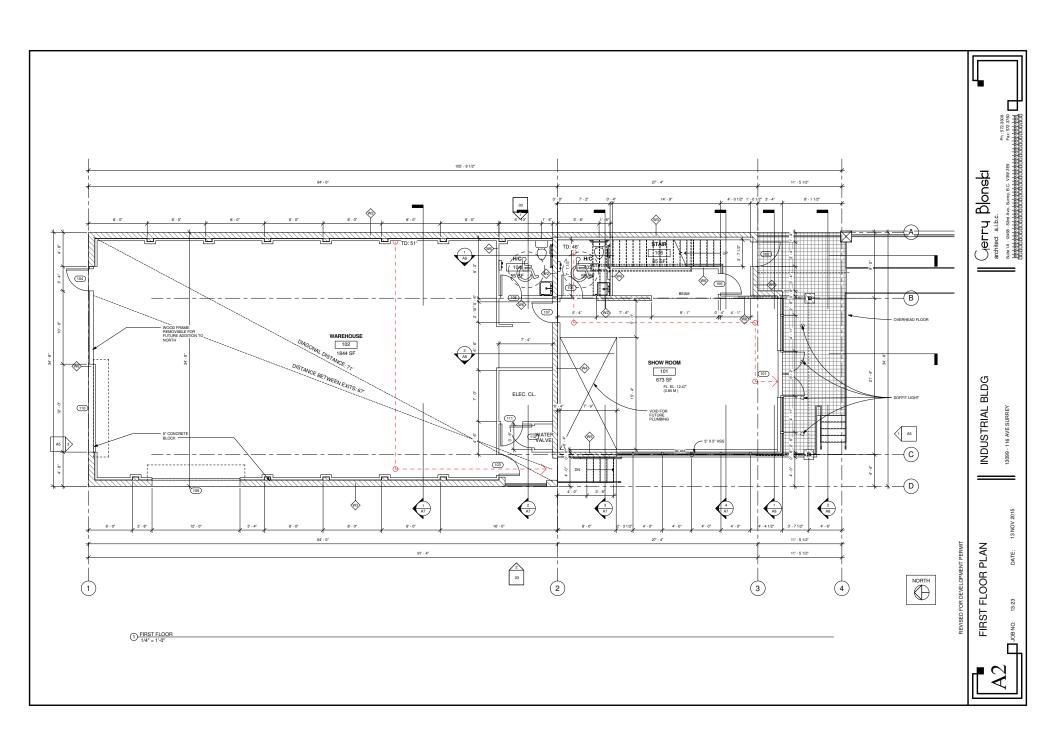


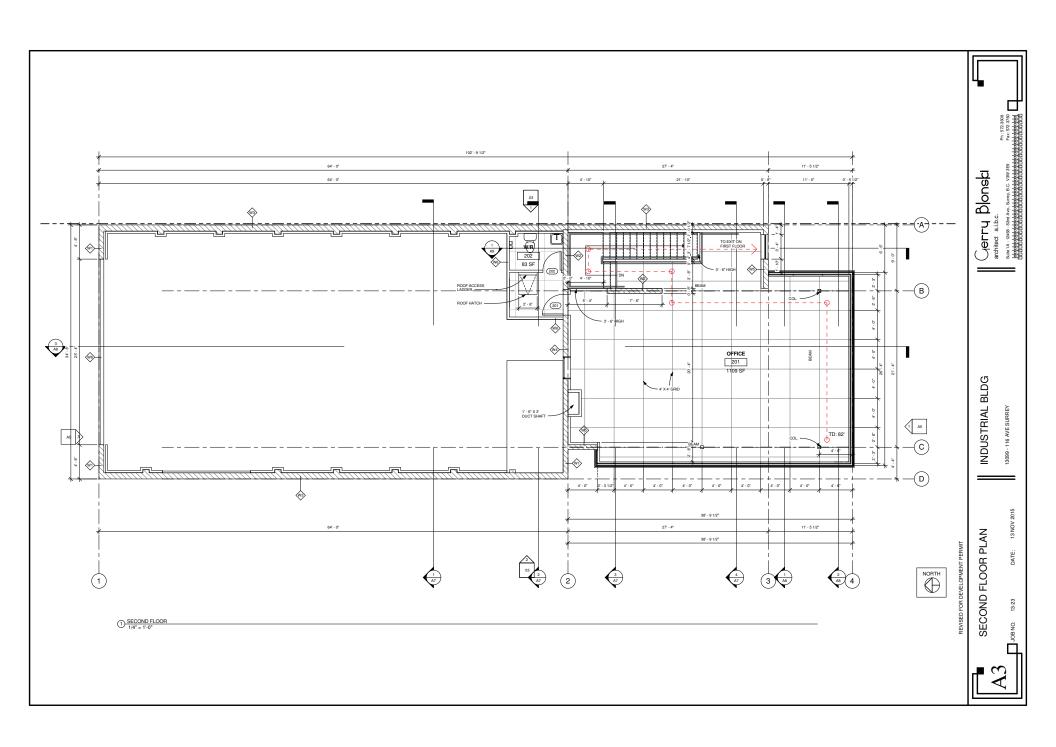


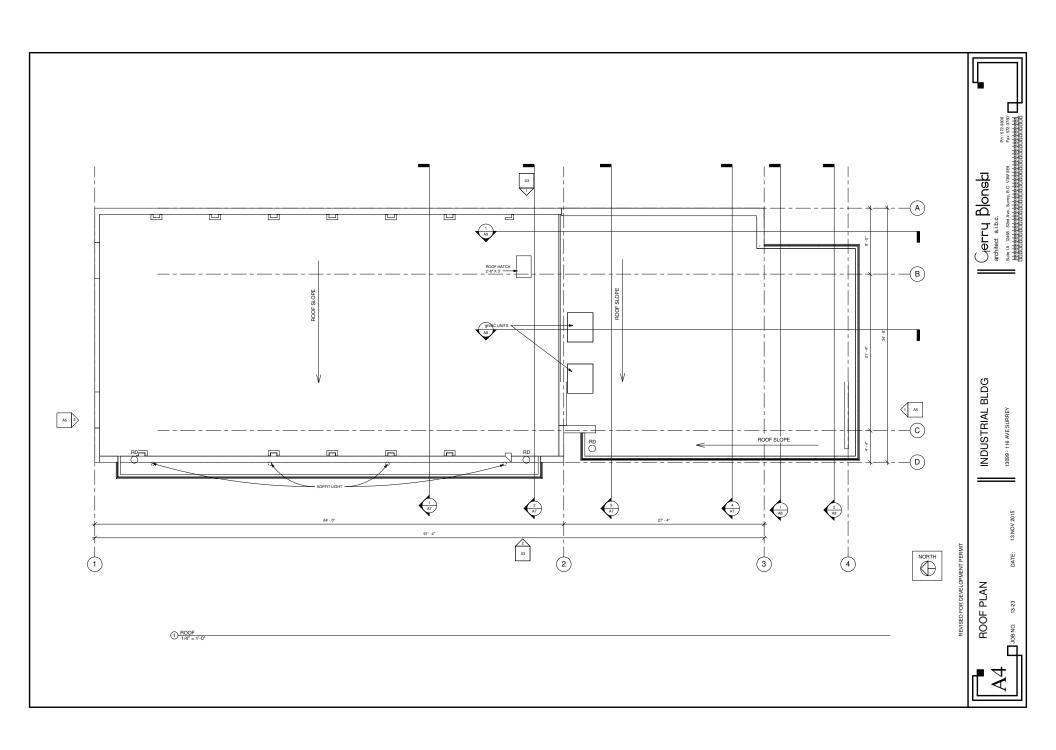


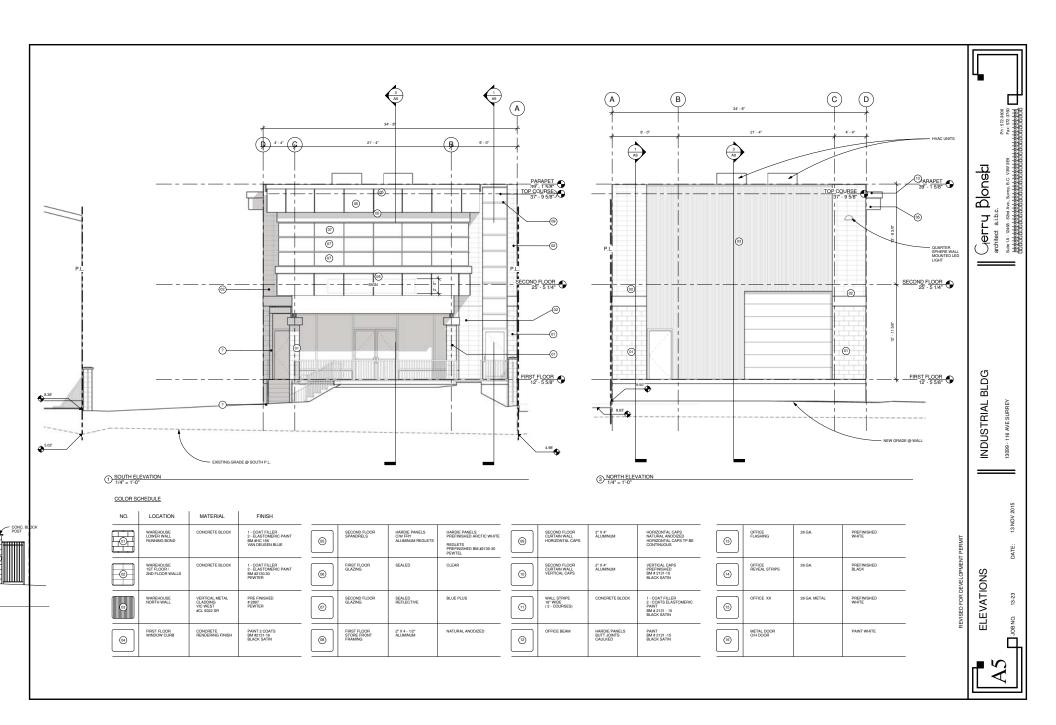


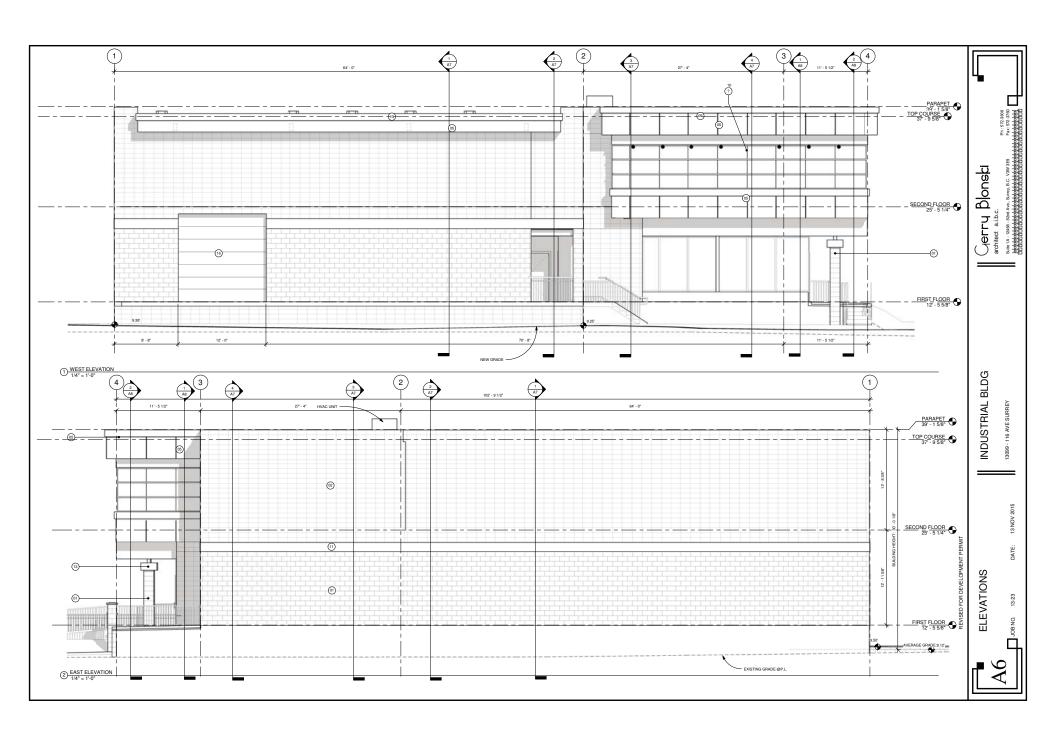


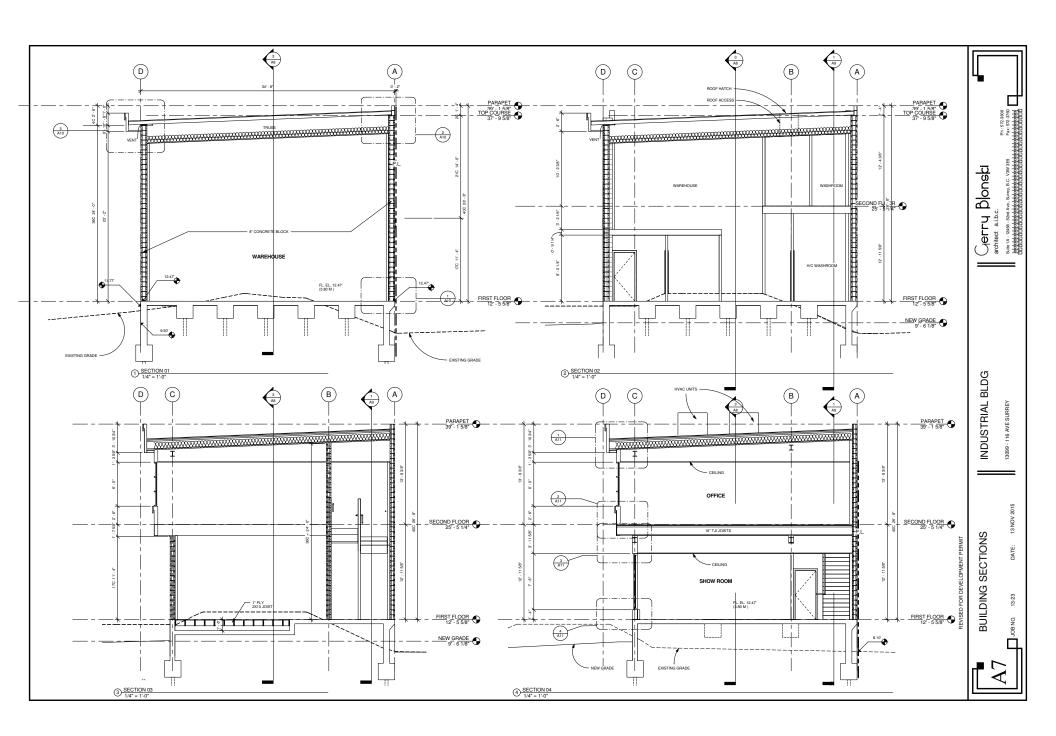


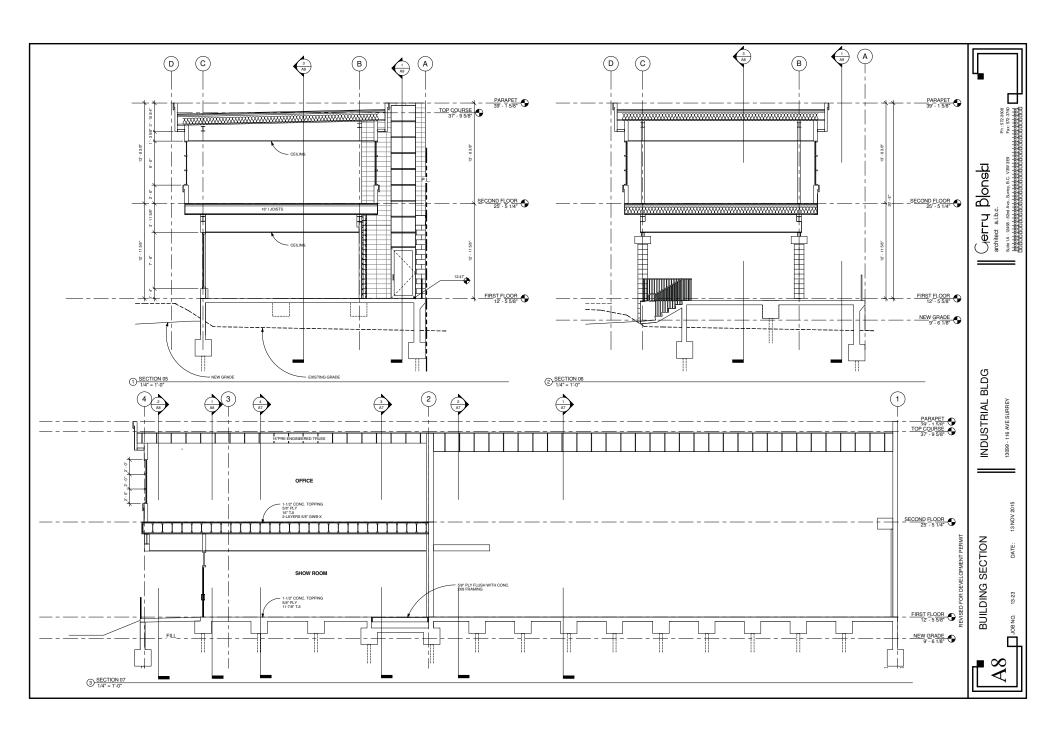

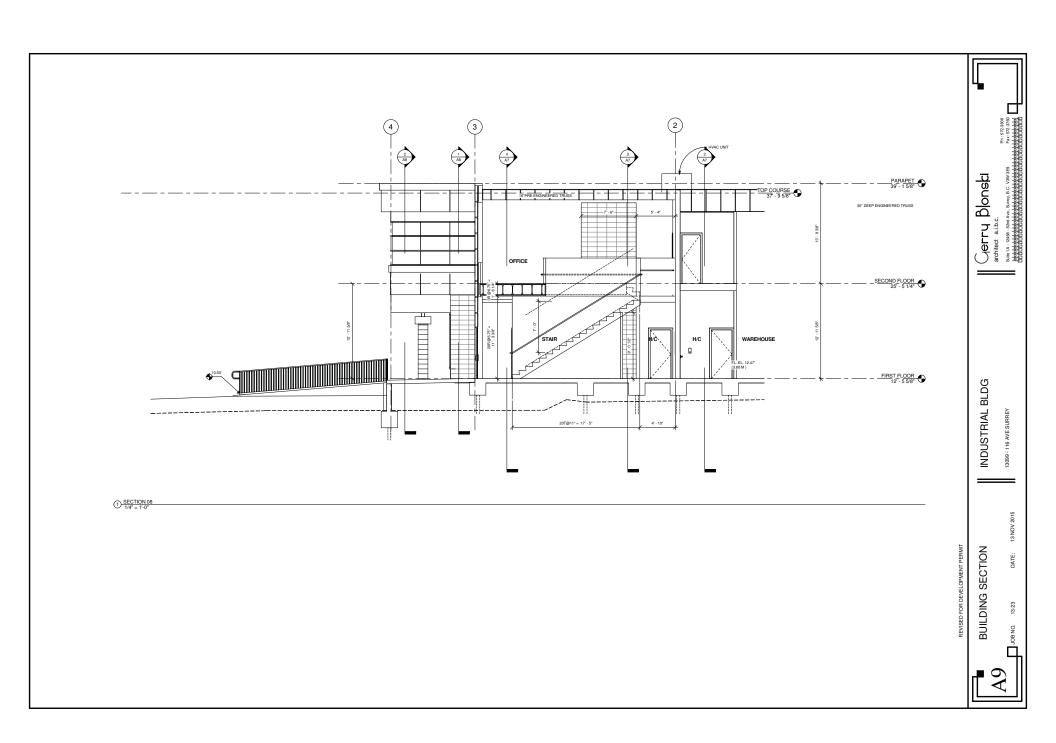

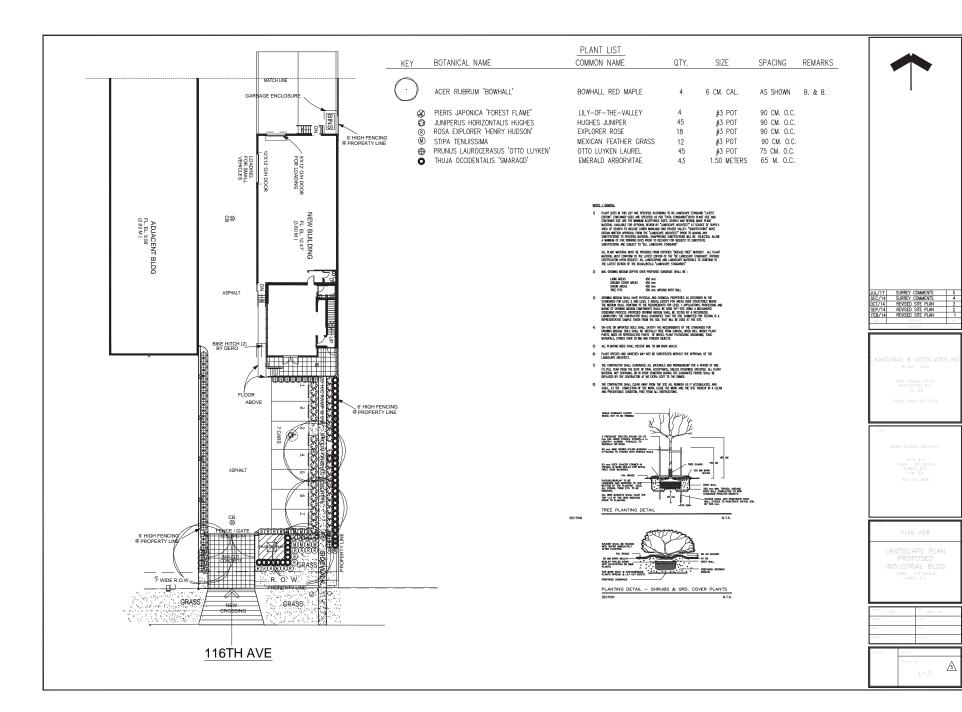

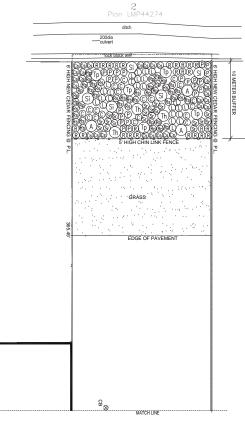

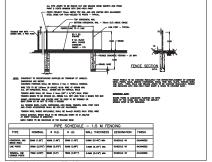

1.5m CHAIN LINK FENCE

#### PLANT LIST

KEY	BOTANICAL NAME	COMMON NAME	QTY.	SIZE	SPACING	REMARKS
CONIFERO	US TREES					
(Tp)	THUJA PLICATA	WESTERN RED CEDAR	5	1.20 METERS	AS SHOWN	B. & B.
Si	PICEA SITCHENSIS	SITKA SPRUCE	5	1.20 METERS	AS SHOWN	B. & B.
Th	TSUGA HETEROPHYLLA	WESTERN HEMLOCK	3	1.20 METERS	AS SHOWN	B. & B.
DECIDUOU	S TREES					
A	ACER MACROPHYLLUM	BIGLEAF MAPLE	3	1.20 METERS	AS SHOWN	B. & B.
SHRUBS						
©	CORYLUS CORNUTA	BEAKED HAZELNUT	20	#2 POT	90 CM. O.C.	WELL BRANCHED
P	PHYSOCARPUS CAPITATUS	PACIFIC NINE-BARK	23	#2 P0T	90 CM. O.C.	WELL BRANCHED
©s)	CORNUS SERICEA	RED OSIER DOGWOOD	27	#2 P0T	90 CM. O.C.	WELL BRANCHED
®	ROSA NUTKANA	NOOTKA ROSE	26	#2 POT	90 CM. O.C.	WELL BRANCHED
℘	SAMBUCUS RACEMOSA	RED ELDERBERRY	20	#2 POT	90 CM. O.C.	WELL BRANCHED
®	RUBUS PARVIFLORUS	THIMBLE BERRY	19	#2 P0T	90 CM. O.C.	WELL BRANCHED
0	LONICERA INVOLUCRATA	BLACK TWINBERRY	25	#2 P0T	90 CM. O.C.	WELL BRANCHED
Rs	RUBUS SPECTABILIS	SALMONBERRY	25	#2 POT	90 CM. O.C.	WELL BRANCHED

#### NOTES / GENERAL


1) PLANT SIZES IN THIS LIST ARE SPECIFED A COMPOING TO BE LANDSCAPE STANDARD "LATEST EDITION", CONTAINER SIZES ARE SPECIFED AS FOR "OITH STANDARDS"S SIGH PLANT SIZE AND CONTAINERS SIZE ARE THE MARMAN MECPHER SIZES, SEARCH AND REVIEW, WHERE PLANT MATERIAL, AVAILABLE FOR OPTIONAL REVIEW BY "LANDSCAPE", ARCHITECT" AT SURRECE OF SIPPLY, AREA OF SEARCH TO INCLUDE LORDWIN MARMAN DAY REVIEW SIZES VILLEY, "SIRSTIFILITIONS" MIST CORTAN WRITTEN APPROVING THAN AND AND AND SIZES SIZES OF SEARCH LANDFORMOR SIZES THOUGH SIZES SIZE

ALL PLANT MATERIAL MUST BE PROVIDED FROM CERTIFED "DISEASE FREE" NURSERY, ALL PLANT MATERIAL MUST CONFORM TO THE LATEST EDITION OF THE "BE LANGSAPE STANDARD", PROVIDE CERTIFICATION FOR REQUEST, ALL DISHOSCAPINE AND LORSCAPE MATERIALS TO CONFORM TO THE LATEST EDITION OF THE BELMA/BOSSA "LANGSCAPE STANDARDS"


2) MIN. GROWING MEDIUM DEPTHS OVER PREPARED SUBGRADE SHALL BE:

| CAINN AREAS | 300 mm | GROUND COVER AREAS | 450 mm | SHRUB AREAS | 1700 mm | 4700 mm

- 3) GROWING MEDIAM SHALL HAVE PHYSICAL AND CHEMICAL PROPERTIES AS DESCREED IN THE STAMPARDS FOR LEISE, 2 AND LEVEL 3. MEAS, DOZEF FOR MEASS ONES SHOUTHESS WHERE THE MEDIAM PAUL CONFRONT IN THE REGISHERIST FOR ITELL A PREVIATION, PROCESSING AND MONIO OF GROWING MEDIAM COMPONENTS SHALL BE OTHER OFF-STE LISSE A MECHANIZED SCHEMIN PROCESS. PROMPSESS DOMINION MEDIAM SHALL BESTED BY A RECOGNIZED LARGEROOM, THE COMPRICTOR SHALL QUARMETE THAT THE SUL SIGNATURE FOR TESTING IS A REPRESENTANT SHAPEL FROM THEM BEST THAT ME USUAL AT HE STEEL OF THE STAMP O
- 4) ON-SITE OR IMPORTED SOILS SHALL SATISFY THE REQUIREMENTS OF THE STANDARDS FOR GROWNO MEDIUM. SOILS SHALL BE VERTIALLY FREE FROM SUSSOIL, WOOD INCL. WOODY PLANT PARTS, WEED OR REPRODUCTIFE PARTS OF WIEEDS, PLANT PATHOGENIC ORGANISMS, TOXIC MATERIALS, STONES OVER 30 MM AND FOREIGN GOECTS.
- 5) ALL PLANTING BEDS SHALL RECEIVE MIN. 50 MM BARK MULCH.
- PLANT SPECIES AND VARIETIES MAY NOT BE SUBSTITUTED WITHOUT THE APPROVAL OF THE LANDSCAPE ARCHITECT.
- THE CONTRACTOR SHALL GUARANTEE ALL MATERIALS AND WORKMANSHIP FOR A PERIOD OF ONE (1) FULL YEAR FROM THE DATE OF FINAL ACCEPTANCE, UMESS OTHERWISE SPECIFIED, ALL PLANT MATERIAL MOST SERVING, OR IN POOR CONDITION DURING THE GUARANTEE PERIOD SHALL BE REFLACED BY THE CONTRACTOR AT NO EXTRA COST TO THE OWNER.
- THE CONTRACTOR SHALL CLEAR AWAY FROM THE SITE ALL RUBBISH AS IT ACCUMULATES, AND SHALL, AT THE COMPLETION OF THE WORK, LEAVE THE WORK AND THE SITE THEREOF IN A CLEAN AND PRESENTABLE CONDITION, PREE FROM ALL OBSTRUCTIONS.

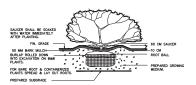

PLANTING	DETAIL	_	SHRUBS	&	GRD.	COVER	PLANTS
CECTION							NTC

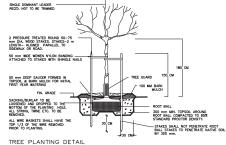

SECTION




2140	REMARKS	NO.
FEB/14	REVISED SITE PLAN	1
SEP/14	REVISED SITE PLAN	2
DCT/14	REVISED SITE PLAN	3
DEC/14	SURREY COMMENTS	4
UL/17	SURREY COMMENTS	5

1:150	DATE JAN/14
DRAFT	снкта
DNG.	CHCD
APPRO	AS RULT

N.T.S.


RATED	JOR No.	
	L-2	<u></u>



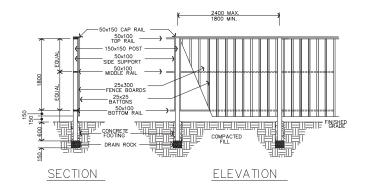


6' SOLID CEDAR FENCE TO BE INSTALLED ALONG NORTH, EAST AND WEST PROPERTY LINES.

# GARBAGE ENCLOSURE DETAIL N.T.S.

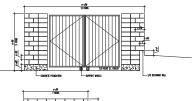



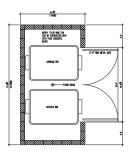

.KAVOLINAS & ASSOCIATES INC

PHONE (604) 857-23

CERRY BLONSKI ARCHITECT

SUITE #1A

12488 - 82 AVENUE
SURREY, B.C.
V3W 3E9

804 572 3608

PLAN VIEV

LANDSCAPE DETAILS PROPOSED INDUSTRIAL BLDG 13099 - 116 AVENUE SURREY, B.C.

1:150	DATE JAN/14
DRAFT	CHK,D
DVC.	снито
APPRID	AS RUET

J08 No.	
DRAWNG No.	Δ
L-1A	/51

#### FRONT YARD FENCE DETAIL

P.L. CONC. BLOCK UM GATE TO POST TCH FENCE	CONC. BLOCK ALUM FENCING POST PAINTED BLACK	CONC. BLOCK PEDESTRIAN GATE	CONC. BLOCK POST
(8) 1 (S)			(6)
	116TH AVE		