

City of Surrey PLANNING & DEVELOPMENT REPORT File: 7915-0149-00

Planning Report Date: November 2, 2015

PROPOSAL:


• Development Permit

to permit the development of an industrial building.

LOCATION: 19005 - 52 Avenue
OWNER: BJT Holdings Ltd

ZONING: IL

OCP DESIGNATION: Industrial

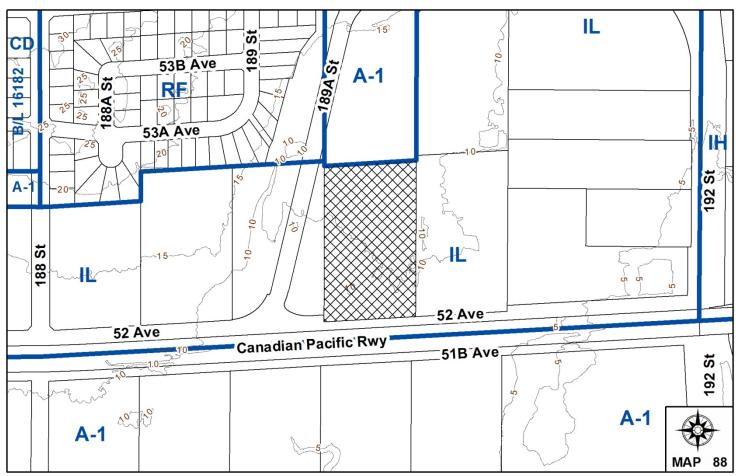

RECOMMENDATION SUMMARY

• Approval to draft Development Permit.

DEVIATION FROM PLANS, POLICIES OR REGULATIONS

• None.

RATIONALE OF RECOMMENDATION

- Complies with the Industrial designation in the OCP and with the regulations of the IL Zone.
- The proposal supports the City's Economic Development and Employment Lands Strategies.
- The proposed building form and land use are appropriate for this area.
- The building features durable materials with substantial glazing towards the street edges.

RECOMMENDATION

The Planning & Development Department recommends that:

1. Council authorize staff to draft Development Permit No. 7915-0149-00 generally in accordance with the attached drawings (Appendix II).

- 2. Council instruct staff to resolve the following issues prior to approval:
 - (a) ensure that all engineering requirements and issues including restrictive covenants, dedications, and rights-of-way where necessary, are addressed to the satisfaction of the General Manager, Engineering;
 - (b) submission of a road dedication plan to the satisfaction of the Approving Officer;
 - (c) submission of a finalized tree survey and a statement regarding tree preservation to the satisfaction of the City Landscape Architect;
 - (d) submission of a landscaping plan and landscaping cost estimate to the specifications and satisfaction of the Planning and Development Department;
 - (e) resolution of all urban design issues to the satisfaction of the Planning and Development Department; and
 - (f) registration of a shared access easement with the neighbouring property to the west (18949 52 Avenue).

REFERRALS

Engineering: The Engineering Department has no objection to the project

subject to the completion of Engineering servicing requirements as

outlined in Appendix III.

SITE CHARACTERISTICS

Existing Land Use:

Adjacent Area:

Direction	Existing Use	OCP	Existing Zone
		Designation	
North:	Outside storage of pre-cast concrete	Suburban	A-1
	under Temporary Use Permit No.	(Industrial at	(IL at Third
	7912-0272-00 (expires December 17,	Third Reading)	Reading)
	2015). Application No. 7905-0014-00		
	received Third Reading on July 11,		
	2005 for OCP amendment to		
	Industrial and rezoning to IL.		
East:	Farm buildings with single family	Industrial	IL
	dwelling.		
South (Across 52	Single family dwelling on acreage	Agricultural	A-1
Avenue and railway):	within ALR.		
West:	Vacant lot.	Industrial	IL

DEVELOPMENT CONSIDERATIONS

Background

- The subject lot is located at 19005 52 Avenue in southeast Cloverdale and encompasses an area of 1.9 hectares (4.75 acres). The subject site is designated Industrial under the Official Community Plan (OCP) and is zoned "Light Impact Industrial Zone (IL)".
- The applicant, Oasis Windows, is proposing a Development Permit to permit development of an industrial building that includes an onsite childcare for employee's children.
- Oasis Windows has approximately 200 employees and is relocating the plant from 13120 76
 Avenue in Newton. The applicant is seeking to have the proposed building constructed and completed by the end of April, 2016.
- The triangular property to the west is City-owned. Due to its odd shape, the applicant has provided a concept as to how this lot could potentially develop in the future (see Appendix V).
- The proposed building will have a total floor area of 8,251 square metres (88,812 sq. ft.) which includes 6,552 square metres (70,528 sq. ft.) of industrial space, 1,463 square metres (15,753 sq. ft.) of two-storey ancillary office space and 235 square metres (2,531 sq. ft.) of childcare space, which represents a floor area ratio (FAR) of 0.44 and a lot coverage of 41.5%. The proposal complies with the maximum FAR of 1.0 and lot coverage of 60% permitted in the IL Zone.

• The site to the north (18998 – 54 Avenue) is designated Suburban in the OCP and is currently zoned "General Agricultural Zone (A-1)". An existing application (No. 7905-0014-00) is at Third Reading to amend the OCP designation to Industrial and to rezone the site to IL.

• With the recent introduction of the 189A Street connector between 52 Avenue and 54 Avenue, industrial access to 184 Street between 192 Street has been drastically improved.

PRE-NOTIFICATION

• In accordance with Council policy, a Development Proposal Sign has was erected on the subject site on July 20, 2015. Staff have not received any comments from neighbours.

DESIGN PROPOSAL AND REVIEW

Building

- The proposed building is prefabricated and is intended as a window manufacturer/warehouse facility, with a two-storey office component. The building also includes a childcare for employees' children.
- The proposed 8,251-square metre (88,812 sq.ft.) building is approximately 68.6 metres (225 ft.) wide by 119 metres (390 ft.) long and will be located on the southern portion of the lot.
- The proposed building is 10.7 metres (35 ft.) in height, which is within the 18 metres (60 ft.) permitted in the IL Zone.
- The primary colours of the building are blue and grey with two (2) canopies constructed of timber and glass along the south elevation to distinguish the childcare from the rest of the building and also to provide for weather protection.
- As the subject industrial building is a window manufacturer, the building has substantial windows along the south elevation and office component of the east and west elevations. To provide for natural lighting within the warehouse, a row of windows is proposed just below the roofline around the perimeter of the building.
- The main building entrance as well as a separate entrance for the childcare are located on the south elevation of the building.
- Three large loading doors are proposed along the north elevation, one loading door is proposed along the east elevation and three loading doors are proposed along the west elevation.
- A 184-square metre (1,985 sq. ft.) second-storey roof deck and staff outdoor amenity area is proposed along the south side of the building above the childcare.
- The rooftop mechanical units will be screened by a parapet.

Childcare

- The applicant is proposing a 235-square metre (2,531 sq. ft.) childcare space, exclusively for employees' children, in the southeast portion of the ground floor of the building. The childcare will have a capacity of approximately 25 children and will require approximately four (4) staff. A childcare centre is a permitted accessory use under the IL Zone.
- The proposed childcare will have a separate access from the office/warehouse entrance and will have five accessible parking spaces with special curb treatment located in front to provide easier access for parents to drop off children.
- The childcare's outdoor play area is proposed to be located at the southeast corner of the building. The play area is approximately 79.2 square metres (853 sq. ft.) and a portion is covered by a canopy to provide weather protection.

Signage

- The applicant proposes a double-sided, free-standing sign along 52 Avenue next to the western driveway. The proposed sign is 3.5 metres (11.5 ft.) tall by approximately 1.8 metres (6 ft.) wide for a total area of 6.3 square metres (68 sq. ft.) which complies with the Sign By-law. The proposed sign includes channel lettering mounted to inch thick frosted glass and a sign box with the Oasis logo mounted on a metal rib siding monument and concrete base.
- The Oasis name and logo are proposed on the upper west corner of the south building elevation. Proposed fascia signage will be comprised of individual channel lettering and has dimensions of approximately 1.2 metres (4 ft.) by 4.4 metres (14.5 ft.).
- Other signage includes a 0.5-metre (1.5 ft.) by 3 metres (10 ft.) childcare sign located above the childcare entrance and a 0.5-metre (1.5 ft.) by 2 metres (7 ft.) street address sign located over the main entrance.
- The number and size of the proposed signage comply with the Sign By-law.

Site Access, Parking and Circulation

- With the introduction of 189A Street, industrial access to the site is improved with trucks having improved access to 192 Street and 184 Street via 52 Avenue and 54 Avenue.
- The layout proposes two driveways along the eastern and western side of the 52 Avenue frontage respectively. The eastern entrance will be primarily for trucks to enter the site and the western entrance will act as the primary access and egress to the site.
- The applicant is required to share the westerly access with the neighbouring property to the west (18949 52 Avenue) in order to avoid driveway access from 189A Street.
- Surrey Zoning By-law No. 12000 requires one (1) parking space for every 100 square metres (1,075 sq. ft.) of gross floor area for light impact industrial uses, including the ancillary office space and one (1) parking space for each childcare employee. As such, the proposal requires a total of 83 on-site parking spaces and the applicant is proposing 126 spaces.

• The rear yard (north) of the site acts primarily as a covered and uncovered outside storage area for materials. A row of approximately 34 parking spaces are proposed along the northern property line.

- Next to the west side of the building are four angled truck loading bays and along the southern portion of the building are approximately nine (9) employee parking spaces, including two (2) electrical vehicle charging stations.
- There are approximately 24 parking spaces located along 52 Avenue and 5 accessible spaces located in front of the childcare.
- The eastern portion of the site is primarily an entrance drive aisle providing access to approximately 54 spaces along the eastern property line.

TREES

• Bill Wilde, ISA Certified Arborist of Arbor Vitae Tree Consultants Assessment prepared an Arborist Assessment for the subject property. The table below provides a summary of the tree retention and removal by tree species:

Table 1: Summary of Tree Preservation by Tree Species:

Tree Species	Exis	ting	Remove	Retain
Alder and Cottonwood Trees				
Alder 6 6 o				
Cottonwood	3	2	32	0
	Deciduo Alder and		s wood Trees)	
Willow]	L	1	0
	Conifero	ous Tree	s	
Douglas Fir	1.	4	14	0
Western Red Cedar		ļ	4	0
Total (excluding Alder and Cottonwood Trees)		9	19	o
Total Replacement Trees Property (excluding Boulevard Street Trees		77		
Total Retained and Replacement Trees			77	
Contribution to the Green City Fund			nil	

• The Arborist Assessment states that there are a total of 19 mature trees on the site, excluding Alder and Cottonwood trees. Thirty-eight (38) existing trees, approximately 63% of the total trees on the site, are Alder and Cottonwood trees. It was determined that no trees can be retained as part of this development proposal. The proposed tree retention was assessed

taking into consideration the location of services, building footprints, road dedication and proposed lot grading.

- For those trees that cannot be retained, the applicant will be required to plant trees on a 1 to 1 replacement ratio for the Alder and Cottonwood trees, and a 2 to 1 replacement ratio for all other trees. This will require a total of 76 replacement trees on the site. The applicant is proposing 77 replacement trees, exceeding City requirements.
- In addition to the replacement trees, boulevard street trees will be planted on 52 Avenue. This will be determined at the servicing agreement stage by the Engineering Department.
- The new trees on the site will consist of a variety of trees including Beech, Maple, Ash, Pine and Spruce. All proposed trees are located on the boulevard or in the landscaped buffer.
- In summary, a total of 77 trees are proposed to be planted on the site.

Landscaping

- The applicant is proposing landscape screening along the entire site perimeter to screen the loading and parking areas from the street and from neighbouring industrial properties.
- Along the south property line adjacent to 52 Avenue, the applicant proposes a 3-metre (10 ft.) wide landscape buffer with approximately 10 trees and shrubs proposed. The shrubs and a gravel bioswale are proposed to assist with storm water management. The pad mounted transformer is located along the eastern edge of the property and is screened by a hedge. A walkway is proposed connecting the street to the building.
- The west, north and east property lines of the site all border future industrial lots. The applicant proposes a 2-metre (7 ft.) wide buffer along each of these property lines along with landscape islands interspersed through the parking area. The buffer area includes a drainage swale along the west lot line and a total of approximately 62 trees along with shrubs.

Site Slope and Retaining Walls

- The subject site has a minimal slope from 9.5 metres (31 ft.) geodetic along 52 Avenue to approximately 11 metres (38 ft.) geodetic along the north property line and a similar 2-metre (7 ft.) slope up from the west to east property lines.
- No retaining walls will be visible from 52 Avenue. The applicant proposes a 1.6-metre (5 ft.) high retaining wall along the northern property line and a 1.6-metre (5 ft.) high retaining wall along the northern portion of the eastern property line that is eliminated as the wall reaches the southern portion of the eastern property line.

SUSTAINABLE DEVELOPMENT CHECKLIST

The applicant prepared and submitted a sustainable development checklist for the subject site on October 21, 2015. The table below summarizes the applicable development features of the proposal based on the seven (7) criteria listed in the Surrey Sustainable Development Checklist.

Sustainability Criteria	Sustainable Development Features Summary
1. Site Context & Location (A1-A2)	• N/A
2. Density & Diversity (B1-B7)	Inclusion of childcare within the warehouse.
3. Ecology & Stewardship (C1-C4)	 On-site rainwater management Approximately 1,538 square metres (16,554 sq. ft.) of landscaping added to site. Recycling facilties are included within the site. Pre-fabricated building which reduces construction waste.
4. Sustainable Transport & Mobility (D1-D2)	 Contains electrical vehicle parking spaces. Bike parking spaces.
5. Accessibility & Safety (E1-E3)	• Includes baby stroller accessible parking spaces next to the childcare.
6. Green Certification (F1)	• N/A
7. Education & Awareness (G1-G4)	• N/A

INFORMATION ATTACHED TO THIS REPORT

The following information is attached to this Report:

Appendix I. Lot Owners, Action Summary and Project Data Sheets

Appendix II. Site Plan, Building Elevations, Landscape Plans and Perspective

Appendix III. Engineering Summary

Appendix IV. Summary of Tree Survey and Tree Preservation Appendix V. Concept Plan Prepared for 18949 – 52 Avenue

original signed by Ron Hintsche

Jean Lamontagne General Manager Planning and Development

Information for City Clerk

Legal Description and Owners of all lots that form part of the application:

1. (a) Agent: Name: Peter Lovick

PJ Lovick Architect

Address: 3707 First Avenue

Burnaby, BC V₅C ₃V₆

Tel: 604-298-3700

2. Properties involved in the Application

(a) Civic Address: 19005 - 52 Avenue

(b) Civic Address: 19005 - 52 Avenue Owner: BJT Holdings Ltd

PID: 012-779-024

Lot 4 Except: Parcel "A" (Explanatory Plan 42962), Section 4 Township 8 New

Westminster District Plan 1461

3. Summary of Actions for City Clerk's Office

DEVELOPMENT DATA SHEET

Existing Zoning: IL

Required Development Data	Minimum Required / Maximum Allowed	Proposed
LOT AREA (in square metres)		
Gross Total		19,226 sq.m.
Road Widening area		855 sq.m.
Undevelopable area		
Net Total		18,370 sq.m.
LOT COVERAGE (in % of net lot area)		
Buildings & Structures	60%	41.5%
Paved & Hard Surfaced Areas	0070	41.370
Total Site Coverage		
SETBACKS (in metres)		
Front	7.5 m	19.0 m
Rear	7.5 m	34.4 m
Side #1 (East)	7.5 m	18.0 m
Side #2 (West)	7.5 m	19.6 m
BUILDING HEIGHT (in metres/storeys)		
Principal	18 m	10.75 m
Accessory	6 m	9.1 m
NUMBER OF RESIDENTIAL UNITS		N/A
Bachelor		N/A
One Bed		N/A
Two Bedroom		N/A
Three Bedroom +		N/A
Total		N/A
FLOOR AREA: Residential		N/A
FLOOR AREA: Commercial		
Childcare		235 sq.m.
Office		1,321 sq.m.
Total		1,556 sq.m.
FLOOR AREA: Industrial		6,552 sq.m.
FLOOR AREA: Institutional		N/A
TOTAL BUILDING FLOOR AREA	18,370 sq.m.	8,251 sq.m.

Development Data Sheet cont'd

Required Development Data	Minimum Required / Maximum Allowed	Proposed
DENSITY		
# of units/ha /# units/acre (gross)		
# of units/ha /# units/acre (net)		
FAR (gross)	1.0	0.44
FAR (net)		
AMENITY SPACE (area in square metres)		
Outdoor (Warehouse)		184 sq.m.
Outdoor (Childcare)		79 sq.m.
PARKING (number of stalls)		
Commercial	N/A	N/A
Industrial	66	70
Residential Bachelor + 1 Bedroom	N/A	N/A
2-Bed	N/A	N/A
3-Bed	N/A	N/A
Residential Visitors	N/A	N/A
Office	13	
Daycare	4	4
Total Number of Parking Spaces	83	126
Number of disabled stalls	1	1
Number of small cars	25%	ο%
Tandem Parking Spaces: Number / % of Total Number of Units		N/A
Size of Tandem Parking Spaces width/length		N/A

Heritage Site	NO	Tree Survey/Assessment Provided	YES

19005 - 52 AVE, SURREY, B.C.



DRAWING / CONSULTANT LIST:

ARCHITECTURAL

PJ LOVICK ARCHITECT LTD. \$707 1st AVENUE, BURNABY, B.C., VSC \$V6 (lel) 604.296.8051 (lem) 604.296.8051 (lemsil) pjiovick@pjiovick.com

AD COVER SHEET CONTEXT PLAN CONTEXT PHOTOS

AS1 SITE PLAN

AS1.1 PARTIAL SITE PLAN

AS1.2 VEHICLE TRUCK ACCESS PLAN
AS2 BUILDING SIGNAGE DETAILS
A1 GROUND FLOOR & ROOF PLAN
A1.1 PARTIAL OF PLAN (OFFICES/DAYCARE)

A12 PARTIAL SF PLAN (OFFICES)

A1.3 PARTIAL OF PLAN (WAREHOUSE)

A2.0 PARTIAL ROOF PLAN

(OFFICES/ DAYCARE)
A2.1 PARTIAL ROOF PLAN (WAREHOUSE)

A3.0 SOUTH ELEVATIONS

EAST & WEST ELEVATION (PARTIAL)

A3.1 ELEVATIONS (OVERALL)

COLOUR ELEVATIONS

SURVEY

DHALIWAL & ASSOCIATES LAND SURVEYING INC. 121-13140 BOTH AVENUE, SURREY, B.C. VSW 882 (M) 804.501.8188 (Mx) 804.501.8188

SURVEY PLAN

LANDSCAPE ARCHITECT

PMG LANDSCAPE ARCHITECTS, C100 4185 STILL CRIECK DRIVE, BURNABY, B.C. VSC 6G9 (lef) 604-294.0011 (lex) 604-294.0022

email: www.pmglandscape.com

L2 SHPUB PLAN - SOUTH L3 SHPUB PLAN - NORTH

L4 LANDSCAPE DETAILS

L5 TREE MANAGEMENT PLAN

TREE SURVEY / ABORIST REPORT

BILL WILDE
ARBOR VITAE TREE CONSULATANTS
P.O BOX 1185 FORT LANGLEY
BC V1M2S5
(b) 778.551.0130
smail: abovitaeWee@gmail.com

REPORT INCLUDED

CIVIL

RAJEEV MANGLA
MAINLAND ENGINEERING CORPORATION
CIVIL & STRUCTURAL ENGINEERS
#206, \$365 - 125 STREET,
SURREY
(iai) 804.545.8044
email: civil@mainlandeng.com

C1555 DRG NO 1 C1555 DRG NO 2



P J LOVICK ARCHITECT LTD.

OASIS WINDOWS LTD. - SURREY, B.C.



1 - VIEW OF RESIDENTIAL AREA LOOKING SOUTHEAST ON 188TH STREET



2 - VIEW OF ADJACENT PROPERTY LOOKING SOUTH ON 54TH AVE.



3- VIEW OF UPGRADED ROAD LOOKING SOUTH ON 192ND ST.



4 - VIEW OF EXISTING PROPERTY LOOKING WEST ON 192ND ST.



10 - VIEW OF EXISTING ADJACENT PROPERTY LOOKING NORTH ON 52ND AVENUE





7 - VIEW OF EXISTING PROPERTY LOOKING SOUTH ON 52ND AVENUE



5 - VIEW OF EXISTING TRAIN TRACK AND BRIDGE LOOKING SOUTH ON 192ND STREET

6 - VIEW OF EXISTING PROPERTY LOOKING NORTH WEST ON

52ND AVENUE




9 - VIEW OF CURRENT SITE LOOKING NORTH ON 52ND AVENUE



CONTEXT PHOTOS



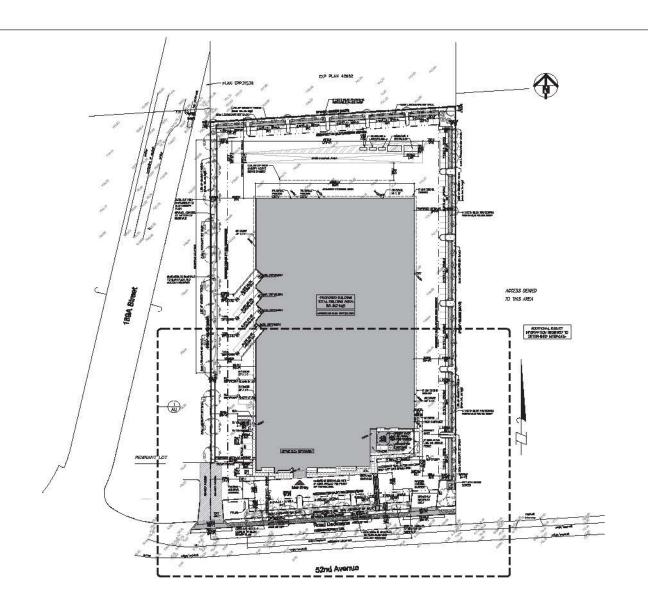



CATC ADMINISTRATION OF ARMS STORY OF ARMS ST

ZZNINS L - LIENT DPACT NOUSTRIAL

OCCUPANCY CLASSIFICATION PROPOSED USES - ORDUP F2 - LIGHT INFOACT INDUSTRIAL SPACE D - OFFICES

PARCEL AREA

ACTUAL: 205,44894 542FT, (#205,64 542H) ROAD DEDICATION: 4,80592 542PF, 8954PH 542HU

TOTAL HET AREA, MITT40/05 SOFT, (METPO/05 SOFT)

PROPOSED FLOOR AREA

10, 528-50Pt. 14, 25.4-50FT. 1,528-50FT. 2,538-50FT. WATERCIES OFFICES PESIDENTIAL DAYCARS TOTAL PLOOR AREA

HADIHM ALIZMARIE | IZZ : 1977/02/06 SEIPT | IREPTICAS SEIPT | IREP

HAXIHA ALIOHEA - 60 % (FT) 140 06 x 50 - 18644 09 50 FT)

750 POED. 22 BOA 50FT. = 22,1804 / HT(140,06 = 45 ± 100 = 415 \$.

SETEMANS.

ELEVATION SIDE	VITCHED	PROFUSED
NORTH (REAR)	T5 n (34af)	- 2420 m (la'-10')
EAST (Right)	15 n (2461)	- BD0 n B4419
SOUTH ITROHIT	15 n Q46!)	- BAT n 621 47
WEST (LEFT)	75 m (34.61)	- MSB n (64: 3*)

HEGHT OF BULDING

ALLOWALE: PRINCIPAL BUILDING = HAX BM (80 PT.)
ACCESSORY BUILDING 4 STRUCTURES = HAX BM (20 PT.)

PROPOSEDA PRINCIPAL BUILDING : 30 R. 10:6H PARKINA

PROJECTS SPACES LIGHT PHENCT HOUSIRUM, USD. HARDHOUSE (1 SPACE FEB. 100 SQLF. (1015 SQLFT.)

TOTAL REGURED SPACES GLASPACES

PROVIDED SPACES
REGULAR =
SPALL CARS =
EV CHARSINS =
HYDAP ANDERSHIES =
STROLLER ANDERSHIES 18 - 57AL5 0 - 57AL5 0 - 57AL5 2 - 57AL5 1 - 57AL5 5 - 57AL5



PILOVICK ARCHITECT LTD

3707 1gt AVENUE BURNABY, BRITISH COLUMBIA VSC 3V6 8-MAIL: gilavids@gilavids.com fac: 604-298-6081 tel: 604-298-3700 Member of the ABC Member of the RAC Certified Professional


OASIS WINDOWS LTD

MOGS - SE AVE. Burrey, B.C.

SITE PLAN

PAGE TRANSPORT	PRODUCT MARKET
H-094	ASI
II-200	-076 -07
DES	ANT THE WILL



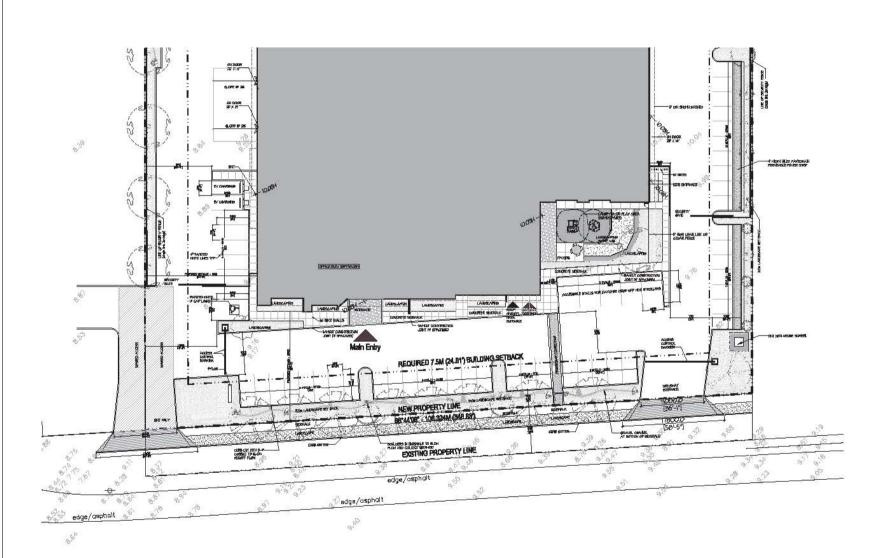



Challe net les



3707 1st AVENUE BURNABY, BRITISH COLUMBIA V5C 3V6 B-MAIL: pllovich@pjlovich.com tel: 604-298-3700 fee: 604-298-6081

or of the ABU. Number of the card the ABU. Number of the Received Standard of the Received Standard St


OASIS WINDOWS LTD


19005-50 AVE. BLING, B.C.


SITE PLAN (PARTIAL)

14-044 ASI.1 L 1-200 CCT 27TH 2005 CCT 27TH



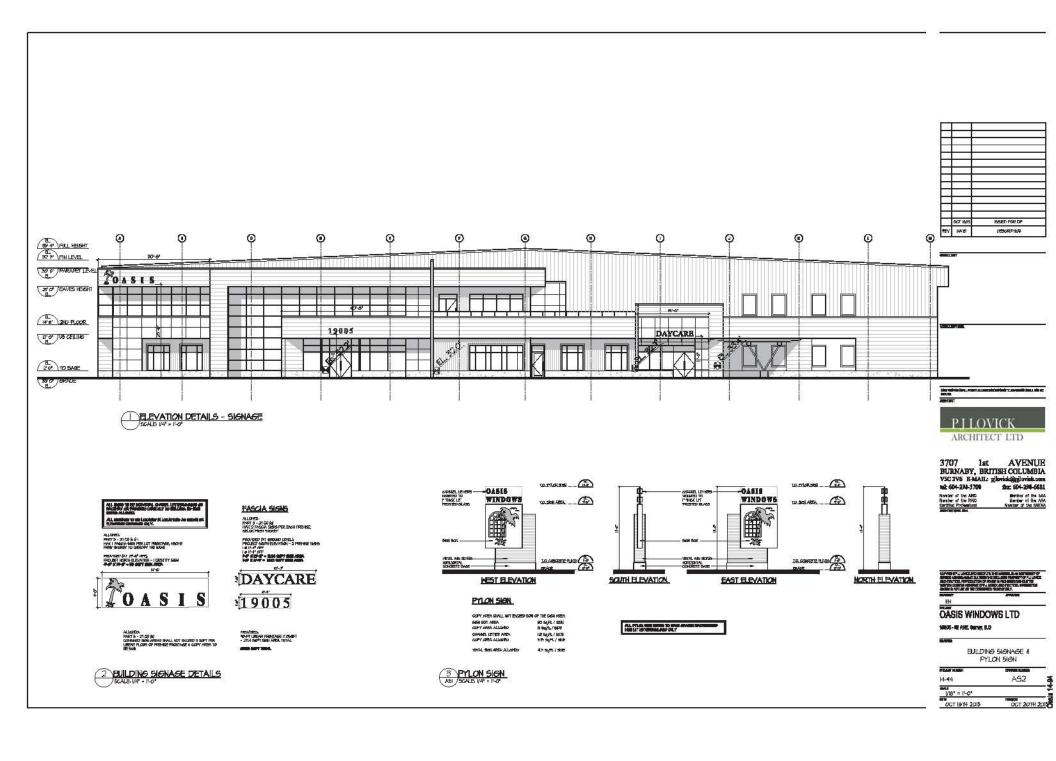

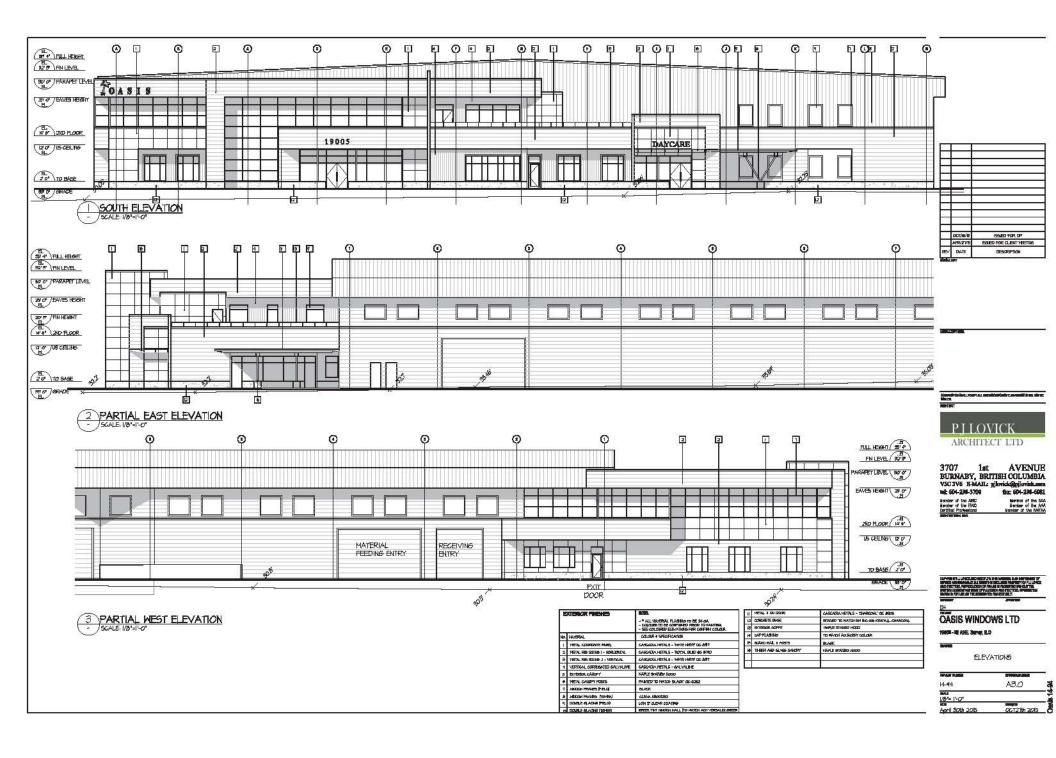

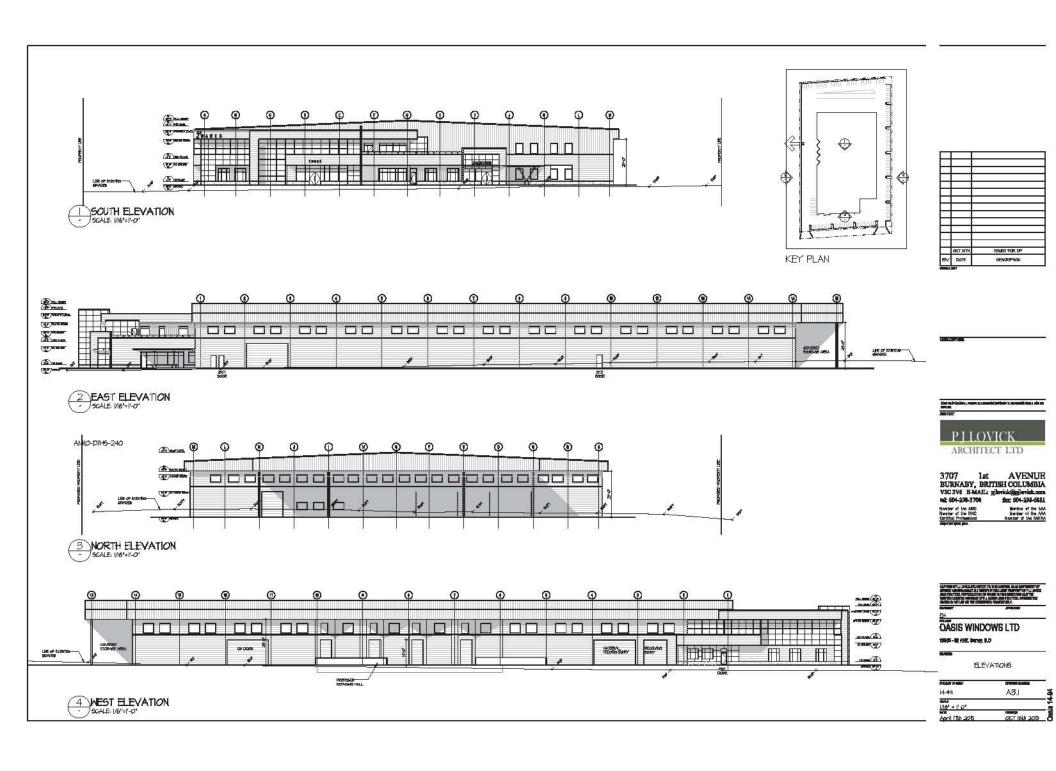



NORTH ELEVATION








P J LOVICK ARCHITECT LTD.

OASIS WINDOWS LTD. - SURREY, B.C.

RENDERINGS

١N	T S	CHEDULE		PMG PROJECT NUMBER: 15133
	QTY	BOTANICAL NAME	COMMON NAME	PLANTED SIZE / REMARKS
m.	13	ACER RUBRUM 'RED ROCKET'	RED ROCKET MAPLE	6CM CAL; 2M STD; B&B
:20	7	FAGUS SYLVATICA 'DAWYCK'	FASTIGIATE OR DAWYCK BEECH	6CM CAL; B&B
=	9	FRAXINUS AMERICANA 'AUTUMN PURPLE'	AUTUMN PURPLE ASH	6CM CAL; 1.8M STD; B&B
العد	4	PICEA GLAUCA 'PENDULA'	WEEPING WHITE SPRUCE	3.0M HT; B&B
≂	9	PICEA OMORIKA 'BRUNS'	BRUNS SERBIAN SPRUCE	3.0M HT; B&B
۸۰	13	PINUS FLEXILIS 'VANDERWOLF'S PYRAMID'	VANDERWOLF'S PYRAMIDAL LIMBER PINE	2.5M HT;B&B
10	22	QUERCUS PALUSTRIS 'GREEN PILLAR'	COLUMNAR PIN OAK	6CM CAL
	68	AZALEA JAPONICA 'PURPLE SPLENDOUR'	AZALEA; RED-VIOLET	#3 POT; 40CM
)	91	BUXUS MICROPHYLLA WINTER GEM	LITTLE-LEAF BOX	#2 POT; 25CM
)	16	CORNUS SERICEA KELSEYI'	DWARF KELSEY DOGWOOD	#3 POT; 80CM
)	62	CORNUS STOLONIFERA 'ARCTIC FIRE'	RED OSIER DOGWOOD	#3 POT; 80CM
)	45	ESCALLONIA RUBRA 'NEWPORT DWARF'	DWARF ESCALLONIA	#2 POT; 30CM
)	4	FARGASIA NITIDA	FOUNTAIN BAMBOO	#3 POT; 50CM
)	12	FOTHERGILLA GARDENII	DWARF FOTHERGILLA	#3 POT; 50CM
)	22	HYDRANGEA SERRATA 'BLUEBIRD'	MOUNTAIN HYDRANGEA; LACECAP BLUE	#3 POT; 40CM
)	58	LONICERA PILEATA	BOX-LEAF HONEYSUCKLE	#3 POT; 50CM
)	136	NANDINA DOMESTICA 'FIREPOWER'	FIREPOWER HEAVENLY BAMBOO	#3 POT; 50CM
)	28	ROSA MEIDILAND 'RED'	MEIDILAND ROSE; RED; 0.9M MATURE HT	#3 POT; 60CM
)	120	SPIRAEA JAPONICA 'GOLDMOUND'	DWARF GOLDMOUND SPIREA	#3 POT 40CM
)	319	THUJA OCCIDENTALIS 'SMARAGD'	EMERALD GREEN CEDAR	2M HT; B&B
)	4	TSUGA CANADENSIS 'GRACILIS'	DWARF CANADIAN HEMLOCK	#3 POT
)	102	VACCINIUM OVATUM 'THUNDERBIRD'	EVERGREEN HUCKLEBERRY	#2 POT; 50CM
) SS	110	VIBURNUM TINUS 'SPRING BOUQUET'	DWARF VIBURNUM	#3: POT; 50CM
	182	ACORUS GRAMINEUS 'OGON'	GOLDEN SWEET FLAG	#1 POT
5	51	CALAMAGROSTIS ACUTIFLORA 'KARL FOERSTER'	FOERSTER REED GRASS	#1 POT
6	167	CAREX TESTACEA	NEW ZEALAND SEDGE	#1 POT
Ś	171	DESCHAMPSIA CASPITOSA	TUFTED HAIR GRASS	#1 POT
١.	1000	FESTUCA CINEREA 'ELIJAH BLUE'	ELIJAH BLUE GRASS	#1 POT
Ś	282	HELICTOTRICHON SEMPERVIRENS	BLUE OAT GRASS	#1 POT
Ó	224	IMPERATA CYLINDRICA 'RED BARON'	BLOOD GRASS	#1 POT
,	202	JUNCUS EFFUSUS	COMMON RUSH	#1 POT
	108	MISCANTHUS SINENSIS 'ADAGIO'	MAIDEN GRASS	#1 POT
)	24	MISCANTHUS SINENSIS 'YAKU JIMA'	YAKU JIMA GRASS	#2 POT
•	165	PENNISETUM ALOPECUROIDES 'HAMELIN'	DWARF FOUNTAIN GRASS	#1 POT
)	93	PENNISETUM ORIENTALE	ORIENTAL FOUNTAIN GRASS	#1 POT
NNI	AL			
)	265	BERGENIA GRANDIFOLIA	HEARTLEAF BERGENIA	#1 POT
)	10	CROCOSMIA 'SEVERN SUNRISE'	ORANGE-PINK CROCOSMIA	#2 POT
)	43	ECHINACEA PURPUREA	PURPLE CONEFLOWER	#1 POT
)	26	ECHINACEA PURPUREA 'TIKI TORCH'	CONEFLOWER; PUMPKIN ORANGE	15CM POT
)	74	HESPERANTHA COCCINEA 'MAJOR'	CRIMSON FLAG LILY	#1 POT; 1-2 FAN
	39	LAVENDULA ANGUSTIFOLIA 'HIDCOTE BLUE'	ENGLISH LAVENDER; COMPACT; DEEP PURPLE	#1 POT
)	208	LIRIOPE MUSCARI	BLUE LILY-TURF	15CM POT
)	51	RUDBECKIA FUL. VAR S. 'GOLDSTURM'	RUDBECKIA; YELLOW	#1 POT
)	116	GENISTA PILOSA 'VANCOUVER GOLD'	VANCOLIVER GOLD BROOM	#1 POT: 15CM

NOTES: "PLANT SIZES IN THIS LIST ARE SPECIFIED ACCORDING TO THE BC LANDSCIPE STANDARD, LATEST EDITION. CONTAINER SIZES SPECIFIED AS PER CIVAL STRANDARDS. BOTH PLANT SIZE AND CONTINENES DES ARE THE MINIMAL ACCEPTAGE SIZES. "SEER TO SPECIFICATIONS FOR DEFINED CONTINUENES AND ACCEPTAGE SIZES." SEER TO SPECIFICATIONS FOR DEFINED CONTINUENES AND ACCEPTAGE SIZES. "SEER TO SPECIFICATIONS FOR THE ACCEPTAGE SIZES." SEER SIZES. "SEER SIZES SIZE

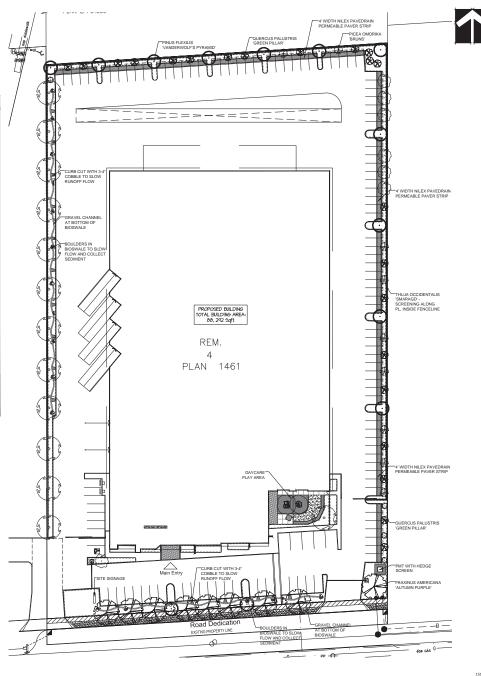

Copyright reserved. This drawing and design is the property of PMG Landscape Architects and may not be reproduced or used for other projects without their permission.

LANDSCAPE ARCHITECTS
Sulic C100 - 4 185 Still Creek Drive Bumaby, British Columbia, VSC 659 p: 604 294-0021; j: 604 294-0022

SEAL:

4 13.0C135 OF MUNICIPOR AND
3 15.0C137 ERROR MAY MICHIET MUNICIPOR AND
2 15.0C4.03 NEW SHIPT AND
1.15.0C4.03 NEW SHIPT AND
MO DATE REVISION DESCRIPTION
CUEMT:

OASIS WINDOWS WAREHOUSE

19005-52ND AVENUE SURREY, BC

DRAWING TITLE:

LANDSCAPE PLAN


 DATE:
 15.FER.10
 DRAWING NUMB

 SCALE:
 1°=30°-0°


 DRAWN:
 RCK

 DESIGN:
 RCK

 CHKD:
 MCY

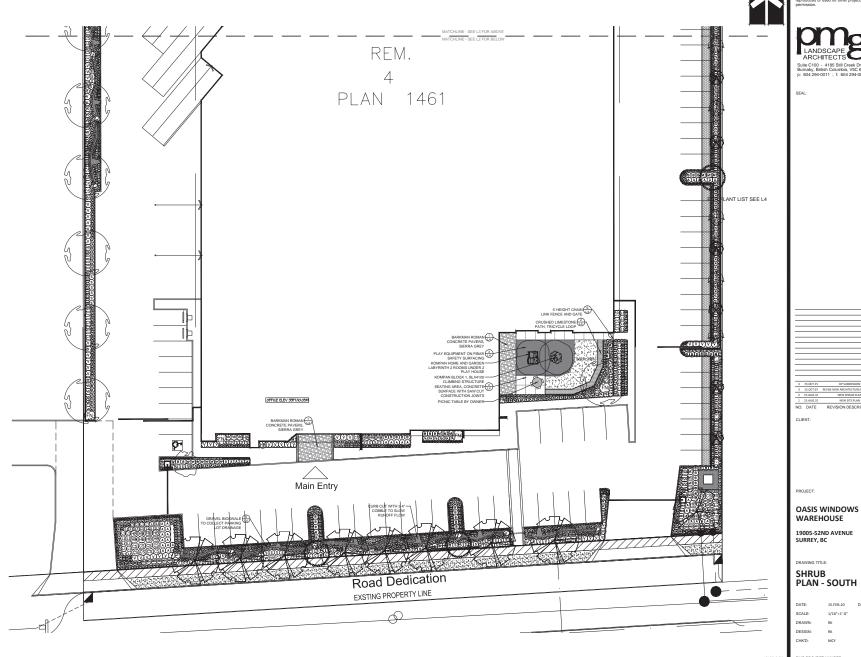

Copyright reserved. This drawing and design is the property of PMG Landscape Architects and may not b reproduced or used for other projects without their

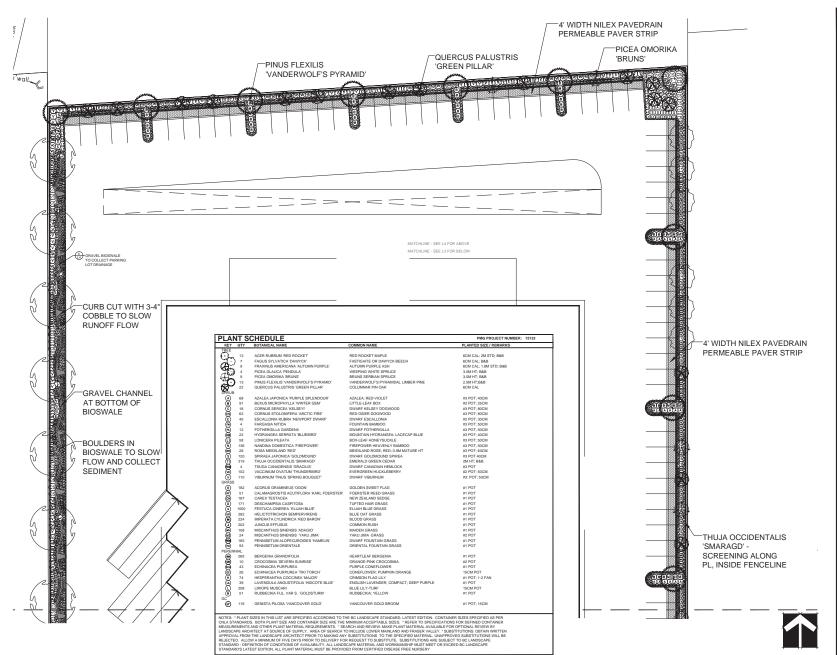

©Copyright reserved. This drawing and design is the property of PMG Landscape Architects and may not be reproduced or used for other projects without their

LANDSCAPE ARCHITECTS
Suite C100 - 4185 Still Creek Drive
Burnaby, British Columbia, V5C 605
p: 604 294-0011; f: 604 294-0022

SEAL:

4 15.007.13 OF SUBMISSION F 1 15.007.15 SHOW MAY ASSESSED FOR A 15.007.15 SHOW MAY ASSESSED FOR A 15.00.00 SHOW MAY ASSESSED FOR A 1

DDO IECT

OASIS WINDOWS WAREHOUSE

19005-52ND AVENUE SURREY, BC


RAWING TITLE

SHRUB PLAN - NORTH

DATE:	15.FEB.10	DRAWING NUMBER:
SCALE:	1/16"=1'-0"	
DRAWN:	RK	13
DESIGN:	RK	
CHKD:	MCY	OF 5





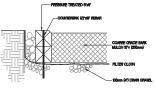





PAVERS ON GRADE

1 PAVERS ON GRADE

2 LIMESTONE PATH

14 PAY

14 PAY

15 PAY


16 PAY


16 PAY

17 PAY

18 PAY



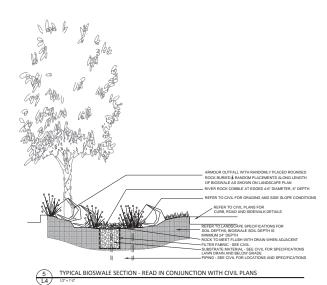

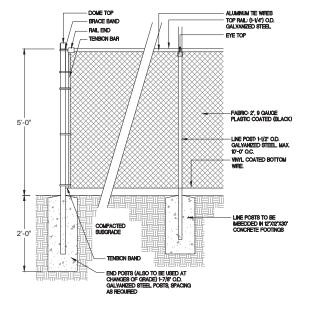

6 5' HEIGHT CHAINLINK FENCE

Copyright reserved. This drawing and design is the property of PMG Landscape Architects and may not be reproduced or used for other projects without their

LANDSCAPE ARCHITECTS
Suite C100 - 4185 Suil Creek Drive Burnaby, British Columbia, V5C 683 p. 604 259-4011 ; ; ; 604 259-4022

SEAL:

11.0.07.13 OF MIRROSON 1
1.0.07.07 FOREN AND ACTION (AND A TANK A

CLIENT:

O IECT:


OASIS WINDOWS WAREHOUSE


19005-52ND AVENUE SURREY, BC


DRAWING TITL


LANDSCAPE DETAILS

DATE: 15.FEB.10 DRAWING NUMBER:
SCALE: AS NOTED
DRAWN: RK
DESIGN: RK
CHKD: MCY
OF5

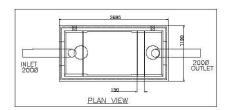

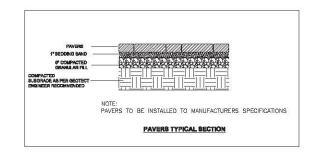


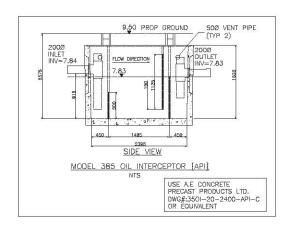


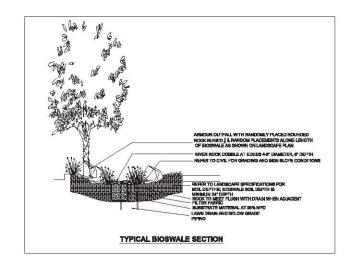

REFER TO LANDSCAPE PLAN BY: PMG LANDSCAPE ARCHITECTS FOR DETAILS OF BIOSWALE

LOCATED AT INTERSECTION OF 192 ST & 54 AVE ELEVATION = 8.202M	LEGAL DESCRIPTION; LOT 4 EXCEPT: PCL "A" (EP 42982) SECTION 4 TOWNSHIP 8		MAINLAND ENGINEERING DESIGN CORPORATION	DEVELOPMENT/SITE LOCATION	#19005 52 AVE, SURREY, BC	SEAL	SCREE 1:500 SURREY PROJECT NO. DRAWING NO. DESIGNED VP DRAWN SURREY DRAWING NO.
	NEW WESTMINSTER DISTRICT PLAN 9813.	O 15/10/21 VP RM ISSUED FOR COORDINATION NO. YY/MM/DOJDRN CH. REVISION	SURREY, B.C. V3W 497 TEL: (804) 543 8044 FAX: (804) 543 8104 EMAIL: CIVILIDMAINLANDENG.COM	DWG. NAME	ONSITE DETAILS		CHECKED RM C-1555 OF 2 APPROVED AB DATE 15/10/21 REV. 0

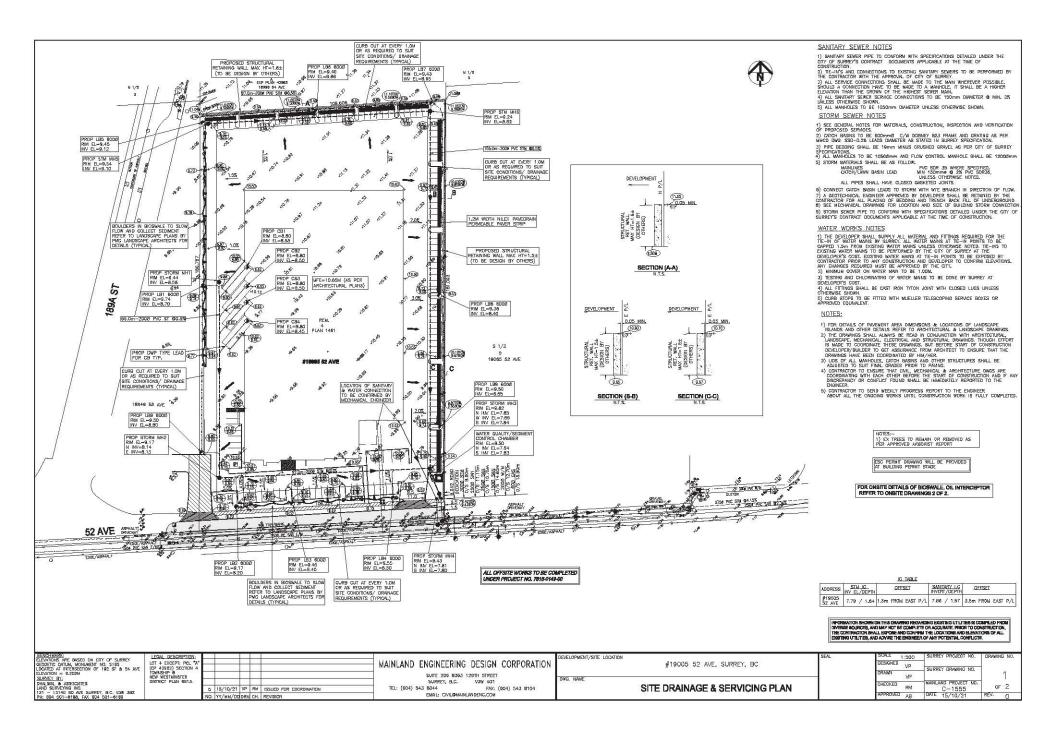

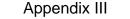



INTER-OFFICE MEMO

TO:

Manager, Area Planning & Development

- North Surrey Division

Planning and Development Department

FROM:

Development Services Manager, Engineering Department

DATE:

August 20, 2015

PROJECT FILE:

7815-0149-00

RE:

Engineering Requirements (Commercial/Industrial)

Location: 19005 - 52 Avenue

DEVELOPMENT PERMIT

The following issues are to be addressed as a condition of issuance of the Development Permit:

Property and Right-of-Way Requirements

- Dedicate 8.042m on 52 Avenue.
- Provide 0.5m wide statutory rights-of-way along 52 Avenue.

Works and Services

- Construct 52 Avenue to Through Local standard.
- Construct sanitary main, storm main and water main along 52 Avenue to service the site.
- Register reciprocal access easement.
- Register restrictive covenant for water quality and for on-site detention (if applicable).

A Servicing Agreement is required prior to the issuance of Development Permit.

Rémi Dubé, P.Eng.

Development Services Manager

HB

Table 1: Summary of Tree Preservation by Tree Species:

Tree Species	Existing	Remove	Retain
Alde	rees		
Alder	6	6	0
Cottonwood	32	32	0
	Deciduous Trees		
(excluding	g Alder and Cottonwo	ood Trees)	
Apple			
Mountain Ash			
Trembling Aspen			
Paper Birch			
Cherry			
Crabapple			
Katsura			
Maidenhair Tree			
Red Maple			
Willow	1	1	0
	Coniferous Trees		
Atlas Cedar			
Deodar Cedar			
Western Red Cedar	1	1	0
Douglas Fir	14	14	l 0
Falsecypress			0
Scots Pine			
Spruce			
Norway Spruce			
Not way Sprace			
Total (excluding Alder and	19 ▮	19 €	o
Cottonwood Trees)		19	
Additional Transitional Co.			
Additional Trees in the proposed Open			
Space / Riparian Area			
Total Replacement Trees Proposed			
(excluding Boulevard Street Trees)			
-			
Total Retained and Replacement		(0
Trees			

Tree Preservation Summary

Surrey Project No:


Address: 19005 52nd Ave.

Registered Arborist: Bill Wilde Arbor Vitae Tree Consultants(778-551-0130)

On-Site Trees	Number of Trees
Protected Trees Identified	
(on-site and shared trees, including trees within boulevards and proposed streets and lanes, but excluding trees in proposed open space or riparian areas)	37
Protected Trees to be Removed	37
Protected Trees to be Retained (excluding trees within proposed open space or riparian areas)	0
Total Replacement Trees Required: - Alder & Cottonwood Trees Requiring 1 to 1 Replacement Ratio 32	■ 42
Replacement Trees Proposed	
Replacement Trees in Deficit	
Protected Trees to be Retained in Proposed [Open Space / Riparian Areas]	

Off-Site Trees	Number of Trees
Protected Off-Site Trees to be Removed	
Total Replacement Trees Required:	
- Alder & Cottonwood Trees Requiring 1 to 1 Replacement Ratio	34 ■
Replacement Trees Proposed	
Replacement Trees in Deficit	

summary, report and plan prepared and submitted	э ру:
MNSLe	26-March-2015
Signature of Arborist)	Date

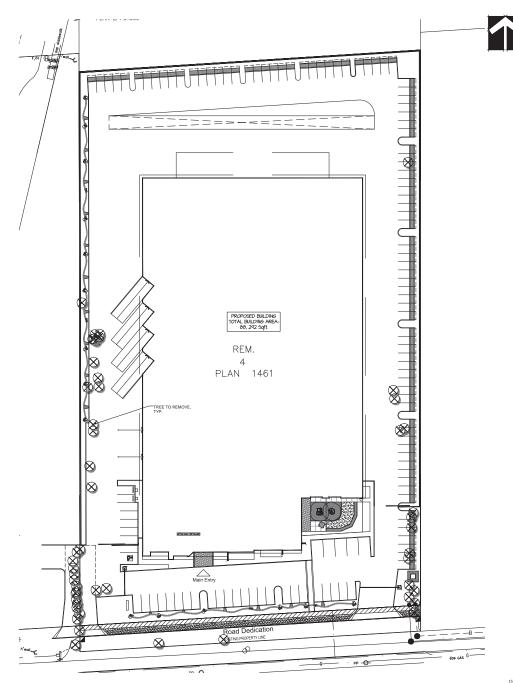

CLIENT:

PROJECT:

OASIS WINDOWS WAREHOUSE

19005-52ND AVENUE SURREY, BC

TREE MANAGEMENT PLAN

DATE:	15.FEB.10	DRAWING NUMBER:
SCALE:	1"=30"-0"	
DRAWN:	RCK	Lb
DESIGN:	RCK	
CHKD:	MCY	OF 5

15-133

