

# City of Surrey PLANNING & DEVELOPMENT REPORT File: 7915-0108-00

Planning Report Date: June 27, 2016

#### PROPOSAL:

- OCP Amendment from Urban to Multiple Residential
- **Rezoning** from RA to RM-30
- Development Permit
- Development Variance Permit


to permit the development of approximately 22 townhouse units.

**LOCATION:** 7918 – 168 Street

**OWNER:** Hayers Builders Group (Fleetwood

Townhomes) Ltd.

ZONING: RA
OCP DESIGNATION: Urban

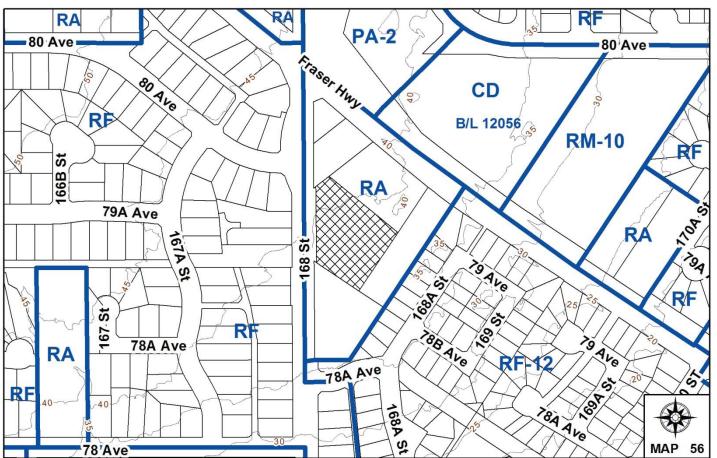

#### **RECOMMENDATION SUMMARY**

- By-law Introduction and set date for Public Hearing for:
  - o OCP Amendment; and
  - o Rezoning.
- Approval to eliminate indoor amenity space.
- Approval to draft Development Permit.
- Approval for Development Variance Permit to proceed to Public Notification.

#### DEVIATION FROM PLANS, POLICIES OR REGULATIONS

- Seeking to reduce the minimum required setbacks along all lot lines of the RM-30 Zone.
- Seeking to increase the maximum permitted building height of the RM-30 Zone from 13 metres (42.5 ft.) to 13.5 metres (43.5 ft.) for Building 4.

#### RATIONALE OF RECOMMENDATION

- The reduced setbacks are in keeping with what has been approved for similar townhouse developments in the Fleetwood area. The reduced setbacks will still accommodate appropriate yard space and landscaping treatments.
- The proposed increase in the building height of proposed Building 4 is as a result of the grade change on the subject site, which is particularly low at the southeast corner. Proposed Building 4 exceeds the maximum permitted building height by approximately 0.25 metre (0.8 ft.).
- The proposed OCP amendment to Multiple Residential is required to accommodate the proposed townhouse development on this site. The applicant will be providing a community benefit in the form of a cash contribution of \$1,500 per townhouse unit, to satisfy the OCP Amendment Policy.
- The proposed density and building form are appropriate for this part of Fleetwood and will support City efforts to increase density along transit corridors. The increased density can help support transit ridership by locating increased population within walking distance to transit.

#### **RECOMMENDATION**

The Planning & Development Department recommends that:

- a By-law be introduced to amend the OCP by re-designating the subject site (Appendix VIII) from Urban to Multiple Residential and a date to be set for Public Hearing.
- 2. Council determine the opportunities for consultation with persons, organizations and authorities that are considered to be affected by the proposed amendment to the Official Community Plan, as described in the Report, to be appropriate to meet the requirement of Section 475 of the Local Government Act.
- a By-law be introduced to rezone the subject site from "One-Acre Residential Zone (RA)" to "Multiple Residential 30 Zone (RM-30)" and a date be set for Public Hearing.
- 4. Council approve the applicant's request to eliminate the required indoor amenity space.
- 5. Council authorize staff to draft Development Permit No. 7915-0108-00 generally in accordance with the attached drawings (Appendix II).
- 6. Council approve Development Variance Permit No. 7915-0108-00 (Appendix VI) varying the following, to proceed to Public Notification:
  - (a) to reduce the minimum front yard (west) setback of the RM-30 Zone from 7.5 metres (25 ft.) to 6.5 metres (21 ft.) to the corner of Building 1, and to 5.5 metres (18 ft.) to corner of Building 2 and to 5.0 metres (16.5 ft.) to the building overhang of Building 2;
  - (b) to reduce the minimum rear yard (east) setback of the RM-30 Zone from 7.5 metres (25 ft.) to 6.0 metres (20 ft.) to the building face and to 5.0 metres (16.5 ft.) to the roof overhang of Building 4, and to 3.0 metres (10 ft.) to the building face of the east townhouse unit in Building 5 and to 2.5 metres (8 ft.) to the building face of the electrical room and to 1.5 metres (5 ft.) to the electrical room roof overhang of Building 5;
  - (c) to reduce the minimum north side yard setback of the RM-30 Zone from 7.5 metres (25 ft.) to 4.0 metres (13 ft.) to the building face and to 3.0 metres (10 ft.) to the roof overhangs of Buildings 1 and 5;
  - (d) to reduce the minimum south side yard setback of the RM-30 Zone from 7.5 metres (25 ft.) to 5.5 metres (18 ft.) to the building face and to 5.0 metres (16.5 ft.) to the roof overhangs of Buildings 3 and 4; and
  - (e) to increase the maximum permitted building height of the RM-30 Zone from 13 metres (42.5 ft.) to 13.5 metres (43.5 ft.) for Building 4 only.

- 7. Council instruct staff to resolve the following issues prior to final adoption:
  - (a) ensure that all engineering requirements and issues including restrictive covenants, dedications, and rights-of-way where necessary, are addressed to the satisfaction of the General Manager, Engineering;
  - (b) submission of a road dedication plan to the satisfaction of the Approving Officer;
  - (c) submission of a finalized tree survey and a statement regarding tree preservation to the satisfaction of the City Landscape Architect;
  - (d) submission of a landscaping plan and landscaping cost estimate to the specifications and satisfaction of the Planning and Development Department;
  - (e) resolution of all urban design issues to the satisfaction of the Planning and Development Department;
  - (f) the applicant address the concern that the development will place additional pressure on existing park facilities to the satisfaction of the General Manager, Parks, Recreation and Culture;
  - (g) demolition of existing buildings and structures to the satisfaction of the Planning and Development Department;
  - (h) registration of a Section 219 Restrictive Covenant to adequately address the City's needs with respect to public art, to the satisfaction of the General Manager Parks, Recreation and Culture;
  - (i) the applicant adequately address the impact of no indoor amenity space; and
  - (j) provision of community benefit to satisfy the OCP Amendment policy for OCP Amendment applications.

#### **REFERRALS**

Engineering: The Engineering Department has no objection to the project

subject to the completion of Engineering servicing requirements as

outlined in Appendix III.

School District: **Projected number of students from this development:** 

4 Elementary students at William Watson Elementary School

2 Secondary students at Fleetwood Park Secondary School

(Appendix IV)

The applicant has advised that the dwelling units in this project are expected to be constructed and ready for occupancy by Spring/Summer 2018.

Parks, Recreation &

Culture:

Parks has some concerns about the pressure this project will place

on existing parks, recreation and cultural facilities in the

neighbourhood.

Surrey Fire Department: No concerns.

#### **SITE CHARACTERISTICS**

<u>Existing Land Use:</u> Oversized acreage lot occupied by a single family dwelling and accessory

building, which will be removed.

#### Adjacent Area:

Direction	Existing Use	OCP Designation	<b>Existing Zone</b>
North:	Single family dwellings on half acre to acreage-sized residential lots.	Urban	RA
East:	Single family dwelling and accessor buildings on an acreage-sized residential lot.	Urban	RA
South:	Telecommunications tower and outdoor storage on an acreage lot owned by BC Gas (Fortis BC).	Urban	RA
West (Across 168 Street):	Single family dwellings and City parkland.	Urban	RF

#### **DEVELOPMENT CONSIDERATIONS**

#### **Background**

- The subject property is located in Fleetwood, just southeast of the Fraser Highway and 168 Street intersection. The property is designated Urban in the Official Community Plan (OCP) and is zoned "One-Acre Residential Zone (RA)".
- A single family dwelling and an accessory building are located on the subject property, all of which will be removed as part of the current development application.
- Planning staff have received numerous enquiries regarding the five (5) properties at the southeast corner of Fraser Highway and 168 Street (16854 and 16882 Fraser Highway, 7950 and 7964 168 Street, as well as the subject property at 7918 168 Street). Developers have noted that the assembly of land for development in this area has been a considerable challenge.

• Staff encouraged the applicant of the subject site to acquire the abutting properties in order to develop in a more comprehensive manner. However, this has been unsuccessful, as not all of the property owners are willing to sell or to develop at this time.

• The current applicant has submitted a development application for the subject site only, however, the applicant has demonstrated future redevelopment of the abutting properties in a similar townhouse form is not compromised (Appendix VII).

#### Current Proposal

- The applicant proposes an Official Community Plan amendment (Appendix VIII) from "Urban" to "Multiple Residential", a rezoning of the subject site from "One-Acre Residential Zone (RA)" to "Multiple Residential 30 Zone (RM-30)" and a Development Permit (DP) in order to permit the development of 22 townhouse units. A Development Variance Permit (DVP) is requested for reduced building setbacks along all lot lines and for an increase to the building height of proposed Building 4 (see By-law Variance section).
- The net density for the proposed 22-unit townhouse development is 48 units per hectare (19.5 units per acre) with a floor area ratio (FAR) of 0.90, which comply with the maximum permitted density of 75 units per hectare (30 units per acre) and the maximum permitted FAR of 0.90 in the RM-30 Zone.

#### Transit / Transportation Considerations

- Currently, the City is proposing two (2) light rail transit (LRT) lines one connecting City Centre with Guildford along 104 Avenue and with Newton along King George Boulevard, and one from City Centre to Langley along Fraser Highway.
- The City Centre to Langley LRT line will include a number of LRT stations at key intersections along Fraser Highway.
- Given that the subject site is located within close proximity of a future LRT station along Fraser Highway, increased densities near the Fraser Highway transportation corridor are appropriate and necessary to support the proposed installation and expansion of the rapid transit network.

#### Proposed Road and Connections

- The subject site is located near the busy intersection of Fraser Highway and 168 Street. In order to improve connectivity and traffic flow to/from the subject site as well as the adjacent properties near the intersection, staff requested a 14.5-metre (48-ft.) wide road through the north portion of the subject site, running from 168 Street and exiting out to Fraser Highway through the abutting properties (16854 and 16882 Fraser Highway). The full construction of the 14.5-metre (48-ft.) wide road is contingent on the redevelopment of the properties that abut the subject site.
- The ultimate 14.5-metre (48-ft.) wide road will include two-way traffic, parking on one side, as well as a sidewalk and boulevard (including trees and street lighting) on both sides.

• The applicant will be required to dedicate 8.5 metres (28 ft.) along the north lot line of the subject site for the east/west portion of the new 14.5-metre (48-ft.) wide road, with the remaining 6.0 metres (20 ft.) to be provided on the abutting property to the north (16854 Fraser Highway) when it redevelops in the future. The 14.5-metre (48-ft.) wide road will bend northward at the east end of the subject site to Fraser Highway. The completion of this north/south portion of the road to Fraser Highway is contingent on the redevelopment of the properties at 16854 and 16882 Fraser Highway (Appendix VII).

- The interim 8.5-metre (28-ft.) wide road will accommodate two-way traffic as well as a sidewalk on the south side. No parking can be accommodated within the 8.5-metre (28 ft.) road cross-section.
- Currently, direct vehicle access is proposed from the subject site via 168 Street. The road bends south of the abutting property to the north (7950 168 Street) in order to accommodate an access entirely on the subject site. When the adjacent properties redevelop in the future, the full 14.5-metre (48-ft) wide road will continue to utilize this vehicle access to 168 Street (Appendix VII).
- A 2.7-metre (9.0-ft.) wide right-of-way will be registered on the subject site along the west property line adjacent 168 Street for a multi-use path.

#### **PRE-NOTIFICATION**

Pre-notification letters were sent on April 12, 2016, and as a result, staff received two (2) e-mails. The respondents expressed the following concerns:

• The proposed townhouse development will generate more traffic, which will make the situation worse at a busy intersection (Fraser Highway and 168 Street).

(As part of the subject development application, the applicant is required to construct a centre median on 168 Street south of 80 Avenue to restrict left-in/left-out turning movements to and from the proposed road along the north property line. 168 Street is an arterial road, and will ultimately be widened to 4 lanes. The median will restrict left turning movements from and to the new road at the north end of the subject site. Ultimately, this new road will connect to Fraser Highway through future development in the area, and will provide additional access and egress options for future residents in the area.)

• The proposed townhouse development will generate more traffic, and make it more difficult for pedestrians to utilize the existing sidewalks and crosswalks in the area.

(The applicant is required to dedicate approximately 2.8 metres (9 ft.) and provide a 2.7-metre (9-ft.) wide right-of-way along 168 Street in order to accommodate road widening and a multi-use path. These works will improve upon the movement and safety for drivers and pedestrians in the area.)

#### JUSTIFICATION FOR PLAN AMENDMENT

• A proposed LRT station at the intersection of 168 Street and Fraser Highway, for the proposed LRT route along Fraser Highway that will connect City Centre to Langley, is located 100 metres (330 ft.) north of the subject site.

- The proposed OCP Amendment from Urban to Multiple Residential is consistent with Surrey's OCP policies seeking increased densities along future rapid transit corridors.
- The eastern boundary of the Fleetwood Town Centre Plan is located to the west of the subject site, across 168 Street, north of 80 Avenue. The "Medium Density Townhouses" designation within the Fleetwood Town Centre Plan, which permits townhouses, is located 250 metres (820 ft.) west of the subject site. Furthermore, 375 metres (1,230 ft.) to the west of the subject site, 101 townhouse units are proposed under Application No. 7916-0212-00 (Pre-Council) within Fleetwood Town Centre, south of Fraser Highway.
- The proposed 22-unit townhouse project supports housing diversity, sustainability and affordability, while also supporting increased densities near a rapid transit corridor.
- In accordance with the OCP, the provision of a community benefit is required for an OCP Amendment located outside of a secondary plan area. The applicant has agreed to provide a community benefit contribution for the proposed 22 townhouse units in the amount of \$1,500 per unit, for a total of \$33,000 prior to the rezoning being considered for Final Adoption.

#### PUBLIC CONSULTATION PROCESS FOR OCP AMENDMENT

Pursuant to Section 475 of the <u>Local Government Act</u>, it was determined that it was not necessary to consult with any persons, organizations or authorities with respect to the proposed OCP amendment, other than those contacted as part of the pre-notification process.

#### **DESIGN PROPOSAL AND REVIEW**

- The proposed 22-unit townhouse project consists of five (5), three-storey buildings with garages accessed internally at grade.
- All 22 proposed townhouses consist of double car, side-by-side garages. No tandem garage units are proposed.
- The proposed building materials include hardie panel siding painted white, horizontal vinyl siding painted blue, and corrugated metal siding painted grey. The proposed wood trims are painted black.
- The proposed unit doors are metal and will be painted to resemble a stained wood door. Entry canopies and window trims are painted black.

• Each proposed townhouse unit includes a second-floor deck as well as a rooftop deck located above the third floor bedrooms. The uncovered rooftop decks offer private outdoor space for each townhouse unit.

- The proposal will include two (2) electrical rooms adjacent to the Buildings 3 and 4. Two (2) pad-mounted transformer (PMT) boxes are proposed adjacent to Building 5. The PMTs will be screened by landscaping.
- The proposed townhouse development includes a total of 48 parking spaces, consisting of 44 resident parking spaces in 22 double car, side-by-side garages, as well as four (4) visitor parking spaces, which complies with the parking requirements of the Surrey Zoning By-law. All visitor parking spaces will be delineated by permeable concrete unit pavers.

#### **Amenity Spaces**

- The RM-30 Zone requires that 66 square metres (710 sq. ft.) of indoor amenity space and 66 square metres (710 sq. ft.) of outdoor amenity space be provided (3.0 sq.m. / 32 sq.ft. of each amenity per dwelling unit) for the proposed 22-unit townhouse project.
- The applicant proposes 77 square metres (828 sq.ft.) of outdoor amenity space, which exceeds the minimum 66 square metres (710 sq. ft.) required under the RM-30 Zone. The proposed outdoor amenity space is located at the southwest corner of the subject property adjacent to the proposed landscape buffer along the west lot line.
- The outdoor amenity space includes children's play equipment and a small grassed area with benches.
- Given the size of the proposed townhouse development (22 units), the applicant does not propose any indoor amenity space and will provide a monetary contribution of \$26,400 (based on \$1,200 per unit) in accordance with City policy to address this shortfall. The subject site is within close proximity to the Surrey Sports and Leisure Complex, which offers quality services and amenity space.

#### **TREES**

 Monica Ardiel, ISA Certified Arborist of Mike Fadum and Associates prepared an Arborist Assessment for the subject property. The table below provides a summary of the tree retention and removal by tree species:

Table 1: Summary of Tree Preservation by Tree Species:

Tree Species	Existing	Remove	Retain		
Alder	Alder and Cottonwood Trees				
Alder	8	8	0		
Cottonwood	7	7	0		
<b>Deciduous Trees</b> (excluding Alder and Cottonwood Trees)					
Birch, Paper	1	1	0		
Cherry	2	2	0		

Tree Species	Exis	ting	Remove	Retain
Cherry, Bitter	]	l	1	0
Oak, English	2	2	2	0
Plum, Purple Leaf	]	L	1	0
	Conifero	ous Tree	s	
Cedar, Western Red	1		1	0
Falsecypress	6	Ó	6	0
Norway Spruce	1		1	0
<b>Total</b> (excluding Alder and Cottonwood Trees)	15		15	0
Total Replacement Trees Proposed (excluding Boulevard Street Trees)			79	
Total Retained and Replacement Trees			79	
Contribution to the Green City Fund		1	No contribution	required

- The Arborist Assessment states that there are a total of 15 mature trees on the site, excluding Alder and Cottonwood trees. Fifteen (15) existing trees, approximately 50% of the total trees on the site, are Alder and Cottonwood trees. It was determined that no trees can be retained as part of this development proposal. The proposed tree retention was assessed taking into consideration of tree health, building footprints and road dedication.
- For those trees that cannot be retained, the applicant will be required to plant trees on a 1 to 1 replacement ratio for Alder and Cottonwood trees, and a 2 to 1 replacement ratio for all other trees. This will require a total of 45 replacement trees on the site. The applicant is proposing 79 replacement trees, which exceeds City requirements.
- In summary, a total of 79 trees are proposed to be replaced on the subject site. No contribution is required to the Green City Fund.

#### **Landscaping**

- The landscape plan shows a total of 79 trees to be planted throughout the subject site including maple, spruce, pine and pear.
- A significant number of shrubs and ground cover species are proposed throughout the subject site, including boxwood, yew, rhododendrens, barberry, sedge and decorative grasses.
- The applicant proposes a 3.0-metre (10-ft.) wide landscape buffer, adjacent to the 2.7-metre (9-ft.) wide multi-use path along the west property line, to provide screening from 168 Street.

#### SUSTAINABLE DEVELOPMENT CHECKLIST

The applicant prepared and submitted a sustainable development checklist for the subject site on May 12, 2016. The table below summarizes the applicable development features of the proposal based on the seven (7) criteria listed in the Surrey Sustainable Development Checklist.

Sustainability Criteria	Sustainable Development Features Summary
1. Site Context & Location (A1-A2)	• The site is located in Fleetwood in an established neighbourhood with frequent transit service along Fraser Highway and 168 Street.
2. Density & Diversity (B1-B7)	<ul> <li>The proposed development will increase the density in the area and promote a more urban, pedestrian-friendly streetscape.</li> <li>The project will diversify the housing stock and provide additional options for future home buyers in this area.</li> <li>Increased densities in the area may advance the expansion of transit options and create a more pedestrian and transit-friendly neighbourhood.</li> </ul>
3. Ecology & Stewardship (C1-C4)	The proposed development includes absorbent soils, swales, and sediment control devices.
4. Sustainable Transport & Mobility (D1-D2)	<ul> <li>Frequent transit service runs along both Fraser Highway and 168 Street, and transit stops are located within walking distance from the subject site.</li> <li>A multi-use path runs along 168 Street and provides access for pedestrians and cyclists.</li> </ul>
5. Accessibility & Safety (E1-E3)	The proposed building incorporates CPTED principles including: well-lit entries/exits, passive surveillance on the street, and good pedestrian linkages and lighting.
6. Green Certification (F1)	No green rating or certification is proposed.
7. Education & Awareness (G1-G4)	Pre-notification letters were mailed to area residents and a development proposal sign was installed on subject site.

#### BY-LAW VARIANCES AND JUSTIFICATION

#### (a) Requested Variances:

• To reduce the minimum front yard (west) setback of the RM-30 Zone from 7.5 metres (25 ft.) to 6.5 metres (21 ft.) to the corner of Building 1, and to 5.5 metres (18 ft.) to the corner of Building 2 and to 5.0 metres (16.5 ft.) to the building overhang of Building 2;

• To reduce the minimum rear yard (east) setback of the RM-30 Zone from 7.5 metres (25 ft.) to 6.0 metres (20 ft.) to the building face and to 5.0 metres (16.5 ft.) to the roof overhang of Building 4, and to 3.0 metres (10 ft.) to the building face of the east townhouse unit in Building 5 and to 2.5 metres (8 ft.) to the building face of the electrical room and to 1.5 metres (5 ft.) to the electrical room roof overhang of Building 5;

- To reduce the minimum north side yard setback of the RM-30 Zone from 7.5 metres (25 ft.) to 4.0 metres (13 ft.) to the building face and to 3.0 metres (10 ft.) to the roof overhangs of Buildings 1 and 5; and
- To reduce the minimum south side yard setback of the RM-30 Zone from 7.5 metres (25 ft.) to 5.5 metres (18 ft.) to the building face and to 5.0 metres (16.5 ft.) to the roof overhangs of Buildings 3 and 4.

#### Applicant's Reasons:

- The proposed setback reductions along the east lot line will bring the units closer to the street, which will allow the units to better engage the street and enliven the public realm.
- The reduced setbacks are consistent with similarly approved setbacks for other townhouse developments in the City.
- The roof overhangs form an integral part of the overall design and articulation of the buildings.

#### **Staff Comments:**

- The RM-30 Zone requires that buildings and structures be sited a minimum of 7.5 metres (25 ft.) from all property lines.
- The reduced front yard (west) setbacks of 6.5 metres (21 ft.) and 5.5 metres (18 ft.) are to the corners of proposed Buildings 1 and 2, and are measured to the west property line along 168 Street. A 2.7-metre (9-ft.) wide right-of-way (ROW) for a multi-use path along the west lot line of the subject site, and the corners of proposed Buildings 1 and 2 are set back 4.0 metres (13 ft.) and 3.0 metres (10 ft.) from the ROW.
- The proposed rear yard (east) setback of 6.0 metres (20 ft.) to proposed Building 4 will allow adequate rear yard spaces with landscaping, while the proposed setback of 3.0 metres (10 ft.) to east townhouse unit in proposed Building 5 is a side yard condition. The proposed 2.5 metres (8 ft.) setback to the building face of the electrical room attached to the east end of townhouse unit #19 in proposed Building 5 is also a side yard condition, and will likely be adjacent to an internal drive aisle of the abutting property to the east when it is redeveloped in the future. In the interim, the reduced setbacks are not expected to negatively impact the adjacent property to the east, as the existing dwelling at 16882 Fraser Highway is located further to the north near Fraser Highway.

• The proposed north side yard setback of 4.0 metres (13 ft.) will accommodate front yards for proposed Buildings 1 and 5, as these townhouse units will front the new 8.5-metre (28-ft.) wide road.

- The proposed south side yard setback of 5.5 metres (18 ft.) to proposed Buildings 3 and 4 is a side yard condition measured to south lot line. A 3.0-metre (10-ft.) wide landscape buffer is proposed along the entire south lot line, and proposed Buildings 3 and 4 will be set back at least 2.5 metres (8 ft.) from the landscape buffer. The landscape buffer provides screening along the south lot line, and as a result, the reduced south side yard setback is not expected to impact the abutting lot to the south, which is owned by Fortis BC and occupied by a telecommunications tower and outdoor storage.
- The reduced setbacks are consistent with similarly approved setbacks for other townhouse developments in the Fleetwood area.
- Staff support the requested variances.

#### (b) Requested Variance:

• To increase the maximum permitted building height of the RM-30 Zone from 13 metres (42.5 ft.) to 13.5 metres (43.5 ft.) for Building 4 only.

#### Applicant's Reasons:

- The existing grade is lower at the southeast corner of the subject site, and the floor elevations are driven by the internal driveway, which must also work with the west-facing units in proposed Building 3. A minor increase of 0.25 metre (0.8 ft.) to the maximum permitted building height of 13 metres (42.5 ft.) is requested for proposed Building 4.
- The proposed height will be compatible with future development southeast of the site, which is anticipated to be in the form of a 3-storey townhouse development.

#### **Staff Comments:**

- The RM-30 Zone states that principal buildings cannot exceed 13 metres (42.5 ft.) in height.
- The height of proposed Building 4 located at the southeast corner of the subject site is approximately 13.3 metres (43.5 ft.), which is less than a 0.5 metre (1 ft.) above the maximum permitted building height.
- The minor increase in the building height is to accommodate building extensions above the roof, which provide greater building articulation.
- The height of the other four (4) proposed buildings (Buildings 1, 2, 3 and 5) do not exceed the maximum permitted building height of 13 metres (42.5 ft.).
- Staff support the requested variance.

#### **INFORMATION ATTACHED TO THIS REPORT**

The following information is attached to this Report:

Appendix I. Lot Owners, Action Summary and Project Data Sheets Appendix II. Site Plan, Building Elevations, and Landscape Plans

Appendix III. Engineering Summary
Appendix IV. School District Comments

Appendix V. Summary of Tree Survey and Tree Preservation Appendix VI. Development Variance Permit No. 7915-0108-00 Appendix VII. Proposed Road and Redevelopment Concept

Appendix VIII. OCP Amendment Map

original signed by Judith Robertson

Jean Lamontagne General Manager Planning and Development

#### DN/dk

c:\users\dk7\appdata\local\temp\oa\folderdocumentdetail\_getfile\_o.tmp KD 6/22/16 3:54 PM

#### <u>Information for City Clerk</u>

Legal Description and Owners of all lots that form part of the application:

1. (a) Agent: Name: Colin A. Hogan

Focus Architecture Incorporated

Address: Unit 109, 1528 McCallum Road

Abbotsford, BC V2S 8A3

Tel: (604)853-5222

2. Properties involved in the Application

(a) Civic Address: 7918 – 168 Street

(b) Civic Address: 7918 – 168 Street

Owner: Hayers Builders Group (Fleetwood Townhomes) Ltd.

PID: 006-934-862

Lot 12 Section 19 Township 8 New Westminster District Plan 33907

- 3. Summary of Actions for City Clerk's Office
  - (a) Introduce a By-law to amend the Official Community Plan to redesignate the site.
  - (b) Introduce a By-law to rezone the property.
  - (c) Proceed with Public Notification for Development Variance Permit No. 7915-0108-00 and bring the Development Variance Permit forward for an indication of support by Council. If supported, the Development Variance Permit will be brought forward for issuance and execution by the Mayor and City Clerk in conjunction with the final adoption of the associated Rezoning By-law.

### **DEVELOPMENT DATA SHEET**


Proposed Zoning: RM-30


Required Development Data	Minimum Required / Maximum Allowed	Proposed Zonnig: RM-30
LOT AREA	- Maximum miowea	
Gross Total		5,687 sq.m.
Road Widening area		1,105 sq.m.
Undevelopable area		7 7 1
Net Total		4,582 sq.m.
LOT COVERAGE (in % of net lot area)		
Buildings & Structures	45%	37%
Paved & Hard Surfaced Areas		26%
Total Site Coverage		63%
SETBACKS		
Front (west): Building 1	7.5 metres	6.5 metres to corner of Building 1*
Front (west): Building 2	7.5 metres	5.5 metres to corner and 5.0 metres to the overhang of Building 2*
Rear (east): Building 4	7.5 metres	6.0 metres to building face and 5.0 metres to roof overhang of Building 4*
Rear (east) : Building 5	7.5 metres	3.0 metres to building face of the townhouse unit in Building 5, and 2.5 metres to the electrical room and 1.5 metres to roof overhang of Building 5*
Side #1 (north)	7.5 metres	4.0 metres to building face and 3.0 metres to overhangs of Buildings 1 & 5*
Side #2 (south)	7.5 metres	5.5 metres to building face and 5.0 metres to overhangs of Buildings 3 & 4*
BUILDING HEIGHT		
Principal	13 metres	13.5 metres* (Building 4 only)
Indoor Amenity Building	11 metres	5.5 metres
Accessory	4.5 metres	N/A
NUMBER OF RESIDENTIAL UNITS		
One Bed		N/A
Two Bedroom		N/A
Three Bedroom +		22
Total		22
FLOOR AREA: Residential		4,109 sq.m.
FLOOR AREA: Commercial		N/A
Retail		
Office		
Total		
FLOOR AREA: Industrial		N/A
FLOOR AREA: Institutional		N/A
TOTAL BUILDING FLOOR AREA	4,123 sq.m.	4,109 sq.m.
*Variances requested		

# Development Data Sheet cont'd

Required Development Data	Minimum Required / Maximum Allowed	Proposed
DENSITY		
# of units/ha /# units/acre (gross)		39 uph / 16 upa
# of units/ha /# units/acre (net)	75uph / 30 upa	48 uph / 19.5 upa
FAR (gross)		0.72
FAR (net)	0.90	0.90
AMENITY SPACE (area in square metres)		
Indoor	66 sq.m.	o.o sq.m.
Outdoor	66 sq.m.	77 sq.m.
PARKING (number of stalls)		
Commercial		N/A
Industrial		N/A
Residential Bachelor + 1 Bedroom		
2-Bed		
3-Bed	44	44
Residential Visitors	4	4
Institutional		N/A
Total Number of Parking Spaces	48	48
Number of disabled stalls		0
Number of small cars		0
Tandem Parking Spaces: Number / % of Total Number of Units		N/A
Size of Tandem Parking Spaces width/length		N/A

Heritage Site NO	Tree Survey/Assessment Provided	YES
------------------	---------------------------------	-----

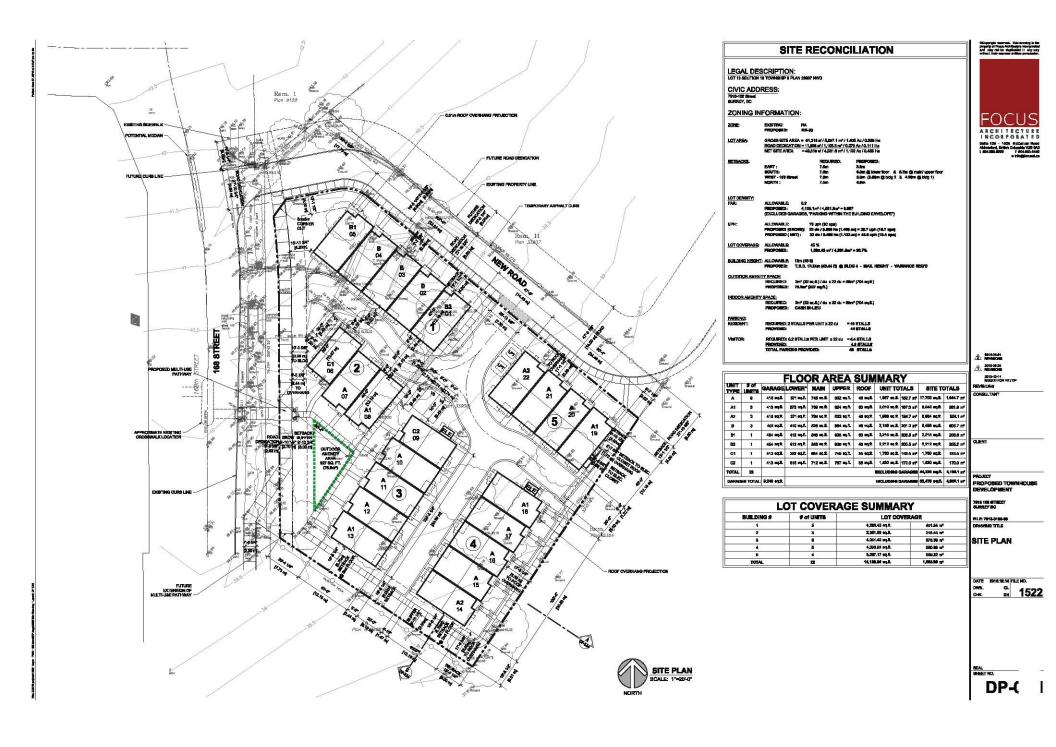

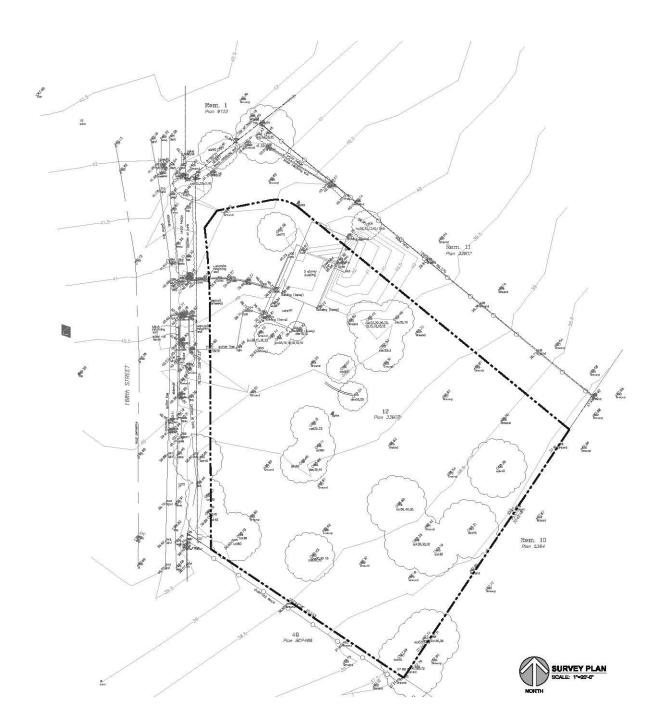



À 2019-04-01 № 2019-08-04 № 2019-08-04

7018 100 STREET SURVEY BG

SURVEY PLAN

DATE BOIGNESS FLEND.
DWN. CL
CHK DH 1522

DP-0.02



NORTH STREETSCAPE (NEW ROAD) SCALE: N.T.S.



WEST STREETSCAPE (168 STREET) SCALE: N.T.S.

Company of the Control of the Contro ARCHITECTURE INCORPORATED BOTO IN - 100 MORNING POR INCOME TO COMPANY INCOME TO COMPANY

A 1545 A 1545

MALES FOREIZZEP VIENCING

FILE THIS CHIEF.

COLOURED STREETSCAPES

DATE SHEEKE FLENG.

DP-0.0a



Minispely is consent. This density is the property of Photo Additional Intelligence of the party may self-out to be supported in party may self-out facilities with the property of the party may self-out facilities of the party may self-out facilities of the party may be supported to the party may be suppo **FOCUS** 

A MAN A MARK

MALES POLICE/ESP
PERVISORES
COMMUNICATION

PROPOSED TOWNSHOUSE DEVELOPMENT

NAME AND ADDRESS OF THE OWNER, TH

FILE THIS CHIEF.

COLOUR SCHEME


DATE SHEEKE PLENG.


DP-0.0b



Ottoppright reserved. This drawing is the properly of Popus Autolitedary impergented and may not be deplicated in any only of these trade general artifacts. ARCHITECTURE INCORPORATED

1522

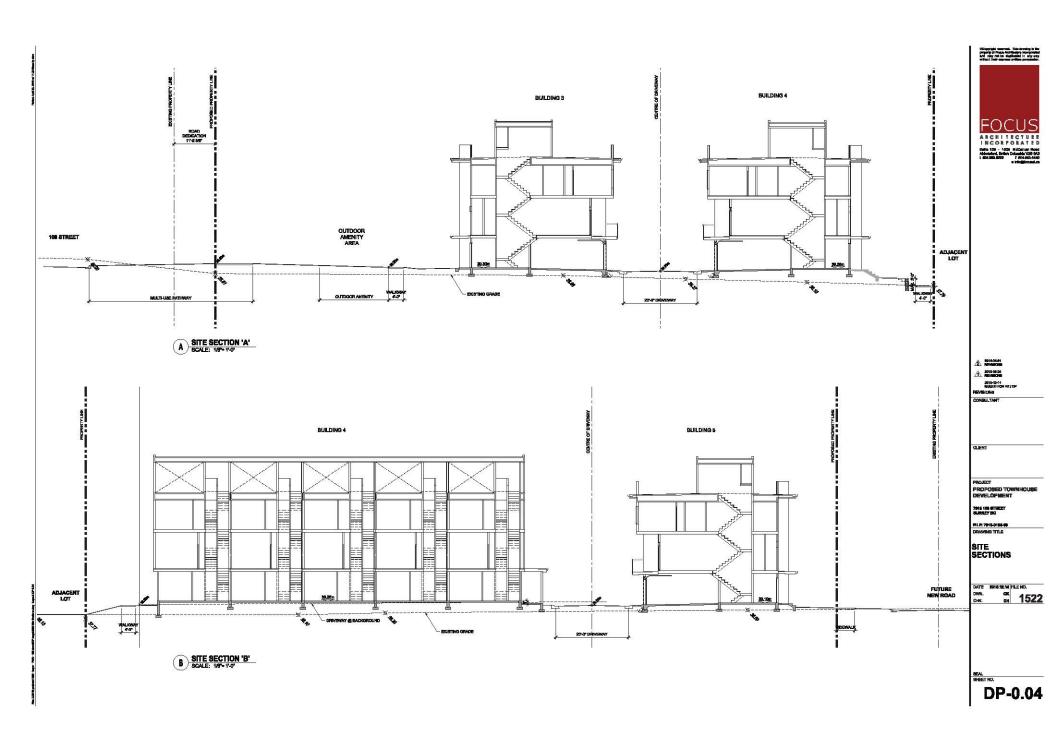

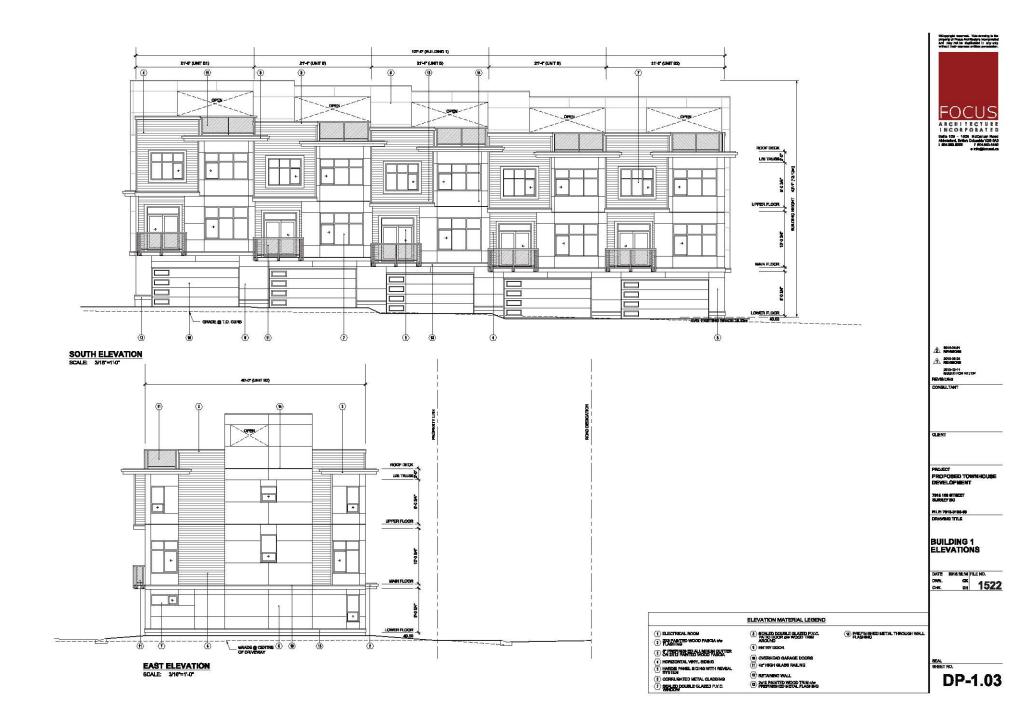



Ottoppright reserved. This dressing is the property of Popus Anti-Resign interpretable and may not be deplicated in any enty of that their opens written pre-market.






T SEALED POUBLE GLAZED P.V.C.

Ottoppright reserved. This dressing is the property of Popus Anti-Resign interpretable and may not be deplicated in any enty of that their opens written pre-market. FOCUS ARCHITECTURE INCORPORATED

1522

DP-3.03



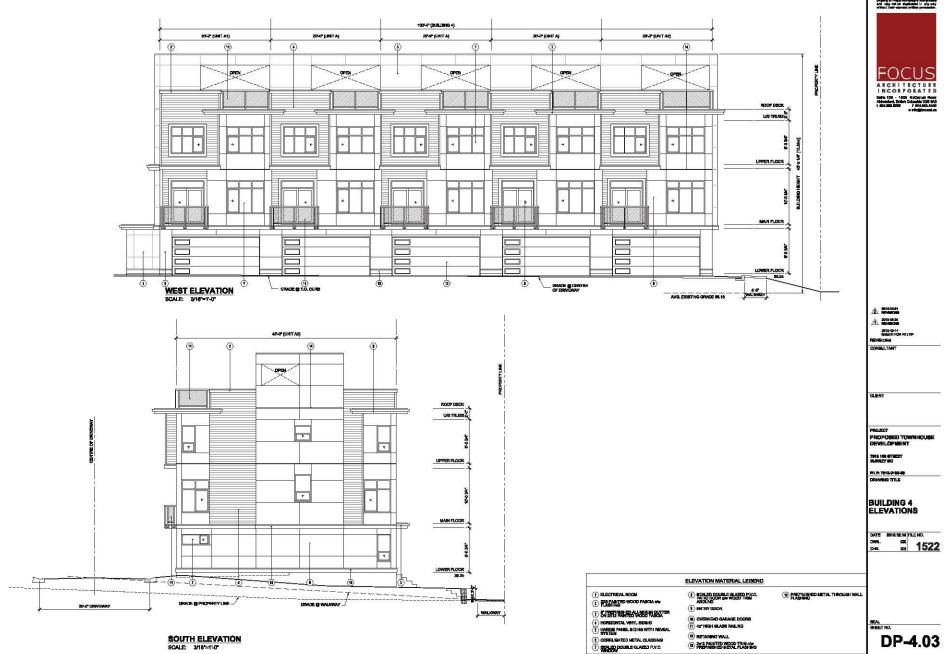


Ottoppright reserved. This dressing is the property of Popus Anti-Resign interpretable and may not be deplicated in any enty of that their opens written pre-market.




Ottoppright reserved. This density is the property of Pope Auctionates improposed and really not be deplicated in any exty of that their expenses without their expenses without their expenses without their expenses. ARCHITECTURE INCORPORATED



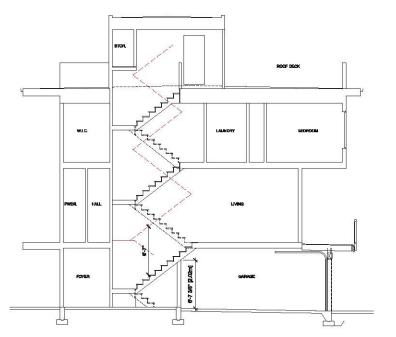



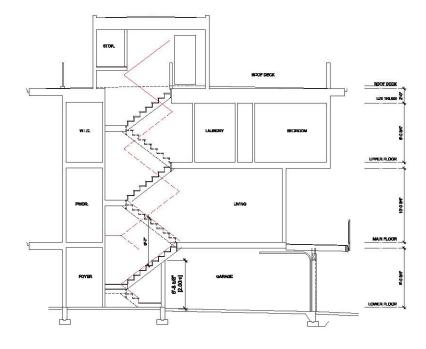

TYP. UNIT C STAIR SECTION SCALE: 14"=1"-0"

ROOF DECK 🛬 lb

FOCUS
ARCHITECTURE
INCOME TO THE PROPERTY OF T

2016-03-41
PER-MICHIE
2016-03-14
REQUEST FOR REZ/ESP
PEN-MICHIE
PE

\_\_\_\_

PROJECT PROPOSED TOWNHOUS DEVELOPMENT


764s 100 STREET SURGLEY BO

PILE: 7915-0105-09 DRAWING TITLE

UNIT SECTIONS

DATE 2016.92.14 FILE NO.
DWN. CX
CHK. CH 1522

DP-6.07

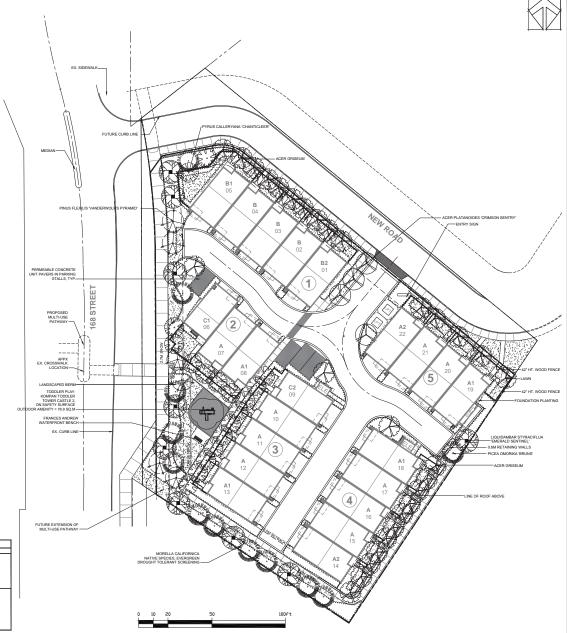

SEAL:

CLIENT:

#### PROPOSED TOWNHOUSE DEVELOPMENT

7918 168TH STREET SURREY, B.C.

DRAWING TITLE:

#### LANDSCAPE PLAN


DATE:	15.NOV.25	DRAWING NUMBER:
SCALE:	1"=20'-0"	
DRAWN:	MM	L1
DESIGN:	MM	
CHK'D:		OF 3

15-172



TREE	TREE SCHEDULE PMG PROJECT NUMBER: 15-172				
KEY	QTY	BOTANICAL NAME	COMMON NAME	PLANTED SIZE / REMARKS	
(d)	29	ACER GRISEUM	PAPERBARK MAPLE	6CM CAL:1.8M STD:B&B	
1 20	) 4	ACER PLATANOIDES 'CRIMSON SENTRY'	COLUMNAR CRIMSON SENTRY MAPLE	6CM CALI2M STDIB&B	
(B)	10	LIQUIDAMBAR STYRACIFLUA 'EMERALD SENTINEL'	EMERALD SENTINEL SWEETGUM	6CM CALI2M STDIB&B	
- 0	12	PICEA OMORIKA 'BRUNS'	BRUNS SERBIAN SPRUCE	2.5M HT::B&B	
4	6	PINUS FLEXILIS 'VANDERWOLF'S PYRAMID'	VANDERWOLF'S PYRAMIDAL LIMBER PINE	2M HT/B&B	
7	18	PYRUS CALLERYANA 'CHANTICLEER'	CHANTICLEER PEAR	6CM CAL:1.5M STD:B&B	
NOTES: "PLANT SUZES IN THIS LIST ARE SPECIFIED ACCORDING TO THE BC LANDSCAPE STANDARD, LATEST EDITION. CONTAINER SUZES SPECIFIED AS PER NOTES, STANDARDS. BOTH IN BALE SIZE AND CONTRAINED AND AND AND AND AND AND AND AND AND AN					

ONTA STANDARDS. BOTH PLANT SUE AND CONTINUES SUE ARE THE MINIMUM ACCEPTABLE SUES. REFERT OS PECIFICATIONS FOR DEFINED CONTINUES MEASUREMENTS AND DIFFER AVAILABLE FOR FOR FOR THE ACCEPTABLE SUES. SECRET AS SECRETARIA AVAILABLE FOR POPIONAL REVIEWED LANGUAGE ADDITECT AT SOURCE OF SUPPLY. AREA OF BEARDH TO INCLUDE LOWER MAINLAND AND FRASER VALIDEY. SUBSTITUTIONS OBTAIN WRITTEN LANGUAGE FOR A SECRETARIA AVAILABLE FOR THE ACCEPTABLE OF SECRETARIA AVAILABLE FOR SECRETARIA AVAILABLE SECRETARIA AVAILABLE FOR SECRETARIA AVAI

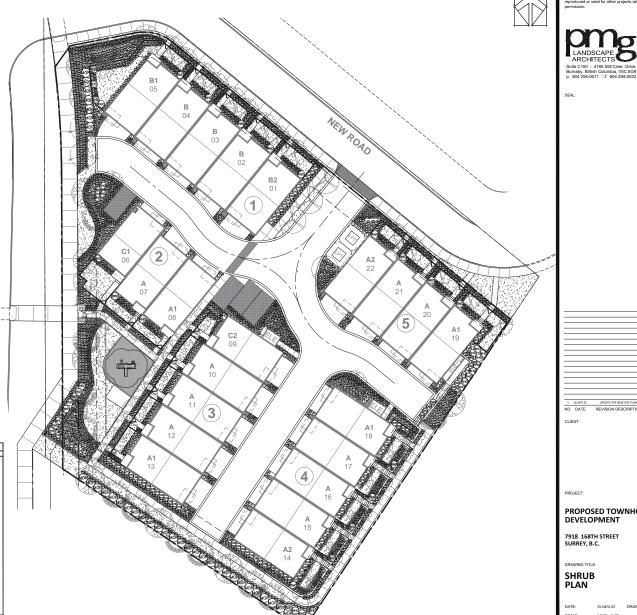

PLANT SCHEDULE PMG PROJECT NUMBER: 15-172 PLANTED SIZE / REMARKS 6CM CAL::1.8M STD::B&B 6CM CAL::2M STD::B&B PAPERBARK MAPLE COLUMNAR CRIMSON SENTRY MAPLE ACER PLATANOIDES 'CRIMSON SENTRY ALEH PALI MOULES CHRISION SERVITE COLUMNAR PARADER STATE OF THE MORE COLUMNAR PARADER STATE SWEETING WE PICE A MORRIKA 'BEUIS'
PINUS FLEXILIS 'VANDERWOLFS PYRAMID'
PINUS FLEXILIS VANDERWOLFS PYRAMID'
PINUS CALERYAMA' CHANTICLEER'
CHANTICLEER PEAR 6CM CALI2M STDIB&B 2.5M HTIB&B 2M HT/B&B 6CM CAL::1.5M STD::B&B GOLDEN DWARF BARBERRY DWARF ENGLISH BOXWOOD MEXICAN MOCK ORANGE BIGLEAF HYDRANGEALRED RHODODENDRON-BLUE HIMALAYAN SWEET BOX JAPANESE SKIMMIA HICK'S YEW DAVID'S VIBURNUM 12 POTESOCM 12 POTESOCM 13 POTESOCM 13 POTESOCM 12 POTESOCM 12 POTESOCM 13 POTESOCM 1.5M B&B 13 POTESOCM BERBERIS THUNBERGII "AUREA NANA" BERBERIS THUNBERGII "AUREA NAMA"
BUNJA SEMPERVIRENS SUFFETUTIOGAN
CHOISYA TERNATA SUNDANCE
HYDRANGEA MACROPHYLLA MASJA'
RHODODENDRON "ANAH KRUSCHKE"
SARCOCOCCA HOOKERANA VAR. HUMILIS
SIMMINI, JAPONICA (10% MALE)
TAXUS X MEDIA HICKSI'
VIBURNUM DAVIDII | ■ 421 | WIBURNAUM DAVIDII
| GRASS | | → 459 | | → 459 | → 459 | | → 459 | | → 459 | | → 459 | | → 459 | | → 459 | | → 459 | | → 459 | | → 459 | | → 459 | | → 459 | | → 459 | | → 459 | → 459 | | → 459 | | → 459 | | → 459 | | → 459 | | → 459 | | → 459 | | → 459 | | → 459 | | → 459 | | → 459 | | → 459 | | → 459 | → 459 | | → 459 | | → 459 | | → 459 | | → 459 | | → 459 | | → 459 | | → 459 | | → 459 | | → 459 | | → 459 | | → 459 | | → 459 | → 459 | | → 459 | | → 459 | | → 459 | | → 459 | | → 459 | | → 459 | | → 459 | | → 459 | | → 459 | | → 459 | | → 459 | | → 459 | → 459 | | → 459 | | → 459 | | → 459 | | → 459 | | → 459 | | → 459 | | → 459 | | → 459 | | → 459 | | → 459 | | → 459 | | → 459 | → 459 | | → 459 | | → 459 | | → 459 | | → 459 | | → 459 | | → 459 | | → 459 | | → 459 | | → 459 | | → 459 | | → 459 | | → 459 | → 459 | | → 459 | | → 459 | | → 459 | | → 459 | | → 459 | | → 459 | | → 459 | | → 459 | | → 459 | | → 459 | | → 459 | | → 459 | → 459 | | → 459 | | → 459 | | → 459 | | → 459 | | → 459 | | → 459 | | → 459 | | → 459 | | → 459 | | → 459 | | → 459 | | → 459 | → 459 | | → 459 | | → 459 | | → 459 | | → 459 | | → 459 | | → 459 | | → 459 | | → 459 | | → 459 | | → 459 | | → 459 | | → 459 | → 459 | | → 459 | | → 459 | | → 459 | | → 459 | | → 459 | | → 459 | | → 459 | | → 459 | | → 459 | | → 459 | | → 459 | | → 459 | → 459 | | → 459 | | → 459 | | → 459 | | → 459 | | → 459 | | → 459 | | → 459 | | → 459 | | → 459 | | → 459 | | → 459 | | → 459 | → 459 | | → 459 | | → 459 | | → 459 | | → 459 | | → 459 | | → 459 | | → 459 | | → 459 | | → 459 | | → 459 | | → 459 | | → 459 | → CAREX CAROPHYLLEA 'BEATLEMANIA' HELICTOTRICHON SEMPERVIRENS MISCANTHUS SINENSIS 'GRACILLIMUS' STIPA TENUISSIMA BEATLEMANIA SEDGE BLUE OAT GRASS MAIDEN GRASS MEXICAN FEATHER GRASS n POT n POT n POT n POT NIAL 23 HEMEROCALLIS :STELLA D'ORO' DAYLILY:YELLOW 2 POT:2-3 FAN MEXICAN FEATHER GRASS □1 POT

NOTES: PLANT SIZES IN THIS LIST ARE SPECIFED ACCORDING TO THE BC LANGSCAPE STANDARD, LATEST EDITION. CONTAINER SIZES SPECIFIED AS PER CALL STANDARDS, BOTH PLANT SIZE AND CONTAINERS SIZE ARE THE MINIMAM ACCEPTABLE SIZES. REFERT OS SPECIFICATIONS FOR DEFINED CONTAINERS CALL STANDARDS. BOTH PLANT SIZE AND CONTAINERS SIZES SPECIFIED AND SIZES SPECIFIED ASSETT OF SPECIFICATIONS FOR DEFINED CONTAINERS AND ADMINISTRATION OF THE SIZE OF SPECIFIED ASSETT OF SPECIFICATIONS AND SIZES SPECIFIED ASSETT ASSETT AND SIZES SPECIFIED ASSETT AND S

Copyright reserved. This drawing and design is the property of PMG Landscape Architects and may not be reproduced or used for other projects without their

UPDATE PER NEW SITE PLAN
REVISION DESCRIPTION

## PROPOSED TOWNHOUSE


DATE:	15.NOV.25	DRAWING NUMBER
SCALE:	1/16" = 1'-0"	
DRAWN:	MM	17
DESIGN:	MM	
CHKD:		OF 3

15-172




KOMPAN TOWER CASTLE

42" WOOD PICKET FENCE

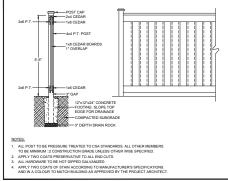



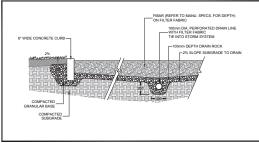

PROJECT:

PROPOSED TOWNHOUSE DEVELOPMENT

7918 168TH STREET SURREY, B.C.

DRAWING TITLE

LANDSCAPE DETAILS

 DATE:
 15.NOV.25
 DRAWING NUMBER:

 SCALE:
 AS SHOWN

 DRAWN:
 MM

 DESIGN:
 MM

 CHKD:
 MCY

 OF 3

nma

Copyright reserved. This drawing and design is the property of PMG Landscape Architects and may not be reproduced or used for other projects without their

LANDSCAPE ARCHITECTS
Suite C100 - 4185 Still Cree=Drive
Burnaby, British Columbia, V5C 6G9
p: 604 294-0022

SEAL:

1. MANYAZ UPDATTERNINUSTE NANA CALINATORIA
 NO. DATE REVISION DESCRIPTION DA

CALINATORIA



# INTER-OFFICE MEMO

TO:

Manager, Area Planning & Development - North Surrey Division

Planning and Development Department

FROM:

Development Project Engineer, Engineering Department

DATE:

June 22, 2016

PROJECT FILE:

7815-0108-00

RE:

Engineering Requirements Location: 7918 168 Street

#### **OCP AMENDMENT**

There are no engineering requirements relative to the OCP Amendment.

#### **REZONE**

#### Property and Right-of-Way Requirements

- Dedicate 2.808 m along 168 Street towards the 30 m Arterial Road Standard.
- Dedicate 8.5 m along the north/east property line towards the 14.5 m Flex Road.
- Provide a 2.7 m Statutory Right-of-Way along the 168 Street frontage to facilitate the construction of the Multi-Use Pathway.
- Provide a 0.5 m Statutory Right-of-Way along the frontage of the Flex Road.

#### Works and Services

- Construct a 4.0 m Multi-Use Pathway along the east side of 168 Street.
- Construct a 0.6 m wide finger median along the existing 168 Street left turn bay to restrict Flex Road to right in/right out.
- Construct the Flex Road to an interim standard until future development of adjacent lands.
- Construct a 7.3 m concrete driveway letdown to the Flex Road.
- Provide on-site stormwater mitigation features per the draft Fleetwood Greenway North Creek ISMP.
- Construct water, storm, and sanitary service connections to service the development.
- Abandon existing service connections no longer required to the proposed lot.

A Servicing Agreement is required prior to Rezoning.

#### **DEVELOPMENT PERMIT**

There are no engineering requirements relative to issuance of the Development Permit.

Robert Cooke, Eng.L.

Development Project Engineer

CE<sub>4</sub>



Friday, April 22, 2016
Planning

## THE IMPACT ON SCHOOLS

APPLICATION #:

15 0108 00

#### SUMMARY

The proposed 22 townhouse units are estimated to have the following impact on the following schools:

#### Projected # of students for this development:

Elementary Students:	4
Secondary Students:	2

#### September 2015 Enrolment/School Capacity

William	Watson	Elementary

Enrolment (K/1-7): 38 K + 322 Capacity (K/1-7): 40 K + 325

#### Fleetwood Park Secondary


Enrolment (8-12):	1371
Nominal Capacity (8-12):	1200
Functional Capacity*(8-12);	1296

#### School Enrolment Projections and Planning Update:


The following tables illustrate the enrolment projections (with current/approved ministry capacity) for the elementary and secondary schools serving the proposed development.

There are no new capital projects proposed at William Watson Elementary or Fleetwood Park Secondary. Fleetwood Park Secondary is slightly over capacity and uses 3 portables to help accommodate the additional enrolment. William Watson is subject to enrolment pressures which will increase as development continues along Fraser Highway.

#### William Watson Elementary

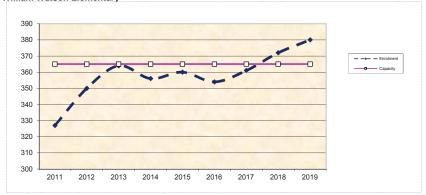

#### Fleetwood Park Secondary

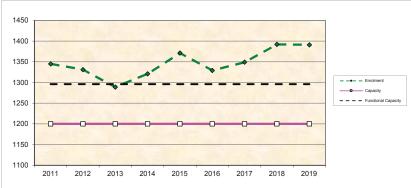

\*Functional Capacity at secondary schools is based on space utilization estimate of 27 students per instructional space. The number of instructional spaces is estimated by dividing nominal facility capacity (Ministry capacity) by 25.

# MIKE FADUM AND ASSOCIATES LTD. VEGETATION CONSULTANTS

# **Tree Preservation Summary**

**Surrey Project No: TBD** 

Address: 7918 -168 Street, Surrey, BC Registered Arborist: Monica Ardiel

On-Site Trees	Number of Trees	
Protected Trees Identified  (on-site and shared trees, including trees within boulevards and proposed streets and lanes, but excluding trees in proposed open space or riparian areas)  Protected Trees to be Removed  Protected Trees to be Retained	30 30	
(excluding trees within proposed open space or riparian areas)	0	
- Alder & Cottonwood Trees Requiring 1 to 1 Replacement Ratio  15 X one (1) = 15  - All other Trees Requiring 2 to 1 Replacement Ratio  15 X two (2) = 30	45	
Replacement Trees Proposed	TBD	
Replacement Trees in Deficit	TBD	
Protected Trees to be Retained in Proposed [Open Space / Riparian Areas]	NA	

Off-Site Trees	Number of Trees
Protected Off-Site Trees to be Removed	1
Total Replacement Trees Required:  - Alder & Cottonwood Trees Requiring 1 to 1 Replacement Ratio $1 \times 0 = 1$	0
- All other Trees Requiring 2 to 1 Replacement Ratio 0 X two (2) = 0	
Replacement Trees Proposed	TBD
Replacement Trees in Deficit	TBD

Summary report and plan prepared and submitted by: Mike Fadum and Associates Ltd.			
Signature of Arborist: Date: February 11, 2015			






# MIKE FADUM AND ASSOCIATES LTD. VEGETATION CONSULTANTS

**Table 1: Summary of Tree Preservation by Tree Species:** 

Tree Species	Existing	Remove	Retain			
Alder and Cottonwood Trees						
Alder/ Cottonwood	15	0	0			
Deciduous Trees  (excluding Alder and Cottonwood Trees)						
Birch, Paper	1	1	0			
Cherry	2	2	0			
Cherry, Bitter	1					
Oak, English	2	2	0			
Plum, Purple Leaf	1	1	0			
Col	niferous Trees					
Cedar, Western Red	1	1	0			
Falsecypress	6	6	0			
Holly	1	1	0			
<b>Total</b> (excluding Alder and Cottonwood Trees)	15	15	0			
Additional Trees in the proposed Open Space / Riparian Area	NA	NA	NA			
Total Replacement Trees Proposed (excluding Boulevard Street Trees)		TE	BD			
Total Retained and Replacement Trees		TBD				





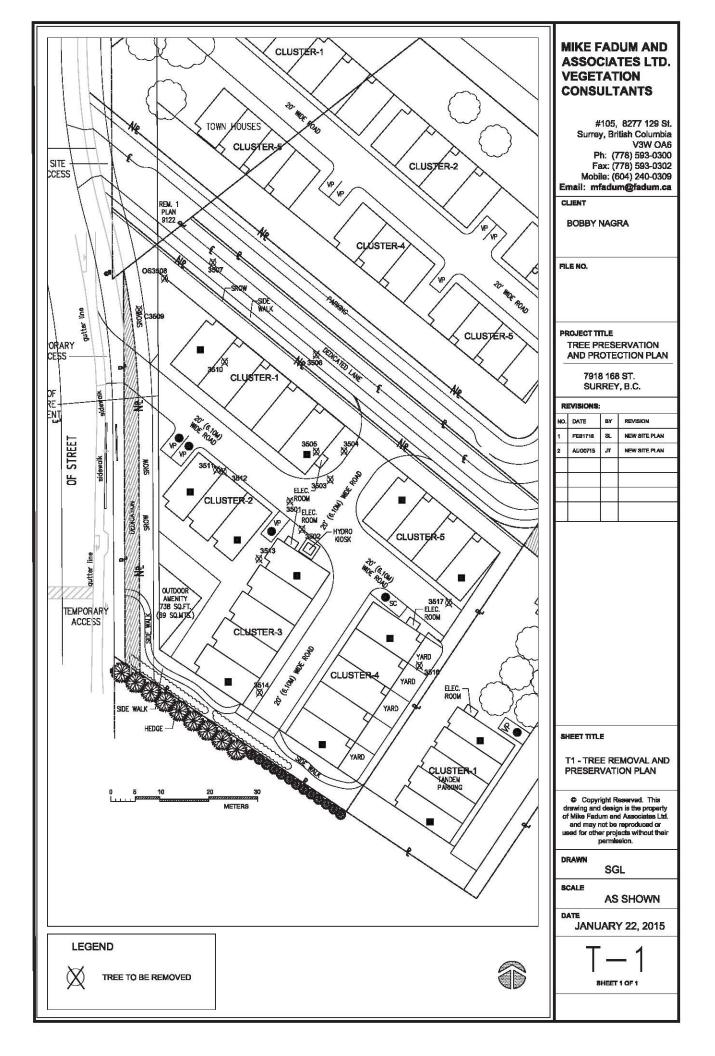

#### **CITY OF SURREY**

(the "City")

#### **DEVELOPMENT VARIANCE PERMIT**

NO.: 7915-0108-00

Issued To: Hayers Builders Group (Fleetwood Townhomes) Ltd.

("the Owner")

Address of Owner: 16317 – 36A Avenue

Surrey, BC V<sub>3</sub>S oX<sub>5</sub>

- 1. This development variance permit is issued subject to compliance by the Owner with all statutes, by-laws, orders, regulations or agreements, except as specifically varied by this development variance permit.
- 2. This development variance permit applies to that real property including land with or without improvements located within the City of Surrey, with the legal description and civic address as follows:

Parcel Identifier: 006-934-862 Lot 12 Section 19 Township 8 New Westminster District Plan 33907

7918 - 168 Street

(the "Land")


- 3. Surrey Zoning By-law, 1993, No. 12000, as amended is varied as follows:
  - (a) To reduce the minimum front yard (west) setback of the RM-30 Zone from 7.5 metres (25 ft.) to 6.5 metres (21 ft.) to the corner of Building 1, and to 5.5 metres (18 ft.) to the corner of Building 2 and to 5.0 metres (16.5 ft.) to the building overhang of Building 2;
  - (b) To reduce the minimum rear yard (east) setback of the RM-30 Zone from 7.5 metres (25 ft.) to 6.0 metres (20 ft.) to the building face and to 5.0 metres (16.5 ft.) to the roof overhang of Building 4, and to 3.0 metres (10 ft.) to the building face of the east townhouse unit in Building 5 and to 2.5 metres (8 ft.) to the building face of the electrical room and to 1.5 metres (5 ft.) to the electrical room roof overhang of Building 5;
  - (c) To reduce the minimum north side yard setback of the RM-30 Zone from 7.5 metres (25 ft.) to 4.0 metres (13 ft.) to the building face and to 3.0 metres (10 ft.) to the roof overhangs of Buildings 1 and 5;


- (d) To reduce the minimum south side yard setback of the RM-30 Zone from 7.5 metres (25 ft.) to 5.5 metres (18 ft.) to the building face and to 5.0 metres (16.5 ft.) to the roof overhangs of Buildings 3 and 4; and
- (e) To increase the maximum permitted building height of the RM-30 Zone from 13 metres (42.5 ft.) to 13.5 metres (43.5 ft.) for Building 4 only.
- 4. This development variance permit applies to only the buildings and structures on the Land shown on Schedule A, which is attached hereto and forms part of this development variance permit.
- 5. The Land shall be developed strictly in accordance with the terms and conditions and provisions of this development variance permit.
- 6. This development variance permit shall lapse if the Owner does not substantially start any construction with respect to which this development variance permit is issued, within two (2) years after the date this development variance permit is issued.
- 7. The terms of this development variance permit or any amendment to it, are binding on all persons who acquire an interest in the Land.
- 8. This development variance permit is not a building permit.

AUTHORIZING	FRESOLUTION	PASSED BY THE	COUNCIL, THE	DAY OF	, 20 .
ISSUED THIS	DAY OF	, 20 .			
		,			
			Mayor - Linda	Hepner	
			,	1	

City Clerk - Jane Sullivan

#### Setback relaxations shown in red

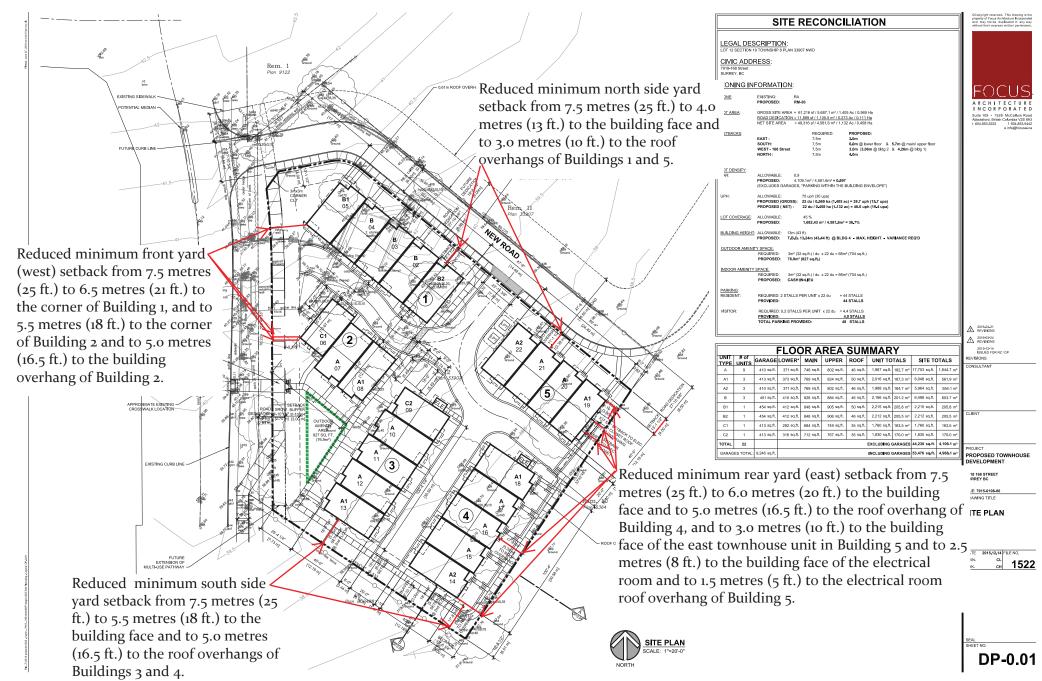

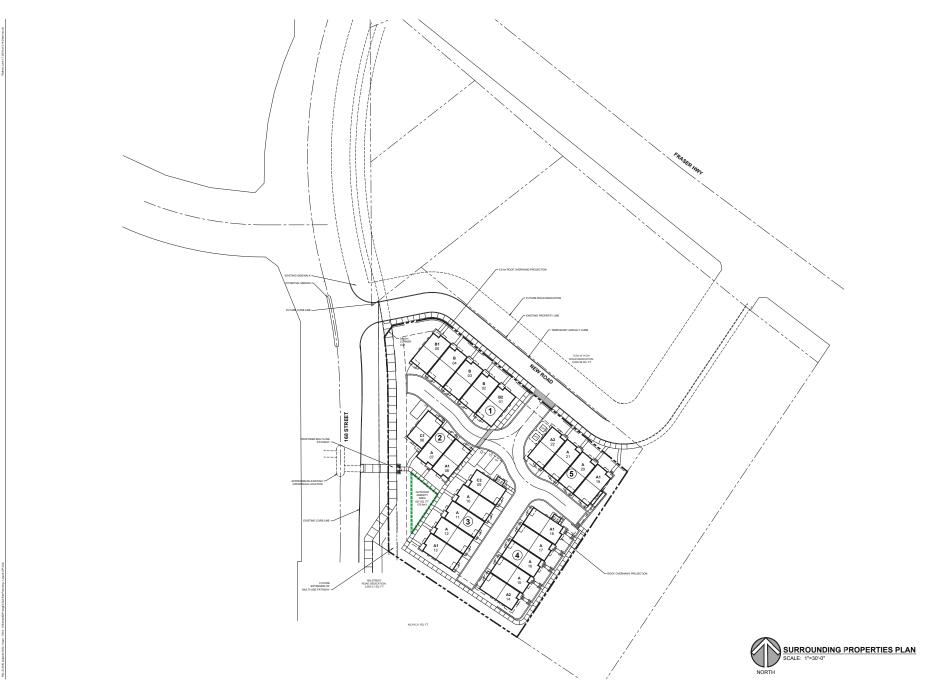

↑ 2016-04-21

↑ REVISIONS

↑ 2016-03-24

REVISIONS

↑ SULL TA\*\*\*

PROJECT
PROPOSED TOWNHOUSE
DEVELOPMENT


7918 168 STREET SURREY BC

SURREY FILE No. 7915-0108-00 DRAWING TITLE

SURROUNDING PROPERTIES PLAN

DATE 2015.12.14 FILE NO.
DWN. CL
CHK CH 1522

DP-0. pp

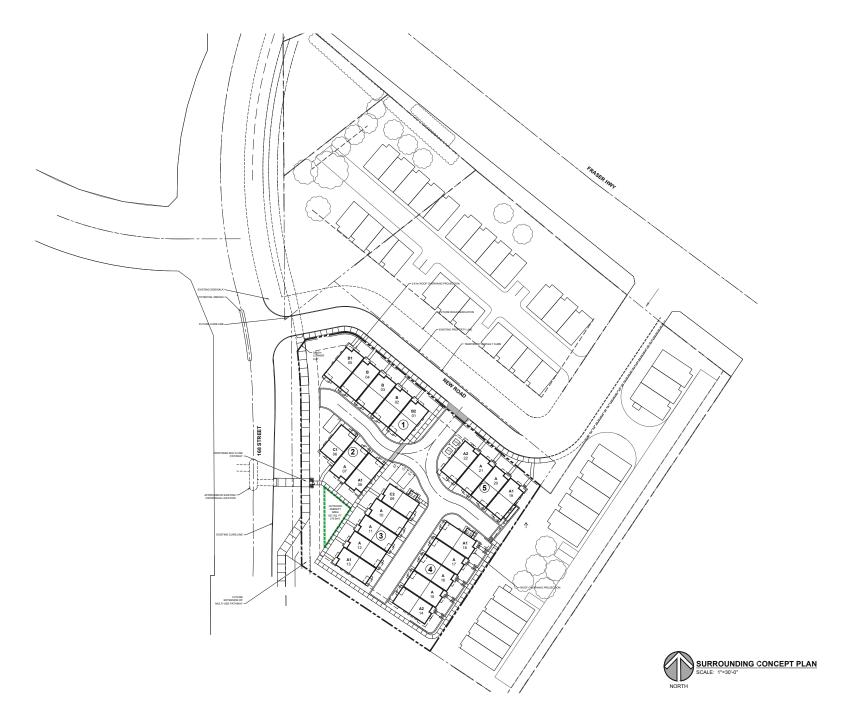

A R C H I T E C T U R E I N C O R P O R A T E D Suite 109 - 1528 McCallum Road Abbotsford, British Columbia V25 8A3 1 604.853.5222 f 604.853.542 e info@focusal.ca

2016-04-21
REVISIONS
2016-03-24
REVISIONS
2015-12-14
ISSUED FOR RZ / DP
REVISIONS

PROJECT
PROPOSED TOWNHOUSE
DEVELOPMENT

7918 168 STREET SURREY BC

SURREY FILE No. 7915-0108-00 DRAWING TITLE

SURROUNDING CONCEPT PLAN

DATE 2015.12.14 FILE NO. CL 1522

**DP-0.0d** 

