

City of Surrey PLANNING & DEVELOPMENT REPORT File: 7915-0087-00

Planning Report Date: February 1, 2016

PROPOSAL:

- NCP Amendment
- **Rezoning** from RA to RM-30
- Development Permit
- Development Variance Permit

to permit the development of approximately 66 townhouse units.


LOCATION: 2215 - 164 Street

OWNER: Pamela and William Bray

ZONING: RA
OCP DESIGNATION: Urban

NCP DESIGNATION: Multiple Residential 15-25 upa &

Cluster Residential 10-15 upa

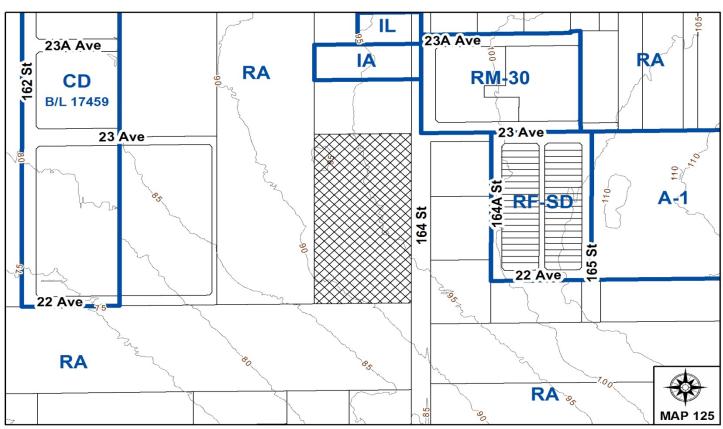

RECOMMENDATION SUMMARY

- By-law Introduction and set date for Public Hearing for rezoning.
- Approval to eliminate indoor amenity space.
- Approval to draft Development Permit.
- Approval for Development Variance Permit to proceed to Public Notification.

DEVIATION FROM PLANS, POLICIES OR REGULATIONS

- The applicant is proposing an NCP amendment from "Cluster Housing 10-15 upa" to "Multiple Residential 15-25 upa" for a portion of the site, and to delete an east-west flex road through the site and the associated drainage corridor.
- The applicant is proposing to eliminate the required indoor amenity space on the subject site.
- The applicant is proposing a Development Variance Permit to reduce setbacks.

RATIONALE OF RECOMMENDATION

- The proposal complies with the site's OCP Designation.
- The proposed development partially complies with the Biodiversity Conservation Strategy Green Infrastructure Network objectives by conserving a 5 metre (16 feet) wide BCS corridor and 10 metre (33 feet) wide dedication for the Grandview Ridge Trail on the southern portion of the site. The combined 15 metre (50 feet) wide dedicated area accounts for 75% of the target GIN area which is considered acceptable.
- The proposed NCP amendment is for a small portion of the site in the southeast corner. This portion of the site was anticipated to be consolidated with the 164 Street road allowance and the parcels to the east. However, 164 Street is no longer proposed to be closed and disposed of, and as such the cluster designation is less applicable as the assembly proposed in the NCP will not be achieved. The applicant is proposing to retain 3 significant trees in this portion of the site, and is also proposing to convey a 5 metre (16 feet) wide BCS corridor and a 10 metre (33 feet) wide corridor for the Grandview Ridge Trail on this portion of the site.
- Despite the proposed elimination of the east-west flex road, the applicant's proposal still provides a reasonable level of connectivity in the area, and drainage will be addressed on-site. In addition, to enhance neighbourhood connectivity, the applicant is providing a significant 10 metre (33 feet) wide dedication along the southern portion of the site for the Grandview Ridge Trail.

• The proposed elimination of indoor amenity space on the subject site is supportable given the applicant's proposal that the indoor amenity space on the neighbouring project to the west (16330 – 24 Avenue; Application No. 7914-0257-00 at 3rd Reading), which is being developed by the same applicant, be shared between the two sites. The shared indoor amenity space arrangement will be secured via a shared access and maintenance easement. The applicant is proposing to address the shortfall in indoor amenity space on the subject site with a cash-in-lieu contribution in accordance with City policy.

- The proposed setbacks achieve a more urban, pedestrian streetscape, and are generally consistent with the setbacks proposed in the townhouse development to the west (Application No. 7914-0257-00), which is currently at 3rd Reading.
- The proposed density and building form are appropriate for this part of Sunnyside Heights.

RECOMMENDATION

The Planning & Development Department recommends that:

- 1. a By-law be introduced to rezone the subject site from "One-Acre Residential Zone (RA)" (By-law No. 12000) to "Multiple Residential 30 Zone (RM-30)" and a date be set for Public Hearing.
- 2. Council approve the applicant's request to eliminate the required indoor amenity space (ie. 198 square metres/2,130 square feet) on the subject site.
- 3. Council authorize staff to draft Development Permit No. 7915-0087-00 generally in accordance with the attached drawings (Appendix II).
- 4. Council approve Development Variance Permit No. 7915-0087-00 (Appendix VII) varying the following, to proceed to Public Notification:
 - reduce the minimum northerly setback of the RM-30 Zone from 7.5 metres (25 feet) to 4.5 metres (15 feet) along 23 Avenue;
 - (b) reduce the minimum easterly setback of the RM-30 Zone from 7.5 metres (25 feet) to 4.5 metres (15 feet) along the proposed new 164 Street alignment and to 3.7 metres (12 feet) along the existing 164 Street alignment;
 - (c) reduce the minimum southerly setback of the RM-30 Zone from 7.5 metres (25 feet) to 3.0 metres (10 feet); and
 - (d) reduce the minimum westerly setback of the RM-30 Zone from 7.5 metres (25 feet) to 6.0 metres (20 feet) for proposed Buildings 6, 7 and 9, and to 4.5 metres (15 feet) for Building 11; and to 4.5 metres (15 feet) along the proposed new 164 Street alignment.
- 5. Council instruct staff to resolve the following issues prior to final adoption:
 - (a) ensure that all engineering requirements and issues including restrictive covenants, dedications, and rights-of-way where necessary, are addressed to the satisfaction of the General Manager, Engineering;
 - (b) submission of a subdivision layout to the satisfaction of the Approving Officer;
 - (c) submission of a finalized tree survey and a statement regarding tree preservation to the satisfaction of the City Landscape Architect;
 - (d) submission of a landscaping plan and landscaping cost estimate to the specifications and satisfaction of the Planning and Development Department;
 - (e) demolition of existing buildings and structures to the satisfaction of the Planning and Development Department;

(f) registration of a Section 219 Restrictive Covenant to adequately address the City's needs with respect to public art, to the satisfaction of the General Manager Parks, Recreation and Culture;

- (g) registration of a shared access and maintenance easement between the subject site and 16330 24 Avenue (File No. 7914-0257-00) for shared use of the proposed indoor amenity building located at 16330 24 Avenue; and
- (h) the applicant adequately address the impact of no indoor amenity space.
- 6. Council pass a resolution to amend the Sunnyside Heights NCP to redesignate a portion of the site from "Cluster Housing 10-15 upa" to "Multiple Residential 15-25 upa", and to delete the east-west flex road through the site and the associated drainage corridor, when the project is considered for final adoption.

REFERRALS

Engineering: The Engineering Department has no objection to the project

subject to the completion of Engineering servicing requirements as

outlined in Appendix III.

School District: **Projected number of students from this development:**

13 Elementary students at Pacific Heights Elementary School 7 Secondary students at Earl Marriott Secondary School

(Appendix IV)

The applicant has advised that the dwelling units in this project are

expected to be constructed and ready for occupancy by 2017.

Parks, Recreation &

Culture:

No concerns.

Surrey Fire Department: No concerns.

SITE CHARACTERISTICS

<u>Existing Land Use:</u> Single family residential acreage with some outbuildings.

Adjacent Area:

Direction	Existing Use	OCP/NCP	Existing Zone
		Designation	
North	Vacant site, with an application	Urban/ Multiple	RA
(Across 23 Avenue):	for townhouses at 3 rd Reading	Residential 15-25 upa	
	(File No. 7912-0224-00).		
East	Three single family residential	Urban/ Cluster	RA
(Across 164 Street):	acreages, with an application for townhouses at 3 rd Reading (File	Residential 10-15 upa	
	No. 7915-0031-00) on two of the		
	parcels. The third parcel is		
	vacant.		
South	Large single family acreage with	Urban/ Multiple	RA
(Across 22 Avenue):	some farming activities.	Residential 15-25 upa	
West:	Single family residential acreage	Urban/ Multiple	RA
	with some outbuildings, with an	Residential 15-25 upa	
	application for townhouses at 3 rd		
	Reading (File No. 7914-0257-00).		

JUSTIFICATION FOR PLAN AMENDMENT

- The applicant is proposing a Neighbourhood Concept Plan (NCP) amendment from "Cluster Housing 10-15 upa" to "Multiple Residential 15-25 upa" for a portion of the site, and to delete an east-west flex road through the site and the associated drainage corridor.
- The applicant's proposed NCP designation amendment is for a small portion of the site in the southeast corner. This portion of the site was anticipated to be consolidated with the 164 Street road allowance and the parcels to the east. However, 164 Street is no longer proposed to be closed and disposed of, and thus the cluster designation is less applicable as the assembly proposed in the NCP will not be achieved. The applicant is proposing to retain 3 significant trees in this portion of the site, and is also proposing to convey a 5 metre (16 feet) wide BCS corridor and a 10 metre (33 feet) wide corridor for the Grandview Ridge Trail on this portion of the site.
- The applicant's proposal to delete an east-west flex road through the site and the associated drainage corridor reflects a similar NCP amendment (Application No. 7915-0087-00, at 3rd Reading) proposed on the property to the west (16330 24 Avenue), which is also owned by the applicant.
- Despite the proposed elimination of the east-west flex road, the applicant's proposal provides a reasonable level of connectivity in the area, and drainage will be addressed on-site. In addition, the applicant is providing a 10-metre (33-foot) wide dedication along the southern boundary of the site for the Grandview Ridge Trail, which will provide additional neighbourhood connectivity.
- No concerns were expressed by residents in the vicinity regarding the proposed NCP amendment and rezoning.

DEVELOPMENT CONSIDERATIONS

- The subject 2.0 hectare (5.0 acre) site consists of one parcel located in the Sunnyside Heights NCP at 2215 164 Street. The site is zoned "One-Acre Residential Zone" (RA) and is designated "Urban" in the Official Community Plan (OCP) and "Multiple Residential 15-25 upa" and "Cluster Residential 10-15 upa" in the Sunnyside Heights NCP.
- The applicant is proposing:
 - o an NCP amendment from "Cluster Housing 10-15 upa" to "Multiple Residential 15-25 upa" for a small portion of the site, and to delete the east-west flex road through the site and the associated drainage corridor;
 - o to rezone the site from "One-Acre Residential Zone" (RA) to "Multiple Residential 30 Zone" (RM-30); and
 - a Development Permit to allow the development of 66 townhouse units. A
 Development Variance Permit to reduce building setbacks is also proposed as part of
 the proposal.
- A subdivision plan is required as the proposed realignment for 164 Street will bisect the site. Sixty (60) townhouse units are proposed on the west side of the proposed new 164 Street alignment with 6 townhouse units proposed on the east side. The parcel will be a "hooked" lot, however with one strata for all 66 proposed townhouse units. The applicant is also conveying a 10-metre (30 feet) wide corridor for the Grandview Ridge Trail and a 5-metre (16 feet) wide Biodiversity Conservation Strategy (BCS) corridor along the southern portion of the site adjacent to 22 Avenue.

TREES

 Max Rathburn, ISA Certified Arborist of Diamond Head Consulting Ltd. prepared an Arborist Assessment for the subject property. The table below provides a summary of the tree retention and removal by tree species:

Table 1: Summary of Tree Preservation by Tree Species:

Tree Species	Existing	Remove	Retain			
Alde	Alder and Cottonwood Trees					
Alder	53	53	0			
	Deciduous Tree					
(excludin	g Alder and Cotton	wood Trees)				
Cascara	2	2	0			
Cherry/Plum	1	1	0			
Maple (Bigleaf)	9	9	О			
Paper Birch	34	34	О			
Pacific Dogwood	1	1	0			
	Coniferous Tree	es				
Western Redcedar	3	3	0			
Deodar cedar	1	0	1			
Western Hemlock	2	2	0			

Tree Species	Exis	ting	Remove	Retain
Douglas-fir	3	1	26	5
Monkey puzzle	2	2	0	2
Total (excluding Alder and Cottonwood Trees)	86		78	8
Total Replacement Trees Proposed (excluding Boulevard Street Trees)			209	
Total Retained and Replacement Trees			217	

- The Arborist Assessment states that there are a total of 86 mature trees on the site, excluding Alder and Cottonwood trees. Fifty-three (53) existing trees, approximately 38% of the total trees on the site, are Alder and Cottonwood trees. It was determined that 8 trees can be retained as part of this development proposal. The proposed tree retention was assessed taking into consideration the location of services, building footprints, road dedication and proposed lot grading.
- For those trees that cannot be retained, the applicant will be required to plant trees on a 1 to 1 replacement ratio for Alder and Cottonwood trees, and a 2 to 1 replacement ratio for all other trees. This will require a total of 209 replacement trees on the site. The applicant is proposing 209 replacement trees, meeting City requirements.
- The new trees on the site will consist of a variety of trees including maple, beech, pine, Douglas-fir, Katsura and cypress.
- In summary, a total of 217 trees are proposed to be retained or replaced on the site.

BIODIVERSITY CONSERVATION STRATEGY

- The City of Surrey Biodiversity Conservation Strategy (BCS) Green Infrastructure Network (GIN) map, adopted by Council on July 21, 2014 (Corporate Report No. R141; 2014), identifies a Local BCS Corridor within the southern portion of the subject site, in the Redwood BCS management area, with a Low ecological value.
- The BCS further identifies the GIN area of the subject site as having a Low habitat suitability rating, derived from species at risk presence, species accounts and known ecosystem habitat inventories. The BCS recommends a target Corridor width of 20 metres (66 feet) and target area of 2,050 square metres (0.51 acre), which is 10% of the subject property.

Protecting green infrastructure Hubs (large habitat areas) and Sites (smaller habitat areas) are critical to preserving natural habitat refuges and a diversity of habitat features while maintaining/enhancing Corridors ensures connectivity between fragmented hubs for genetic variation throughout the City. The closest Biodiversity Hub connection in the GIN to the subject site is Hub F, and is located in an area roughly bounded by 16 Avenue, 168 Street, 8 Avenue and Highway 99, centered on the Fergus Watershed Biodiversity Preserve. The BCS Management Area Objectives that the proposed corridor dedication helps to achieve are:

- o increased landscape permeability (amount of natural and semi-natural habitat) on public and private land; and
- o increased tree canopy cover.
- The development proposal conserves a 5-metre (16-foot) wide BCS corridor dedication and a 10-metre (33 feet) wide dedication for the Grandview Ridge Trail on the southern portion of the site. The combined 15 metre (50 feet) wide dedicated area is 1,540 square metres (0.38 acre) or 7.6% of the total gross area of subject site, or 75% of the target GIN area, which is considered acceptable.
- In order for the proposal to fully comply with the BCS target recommendations, an additional 510 square metres (0.13 acre) of the GIN area would be required on the subject site.
- The proposed parkland and trail dedication will assist in the long term protection of the natural features and allows the City to better achieve biodiversity at this location consistent with the guidelines contained in the BCS.

DESIGN PROPOSAL AND REVIEW

- The proposed development contains 66 three-storey and partial three-storey townhouse units that are contained within 13 buildings. All of the units are proposed to have side-by-side double-car garages. No tandem parking unit types are proposed.
- All of the street-fronting units contain active living space on the ground floor which will
 promote interaction with the public realm. These units have entries facing the street, a
 walkway connecting each residence to the street, and windows that provide casual
 surveillance of the street.
- The number of units within individual buildings ranges from two to eight units. Units range in size from 154 square metres (1,660 square feet) to 226 square metres (2,430 square feet), excluding the garage area.
- The proposed exterior materials include fibre cement siding (grey, green, blue, off-white or red colour), wood trim (dark grey or off-white) and stained natural wood siding, and some vinyl on interior elevations. Articulation is provided along the elevations, including various projections that add to the visual interest of the facades.
- The applicant is proposing roof decks for each unit which will provide significant private outdoor amenity space for the residents.

Amenity Space

- The Zoning By-law requires that 198 square metres (2,130 square feet) of indoor amenity area and 198 square metres (2,130 square feet) of outdoor amenity area be provided for this project, based on 3 square metres (32 square feet) per dwelling unit.
- The applicant is proposing not to provide any indoor amenity space on the subject site, but rather to provide a shared indoor amenity space on the neighbouring project to the west (16330 24 Avenue; Application No. 7914-0257-00 at 3rd Reading), which is being developed by the same applicant. The shared indoor amenity space arrangement will be secured via a shared access and maintenance easement. The applicant is proposing to address the shortfall in indoor amenity space on the subject site with a cash-in-lieu contribution in accordance with City policy.
- The applicant is proposing to provide approximately 375 square metres (4,040 square feet) of outdoor amenity space. The applicant is proposing children's play equipment, outdoor seating, lawn areas and retention of a large tree within the outdoor amenity area.

Access, Pedestrian Circulation and Parking

- Vehicular access to the site is proposed from 164 Street, which is proposed to be realigned to
 follow the NCP as part of this application. Street-fronting units are proposed to have
 individual pedestrian access to the street. The applicant is proposing a series of paths
 throughout the site, providing good pedestrian connectivity throughout the site and also to
 adjacent sidewalks and the Grandview Ridge Trail.
- The applicant is proposing to provide 132 resident parking spaces and 14 visitor parking spaces, which exceeds the minimum parking requirements of 13 visitor parking spaces in the Zoning By-law. The applicant is not proposing any tandem parking spaces.

Landscaping

- Landscaping plans have been received and found to be generally acceptable. The landscaping includes a mix of trees, shrubs, ground cover and open lawn areas. A corner plaza is proposed in the northeast corner of the site to enhance the public realm. The corner plaza will contain stamped concrete and benches. A 1 metre (3 feet) high wall signage identifying the name of the development is also located adjacent to both vehicular entries along 164 Street.
- A 1.1 metre (3.5 feet) high transparent aluminum picket fence with cultured stone posts is proposed along portions of the street frontage. The fence will be set back from the property line to allow for planting in front of the fence. Decorative scored and stamped concrete are proposed at the two vehicular entrances and pervious pavers are proposed for the visitor parking spaces.

ADVISORY DESIGN PANEL

The application was not referred to the ADP for review. The design and landscaping plans were reviewed by staff and found to be generally acceptable.

SUSTAINABLE DEVELOPMENT CHECKLIST

The applicant prepared and submitted a sustainable development checklist for the subject site on August 5, 2015. The table below summarizes the applicable development features of the proposal based on the seven (7) criteria listed in the Surrey Sustainable Development Checklist.

Sustainability	Sustainable Development Features Summary
Criteria	
1. Site Context &	• The site is located within the Sunnyside Heights NCP area.
Location	
(A1-A2)	
2. Density & Diversity (B1-B7)	• The proposal includes rooftop patio areas which may be used for gardening.
3. Ecology &	• Absorbent soils greater than 0.3 metres (1 foot) in depth, infiltration
Stewardship	trenches or sub-surface chambers, and natural landscaping (including
(C ₁ -C ₄)	climate-appropriate and drought tolerant plants).
	• The applicant is proposing to retain 8 on-site trees, and plant 209 replacement trees.
	Recycling pick-up will be made available.
4. Sustainable	• The site will be connected via walkways to surrounding sidewalks and
Transport &	the Grandview Ridge Trail. Pedestrian-specific lighting is proposed.
Mobility	Bike parking will be provided.
(D ₁ -D ₂)	Each unit will have a roughed-in electrical outlet for vehicle charging
	stations. A conduit will be extended to the visitor parking spaces for future charging stations.
5. Accessibility &	• Street-fronting townhouses will be oriented to the street, to provide
Safety	surveillance of the public realm.
(E1-E3)	• Playground equipment and an outdoor gathering area are proposed.
6. Green Certification	• n/a
(F ₁)	
7. Education &	Pre-notification to area residents occurred, in the form of a
Awareness	development proposal sign being erected on the property and pre-
(G1-G4)	notification letters being mailed out.

PRE-NOTIFICATION

Pre-notification letters were sent on August 10, 2015. To date, staff have received no correspondence or phone calls.

BY-LAW VARIANCE AND JUSTIFICATION

(a) Requested Variance:

• Reduce the minimum northerly setback of the RM-30 Zone from 7.5 metres (25 feet) to 4.5 metres (15 feet) along 23 Avenue.

Staff Comments:

- The proposed setback will bring the units closer to the street which will allow the units to better engage the street and enliven the public realm.
- The Sunnyside Heights NCP encourages reduced setbacks along streets to encourage surveillance over the public realm. Setbacks of 2.0 metres (7 feet) to porches and 4.0 metres (13 feet) to the front door of units are encouraged for street-fronting units.
- These setbacks are consistent with the setbacks approved in the proposed townhouse development to the west (Application No. 7914-0257-00), which is currently at 3rd Reading.

(b) Requested Variance:

• Reduce the minimum easterly setback of the RM-30 Zone from 7.5 metres (25 feet) to 4.5 metres (15 feet) along the proposed new 164 Street alignment and to 3.7 metres (12 feet) along the existing 164 Street alignment.

Staff Comments:

- The proposed setback will bring the units closer to the proposed 164 Street alignment which will allow the units to better engage the street and enliven the public realm.
- The Sunnyside Heights NCP encourages reduced setbacks along streets to encourage surveillance over the public realm. Setbacks of 2.0 metres (7 feet) to porches and 4.0 metres (13 feet) to the front door of units are encouraged for street-fronting units.
- The proposed setback along the existing 164 Street alignment is a side yard condition as this portion of 164 Street is to remain an unopened, vegetated road allowance containing a small riparian area on the eastern portion of the road allowance.

(c) Requested Variance:

• Reduce the minimum southerly setback of the RM-30 Zone from 7.5 metres (25 feet) to 3.0 metres (10 feet).

Staff Comments:

• The applicant is proposing a substantial 15 metre (50 feet) wide dedication for the purposes of providing a 10 metre (33 feet) wide Grandview Ridge Trail greenway and a 5 metre (16 feet) BCS corridor.

• The townhouse units' interface will be with the 10-metre (33 feet) wide greenway and the 5 metre (16 feet) wide BCS corridor, as such the proposed townhouse units will be set much farther back from the street than the typical setback. A 3 metre (10 feet) setback allows for some separation of the private and public realms, but still allows the buildings to engage the adjacent public realm.

• These setbacks are consistent with the setbacks approved in the proposed townhouse development to the west (Application No. 7914-0257-00), which is currently at 3rd Reading.

(d) Requested Variance:

- Reduce the minimum westerly setback of the RM-30 Zone from 7.5 metres (25 feet) to 6.0 metres (20 feet) for proposed Buildings 6, 7 and 9, and to 4.5 metres (15 feet) for Building 11, and to 4.5 metres (15 feet) along the proposed new 164 Street alignment. Staff Comments:
- The proposed 6.0 metre (20 feet) setback from the adjacent parcel to the west matches the 6.0 metre (20 feet) setback on that neighbouring parcel. The two sites are both being developed by the same applicant.
- The proposed 4.5 metre (15 feet) setback for Building 11 is a side yard condition and mirrors the side yard condition at this location on the neighbouring westerly parcel.
- The proposed setback along the proposed new 164 Street alignment will bring the units closer to the street which will allow the units to better engage the street and enliven the public realm.
- The Sunnyside Heights NCP encourages reduced setbacks along streets to encourage surveillance over the public realm. Setbacks of 2.0 metres (7 feet) to porches and 4.0 metres (13 feet) to the front door of units are encouraged for street-fronting units.

INFORMATION ATTACHED TO THIS REPORT

The following information is attached to this Report:

Appendix I. Lot Owners, Action Summary and Project Data Sheets

Appendix II. Proposed Site Plan, Building Elevations and Landscape Plans

Appendix III. Engineering Summary
Appendix IV. School District Comments

Appendix V. Summary of Tree Survey and Tree Preservation

Appendix VI. NCP Amendment Map

Appendix VII. Development Variance Permit No. 7915-0087-00

original signed by Ron Hintsche

Jean Lamontagne General Manager Planning and Development

DH/dk

\file-server1\net-data\csdc\generate\areaprod\save\3851268020.doc KD 1/28/16 12:16 PM

Information for City Clerk

Legal Description and Owners of all lots that form part of the application:

1. (a) Agent: Name: Rick Johal

Zenterra Developments Ltd.

Address: #216, 2630 Croydon Drive

Surrey, BC V₃Z 6T₃

Tel: 604-788-7975

2. Properties involved in the Application

(a) Civic Address: 2215 - 164 Street

(b) Civic Address: 2215 - 164 Street

Owner: William and Pamela Bray

PID: 011-101-831

Parcel "A" (H68728E) Lot 7 Section 13 Township 1 New Westminster District Plan 5524

- 3. Summary of Actions for City Clerk's Office
 - (a) Introduce a By-law to rezone the property.
 - (b) Proceed with Public Notification for Development Variance Permit No. 7915-0087-00 and bring the Development Variance Permit forward for an indication of support by Council. If supported, the Development Variance Permit will be brought forward for issuance and execution by the Mayor and City Clerk in conjunction with the final adoption of the associated Rezoning By-law.

DEVELOPMENT DATA SHEET

Proposed Zoning: RM-30

Required Development Data	Minimum Required / Maximum Allowed	Proposed
LOT AREA* (in square metres)		
Gross Total		20,197 sq.m.
Road Widening area		5,449 sq.m.
Grandview Ridge Trail and BCS corridor		1,158 sq.m.
Net Total		13,590 sq.m.
LOT COVERAGE (in % of net lot area)		
Buildings & Structures	45%	34%
Paved & Hard Surfaced Areas		
Total Site Coverage		
SETBACKS (in metres)		
North	7.5m	See report
South	7.5m	See report
East	7.5m	See report
West	7.5m	See report
BUILDING HEIGHT (in metres/storeys)		
Principal	13m	11.2m to 13.0m
Accessory		
NUMBER OF RESIDENTIAL UNITS		
Bachelor		
One Bed		
Two Bedroom		
Three Bedroom +		66
Total		
FLOOR AREA: Residential		11,710 sq.m.
FLOOR AREA: Commercial		
Retail		
Office		
Total		
FLOOR AREA: Industrial		
FLOOR AREA: Institutional		
TOTAL BUILDING FLOOR AREA		11,710 sq.m.

^{*} If the development site consists of more than one lot, lot dimensions pertain to the entire site.

Development Data Sheet cont'd

Required Development Data	Minimum Required / Maximum Allowed	Proposed
DENSITY		
# of units/ha /# units/acre (net)	75 uph/30 upa	49 uph/20 upa
FAR (net)	0.90	0.86
AMENITY SPACE (area in square metres)		
Indoor	198 sq.m.	0
Outdoor	198 sq.m.	375 sq.m.
PARKING (number of stalls)		
Commercial		
Industrial		
Residential Bachelor + 1 Bedroom		
2-Bed		
3-Bed	132	132
Residential Visitors	13	14
Institutional		
Total Number of Parking Spaces	145	146
Number of disabled stalls		
Number of small cars		
Tandem Parking Spaces: Number / % of Total Number of Units	33/50%	0
Size of Tandem Parking Spaces width/length		

Heritage Site	NO	Tree Survey/Assessment Provided	YES
---------------	----	---------------------------------	-----

CONTEXT AERIAL PHOTO



PROJECT DATA

CIVIC ADDRESS. 22/5 (645T, SURREY, BC) LEGAL DESCRIPTION: SECTION IS TOWNSHIP I PLAN 5524 NAO PARCEL A OF LOT 1, PART N V2 OF NH V4, PCL A (H68128E)

GROSS AREA 21T-bit 19 (20-216-1 m2) 5-500 K/RES (2.02 tW) ROAD RIDENIG-5-06-41 5F (544-0.5 m2) 1-35 K/RES (0.54 tW) PEDICATED AREA (GRANCYIEN RODE TRAIL & BOUNDERSOON) CONCERN ALL STATES (1.05 m2) 124-60 5F (1.05 m2) 0-28 ACRES (0.12 tW)

NET AREA: (46,446 SF (13,604.9 m2) 9.36 ACRES (1,36 HA)

BULDINOS: 4678.6 m2 (34.4%) PAVED/HARD SURFACE: 4065.0 m2 (30.0%) LOT COVERAGE.

TOTAL: 6,161.6 m2 (64.4%)

TOTAL = 66 UNITS

BUILDING SETBACKS:

IA.16 FT (A5m) / I2.14 FT (3.7m)
IA.16 FT (A5m) / I2.14 FT (3.7m)
IA.17 FT (6.7m) / IA.16 FT (45m)
SHOS FT (16.0m)
ORANDYSEN RIDGE TRAIL I
IG.4 FT (5.0m) BIODIVESTITY
CONSERVATION STIDT CORRIDOR

BULDING HEIGHT: VARIES - SEE MATTIFLE BLDGG, DATA SHEETS

DENSITY - NET: HLB UNITS/ACRE (46.5 UNITS/ HA) - 6R095- IB-2 UNITS/ACRE (82.1 UNITS/ HA)

126,045 SF (11,104,5 mg)

RESIDENT PARKING: 2.0/LNIT = 192 SPACES VISITOR PARKING: 0.2/LNIT = 19 SPACES

TOTAL - 145 SPACES REQUIRED, 146 PROVIDED

DRAWING LIST

A-0.0 COVER SHEET, CONTEXT ASKIAL PHOTO, PROJECT DATA
A-1.0 CONTEXT SITE RIVAN
A-1.2 PREPRIENTING ACCESS SITE PLAN
A-1.3 PREPRIENTING ACCESS SITE PLAN
A-1.4 SITE SECTIONS
A-1.4 SITE SECTIONS

LANDSCAPE.

LANDSCAPE SITE PLAN
LANDSCAPE PLAN NORTH
LANDSCAPE PLAN SOUTH
FENCE LATOUT
LANDSCAPE DETAILS
LANDSCAPE DETAILS I MAGES
SOFT LANDSCAPE SETCIFICATIONS

ISBULTEVSION MEETING WITH PLANNING DEPT MEETING WITH PLANNING DEPT.
MEETING WITH PLANNING DEPT.
APPLICATION FOR REZONING
REVISED & REISSUED
APPLICATION FOR REZONING &
DEVELOPMENT PERMIT

DEVELOPMENT PERMIT
REVISED & REISSUED
APPLICATION FOR REZONING &
DEVELOPMENT PERMIT
REVISED & REISSUED
APPLICATION FOR REZONING &
DEVELOPMENT PERMIT

BERNARD DECOSSE ARCHITECT INC.

113 - 116 West Persier St. Vencouver, SC, V68 156 Tel 604 962 3301 Fav 604 667 1338 6:Mell integligement on

PROJECT TITLE

MULTI-FAMILY RESIDENTIAL DEVELOPMENT 2215 164TH STREET SURREY, BC


SHIRTTIME

PROJECT DATA DRAWING LIST CONTEXT AERIAL PHOTO

PROJECT NO. START DATE SCALE

REVISION NO.

A-0.0

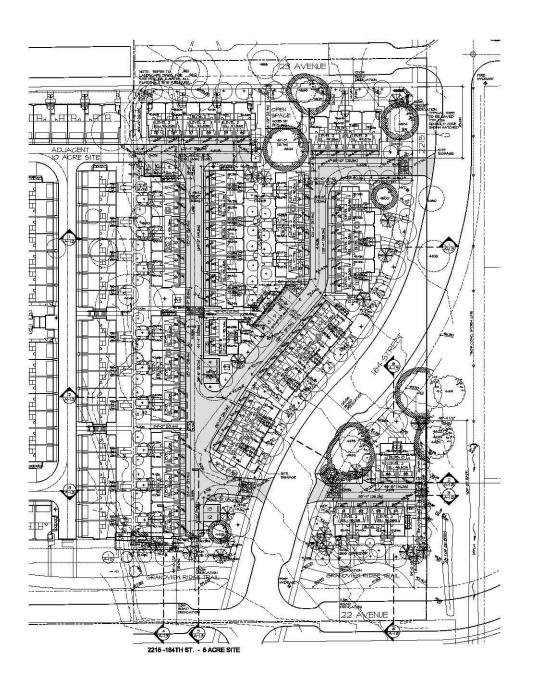


BERNARD DECOSSE ARCHITECT INC.

MULTI-FAMILY RESIDENTIAL DEVELOPMENT 2215 164TH STREET SURREY, BC

CHET TIME

5 ACRE SITE PLAN



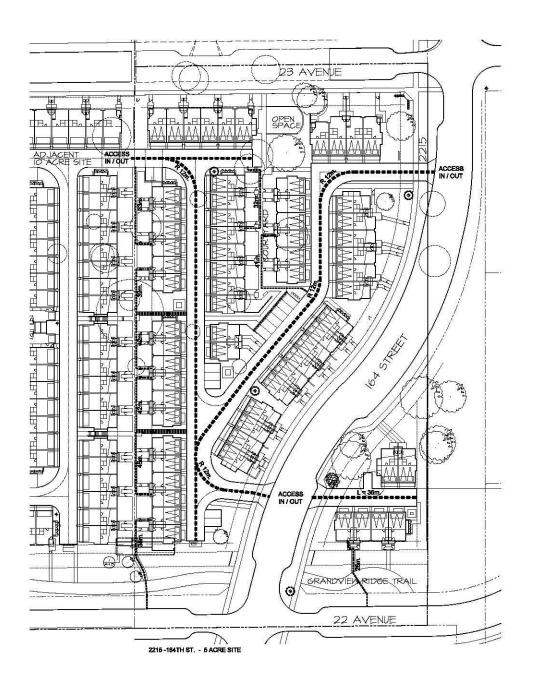


BERNARD DECOSSE ARCHITECT INC.


MULTI-FAMILY RESIDENTIAL DEVELOPMENT 2215 164TH STREET SURREY, BC


CHET TIME

FIREFIGHTING ACCESS SITE PLAN



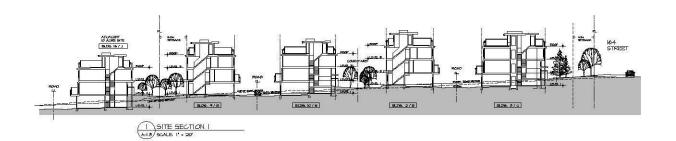

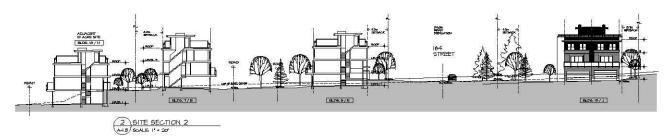

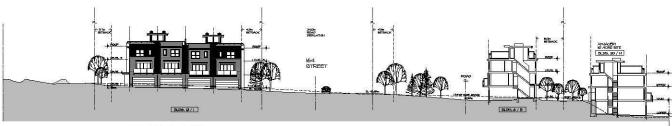





- 254

The contribution that it has a serious.

The contribution that it has a serious and all contributions, creating and the contribution of the contri

Th USUMEWHICH

12/25/14 NEETING WITH PLANNING IS 10/10/14 MEETING WITH PLANNING IS 20/8/18 APPLICATION FOR REZONS 34/07/16 REVISION & RESONAND OR REZONS ADD INTERNAL FOR DEPONDENT

1899/16 REVELOPMENT PERMIT
1899/16 REVELOPMENT PERMIT
APPLICATION FOR REZONMAS &
DEVELOPMENT PERMIT

DOWNLOWS PRODUCT OF THE PROPERTY OF THE PROPER

ryskem militar.

BERNARD DECOSSE ARCHITECT INC.

115-110 West Pender St. Vermanner, SCI, VSE 16 The 604 SEC 15501 Pag 604 SET 1516 B-Med Info@belock.co

PARCET TIME.

MULTI-FAMILY RESIDENTIAL DEVELOPMENT 2215 164TH STREET SURREY, BC


OHET TIME

SITE SECTIONS

PROJECT NO. 14-341
START DATE APPEL 2014
SCALE 1"= 80"

REVISION NO.

A-1.3

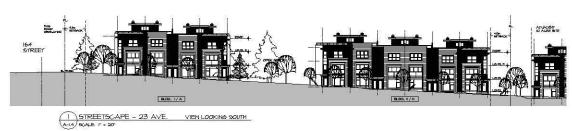





2 STREETSCAPE - 164 STREET VIEW LOOKING MEST



3 STREETSCAPE - WEST PROPERTY LINE VIEW LOOKING BAST



4 STREETSCAPE - 22 AVE. VIEW LOOKING NORTH GALB. I' = 20'


BERNARD DECOSSE ARCHITECT INC.


MULTI-FAMILY RESIDENTIAL DEVELOPMENT 2215 164TH STREET SURREY, BC

OPET TIME


STREETSCAPES

PROJECT NO.:	14-241
START DATE	APRIL 2014
SCALE:	1"-20"
REVISION NO.:	

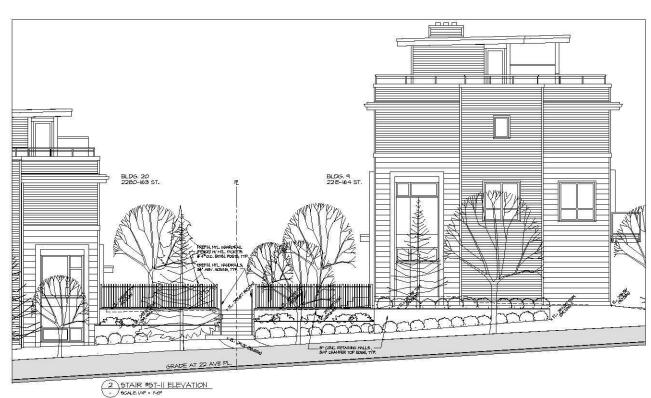


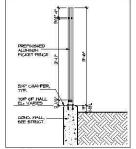

4 GUARDRAIL DETAIL - SCALE, I' = 1'-0'

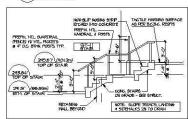

3 STAIR #ST-II SECTION - 9CALE:1/4" = 1'-0"

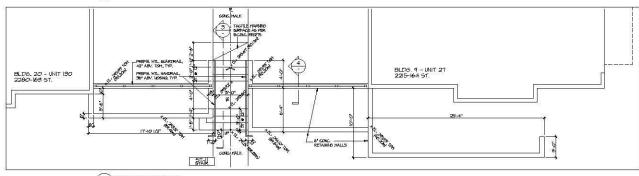

PLAN STAIR #5T-II

BERNARD DECOSSE ARCHITECT INC.

MULTI-FAMILY RESIDENTIAL DEVELOPMENT 2215 164TH STREET SURREY, BC

OPET TIME

STAIR NO. 11
PLAN, ELEVATION &
SECTION DETAILS

APRIL 2014 14" - 1'-0"





DOUBLE GARAGE UNIT FRONT ELEVATION



FLEX UNIT FRONT ELEVATION



DOUBLE GARAGE UNIT END ELEVATION



FLEX UNIT END ELEVATION



- HEER-CEPENT BOARD HORZ'L SIDING SHOOTH (4" EXPOSURE) PAINTED
- TEXTURED (ID 3/4" EXPOSURE) PAINTED
- HEER-CENERT BOARD PANEL NV REGLETS
 GOLDUR TO HATCH PANELS
- HORZL VINT, SIDING (4' EXPOSURE)
 V-JOINT MODO SOFFIT STAINED
 HODOP FACILAS & MATESTABLES PAINTED
 HODOP PAGILAS & MATESTABLES PAINTED
 SOLID CORE MODO DOOR STAINED
- (*) INSULATED FIBRESLASS DOOR PAINTED (*) VINTL FRANCE SLEING DOORS (*) VINTL FRANCE WINDOWS MY HOOD TRIM
- - - PREFINISHED METAL FLASHING PREFINISHED METAL GLADDING
 - (9) METHICAEU MEI AL CLADUNIO

 9) PREFINISED META, PICCET RAILING

 (5) TRU MALL PLACHING COLORE TO MATCH PIELD COLORE.

 9) PREFINISED META, GUARDRAIL W SAFETY GLASS

 (7) FREFINISED CATRIEAD GARAGE DOOR



SITE KEY

CONSULTANT:




MULTI-FAMILY RESIDENTIAL DEVELOPMENT 2215 164TH STREET SURREY, BC


ees me

TYPE'A' **BUILDING ELEVATIONS BUILDING 1**

APRIL 2014 185-1-01

A-4.1

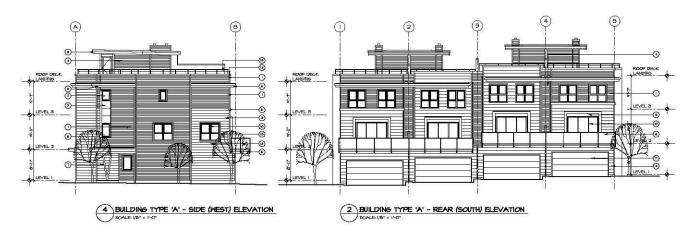

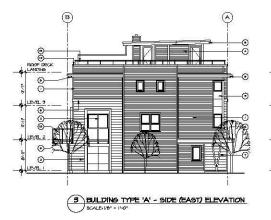





- FIDER-GEMENT BOARD HORZ'L SIDING SHOOTH (4" EXPOSURE) PAINTED
- FIDER-GEHENT BOARD HORZ'L SIDING TEXTURED (IO 9/4" EXPOSURE) PAINTED
- FIBER-CEMENT BOARD PANEL NV REGLETS COLOUR TO MATCH PANELS
- COLOR TO MATCH PARELS

 (*) HORZI, VINT, SIRINE (*P EXPOSURE)

 (*) V-JORY MODD SOFFIT STAINED

 (*) MODD FASCIAS & MATERTABLES PAINTED

 (*) HODD FORTS & BEATH STAINED

 (*) SOLID CORE HODD DOOR STAINED
- (1) INSULATED FIBRESLASS DOOR PAINTED (9) VIN'L FRAMED SLIDING DOORS





SCALE: 1/8" = 1-0"



SITE KEY



BERNARD DECOSSE ARCHITECT INC.

MULTI-FAMILY RESIDENTIAL DEVELOPMENT 2215 164TH STREET SURREY, BC

ees me

TYPE B' BUILDING ELEVATIONS BUILDINGS 2, 6, 7 & 9

PROJECT NO.:	14-241
START DATE	APRIL 2014
SCALE:	185-1-01



MATERIAL KEY

(i) FIBER-GEMENT BOARD HORZ'L SIDING SHOOTH (4" EXPOSURE) - PAINTED (2) FIBER-CEMENT BOARD HORZI, SIDING TEXTURED (10 SY4" EXPOSURE) - PAINTED

FIBER-CENTENT BOARD PANEL NV REGLETS COLOUR TO MATCH PANELS

(1) INSULATED FIBRESLASS DOOR - PAINTED (2) VNYL FRAHED SLIDING DOORS

VINT. PRAHED MINDONS IV HOOD TRIH PREFINSHED METAL FLASHING PREFINSHED HETAL CLADDING



2 BUILDING TYPE 'C' - REAR (NEST) ELEVATION

4 BUILDING TYPE C' - SIDE (NORTH) ELEVATION

SCALE, V8" = 1"-0"



SITE KEY

BERNARD DECOSSE ARCHITECT INC.

MULTI-FAMILY RESIDENTIAL DEVELOPMENT 2215 164TH STREET SURREY, BC

ees me

TYPE 'C' BUILDING ELEVATIONS **BUILDING 3**

APRIL 2014 185-1-01



- (1) FBER-CE-HENT BOARD HORZL SIDING SHOOTH (4" EXPOSURE) PAINTED
 (2) FBER-CE-HENT BOARD HORZL SIDING TEXTURED (10 3/4" EXPOSURE) PAINTED
- (8) PERRY-CENTRAL BOARD PANEL NV REGLETS COLOUR TO HATCH PANELS
- COLOR TO NATCH PARSES

 (4) HORSEL VINTE SIGNING (4* BEPTOSURE)

 (5) V-JOINT HOOD SOFFIT STAINED

 (6) HOOD FASCLAS (4 PATTERTABLES PAINTED

 (7) HOOD POSTS (8 BEAN STAINED

 (8) BOLID CORE HOOD DOOR STAINED
- (INSULATED FIBRESLASS DOOR PAINTED (I) VINTL FRAHED SLIDING DOORS (II) VINYL FRAHED WINDOWS W MOOD TRIM
- VINTL FRAHED SLIDING DOORS VINYL FRAHED WINDONS NV MOOD TRIH

- O VINTE-POWER DETAL FLASHING
 PREPRINCED VETAL FLASHING
 PREPRINCED VETAL FLASHING
 PREPRINCED VETAL CLASSING
 PREPRINCED VETAL FLASHING
 PREPRINCED VETAL FLASHING
 PREPRINCED DETAL PLASHING
 PREPRINCED DETAL PLASHING
 PREPRINCED OVERVEAD GARAGE DOOR



SITE KEY

CONSULTANT:



MULTI-FAMILY RESIDENTIAL DEVELOPMENT 2215 164TH STREET SURREY, BC

ees me

TYPE 'D' BUILDING ELEVATIONS **BUILDING 4**

APRIL 2014 185-1-01



2

1

<u>@</u>-

ROOF DECK LANDING

LEVEL I

ROOF DECK



- (i) INSULATED FIBREGLASS DOOR PAIRTED
 (ii) VINYL FRAHED SLIDING DOORS
 (ii) VINYL FRAHED MINDONS IV MOCO TRIM

- (1) VINT. HAVED MICCINS IV NEOD THIN
 (3) PREIMINGED METAL FLASHING
 (5) PREPARED METAL CLADDING
 (6) THEN MALL FLASHING FOR MAICH FELD COLOR.
 (6) THEN MALL FLASHING COLOR. TO NATCH FIELD COLOR.
 (7) PREPARED DETAL MARKADAL IV SAFETY GLASS
 (7) PREPARED DETAL MARKADAL IV SAFETY GLASS
 (7) PREPARED DETAL MARKADAL IV SAFETY GLASS
 (7)



SITE KEY

CONSULTANT:

BERNARD DECOSSE


ARCHITECT INC.

MULTI-FAMILY RESIDENTIAL DEVELOPMENT 2215 164TH STREET SURREY, BC

ees me

TYPE E **BUILDING ELEVATIONS BUILDING 5**

> APRIL 2014 185-1-01

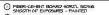

- TEXTURED (10 3/4" EXPOSURE) PAINTED

- TEXTURED (ID 3/4" BOYGURE) PARITED

 PERSONERS BOADED FAMILITY RESIDENTS
 COLDUR TO MATCH PARELS

 HORZL VIATU. SIDHIG (14" ESPOSURE)

 V-LINT MOOD SOFFIT STANED


 MOOD PRACIAS 1 MATERIABLES PAINTED

 MOOD PROSTS : BEAN STANED

 SOLID CORE MOOD DOOR STANED





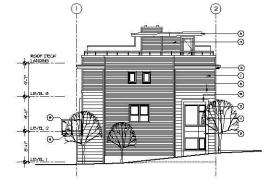


9CALE: 1/8" = 1-0"

(2)

(I) ROOF DECK LANDING

LEVEL

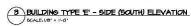

4 BUILDING TYPE E' - SIDE (NORTH) ELEVATION

(1)



BUILDING TYPE E' - FRONT (EAST) ELEVATION



MATERIAL KEY

- FIDER-CEMENT BOARD HORZ'L SIDING SHOOTH (4" EXPOSURE) PAINTED
 FIDER-CEMENT BOARD HORZ'L SIDING TEXTLIRED (IO 3/4" EXPOSURE) PAINTED
- (i) FIBER-CEHENT BOARD PANEL IV REGLETS
- COLOR TO MATCH PASELS

 (4) HORZI, VINTI, SIDING (4" EXPOSURE)

 (5) V-LORIT MODD SOFFIT STAIRED


 (6) NODD PASSLAS 1 MATERTABLES PAI

 (7) NODD POSTS 6 IEEEAM STAIRED

 (8) SOLID CORE MODD DOOR STAIRED

(*) INSULATED FIGHER ASS DOOR - FAINTED
(**) VINYL FRAMED SLIDING DOORS
(**) VINYL FRAMED MINIOPS AY MOOD TRIM

- PREFINISHED METAL FLASHING PREFINISHED METAL CLADDING PREFINISHED METAL PICKET RAILING
- (9) REFINISHED NETAL CLADDING
 (3) REFINISHED NETAL DICKER PAILING
 (3) THEIL HALL FLASHING COLOR TO MATCH FIELD COLOR
 (3) PRIFINISHED METAL GLADDRAIL (4) SAFETY GLASG
 (1) PRIFINISHED OVERHEAD GARAGE DOOR

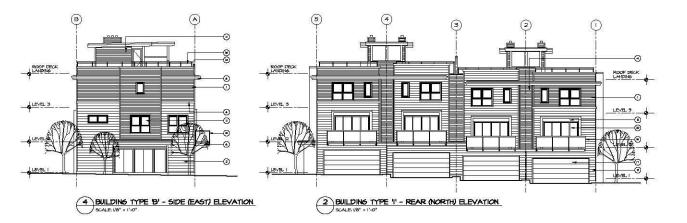



SITE KEY

CONSULTANT:

(3)

LEVEL 9




MULTI-FAMILY RESIDENTIAL DEVELOPMENT 2215 164TH STREET SURREY, BC

ees me

TYPE T **BUILDING ELEVATIONS BUILDING 12**

APRIL 2014 185-1-01

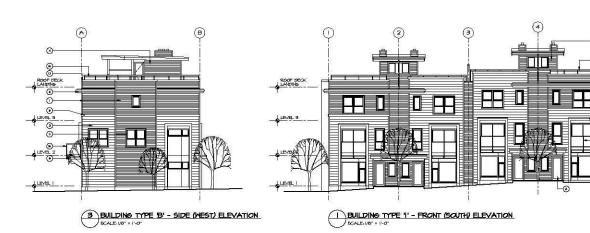

MATERIAL KEY

- FIDER-CEMENT BOARD HORZ'L SIDING SMOOTH (4" EXPOSURE) PAINTED
 FIDER-CEMENT BOARD HORZ'L SIDING TEXTURED (10 3/4" EXPOSURE) PAINTED
- FIBER-CENERY BOARD PANEL W REGLETS COLOUR TO MATCH PANELS
- COLDIK TO MATCH PARELS

 (4) HORZI, VIRT. BITINE (4" EXPOSURE)


 (5) V-LORIT MORD SOFFIT STAINED

 (6) MORD FASCIAS & PARTERTABLES PAINTED

 (7) MORD FORTS & EBAN- STAINED

 (8) BOLID CORE MORD DOOR STAINED
- (F) INSULATED FIBREGLASS DOOR PAINTED
 (B) VINYL FRAHED SLIDING DOORS
 (II) VINYL FRAHED HINDONG NY WOOD TRIM
- PREFINISHED METAL PLASHING PREFINISHED METAL CLASHING
- PREFINISHED METAL PICKET RAILING
- PREFINISHED METAL BURDRAIL BY SAFETY SLASS
 PREFINISHED METAL BURDRAIL BY SAFETY SLASS
 PREFINISHED OVERHEAD GARAGE DOOR.

(3)

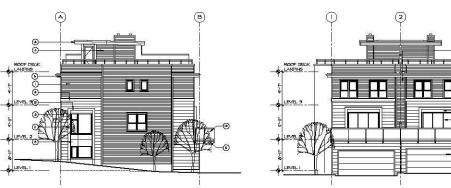

4 BUILDING TYPE 'J' - SIDE (WEST) ELEVATION SCALE: 1/0" = 1'-0"

B

ROOF DECK

 \bigcirc

0

<u>-</u>0



9CALE:1/8" = 1'-0"

3 BUILDING TYPE 'J' - SIDE (EAST) ELEVATION



2 BUILDING TYPE 'J' - REAR (SOUTH) ELEVATION



SITE KEY

CONSULTANT:

BERNARD DECOSSE ARCHITECT INC.

MULTI-FAMILY RESIDENTIAL DEVELOPMENT 2215 164TH STREET SURREY, BC

ees me

TYPE'J' **BUILDING ELEVATIONS BUILDING 13**

APRIL 2014 185-1-01

A-4.10



	SCHEDULE	phase one	PMG JOB NUMBER: 15-04:
KEY GTY	BOTANICAL NAME	COMMON NAME	PLANTED SIZE / REMARKS
TREE.			
~ (A) 5	ACER RUBRIM 'ARMSTRONG GOLD'	ARHSTRONG GOLD COL. MAPLE	6CM CAL, 2M STD; BHB
HZ 3	ACER RUBRUM RED SUNSET	RED SUNSET MAPLE	BCM GAL, 2M STD, B4B
Z(1) 2	ACER X FREEHAMI SCARSEN	SCARLET COLUMNAR SENTINEL HAPLE	BCM GAL, 2M STD, B4B
ñ₩:	CARPINIS BETILIS TASTIGIATA*	PYRAMIDAL EUROPEAN HORNEEAN	BCH GAL, LBM STD, B4B
260	CERCIDIPHYLLIN JAPONICIM	KATSURA TREE	BCH GAL, LBM STD; B4B
12 2	FASIS SYLVATICA DAMYCKII SOLD*	GOLDEN FASTISIATE BEECH	ACH CAL, LBM STD, B4B
≅(•) ⊢	FASIS SYLVATICA DAVYCKII PIRPLE	PARPLE FASTISIATE BEECH	6CH CALIBIB
32 2	NASNOLIA KOBIS STELLATA ROYAL STAR"	ROYAL STAR MAGNOLIA	2.CH HT, B4B
ພາ	POPULIS TREMALOIDES TRECTA'	SHEDISH TREHELING AGPEN	6CH CAL, 2H 5TD, B4B
See			
AU IZ	AKUBA JAPONCA MR. GOLDSTRIKE	HR. GOLDSTRIKE AUGUBA	45 POT-500M
BCB M	DEFIDERIO THUNGERROII MONOMO!	CHERRY BOHB BARBERRY	N2 POT
CO 2	CORRES ALBA WELSEYE'	KELSEY DIVARF DOSNOOD	#2 POT
	BUDNIYUS ALATA (COMPACTUS)	COMPACT MINISTED BURNING BUSH	45 POT, SOOM
H T	HYDRANSEA H. TRELESS SUMMER"	ENCLESS SUPPER DIGLEAF HYDRANSEA	NS POT, BOCH
SPN D	LEX '9KY PENCL'	SKY PENCE HOLLY	45 POT
IC 65	ILEX CREMATA "COMMEXA"	JAPANESE HOLLY	#2 POT
н в	NAMENIA DOMESTICA	HEAVENLY BAMBOO	45 POT, SOOM
FP IO	PHOTINA X FRASERI	FRASER PHOTIMA	LOM HT
н э	PHYSOCARPUS "COPPERTIEN"	COPPERTINA HINEBARK	LOM HT, B4B
P 2	PERIS JAPONCA VALLEY FIRE	VALLEY FIRE PERIS	49 POT, 500M
Z 18	PRINIS LAUROCERASIS 'ZABELIANA'	ZABLES LAIREL	92 POT, BOOM
R2 II	RHODODENDRON NOTE!	HOTEL RHODGOENDRON	92 POT, 500M
RI 6	RHODODENDRON P.J.H. BLITE	P.J.H. ELITE RHODODENDRON	RS POT
SAR 14	SARCOCOCCA HOOKERANA TRESCEPOLIA"	PRAGRANT SARCOCOCCA	N2 POT
SK 45	SKIMMA JAPONICA (ION HALE)	JAPANESE SICINIA	#2 POT; SOCM
SR 21	SKIMMA REEVESIANA	DIVARF SICHMA	M POT
Y 64	TAXUS X NEDIA NICKSI!	MCKS YEN	LØM+
T 45	THUA OCCIDENTALIS YMARASD*	EMERALD GREEN CEDAR	ISM HT, D4D
6RASS			
KF 12	CALAMAGROSTIS X A. YARL FORRSTER*	KARL FORRSTER FEATHEREED 6RASS	92 POT, HEAVY
CA 12	CAREX COLICHOSTACHYA KAGA NISHKI'	60LD FOINTANS SED6E	M POT, FILL
0 18	OPHIOPOSON PLANSCAPUS NISRESCEIS'	BLACK HONDO 6RA65	#I FOT
PERSHAL			
HE2 B	HEMEROCALLIS FURPLE D'ORD"	PURPLE D'ORO DAYLILY	M POT
HE 4	HEMEROCALLIS 'STELLA D'ORD'	DAYLLY	PLEOT, I-2 FAN
ec			
NO B	NAMENIA DOMESTICA NARBOUR DINARP	HARBOUR DINARY HANDINA	#I POT
CD B E2 5 HD 8 E01ES * PLAN EXTA STANDAR	OS. BOTH FLANT SIZE AND CONTAINER SIZE AND AND OTHER FLANT HATERIAL REQUIREMENTS.	EEARGERRY COTOREAGTER EXCHANG, SLAVE VARIEGATED MARQUE RAMEN MARINA TO THE DC. LANDSCAPE STANDARD, LATEST EXTRICAL TO THE DC. LANDSCAPE STANDARD, LATEST EXTRICAL TO MARINA ROCKETABLE STANDARD, LATEST EXTRICAL SEARCH AND REVIEW MARIE FLAIR MATERIAL, AVALAG ELATOR SCALES LOSSES MARIA MAD TRANSEN TAMAL AND ELTO TRICILLE LOSSES MARIA MAD TRANSEN TAMAL AND ELTO TRICILLE LOSSES MARIA MAD TRANSEN TAMAL AND ELTO TRICILLE LOSSES MARIA MAD TRANSEN TAMAL ELTO TRICILLE LOSSES MARIA MARIA ELTO TRICILLE LOSSES MARIA MARIA ELTO TRICILLE LOSSES MARIA MARIA ELTO TRICILLE LOSSES MARIA ELTO TRICILLE MARIA ELTO TR	CATIONS FOR DEFINED CONTAINER BLE FOR OFFICIAL REVIEW BY

	SCHEDULE	phase three	PMG JOB NUMBER:	15
KEY GTY	BOTANICAL NAME	COMMON NAME	PLANTED SIZE / REMARKS	=
TREES				
	ACER GREELM	PAPERBARK HAPLE	BCM CAL, LBM STD, B4B	
3	CARPINIS DETILIS TASTIGIATA"	PYRAMIDAL EUROPEAN HORNEEAN	BOM GAL, LBM STD. BAB	
25.3	HALESIA CARCLINA	CAROLINA SILVERBELL	OCH GAL, LOM STD, DAD	
2	MAGNOLIA KORUS STELLATA ROYAL STAR"	ROYAL STAR MAGNOLIA	2 CH HT; BIB	
σ Κ 0 ι	CKYDENDRON ARECREM	SOURHOOD	BCH GAL; LBM STD; B4B	
ZI - 1	STYRAX JAPONOUS	JAPANESE SICHEELL	BCH CAL; LBM STD, B4B	
SHRB				
AB IB	ABELIA EDHARD GOICHER	PINK ABBLIA	92 POT, BOCH	
AU IO	ALCUBA JAPONICA MR. BOLDSTRIKE	HR. 60LDSTRIKE AUGUBA	#8 POT, SOCH	
AZ S	AZALEA MOLLIS HYBRIDS	DECIDIOUS AZALEAS VARIETIES	#8 POT, 40CM	
BCB 6	BERBERIS THINGEBROIL MONOMS!	CHERRY BOHB BARBERRY	#2 POT	
CO 6	CORNED ALBA VELSEYS!	KELSEY DIVARE DOSNOOD	#2 POT	
E 7	EUDNIMIS ALATA COMPACTIO	COMPACT HINGED BURNING BUSH	45 POT, SOCH	
H 4	HYDRANGEA M. TRICLESS SUMMER"	ENDLESS SUPPER ENGLEAF HYDRANGEA	45 POT, BOCH	
SPH B	LEX YEAY PENCIL!	SKY PENGL HOLLY	45 POT	
IG 25	LEX CREMATA SCHWEXA.	JAPANESE HOLLY	NO POT	
Н 5	NAHONA AGUFOLEM	ORDINON REAPT HOLLY*	65 POT-SOOM	
PH 3	PHLADELPHS LINES	HOCK CRAWER	92 POT-SOOM	
H 3	PHYSOCARPUS Y/OPPERTUAL	COPPERTINA HINEBARK	LON HT. BAB	
P #	PKEA MIAKA YOMGA'	DHARF ALBERTA SPRICE	65 POT 500M	
2 2	PERS JAPONCA VALLEY FIRE	VALLEY FIRE PERM	69 POT 500M	
B4 12	BHODODERDRON TORRESHAN CHEEK	OWISHING CHEEK BIODOGROUPING	69 601 500H	
R3 6	SHOOGOFFIDE OF SHORE	WASHING CHEEK RICCCCCCCACHCH	69 697 500H	
	SMCCCCCCA HOOKPRANA WINCEGLAV	WACH INCOCOSONON PRAMINIT SANCOCOCCA	89 901, 500H 80 907	
	SANCOCOCCA HOOKERANA NUSCIPOLIA	MANAGEME SCHOOLS	#2 POT #2 BOT, NOOM	
TD 4	TAXUS X NEDIA DEBISIFORMIS	DIVARF YOM	45 POT, SHEARED	
Y 102	TAXUS X MEDIA MCKSII'	HICKS YEN	I/DH+	
T 65	THUA OCCUPRITALIS 'SHARASD'	EMERALD GREEN CEDAR	ISM HT, D4D	
VID I	VIBURNIM X BURKHOCOUP	BURKHOOD VIBURALIN	LOM HT, BAD, TREE FORM	
6RASS				
KF 3	CALAMAGROSTIS X A. YARL FORRSTER	KARL FORSTER FEATHEREED 6RASS	92 POT, HEAVY	
CA BI	CAREX COLICHOSTACHYA KAGA NISHKI'	60LD FOINTAINS SEDSE	M POT, FILL	
HA 4	HAKGNECHLOA HACRA "ALLGOLD"	ALLGOLD JAPANESE FOREST GRASS	#I POT	
64 5	MISCARTHUS SINENSIS MORNING LIGHT	HORNING LIGHT JAPSILYER GRASS	#2 POT	
0 26	OPHIOPOSICH PLANSCAPUS NIGRESCEIS!	BLACK HONDO 6RAGS	#I POT	
PEREMAL				
A6 12	ASTILLEE X TITMAY	ETNA PALSE SPRAEA (RED)	92 POT, 5 EYE OR LANGER	
GI 3	CINCIPUSA R. 'ATROPURTUREA'	PURPLE DISCOVE	#2 POT	
DD 6	HELICHERA TYALACE PURPLE"	PALACE PURPLE CORAL BILLS	IDCM POT	
HP I2	HOSTA PRAYING HANDS'	PRAYING HANDS HOSTA	N POT	
1 5	RIS SIDERICA SUPER DISC	SUPER DISC SIDERIAN RIS	N POT 3 PANS	
ec				
AL D	ACKARTIN ALBUTICIN	HESTERN MADERNAR FERN	M POT PAL	
ap s	COTOMERSTER DAMPERS	BEARBERY COTOMASTER	M POT, 25KM	
E2 I	BIOMMS JAPONICA THERALD GAFTY	RICHMAN SEVER VARIFIANTED	M POT, 25KM	
6 4	AMI DERIA SHALLON	SNA!	M POT, 200H	
ND 12	NAMEDIA DOMENTICA WARROW DAMAP	HARPOR CHARF HANDINA	M POT	
HD 12	ROLYSTICHE MARTIN	HARDOUR DRAWN WAIDING	N POT 200H	
V 19	VIICA MINOR WLBA*	NITE-FLOHER PERMINKLE	IDCH POT	
EASIREMENTS	S. BOTH PLANT SIZE AND CONTAINER SIZE ARE:	TO THE BC LANDSCAPE STANDARD, LATEST EDITION. THE MINIMAN ACCEPTABLE SIZES. * REFER TO SPECIF EARCH AND REVIEW, MAKE PLANT MATERIAL AVAILA H TO INCLUDE LOVER MAINLAND AND PRASER VALLE	CATIONS FOR DEFINED CONTAINER BLE FOR OPTIONAL REVIEW BY Y * NEWTONIONS, ORTAIN MILITIEN	

	「 SCHEDULE	phase five	PMG JOB NUMBER: 154
KEY QT	BOTANICAL NAME	COMMON NAME	PLANTED SEE / REMARKS
THEE CO		VIET HARTS	
20;	ACER CINCINATUM		SICH HT, BHB, S STEM CLUMP
OLT 2	ACER HACKOPHILLIN	BIOLEAF HAVLE	6CM CALIBIB
AND 2	CERCIDIPHYLLIM JAPONICIM	KATSURA TREE	6CM CAL, LBM STD, B4B
100 − 2	CHAMABOTTARIS NOOTKATENSIS TENDULA'	NEEPTING HOOTIKA CYPRESS	25H HT, BIB
~~	GINGO BLOBA PRINCETON SENTRY	PRINCETON SENTRY MAIDENNAIR	6CM CAL, 2M STD; B4B
C = 2	MAGNOLIA KORUS STELLATA ROYAL STAR	ROYAL STAR MAGNOLIA	3 CM HT, BIB
النات	PNIS CONTORTA	SHORE PIME	2.CM HT; BIB
UT 2	POPULIS TREMALOIDES TREGTA"	SHEDISH TREMELING ASPEN	BCH CAL, 2H STD; B4B
- kt/4*	PSELDOTSUBA MENZESII	DOMELAS FIR	25H HT; B4B
SHE	GLEROUS ROBUR FASTISHATA	COLUMNIR OAK	BCM CAL; LBM STD; B4B
AB 12	ABELIA EDWARD GOICHER	PINK ABBLIA	92 POT; BOCH
A 2	AZALEA JAPONICA 1990 CRIMSON	AZALEA (SINGLE DEEP CRIMSON)	#2 POT
AZ S	AZALEA MOLLIS HYBRIDS	DECIDIOUS AZALEAS VARIETIES	49 POT, 40CM
BCB 50		CHERRY BOMB BARBERRY	N2 POT
CO 20		KELSEY DWARF DOSNOOD	N2 POT
E 14	EXCHING ALATA (COMPACTIO)	COMPACT MINORD BURNING BUSH	45 POT, SOCH
110 2	HOLODISOUS DISCOLOR	OCEANEPRAY*	#2 POT
H 5	HYDRANSEA H. TROLESG SAMER*	ENDLESS SUPPER DISLEAF HYDRANSEA	45 POT; BOCH
SPH 5	ILEX SKY PENCIL!	SKY PENCIL HOLLY	45 POT
IG T	ILEX CREMATA "COMMEXA"	JAPANESE HOLLY	#2 POT
J5 2	JAPPERUS 'SKYROCKET'	SKYROCKET JINPER	1,25H HT, B4B
H 2	MAHONIA AGRIFOLISM	OREGON GRAPE HOLLY®	#9 POT, SOCH
H IO	NAMENIA DONESTICA	HEAVENLY BAMBOO	49 POT, 500H
PH 2	PHLADELPHIS LENISI	HOCK CRANGE®	92 POT, 500M
FP 2	PHOTINIA X FRASERI	PRACER PHOTIMA	LOM HT
P 1	PERIS JAPONICA VALLEY FIRE	VALLEY FIRE PERIS	RB POT/SOCH
RL 81	FFERES LAUROCERAGUS REYNVAAM!	RUSSIAN LAUREL	RS POT, BOOM
R4 2	RECOCCENCIAN CHRISTMAS CHEER!	CHRISTHAS CHEER RHODODENDRON	45 POT, SOOM
R5 5	RECOCCENCRON SMACH!	NACIM INICOCOMIDIDADIN	#5 POT, SOOM
RI 3	RHODODENDRON P.JH. ELITE*	P.J.H. ELITE RHODODENDRON	45 POT
R 3	RIDES SANGUNEUM	RED FLONERING CURRANT*	45 POT
RO2 IB	ROSA SCARLET MEDILAND	SCARLET MEIDLAND ROSE	#2 POT: 40CM
SAR 2	SARCOCOCCA HOOKERANA TRISCIFOLIA'	FRASRANT SARCOCOCCA	42 POT
584 7	STMPHORICARPOS ALBUS	SHOHEERRY*	92 POT, BOCH
Y 14	TAMS X NEDIA HCKSII*	HCK5 YBH	IdH
T 22	THUA OCCIDENTALIS 'SHARASO'	EMERALD GREEK CEDAR	ISM HT, B4B
VA B	VACCINUM OVATIM THINDERBIRD*	EVEROREEN HICKLEEGERRY*	92 POT/500M
D 6	VIBURUH DAMDII	DAVID'S VIBURUM	12 POT, 500M
VM I	VIBURUH P.T. HARIESI?	HARRES DOUBLE FILE VIBURUM	LOM HT, BAB
VB 2	VIBURBUM X BURBOADCDIF	BURKHOOD VIBURIUM	LOW HT, BAB, TREE FORM
oc			
E2 4	EXCHANG JAPONICA EMERALD GARTY	EICHYNIS; SEVER VARIEGATED	M POT, 25CM
0 42	GAILTHERIA SHALLON	SALAL*	M POT, 200M
F 30	POLYSTICHEM MANTUM	HESTERN SHURD FERNY	M POT, 200M
EAGURENEN ANDSCAPE	RDS. BOTH FLANT SIZE AND CONTAINER SIZE AND OTHER FLANT HATERIAL REQUIREMENTS. RICHTECT AT SOURCE OF SUPPLY. AREA OF SE	IS TO THE BC LANDSCAPE STANDARD, LATEST EDITION. IE THE MINISH ACCEPTABLE SIZES. * REFER TO SPECIF* * SEASON AND REVIEW MANE FLAN HATERIAL AND RICH TO INCLIDE LOWER MANE AND AND PROMER VALUE WAS ANY SHIPPITTION. TO BE SERVICED MATERIAL.	ICATIONS FOR DEFINED CONTAINER BLE FOR OPTIONAL REVIEW BY Y. * SUBSTITUTIONS, OBTAIN WRITTEN
ELECTED. A	OM THE LANDSCAPE ARCHITECT PRIOR TO MAKE	NO ANY SUBSTITUTIONS TO THE SPECIFIED MATERIAL, IN BRY FOR REQUEST TO SUBSTITUTE. SUBSTITUTIONS ARE S	APPROVED SUBSTITUTIONS WILL BE

PLANT	SCHEDULE	phase two	PMG JOB NUMBER: 15-042
KEY GTY	BOTANICAL NAME	COMMON NAME	PLANTED SIZE / REMARKS
TOTAL			
⊕.,	ACER CIRCINATUM	VINE MAPLE	SIOM HT, END, S STEM CLUMP
250	ACER HACKOPHYLLIM	DIGLEAT HAPLE	6CM CALLIBED
OF 5	ACER RUBRIN 'ARMSTRONG GOLD'	ARMSTRONG BOLD COL. HAPLE	ACM CAL, 2M STD, B4B
2.72	ACER X FREEHANI "SCARSEN"	SCAPLET COLUMNAR SENTINEL HAPLE	ACH CAL, 2M STD; B4B
(Alberta	CERCIS CANADENSIS FOREST PANSY	FORENT PANNY REDBUD	ACM CALLUMIT STD. BAB
2000	CHAMARCYPARIS MODIKATENSIS PEMDILI	N METPING NOOTICA CYPRESS	25H HT-BHB
(- E	FASIS STLVATICA DANYCKII GOLD'	GOLDEN FASTIGIATE BEECH	ACH CALL LISH STD, BAB
27.12	FASIS SYLVATICA DAVYCKII PURPLE	PURPLE FASTISIATE BEECH	6CH CALIBIB
(Vall 2	LIGUIDAMBAR STYRACIFLIA NORFLESOCI	V HORPLESDON SHEET 69H	6CH CAL, 2M 51D, B4B
72.7	PINIS CONTORTA	SHORE PINE	2.0H HT, B4B
(-) E 6	POPULIS TREMLOIDES ERECTA!	SNEDISH TREHELING AGPEN	6CH CAL, 2M STD, BIB
344 s	PSEUDOTSUSA MEKZIESII	DOUGLAS FIR	25H HT, BHB
COPPE I	PYRIS CALLERYANA CHANTICLESS	CHANTICLEUR PEAR	6CM CALL ISM STD, BHB
dello			
AU IZ	AUGUBA JAPONICA MR. GOLDSTRIKE	MR. GOLDSTRIKE AKUEA	RS POT, SOCH
AZ 3	AZALEA MOLLIS HYERIDS	DECEDIÇUS AZALEAS VARIETIES	45 POT, 400M
BCB II	BERBERIS THUMBBERISH MONOMIY	CHERRY BOMB BARBERRY	#2 P0T
CQ 24	CORNES ALBA KELSEYIF	KELSEY DWARF DOSHOOD	#2 POT
HO 2	HOLODISCUS DISCOLOR	OCEANSPRAY*	42 P0T
SPH I	LEX SKY PENCL!	SKY PENCIL HOLLY	45 POT
IC 94	ILEX CREMATA (COMPEXA)	JAPANESE HOLLY	42 P0T
H 44	HAHONA AGUFOLISH	OREGON GRAPE HOLLY*	49 POT, 500H
N 6	NANDINA DOMESTICA	HEAVELY BANGOO	49 POT-500H
DI 4	PHILADELPHIS LENSII	MOCK ORANGE®	42 POT-500H
FP 19	PHOTINA X PRACERS	PRACES PROTINA	LOM HT
M D	PHYSICIARRUS (COPPERTINA)	COPPERTINA NIMEDARK	LOM HT. BHB
PP 67	PINIS MISO HOPS	MOPS DWARF HUSO PINE	42 POT, 25CM
Z 30	PRINIS LAUROCERASUS TABELIANA	ZADLES LAUREL	42 POT-500M
R2 12	RICOCORDRON NOTES	HOTEL RHODODENDRON	42 POT, SOOM
R 2	REES SANGURELM	RED FLONERING CURRANT*	45 POT
RCD II	ROSA MEIDRIFORA*	CORAL DRIFT GROWDCOVER ROSE	42 P0T
SAR IO	SARCOCOCCA HOOKERANA RUSCIFOLIA'	FRASRANT SARCOCOCCA	#2 P0T
5K 12	SKIMMA JAPONICA NOB MALE)	JAPANESE SKIPMA	42 P01; B00H
5 4	SPRAEA X BIHALDA LIMENDINO	LIMEHOUND SPIREA	42 POT, 400M
Y 82	TAMIS X HEDIA NICKSIT	HICK'S YEN	LOH
T 42	THUA OCCUDENTALIS SHARAGO'	EMERALD GREEN CEDAR	ISM HT, B4B
VA B	VACCINIM OVATIM THINDERBIRD*	EVERGREEN HICKLEBERRY*	42 POT-500H
VM 2	VIDURUM P.T. HARRESI!	MARIES DOUBLE FILE VIBIRIUM	LOM HT. BHB
GRAGS			
CA 20	CAREX COLICIOSTACINA KAGA NISHKI"	GOLD FOUNTAINS SEDICE	#I POT, FULL
64 5	HISCANTING STIENESS HORNING LIGHT	MORNING LIGHT JAPSELVER GRASS	42 POT
0 30	OPHICPOSON PLANSCAPUS YMRESCENS'	BLACK HONDO GRAGG	#I POT
PERENNAL.			
HE 5	HEMEROCALLIS SITELLA D'ORO"	DAYLLY	#I POT; I-2 FAN
60			
6 8	GAILTHERIA SHALLON	SALAL*	*I POT, 20CM
NO 4	NANDINA DOMESTICA HARBOUR DINARF	HARBOUR DHARF NANDRIA	#I POT
F 64	POLYSTICHUM MUNTUM	NESTERN SNORD FERM*	PI POT, 20CH
HIA STANDAR	DS. BOTH PLANT SIZE AND CONTAMER SIZE AND CONTAMER SIZE AND CONTAMER PLANT MATERIAL SEGUISIPSENTS	NO TO THE BY LANDSCAPE STANDARD, LATEST EXTERNA ARE THE MINIMA ACCEPTABLE SIZES. * SEPTER TO SPECI * SEARCH AND REVERN HAME PLANT HATESTAL, AVAIL EMPLY TO MIZURE LOWER HAMLAND AND FRASER VALUE HAME ANY SESTITUTIONS TO THE SPECIFED HATESTALL IS HAVE ANY SESTITUTIONS TO THE SPECIFED HATESTALL IS	FICATIONS FOR DEFINED CONTAINER AND F FOR OPTIONAL REVISION RY

2LAN	4 I	SCHEDULE	PHASE FOUR	PMG JOB NUMBER: 15-042
KEY (ΉY	BOTANICAL NAME	COMMON NAME	PLANTED SIZE / REMARKS
THEE			PAPERANC MAR F	
		ACER 6RISSIM		&CH CAL, I.BM STD, B4B
VIEW	2	ACER RUBRIM RED SURGET	RED SURET NAVLE	6CH CAL, 2H 5TD, B4B
みい		ACER X FREEHANI SCARSON	SCAPLET COLUMNAR SERTINGS, HAPLE	&CM CAL, 2M 51D, B4B
ans.	1	CARPINIO BETILUO TASTIGIATA'	PYRAMIDAL BIROFEAN HORREEAH	BOM CAL, LBM STD, B4B
ക്ക		CERCIS CANADENSIS FOREST PANSY	POREST PANSY REDBUD	ACM CAL, LEMT STD, BIRB
985	4	CHANADOYPARIS NOOTKATENSIS PENDULA'	NEEPING NOOTICA CYPRESIG	25H HT BHB
290	4	LIGUIDAMBAR STYRACIFLIA WORFLESDON	HORPLESOON SHEET 66H	ACM CAL, 2M STD, DED
(K)	4	PYRIG CALLERYANA CHANDICLERS	CHANTICLEUR PEAR	ACM CALLISM STD. DED
office .				
	26	ARELIA EDHARD GOICHER*	PRIK ABELIA	42 POT-BOOM
		AZALEA HOLLIS HYERIDS	DECEDIÇUS AZALEAS VARIETIES	45 POT; 400H
BCB	17	BERBERIS THANSBERIST THORONDY	CHERRY BOYD BARBERRY	92 POT
60	8	CORNES ALBA KELSEYI'	KELSEY DWARF DOSNOOD	92 POT
	9	RICHMAN ALATA YOMPACHIN	COMPACT HIMSED PURSONS RISH	65 POS 500H
5534		LPX VICT PRICE!	NY ISSUE HOLLY	89 892F
K	ů.	ILEX CREMATA YORNEYA'	MEMBERS WOLLY	\$2 9/2F
		INTERN MOTOCAPT	NOWCKPT HAPPE	L25M HT, B4B
м	Ä	HAVONA AGUITOLIIM	CRESCU GRAFF HOLLY?	85 POT SOCH
	50	PIOTINA X PRAGERI	FRASER PICTIMA	LOM HT
	Б	PHYSOCARPUS COPPERTINA'	COPPERTINA HINETIARIX	LCM HT. DED
P	2	PERS JAPONGA VALLEY FIRE	VALLY FIRE PERIS	65 POT-500H
PP	i	PNS NINO NOW	MOPS DIARRE NINO PINE	62 P05-25CH
	21	PRING LARROCERAGE TOTTO LINKEN	OTTO LIMEN LAIRE.	65 POT SOCH
	í,	BHODODRON CHRISTMAS CHEEK	ORNINAS CHER SHODODINOSON	#8 POT SOCH
	ž	BHODODRON WOTEL	HOTEL SHOOGOFHORON	#2 P01 B00H
	4	RHODODENON NACHT	NACH SHOOCOFFICEON	69 POT 500H
	2	BOSA KWOKOT BADBATT	SADSATT KNOCKOUT BOSE	12 POT
	ĕ	BON MEDICAL POPULATA	CORN DRET RECEIPTONE BONE	#2 POT
100		SARCOCOCCA HOOKPRANA WINCHOLIA	PRAMBANT SANCOCOCA	12 POT
	2	SARCOCOCCA HOOKERANA MUSCIPOLIA	MARKANT SARCOCOCCA	
				#2 POT, BOOM
9	٠	SPIRABA X BUHALDA LIMENDINO	LIMEMOUND SPIREA	42 POT; 400M
	135	TAXIS X HEDIA NICKSI!	HICK'S YEN	LCH+
	52	THUA OCCUPATALIS YMARASD'	EMERALD GREEN CEDAR	LSH HT, DAD
	2	VEURNAM P.T. HARIESE*	MARIES DOIBLE FILE VIBURUM	LCH HT, DAD
	4	VEURNAM X BURKHDOOM	BURKHOOD VIBURNIM	LOH HT, BAB, TREE FORM
VM				
	2	CLEMATIO TANGUTICA AURECLIN	TANGUTICA CLEMATIS	R2 POT, BOCH, STAKED
VI	2	CLEMATIS VITICELLA PURPUREA PLENA"	PURPLE CLEMATIS	R2 POT, BOOM , STANED
OR/65				
01	14	MISCANTING STIEDING HORNING LIGHT	MORNING LIGHT JAPOLVER GRASS	12 107
FERENNA	L			
HE2	4	HEMEROCALLIS TURTLE D'ORO'	PURPLE DIORO DAYLLY	AI POT
HE	ri .	HEMEROCALLIS "STELLA D'ORO"	DAYLLY	ALPOT, I-2 PAN
ec "				-10015111
	54	CALLINA VILGARIS DARK BEAUTY	DARK BEAUTY HEATHER	BKM POT
	6	COTOMIANTER DAMMERS	DEARDERRY COTOMISSIER	#I POT-250M
	ě	GALTHERA SHALLON	SALAL*	#I POT 200M
		POLYSTICAM MINTEN	MISTERN SHORD FERSY	# POT 200M

SOTTE: I TALE SOTTE IN THE LITTLE SEPECIFIE ACCORDING TO THE ECL AMPLICATE STREAMS, LATER ETITLES, CARRIAGE SOTTE SEPCIFIED ACTIVE SOTTE IN THE SOTTE ACTIVITY OF THE SEPCIFIC ACCORDING THE SEPCIFICATION THE SEPCIFICATION THE SEPC

©Copyright reserved. This drawing and design is the property of PMG Landscape Architects and may not b reproduced or used for other projects without their permission.



AL:

BERNARD DECOSSE ARCHITECT INC. 113 - 119 W PENDER STREET VANCOUVER BC T: 604 682 3301

CLIENT:

PROJECT:

Multi-Family Residential Project ---- 24th Avenue Surrey, BC

DRAWING TITLE:


LANDSCAPE SITE PLAN


DATE: 15.APR.28 DRAWING NL
SCALE: 1"-30'-0"
DRAWN: BJ
DESIGN:
CHICD: PCM

15047-4B.ZIP

PROJECT NUMBER:

15-047

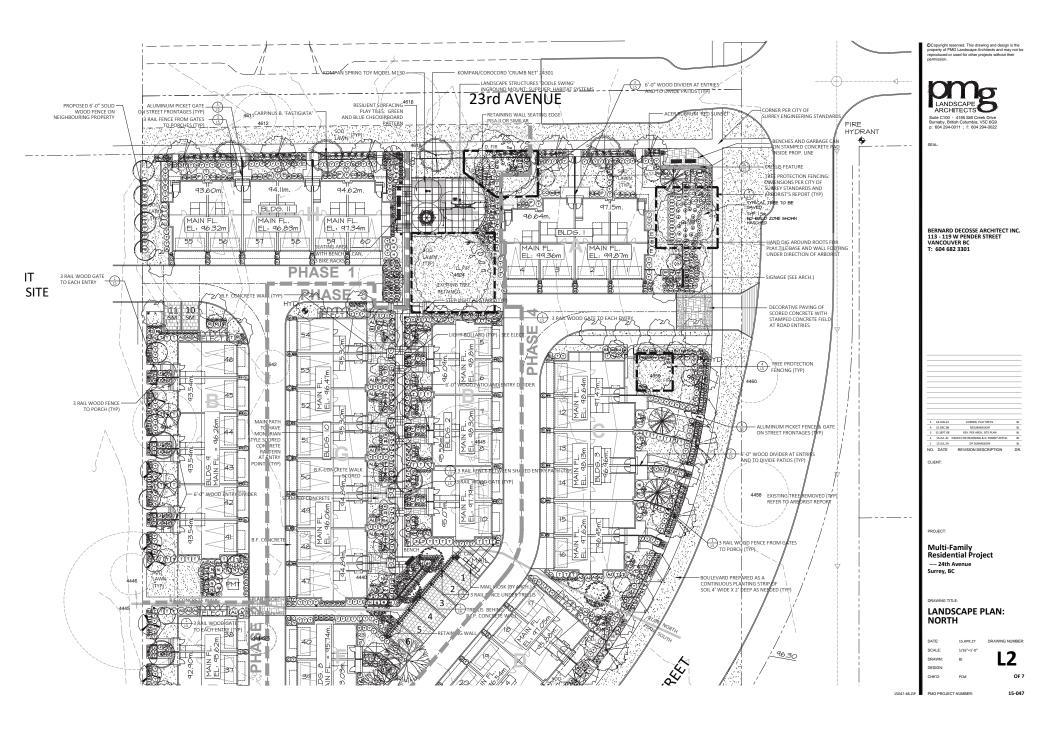

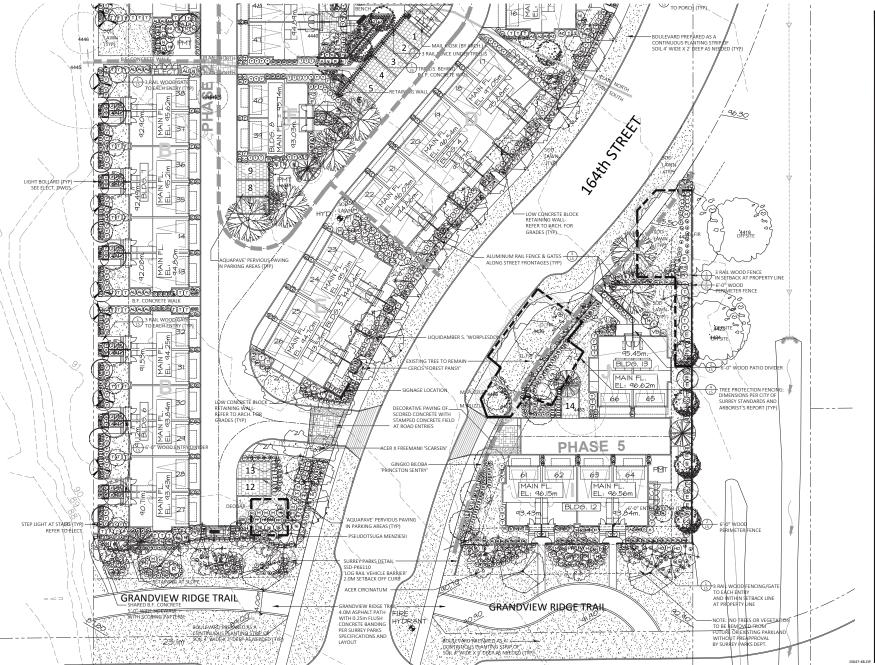

©Copyright reserved. This drawing and design is the property of PMG Landscape Architects and may not b reproduced or used for other projects without their

LANDSCAPE ARCHITECTS
Suite C100 - 4185 Still Creek Dr Burnaby, British Columbia, VSC 6

AL:

BERNARD DECOSSE ARCHITECT INC. 113 - 119 W PENDER STREET VANCOUVER BC T: 604 682 3301

5	16.JAN.22	CORNER, PLAY SPECS.	BJ
4	15.DEC.08	RESUBMISSION	BJ
3	15.5EPT.08	REV. PER ARCH. SITE PLAN	BJ
2	15.JUL.31	ISSUED FOR REZONING & D. PERMIT APPLIC.	BJ
1	15.JUL.24	DP SUBMISSION	BJ
NO.	DATE	REVISION DESCRIPTION	DR

CLIENT

PROJECT:

Multi-Family Residential Project ---- 24th Avenue Surrey, BC


DRAWING TITLE:

LANDSCAPE PLAN: SOUTH

ATE:	15.APR.21	DRAWING NUMBER:
CALE:	1/16"=1'-0"	
RAWN:	BJ	L3
ESIGN:		
HK'D:	PCM	OF 7

15-047

IP PMG PROJECT NUMBER:

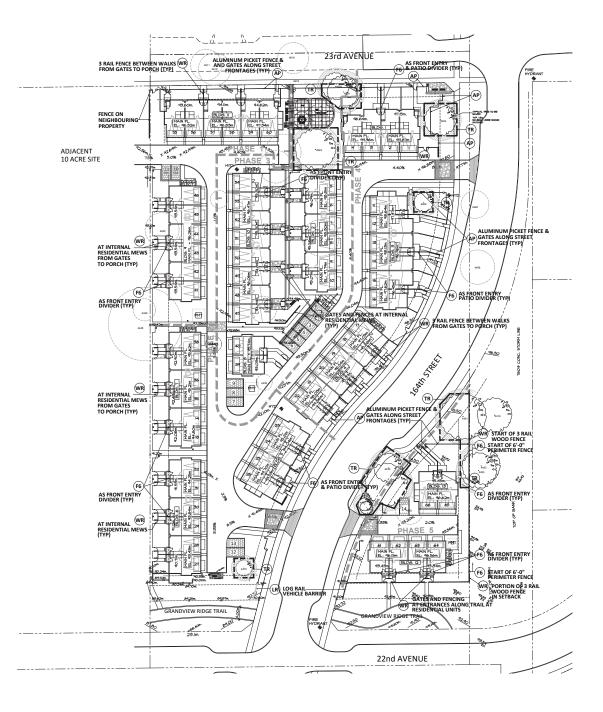

FENCE KEY

- 6'-0" WOOD FENCE AS PERIMETER FENCE AND PORCH DIVIDER
- WR WOOD RAIL FENCE IN NON-STREET RESIDENTIAL AREAS
- AP ALUMINUM PICKET FENCE IN STREET RESIDENTIAL AREAS
- TREE PROTECTION FENCING PER ARBORIST'S REPORT
- LOG RAIL VEHICLE BARRIER
 PER SURREY PARKS DEPT. DETAILS
 SSD-PD6110

©Copyright reserved. This drawing and design is the property of PMG Landscape Architects and may not b reproduced or used for other projects without their



SEAL:

BERNARD DECOSSE ARCHITECT INC. 113 - 119 W PENDER STREET VANCOUVER BC T: 604 682 3301

16.JAN.22	CORNER, PLAY SPECS.
15.DEC.08	RESUBMISSION
15.5EPT.08	REV. PER ARCH. SITE PLAN
15.JUL.31	ISSUED FOR REZONING & D. PERMIT APPLIC.

I IENT

PROJECT:


Multi-Family Residential Project ---- 24th Avenue Surrey, BC

DRAWING TITLE:

FENCE LAYOUT

DATE:	15.APR.21	DRAWING NUMBER:
SCALE:	1"=30'-0"	
DRAWN:	BJ	14
DESIGN:		
CHK'D:	PCM	OF 7

15047-48.ZIP PM

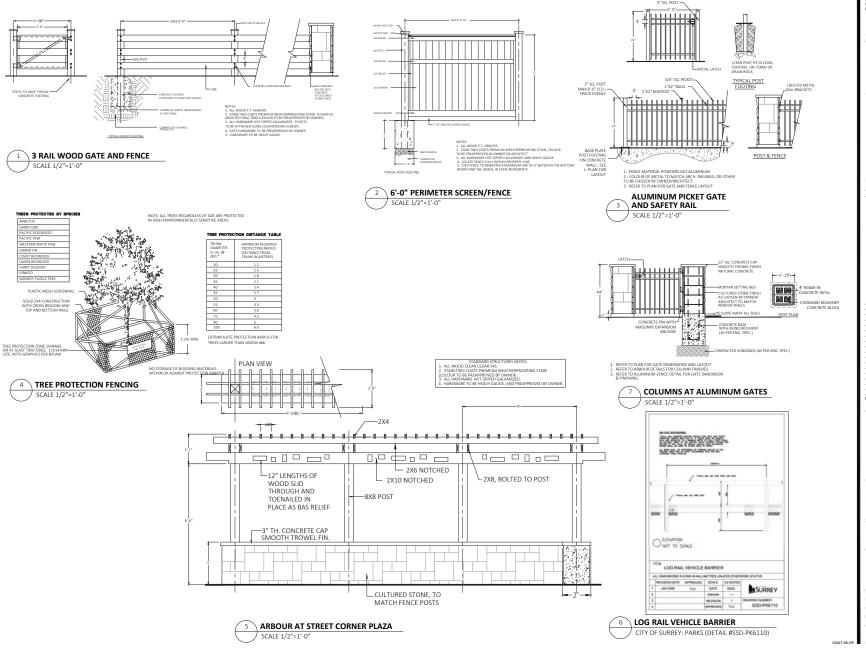

©Copyright reserved. This drawing and design is the property of PMG Landscape Architects and may not b reproduced or used for other projects without their acceptance.

LANDSCAPE ARCHITECTS
Suite C100 - 4185 Still Creek Drivi

SEAL:

BERNARD DECOSSE ARCHITECT INC. 113 - 119 W PENDER STREET VANCOUVER BC T: 604 682 3301

5 MANNA 22 CORNER, FANT SPECS IN A SECRET MEDITALISM IN A SECRET MED

CLIE

PROJECT:

Multi-Family Residential Project ---- 24th Avenue Surrey, BC

DRAWING TITLE:

LANDSCAPE DETAILS

 DATE:
 15.APR.21
 DRAWING NUMBER:


 SCALE:
 VARIES
 VARIES

 DRAWN:
 BJ
 L5


 DESIGN:
 CHKCb:
 PCM
 0F7

PMG PROJECT NUMBER:

15-047

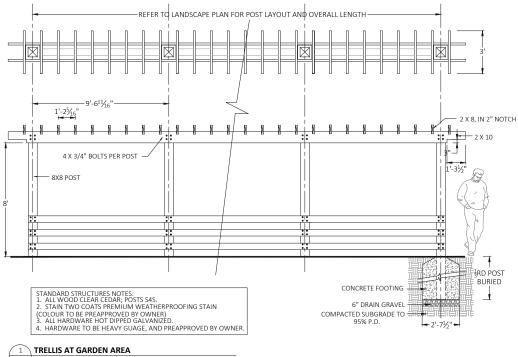

SCALE 1/2"=1'-0"

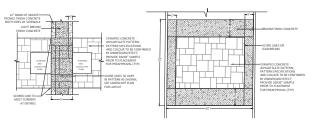

STAMPED CONCRETE IN COURTYARDS: PATTERN: ASHLAR SLATE OR SIMILAR; SMALLER SCALE PATTERN AT PEDESTRIAN ENTRIES. LARGER SCALE PATTERN IN DRIVE ENTRIES. COLOURS: TO BE CHOSEN BY OWNER. SUPPLY SAMPLE 1MX1M FOR PREAPPROVAL

TYPICAL PAVING LAYOUTS SCALE N.T.S.



BENCH: MAGLIN MLB400-RB PC BLACK FINETEX; BROWN RECYCLED PLASTIC SLATS SURFACE MOUNT TO CONCRETE BASE





COROCORD CRUMBNET 24301* KOMPAN M130 SPRING RIDER* DERO: BIKE HITCH*





COLOUR: P.C. BLACK SURFACE MOUNT TO CONCRETE BASE



OODLE SWING: LANDSCAPE STRUCTURES COLOURS: P.C. STEEL - TANGERINE
PLASTIC COMPONENTS - DENIM
CABLE - RED
DIRECT BURY* 90" FALL HEIGHT*



BOLLARD: RELIANCE FOUNDRY MODEL R-7902, BLACK TEXTURED FINISH SURFACE MOUNT

*ALL PLAY PIECES AND FURNITURE TO BE INSTALLED

Copyright reserved. This drawing and design is the property of PMG Landscape Architects and may not b reproduced or used for other projects without their



BERNARD DECOSSE ARCHITECT INC. 113 - 119 W PENDER STREET VANCOUVER BC T: 604 682 3301

	15.APR.23	DP RESUBMISSION	
10.	DATE	REVISION DESCRIPTION	Di

PROJECT:

Multi-Family Residential Project 16330 24th Avenue Surrey, BC

DRAWING TITLE:

LANDSCAPE **DETAILS & IMAGES**

DATE:	15.APR.21	DRAWING NUMBER
SCALE:	VARIES	
DRAWN:	BJ	L6
DESIGN:		
CHK'D:	PCM	OF 1

14-066

14066-4.ZIP PMG PROJECT NUMBER:



INTER-OFFICE MEMO

TO:

Manager, Area Planning & Development - South Surrey Division

Planning and Development Department

FROM:

Development Services Manager, Engineering Department

DATE:

January 28, 2016

PROJECT FILE:

7815-0087-00

RE:

Engineering Requirements Location: 2215 - 164 Street

NCP AMENDMENT

There are no engineering requirements relative to the NCP Amendment.

REZONING/SUBDIVISION

Property and Right-of-Way Requirements

- dedicate varying widths through the site to accommodate the 30.2 m Collector Road allowance for the realignment of 164 Street.
- dedicate 26.5 m towards the ultimate 35.0 m to accommodate the Local Half Road allowance for 22 Avenue, Biodiversity Conservation Strategy Corridor (BCS) and Grandview Ridge Trail.
- dedicate 10.0 m towards 23 Avenue Local Road allowance.
- provide 0.5 m statutory rights-of-ways fronting 164 Street, 22 Avenue and 23 Avenue.
- Provide a 5.0 m statutory rights-of-way for sanitary sewer.

Works and Services

- construct 164 Street to a modified Collector Road standard.
- construct the north side of 22 Avenue to a Local Road standard.
- construct the south side of 23 Avenue to a Local Road standard.
- construct water, storm and sanitary mains to service the development.

A Servicing Agreement is required prior to Rezoning and Subdivision.

DEVELOPMENT PERMIT/DEVELOPMENT VARIANCE PERMIT

There are no engineering requirements relative to issuance of the Development Permit/ Development Variance Permit.

Robert Cooke, Eng.L.

PCoolee

Development Project Engineer

LR

NOTE: Detailed Land Development Engineering Review available on file

Appendix IV



Tuesday, August 11, 2015
Planning

THE IMPACT ON SCHOOLS APPLICATION #:

15 0087 00

SUMMARY

The proposed 66 townhouse units are estimated to have the following impact on the following schools:

Projected # of students for this development:

Elementary Students:	13
Secondary Students:	7

September 2014 Enrolment/School Capacity

Pacific Heights Elementary

Functional Capacity*(8-12);


Enrolment (K/1-7): Capacity (K/1-7):	41 K + 273 40 K + 250	
Earl Marriott Secondary		
Enrolment (8-12):		1946
Nominal Capacity (8-12):		1500

School Enrolment Projections and Planning Update:

The following tables illustrate the enrolment projections (with current/approved ministry capacity) for the elementary and secondary schools serving the proposed development.


Pacific Heights Elementary is currently over capacity with rapid enrolment growth expected to continue. A new elementary school site has been purchased south of 23rd Avenue - Site #206 near Edgewood Drive. The construction of a new elementary school on this site is a high priority in the District's 5-Year Capital Plan and feasibility planning is underway. The school district has also purchased land for a new secondary school in the Grandview area adjoining the City of Surrey future aquatic centre and recreation property. The construction of this secondary school is also a high priority in the district's 5-Year Capital Plan. A proposed addition to Pacific Heights Elementary is included in the capital plan, but as a lower priority than the two capital projects mentioned above. The enrolment projections include anticipated residential growth from the Grandview and Sunnyside NCPs. The actual enrolment growth rate will be driven by the timing of development, demographic changes and market factors. Enrolment pressures in this area of Surrey are extreme and capital project approval timelines are unknown at this point in time. Additional portables will be required at Pacific Heights for September 2015. Until new elementary and secondary school capital projects are approved, the school district does not support development occurring at a higher density than outlined in approved NCPs.

Pacific Heights Elementary

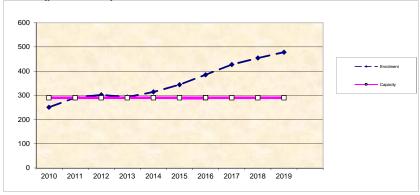

Earl Marriott Secondary

1620

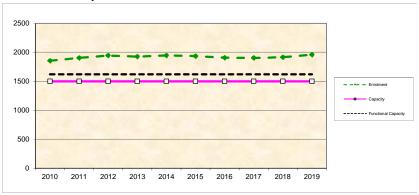

*Functional Capacity at secondary schools is based on space utilization estimate of 27 students per instructional space. The number of instructional spaces is estimated by dividing nominal facility capacity (Ministry capacity) by 25.

Table 3. Tree Preservation Summary

TREE PRESERVATION SUMMARY

Surrey Project No:

Address: 2215 164 Street Surrey BC

Registered Arborist: Max Rathburn


ISA Certified Arborist (PN0599A)
ISA Certified Tree Risk Assessor (159)

On-Site Trees	Number of Trees
Protected Trees Identified (on-site and shared trees, including trees within boulevards and proposed	420
streets and lanes, but excluding trees in proposed open space or riparian areas)	139
Protected Trees to be Removed	131
Protected Trees to be Retained (excluding trees within proposed open space or riparian areas)	8
Total Replacement Trees Required:	
- Alder & Cottonwood Trees Requiring 1 to 1 Replacement Ratio	
	209
- All other Trees Requiring 2 to 1 Replacement Ratio	
78 X two (2) = 156	
Replacement Trees Proposed	209
Replacement Trees in Deficit	0
Protected Trees to be Retained in Proposed [Open Space / Riparian Areas]	
Off-Site Trees	Number of Trees
Protected Off-Site Trees to be Removed	
Total Replacement Trees Required:	
- Alder & Cottonwood Trees Requiring 1 to 1 Replacement Ratio	
<u>15</u> X one (1) = 15	27
- All other Trees Requiring 2 to 1 Replacement Ratio	
6 X two (2) = 12	
Replacement Trees Proposed	0
Replacement Trees in Deficit	27

Summary prepared and submitted by:		Monflathbur	March, 19, 2015
	Arborist		Date

Proposed NCP amendment

7915-0087-00

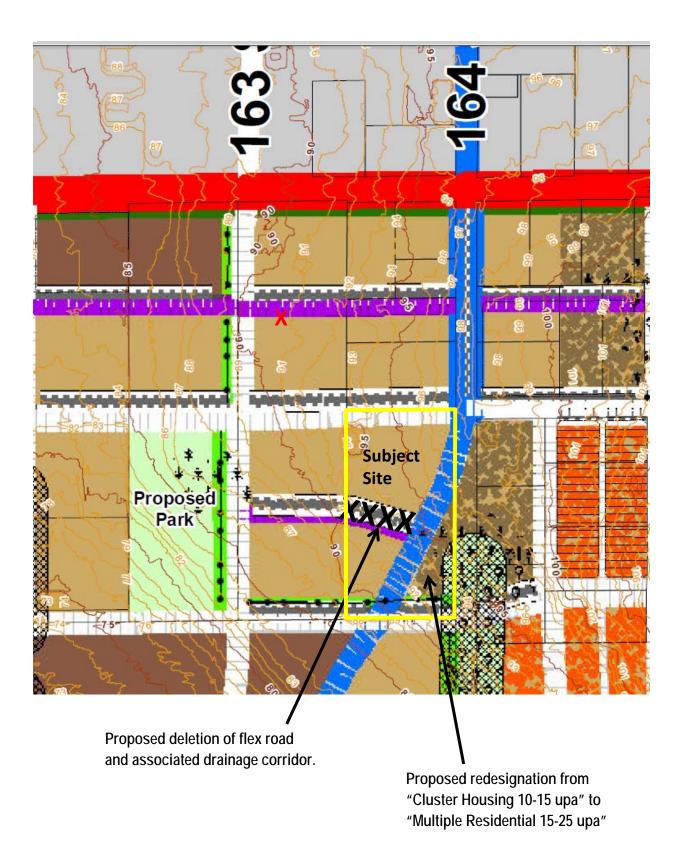

CITY OF SURREY

(the "City")

DEVELOPMENT VARIANCE PERMIT

NO.: 7915-0087-00

Issued To: Pamela and William Bray

("the Owner")

Address of Owner: 2215 - 164 Street

Surrey, BC V₃S oL8

- 1. This development variance permit is issued subject to compliance by the Owner with all statutes, by-laws, orders, regulations or agreements, except as specifically varied by this development variance permit.
- 2. This development variance permit applies to that real property including land with or without improvements located within the City of Surrey, with the legal description and civic address as follows:

Parcel Identifier: 011-101-831 Parcel "A" (H68728E) Lot 7 Section 13 Township 1 New Westminster District Plan 5524 2215 - 164 St

(the "Land")

3. (a) As the legal description of the Land is to change, the City Clerk is directed to insert the new legal description for the Land once title(s) has/have been issued, as follows:

Parcel Identifier:

(b) If the civic address(es) change(s), the City Clerk is directed to insert the new civic address(es) for the Land, as follows:


- 4. Surrey Zoning By-law, 1993, No. 12000, as amended is varied as follows:
 - (a) to reduce the minimum northerly setback of the RM-30 Zone from 7.5 metres (25 feet) to 4.5 metres (15 feet) along 23 Avenue;

- (b) to reduce the minimum easterly setback of the RM-30 Zone from 7.5 metres (25 feet) to 4.5 metres (15 feet) along the proposed new 164 Street alignment and to 3.7 metres (12 feet) along the existing 164 Street alignment;
- (c) to reduce the minimum southerly setback of the RM-30 Zone from 7.5 metres (25 ft.) to 3.0 metres (10 feet); and
- (d) to reduce the minimum westerly setback of the RM-30 Zone from 7.5 metres (25 ft.) to 6.0 metres (20 feet) adjacent to the neighbouring westerly parcel (with Building 11 permitted to have a 4.5 metre (15 feet) setback), and to 4.5 metres (15 feet) along the proposed new 164 Street alignment.
- 5. This development variance permit applies to only the portion of the buildings and structures on the Land shown on Schedule A which is attached hereto and forms part of this development variance permit. This development variance permit does not apply to additions to, or replacement of, any of the existing buildings shown on attached Schedule A, which is attached hereto and forms part of this development variance permit.
- 6. The Land shall be developed strictly in accordance with the terms and conditions and provisions of this development variance permit.
- 7. This development variance permit shall lapse if the Owner does not substantially start any construction with respect to which this development variance permit is issued, within two (2) years after the date this development variance permit is issued.
- 8. The terms of this development variance permit or any amendment to it, are binding on all persons who acquire an interest in the Land.
- 9. This development variance permit is not a building permit.

AUTHORIZING	RESOLUTIO	N PASSED	BY THE COUNCIL, THE	DAY OF	, 20 .
ISSUED THIS	DAY OF	, 20 .			

Mayor – Linda Hepner	
City Clerk - Jane Sullivan	

Schedule A

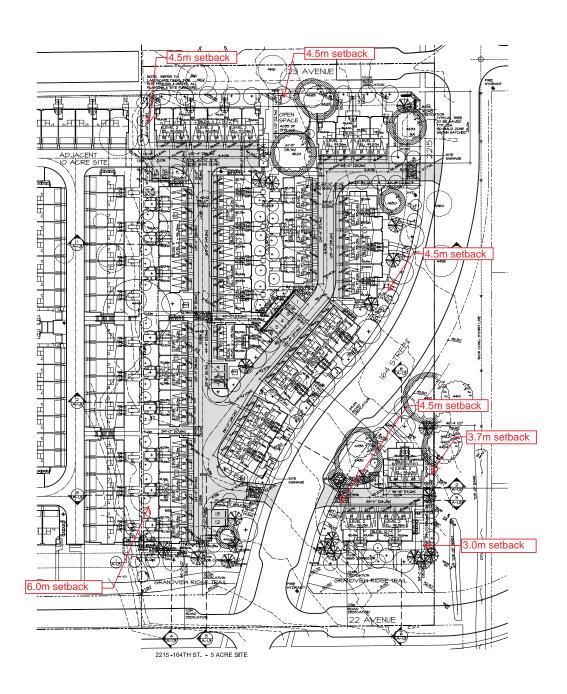

BERNARD DECOSSE ARCHITECT INC.

MULTI-FAMILY RESIDENTIAL DEVELOPMENT 2215 164TH STREET SURREY, BC

SHEET TITLE:

5 ACRE SITE PLAN



START DATE: APRIL 2014 SCALE: 1/32"=1"-0" REVISION NO.

A-1.1