#### City of Surrey PLANNING & DEVELOPMENT REPORT File: 7914-0324-00


Planning Report Date: October 1, 2018


**PROPOSAL:** 

- **Rezoning** from RF to CD (based on RM-30)
- Development Permit

to permit the development of 19 townhouse units.

LOCATION:	12869 - 111 Avenue
	12855 - 111 Avenue
	Portion of Road (128A Street)
ZONING:	RF
OCP DESIGNATION:	Urban
NCP DESIGNATION:	Multiple Residential

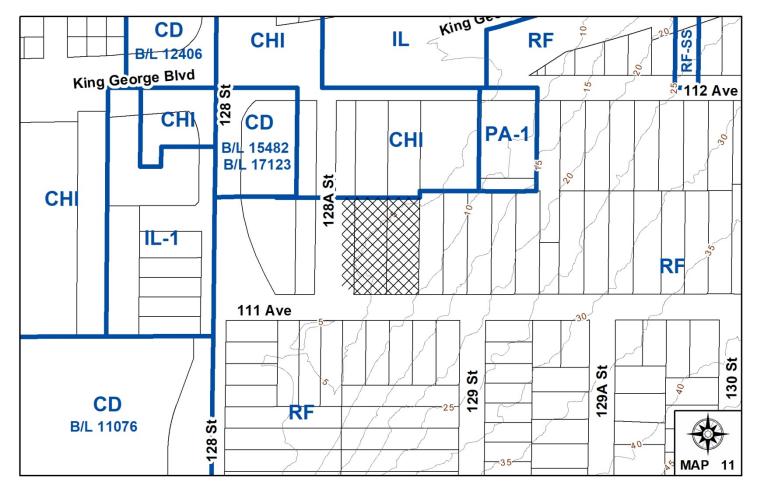

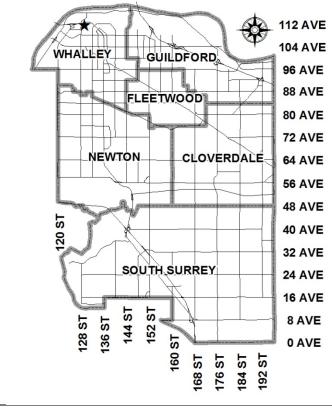

#### **RECOMMENDATION SUMMARY**

- By-law Introduction and set date for Public Hearing for Rezoning.
- Approval to eliminate indoor amenity space.
- Approval to draft Development Permit for Form and Character, Sensitive Ecosystems, and Hazard Lands.

#### DEVIATION FROM PLANS, POLICIES OR REGULATIONS

• None

#### **RATIONALE OF RECOMMENDATION**

- The proposal complies with the Multiple Residential designation in the South Westminster Neighbourhood Concept Plan.
- The proposal complies with the Official Community Plan's Urban designation.
- Allocates a portion of the eastern side of the site for a Green Infrastructure Network (GIN) corridor, as identified in the Biodiversity Conservation Strategy.
- The proposed density and building form are appropriate for this part of South Westminster given the proximity to Scott Road SkyTrain Station.
- The proposed setbacks achieve a more urban, pedestrian-oriented streetscape that will enhance the urban context.

#### **RECOMMENDATION**

The Planning & Development Department recommends that:

- 1. A By-law be introduced to rezone the subject site and portion of road (128A Street) shown as Block A on the survey plan attached in Appendix II from "Single Family Residential Zone (RF)" to "Comprehensive Development Zone (CD)" and a date be set for Public Hearing.
- 2. Council approve the applicant's request to eliminate the required indoor amenity space.
- 3. Council authorize staff to draft Development Permit No. 7914-0324-00 generally in accordance with the attached drawings (Appendix II).
- 4. Council instruct staff to resolve the following issues prior to final adoption:
  - (a) ensure that all engineering requirements and issues including restrictive covenants, dedications, and rights-of-way where necessary, are addressed to the satisfaction of the General Manager, Engineering;
  - (b) submission of a subdivision layout to the satisfaction of the Approving Officer;
  - (c) submission of a finalized tree survey and a statement regarding tree preservation to the satisfaction of the City Landscape Architect;
  - (d) submission of a finalized landscaping plan and landscaping cost estimate to the specifications and satisfaction of the Planning and Development Department;
  - (e) the applicant satisfy the deficiency in tree replacement on the site, to the satisfaction of the Planning and Development Department;
  - (f) resolution of all urban design issues to the satisfaction of the Planning and Development Department;
  - (g) completion of the road closure and acquisition of a portion of 128A Street;
  - (h) registration of a Section 219 Restrictive Covenant to specifically identify the allowable tandem parking arrangement and to prohibit the conversion of the tandem parking spaces into livable space;
  - (i) registration of a Section 219 Restrictive Covenant to adequately address the City's needs with respect to public art, to the satisfaction of the General Manager Parks, Recreation and Culture;
  - (j) the applicant adequately address the impact of no indoor amenity space;
  - (k) address all requirements from Metro Vancouver with respect to the on-site Greater Vancouver Sewer & Drainage District right-of-ways;
  - (l) registration of a Section 219 Restrictive Covenant to restrict habitable floor area below the minimum Flood Construction Level (FCL) and to inform current and

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future owners that the subject property is located within a flood plain area and that any buildings or structures constructed upon the lot may be damaged by flooding or erosion;

- (m) submission of a finalized geotechnical report; and
- (n) registration of a Section 219 Restrictive Covenant that requires the Owner to develop the site in accordance with the Geotechnical Assessment Report.

#### **REFERRALS**

Engineering:	The Engineering Department has no objection to the project subject to the completion of Engineering servicing requirements as outlined in Appendix III.
School District:	Projected number of students from this development:
	5 Elementary students at K.B. Woodward School 2 Secondary students at Kwantlen Park School
	(Appendix IV)
	The applicant has advised that the dwelling units in this project are expected to be constructed and ready for occupancy by Spring/Summer 2020.
Parks, Recreation & Culture:	Parks supports the conveyance of land for GIN corridor purposes.
Surrey Fire Department:	No concerns.
Metro Vancouver:	Metro Vancouver has reviewed and granted preliminary approval to the site plan provided that Metro Vancouver's sanitary sewer is not impacted during site investigations, construction and post- construction.

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#### SITE CHARACTERISTICS

Existing Land Use: Vacant, treed site encumbered by the Metro Vancouver sanitary sewer ROW.

#### Adjacent Area:

Direction	Existing Use	OCP/NCP	Existing Zone
	-	Designation	_
North:	Vehicle Sales	Urban in OCP /	CHI
		Multiple	
		Residential in NCP	
East:	Single Family	Urban in OCP (not	RF
	Housing	in NCP)	
South (Across 111 Avenue):	Single Family	Urban in OCP (not	RF
	Housing	in NCP)	
West (Across 128A Street):	Vacant site under	Mixed	RF
	application to	Employment in	
	rezone from RF to	OCP / Highway	
	CHI to permit the	Commercial in	
	development of	NCP	
	two commercial		
	buildings.		

#### **DEVELOPMENT CONSIDERATIONS**

#### **Background**

- The vacant 0.38-hectare (0.9-acre) subject property is located on the northeast corner of 111 Avenue and 128A Street.
- A Metro Vancouver Right-of-Way containing the North Surrey Interceptor Sewer Main traverses the site.
- The subject property is designated Urban in the Official Community Plan (OCP) and is currently zoned "Single Family Residential Zone (RF)".
- The preferred land use designation for the subject site is Multiple Residential in the South Westminster Neighbourhood Concept Plan (NCP).

#### Current Proposal

• The applicant is proposing to rezone the subject property and portion of adjacent road allowance from "Single Family Residential Zone (RF)" to "Comprehensive Development Zone (CD)" (based on the RM-30 Zone), and Development Permits (DPs) for the development of 19 townhouse units.

Staff Report to Council

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- An unutilized portion of road allowance (722 m<sup>2</sup>) abuts the subject site to the west. The City's Transportation Division confirms that the portion of road allowance is not required and as such, it is proposed to be incorporated into the subject development.
- The northernmost 6 metres (20 ft.) of the subject site (362 m<sup>2</sup>) is proposed to be dedicated to the City as a greenway, linking 128A Street with the planned Green Infrastructure Network (GIN) corridor and, through redevelopment, to Poplar Park to the east. The applicant has also volunteered to convey to the City without compensation the southeast portion of the land (823 m<sup>2</sup>) identified as a GIN corridor as shown in the Official Community Plan. Also road dedication towards the ultimate width of 111 Avenue (98 m<sup>2</sup>) will be provided.
- After land acquisitions and road dedications, the developable site area is proposed to be 0.26 hectares (0.63 ac.). This developable area also takes into account the undevelopable Metro Vancouver (GVWSSD) right-of-way which encumbers the subject site. The undevelopable area is excluded for the purposes of calculating Floor Area Ratio (FAR) but can be used for the provision of outdoor amenity space and parking.
- The net density for the proposed 19-unit townhouse development is 74 units per hectare (19 units per acre) with a floor area ratio (FAR) of 1.09. The gross unit density for the proposed development is 46.9 units per hectare (18.97 units per acre) with a gross FAR of 0.69.
- The proposed unit density, complies with the maximum density of the Urban Designation of the OCP for sites within an NCP area. The proposal also meets the maximum unit density requirements of the RM-30 Zone which the CD Bylaw for the proposed development will be based upon. The proposed FAR of 1.09 is higher than FAR of 1.0 that the RM-30 zone typically would permit, due to the requirement to discount the undevelopable portion of the site.

#### Policy Considerations

- The subject site is designated Urban in the Official Community Plan which supports a density of up to 72 units per hectare (30 units per acre) within approved Secondary Plan areas.
- The proposed development is supported by the following policies of the Official Community Plan:
  - A1.3 Accommodate urban land development according to the following order of growth management priorities:
    - Serviced infill areas and redevelopment sites in appropriate locations within existing residential neighbourhoods, when developed compatibly with existing neighbourhood character.

(The proposed development is located in a well-serviced area and will help to create a compatible transition between the commercial/industrial development to the west and the residential development to the east.

• A3.3 – require development and infill development to contribute to neighbourhood connectivity and walkability and to enhance public opens spaces and greenspaces within existing neighbourhoods.

(The applicant will be required to construct new sidewalks along 111 Avenue and 128A Street in addition to conveying land at the north end of the site for Greenway dedication, and land at the east side of the site as part of the GIN corridor, enhancing the pedestrian environment and creating new greenspaces in the neighbourhood.)

 A3.4 – Retain existing trees and natural and heritage features in existing neighbourhoods where possible, in order to preserve neighbourhood character and ecology.

(The existing trees in the GIN corridor, outside of the Metro Vancouver ROW, that is to be conveyed to the City will have invasive species removed and all existing trees are to be retained.)

 B4.6 – Direct higher residential densities to locations within walking distance of neighbourhood centres, along main roads, near transit routes and adjacent to major parks or civic amenities.

(The subject site is located along an arterial roadway and is within walking distance to Scott Road Skytrain Station and its associated bus loop which is serviced by 6 TransLink routes.)

• B4.7 – Design housing units to front directly onto public streets and/or public spaces, in order to facilitate a safe, welcoming, public streetscape and public realm.

(The townhouse units adjacent to 111 Avenue and 128A Street will be required to front directly onto those respective streets.)

• B4.9 – Plan for housing units to front onto riparian and green areas, where possible, to increase visibility into those areas and to increases the amenity features for those residents.

(The townhouse units adjacent to the proposed greenway and GIN area will be required to front directly towards those respective areas.)

 D1.4 – Preserve riparian areas and watercourses in their natural state and link them with upland natural areas to develop a connected network of natural areas throughout Surrey

(The proposed development includes the voluntary conveyance of land required to complete the City's envisioned Green Infrastructure Network.)

 D2.9 – Permit development in areas subject to flood hazards only when it is demonstrated by a Qualified Professional that the proposal meets current flood protection requirements, at the time of development, with respect to proposed uses, building materials, and required building elevations. A Save Harmless Covenant indemnifying the City is required for all development within flood prone areas.

(All proposed habitable space has been demonstrated to be above FCL and the applicant will be required to register a Restrictive Covenant to restrict habitable floor area below the minimum Flood Construction Level (FCL) and to inform current and future owners that the subject property is located within a flood plain area.)

• The subject site is located in the South Westminster NCP area and is designated as Multiple Residential. The site is also located within the NCP's Transit-Oriented Urban Village area which encourages compact developments that facilitate and encourage the use of transit and the creation of a pedestrian and cycle friendly environment.

(The proposed development is multiple-unit, compact, and will house more residents in the vicinity of Scott Road SkyTrain Station. The proposed development will also include upgrades to the pedestrian realm adjacent to the development.

#### Transportation Considerations

- The proposed development will have vehicular access off of 128A Street from the west and parking will be provided via garages incorporated into each individual dwelling. Two (2) of the 19 proposed units (10.5%) are proposed to utilize a tandem parking configuration and 4 visitor parking spaces are proposed to be provided, meeting the Zoning By-law No. 12000's minimum parking requirements.
- As part of the development, the applicant is being required to construct 111 Avenue and 128A Street along the property lines to their respective road standards and the applicant will also be required to improve the pedestrian realm adjacent to the development through the installation of sidewalks along 111 Avenue and 128A Street, street lighting, and street trees.
- The proposed development is located approximately 90 metres (295 ft.) from the east/west cycle route that runs along the King George Boulevard multi-use pathway and approximately 750 metres (0.46 mi.) from the north/south 132 Street cycle route.
- The subject site is approximately a 900 metre (0.55 mi.) walk from Scott Road SkyTrain Station and its associated bus loop, which is serviced by 6 TransLink routes.

#### PROPOSED CD BY-LAW

- The proposal is to rezone the site from "Single Family Residential Zone (RF)" to "Comprehensive Development Zone (CD)" based on the "Multiple Residential 30 Zone (RM-30)"to accommodate a 19 unit townhouse development.
- The proposed CD By-law will utilize the permitted uses of the RM-30 Zone.

• The following table provides a comparison between the other requirements of the RM-30 Zone and the proposed CD By-law:

	RM-30	Proposed CD By-law
FAR	1.0	1.1
Unit Density	75 unit per hectare (30 u.p.a.)	75 unit per hectare (30 u.p.a.)
Lot Coverage	45%	49%
Principal Building Setbacks	7.5 metres (25 ft.) from all lot lines	<ul> <li>4.0 metres (13 ft.) to the front yard (south) lot line</li> <li>4.0 metres (13 ft.) to the rear yard (north) lot line</li> <li>4.0 metres (13 ft.) to the side yard (east) lot line</li> <li>5.0 metres (16 ft.) to the side yard (east) lot line</li> </ul>
Indoor Amenity Area	3.0 square metres (32 sq. ft.) per dwelling unit	Cash-in-lieu

- The maximum permitted FAR and lot coverage have been increased to reflect the impact of the undevelopable area within Metro Vancouver's Sanitary Sewer Right-of-Way on the project.
- The reduced setbacks along the north, south, and east yards are supportable as they bring the units closer to the street or open spaces, which will allow better engagement with the public realm. These setbacks are also consistent with similarly approved setbacks for other townhouse developments in the City.

#### DEVELOPMENT PERMITS FOR SENSITIVE ECOSYSTEMS AND HAZARD LANDS

• The proposed development is located in both Sensitive Ecosystems (Green Infrastructure Network) and Hazard Lands (Steep Slope and Flood Prone Areas) Development Permit Areas.

#### Sensitive Ecosystem Development Permit – Green Infrastructure Area

- The subject site is traversed by a GIN corridor identified in the City's Official Community and Biodiversity Conservation Strategy.
- To meet the Development Permit requirements, the applicant commissioned an Ecosystem Development Plan for the site.
- The Ecosystem Development Plan, prepared by Tracy Anderson, B.Sc., R.P. Bio of Envirowest Consultants Inc. and dated July 23, 2018 proposes the removal of the existing invasive species and replanting with native shrub species. Staff have requested that all mature trees in the GIN corridor that are outside of the Metro Vancouver ROW be retained.
- The applicants are proposing to convey the GIN corridor to the City through the proposed application, without compensation.

#### Hazard Lands Development Permit - Steep Slopes / Flood Prone Areas

- The site is located in the Hazard Land Development Permit area for Steep Slopes and Flood Prone Areas.
- A geotechnical report, prepared by Anthony Yam, M.A.Sc., P. Eng. of Tony Yam Engineering ltd. and dated April 6,2012 outlines the site's conditions and generally how construction should proceed. Prior to Final Approval, the applicant will be required to submit a finalized geotechnical report and to register a Restrictive Covenant requiring the applicant to develop the site in accordance with that report.
- The applicant has demonstrated that all habitable floor area is above the Fraser River Flood Construction Level (FCL). A Restrictive Covenant to prohibit habitable floor area below the FCL and to inform current and future owners that the subject property is located within a flood plain area.

#### **PRE-NOTIFICATION**

Pre-notification letters were sent on February 24, 2016 and again with an updated version on August 20, 2018. Staff have not received any concerns in response to the pre-notification letters.

#### DESIGN PROPOSAL AND REVIEW

- The proposed 19-unit townhouse project consists of four (4), three-storey buildings with garages accessed internally at grade.
- All unit are proposed to contain three (3) bedrooms.
- Seventeen (17) of the townhouse units will feature double car, side-by-side garages. Two (2) tandem garage units are proposed.
- The proposed townhomes feature strong vertical elements giving the individual units a distinctive definition. The proposed building materials include hardie panel/plank siding, and exterior stone veneer.
- The proposed unit doors and fascias will utilize natural red cedar.
- The individual units will have access to private outdoor amenity areas at ground-level and will all front onto a public street, greenway, or the development's proposed outdoor amenity area.

#### Amenity Area

- The RM-30 Zone requires 57 square metres (614 sq. ft.) of indoor amenity space and 57 square metres (614 sq. ft.) of outdoor amenity space.
- The applicant proposes approximately 323.4 square metres (3,481 sq. ft.) of outdoor amenity space, which exceeds the minimum typically required under the RM-30 Zone.

- The outdoor amenity area, which utilizes the undevelopable area of the Metro Vancouver ROW, features benches, stepping logs and rounded boulders as natural play elements, a play area, and a number of small grassed areas.
- Given the size of the proposed townhouse development (19 units) as well as the constraints of the site, the applicant does not propose any indoor amenity space and will provide a monetary contribution of \$22,800 (based on \$1,200 per unit) in accordance with City policy to address this shortfall. The subject site is within close proximity to the future North Surrey Sport and Ice Complex, which will offer quality services and amenity space.

#### **Landscaping**

- The landscaping for the site includes corner plazas, benches, opens space, a variety of shade trees, shrubs, and decorative concrete paving.
- The fencing to delineate between the development's outdoor amenity area and the GIN corridor will consist of a horizontal rail aluminum fence that will be permeable to wildlife utilizing the corridor.

#### <u>TREES</u>

• Trevor Cox, ISA Certified Arborist of Diamond Head Consulting Ltd. prepared an Arborist Assessment for the subject property. The table below provides a summary of the tree retention and removal by tree species:

Table 1:	Table 1: Summary of Tree Preservation by Tree Species:				
	Tree Species	Existing	Remove		

Tree Species	Existing	Remove	Retain	
Alder and Cottonwood Trees				
Red Alder (located in GIN)	3	0	3	
Cottonwood	14	14	0	
<b>Total</b> (excluding Alder and Cottonwood Trees)	17	14	3	
<b>Total Replacement Trees Proposed</b> (excluding Boulevard Street Trees)		36		
Total Retained and Replacement Trees		39		
Contribution to the Green City Fund		N/A		

• The Arborist Assessment states that there are no protected trees on the site, except for Alder and Cottonwood trees. Seventeen (17) existing trees, 100 % of the total trees on the site, are Alder and Cottonwood trees. It was determined that three (3) Alder trees can be retained as part of this development proposal. The proposed tree retention was assessed taking into consideration the location of services, building footprints, road dedication and proposed lot grading.

- For those trees that cannot be retained, the applicant will be required to plant trees on a 1 to 1 replacement ratio for the Cottonwood trees. This will require a total of fourteen (14) replacement trees on the site. The applicant is proposing thirty-six (36) replacement trees, exceeding City requirements.
- In addition to the replacement trees, boulevard street trees will be planted on 111 Avenue. This will be determined by the Engineering Department during the servicing design review process.
- The new trees on the site will consist of a variety of trees including Japanese Maples, Pacific Dogwood, Susan magnolia, and Douglas Fir species.
- In summary, a total of thirty-one (31) trees are proposed to be retained or replaced on the site with no contribution to the Green City Fund.

#### **BIODIVERSITY CONSERVATION STRATEGY**

- The City of Surrey Biodiversity Conservation Strategy (BCS) Green Infrastructure Network (GIN) map, adopted by Council on July 21, 2014 (Corporate Report No. R141; 2014), identifies a Regional BCS Corridor within the subject site, in the Newton BCS management area, with a Medium ecological value.
- The BCS further identifies the GIN area of the subject site as having a Moderate habitat suitability rating, derived from species at risk presence, species accounts and known ecosystem habitat inventories. The BCS recommends a target Corridor width of 50 meters.
- Protecting green infrastructure Hubs (large habitat areas) and Sites (smaller habitat areas) are critical to preserving natural habitat refuges and a diversity of habitat features while maintaining/enhancing Corridors ensures connectivity between fragmented hubs for genetic variation throughout the City.
- The development proposal conserves and enhances approximately 1,184 square meters (0.29 ac.) of the subject site through Parkland Conveyance. This method of GIN retention/enhancement will assist in the long term protection of the natural features and allows the City to better achieve biodiversity at this location consistent with the guidelines contained in the BCS.

#### SUSTAINABLE DEVELOPMENT CHECKLIST

The applicant prepared and submitted a sustainable development checklist for the subject site on August 16, 2018. The table below summarizes the applicable development features of the proposal based on the seven (7) criteria listed in the Surrey Sustainable Development Checklist.

Sustainability Criteria	Sustainable Development Features Summary
1. Site Context & Location	• The proposed development is located in the South Westminster Neighbourhood Concept Plan area.
(A1-A2)	<ul> <li>The proposed development is consistent with the NCP's Multiple</li> </ul>

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Sustainability	Sustainable Development Features Summary
Criteria	
	Residential designation.
	• The subject site is located within 900 metres (0.5 mi.)walking
	distance of a SkyTrain Station and multiple bus routes.
2. Density & Diversity	• The site plan can accommodate private community gardens adjacent
(B1-B7)	to the outdoor amenity area without impacting the GIN corridor.
3. Ecology &	• The development proposes to preserve and enhance the GIN corridor
Stewardship	through invasive species removal, native species replanting, and
(C1-C4)	conveyance to the City.
4. Sustainable	• Bicycle parking is provided.
Transport &	• A greenway is being dedicated along the north portion of the site
Mobility	which can accommodate a future multi-use path.
(D1-D2)	• The pedestrian environment adjacent to the subject site will be
	upgraded through the proposed development.
5. Accessibility &	• The proposed development consists of street-oriented housing that
Safety	provides "eyes on the street" along 111 Avenue, 128A Street, as well as
(E1-E3)	the greenway and the site's amenity areas.
6. Green Certification	• N/A
(F1)	
7. Education &	• The surrounding community was notified via a pre-notification letter
Awareness	and a Development Proposal Sign as required by the City.
(G1-G4)	• A Public Hearing will be required as part of the rezoning process.

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#### **INFORMATION ATTACHED TO THIS REPORT**

The following information is attached to this Report:

Appendix I.	Lot Owners, Action Summary (Confidential) and Project Data Sheets
Appendix II.	Survey Plan, Site Plan, Building Elevations, and Landscape Plans
Appendix III.	Engineering Summary
Appendix IV.	School District Comments
Appendix V.	Summary of Tree Survey and Tree Preservation
Appendix VI.	Proposed CD By-law
Appendix VII.	Aerial Photo of Subject Site

#### **INFORMATION AVAILABLE ON FILE**

- Geotechnical Study Prepared by Tony Yam Engineering Ltd. dated April 6, 2012
- Ecosystem Development Plan prepared by Envirowest Consultants Inc. dated September 17, 2018
- Complete Set of Architectural and Landscape Plans prepared by W G Architecture Inc. and PMG Landscape Architects, respectively, dated May 2018

original signed by Ron Gill

Jean Lamontagne General Manager Planning and Development

CW/cm

### APPENDIX I HAS BEEN

## **REMOVED AS IT CONTAINS**

**CONFIDENTIAL INFORMATION** 

#### **DEVELOPMENT DATA SHEET**

#### Proposed Zoning: CD (based on RM-30)

Required Development Data	Minimum Required / Maximum Allowed	Proposed
LOT AREA* (in square metres)		
Gross Total		3787 m <sup>2</sup>
Road Acquisition Area (128A Street)		$+722 \text{ m}^2$
Road Dedication Area (111 Avenue)		$-98 \text{ m}^2$
Greenway Dedication		- 362 m <sup>2</sup>
GIN Dedication		$-823 \text{ m}^2$
Undevelopable Area (MV ROW)		- 659 m <sup>2</sup>
Net Total		2567 m <sup>2</sup>
LOT COVERAGE (in % of net lot area)		
Buildings & Structures		~ 39%
Paved & Hard Surfaced Areas		~ 39%
Total Site Coverage		~ 78%
SETBACKS ( in metres)		
Front (south)		4.0 M
Rear (north)		4.0 m
Side (west)		4.0 m
Side (west)		<u>5 m</u>
BUILDING HEIGHT (in metres/storeys)		
Principal		11.8 m
Accessory		N/A
NUMBER OF RESIDENTIAL UNITS		
Bachelor		0
One Bed		0
Two Bedroom		0
Three Bedroom +		19
Total		19
FLOOR AREA: Residential		2808.6 m <sup>2</sup>
FLOOR AREA: Commercial		N/A
Retail		N/A
Office		N/A
Total		N/A
FLOOR AREA: Industrial		N/A
FLOOR AREA: Institutional		N/A
TOTAL BUILDING FLOOR AREA * If the development site consists of more than or		2808.6 m <sup>2</sup>

\* If the development site consists of more than one lot, lot dimensions pertain to the entire site.


Required Development Data	Minimum Required / Maximum Allowed	Proposed
DENSITY		
# of units/ha /# units/acre (gross)		46.9 uph /
		18.97 upa
# of units/ha /# units/acre (net)		74.02 uph /
		29.95 upa
FAR (gross)		0.69
FAR (net)		1.1
AMENITY SPACE (area in square metres)		
Indoor		Cash-In-Lieu
Outdoor		323.4 m <sup>2</sup>
PARKING (number of stalls)		
Commercial		N/A
Industrial		N/A
Residential		
Bachelor + 1 Bedroom		N/A
2-Bed		N/A
3-Bed	38	38
Residential Visitors	3	4
Institutional	N/A	N/A
Total Number of Parking Spaces	41	42
Number of disabled stalls	N/A	0
Number of small cars		2
Tandem Parking Spaces: Number / % of Total Number of Units		4 / 10.5%
Size of Tandem Parking Spaces width/length		4.66 m / 12 m


Heritage Site	NO	Tree Survey/Assessment Provided	YES

### MULTIPLE BUILDINGS DATA SHEET

#### Proposed/Existing Zoning RF / CD

Required Development Data	Building #1	Building #2	Building #3	Building #4
SETBACK (in metres)				
Front	21 M	4 m	21 M	51 M
Rear	21 M	52 m	21 M	4 m
Side (W)	4 m	4 m	22 M	4 m
Side (E)	42m	5 m	20M	11.5 M
BUILDING HEIGHT (in metres/storeys)	11.8 m / 3 Storeys	11.8 m / 3 Storeys	11.8 m / 3 Storeys	11.8 m / 3 Storeys
NUMBER OF RESIDENTIAL UNITS/	4	4	4	7
SIZE RANGE				
Bachelor	0	0	0	0
One Bedroom	0	0	0	0
Two Bedroom	0	0	0	0
Three Bedroom +	4	4	4	7
TOTAL FLOOR AREA	602.06 m <sup>2</sup>	602.13 m <sup>2</sup>	541.99 m <sup>2</sup>	1046.67 m <sup>2</sup>
		5.94 m <sup>2</sup> (Elec. Rm.)		9.8 m <sup>2</sup> (Elec. Rm.)

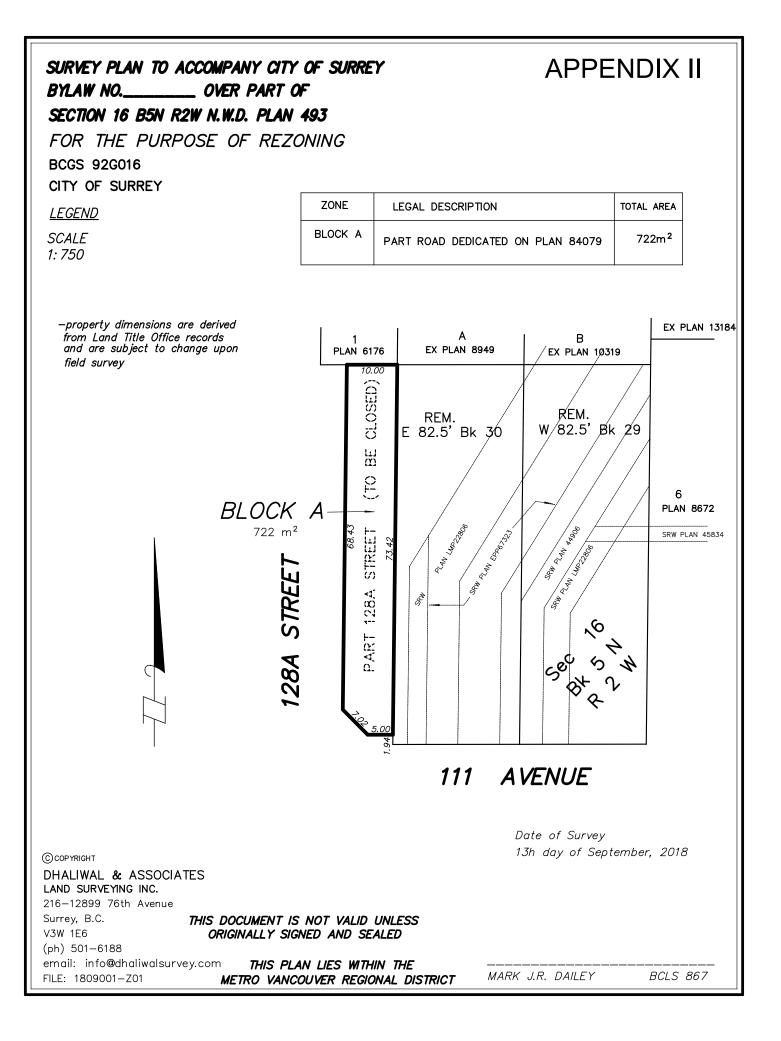

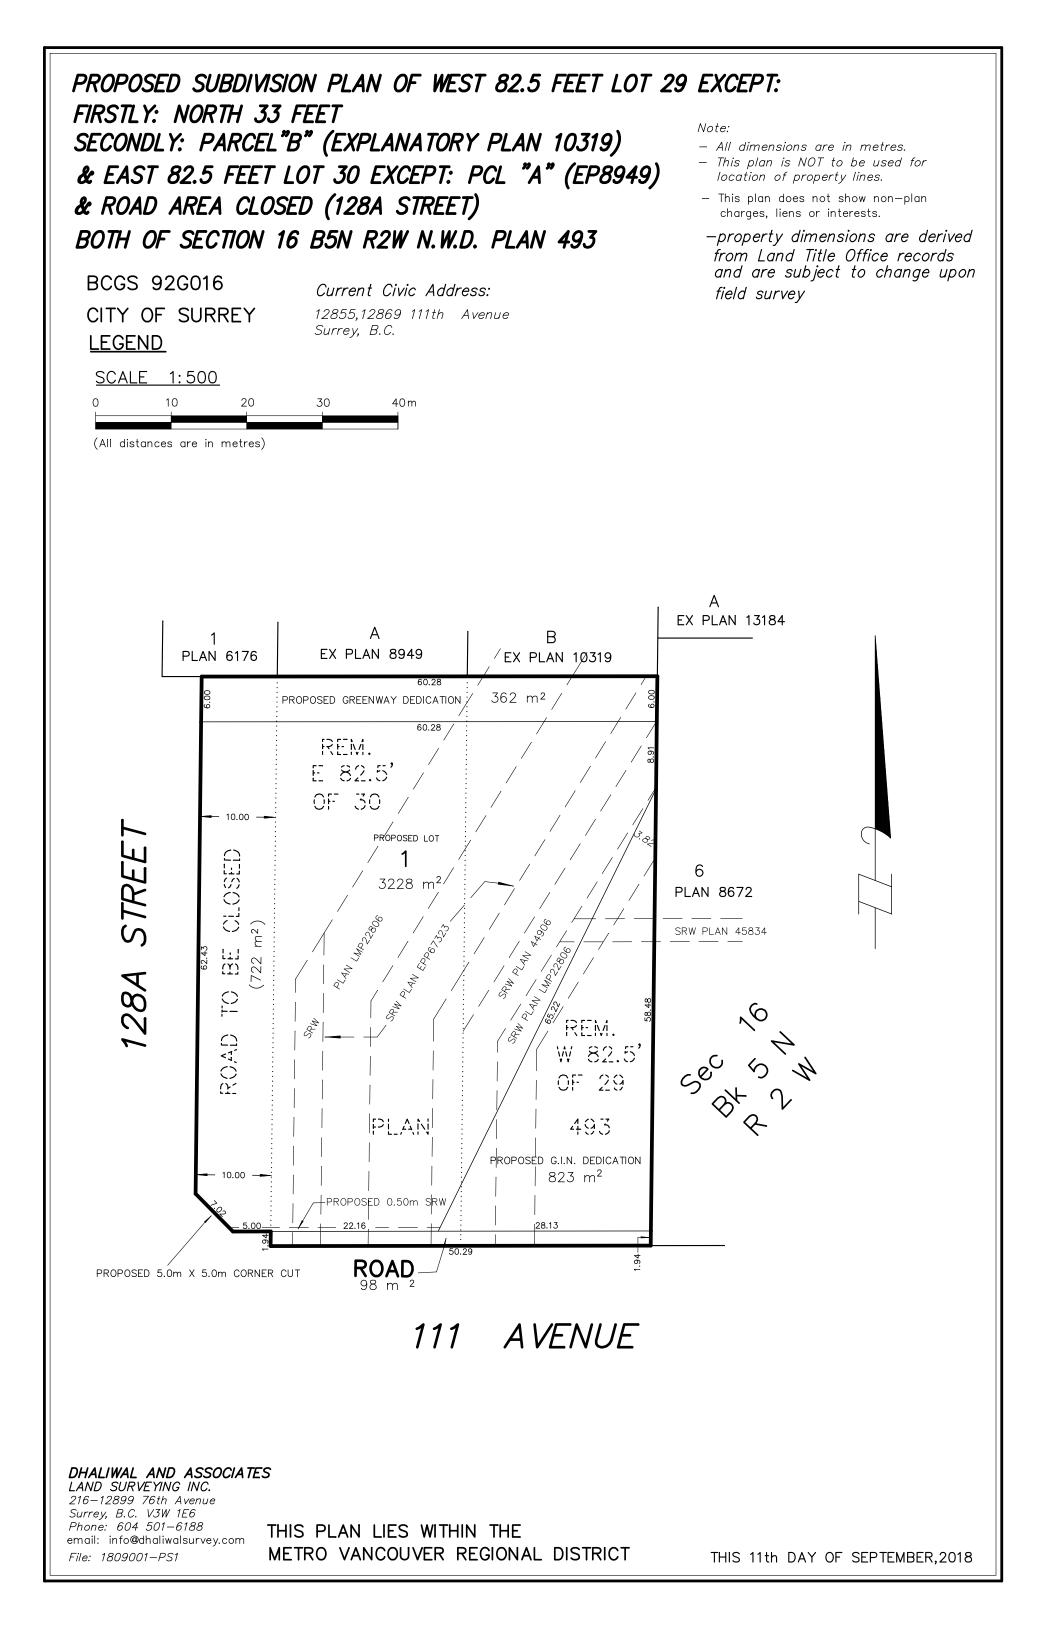

### FIRE FIGHTERS ACCESS

#### BUILDING #1

ALL UNITS INCLUDING UNIT #1 HAVE FIRE FIGHTERS ACCESS FROM 128A STREET DISTANCE FROM CURB IS LESS THAN 15m (10.5m AVERAGE)


#### BUILDING #2

ALL UNITS HAVE FIRE FIGHTERS ACCESS FROM 111 AVENUE DISTANCE FROM CURB IS LESS THAN 15m (11.0m AVERAGE)

#### BUILDING #3 & #4

FIRE FIGHTER'S ACCESS IS FROM FIRE TRUCK ACCESS ROUTE. DISTANCE TO UNITS LESS THEN 45m FIRE TRUCK ACCESS ROUTE SHORTER THAN 90m (50m) DOES NOT REQUIRE A TURN AROUND



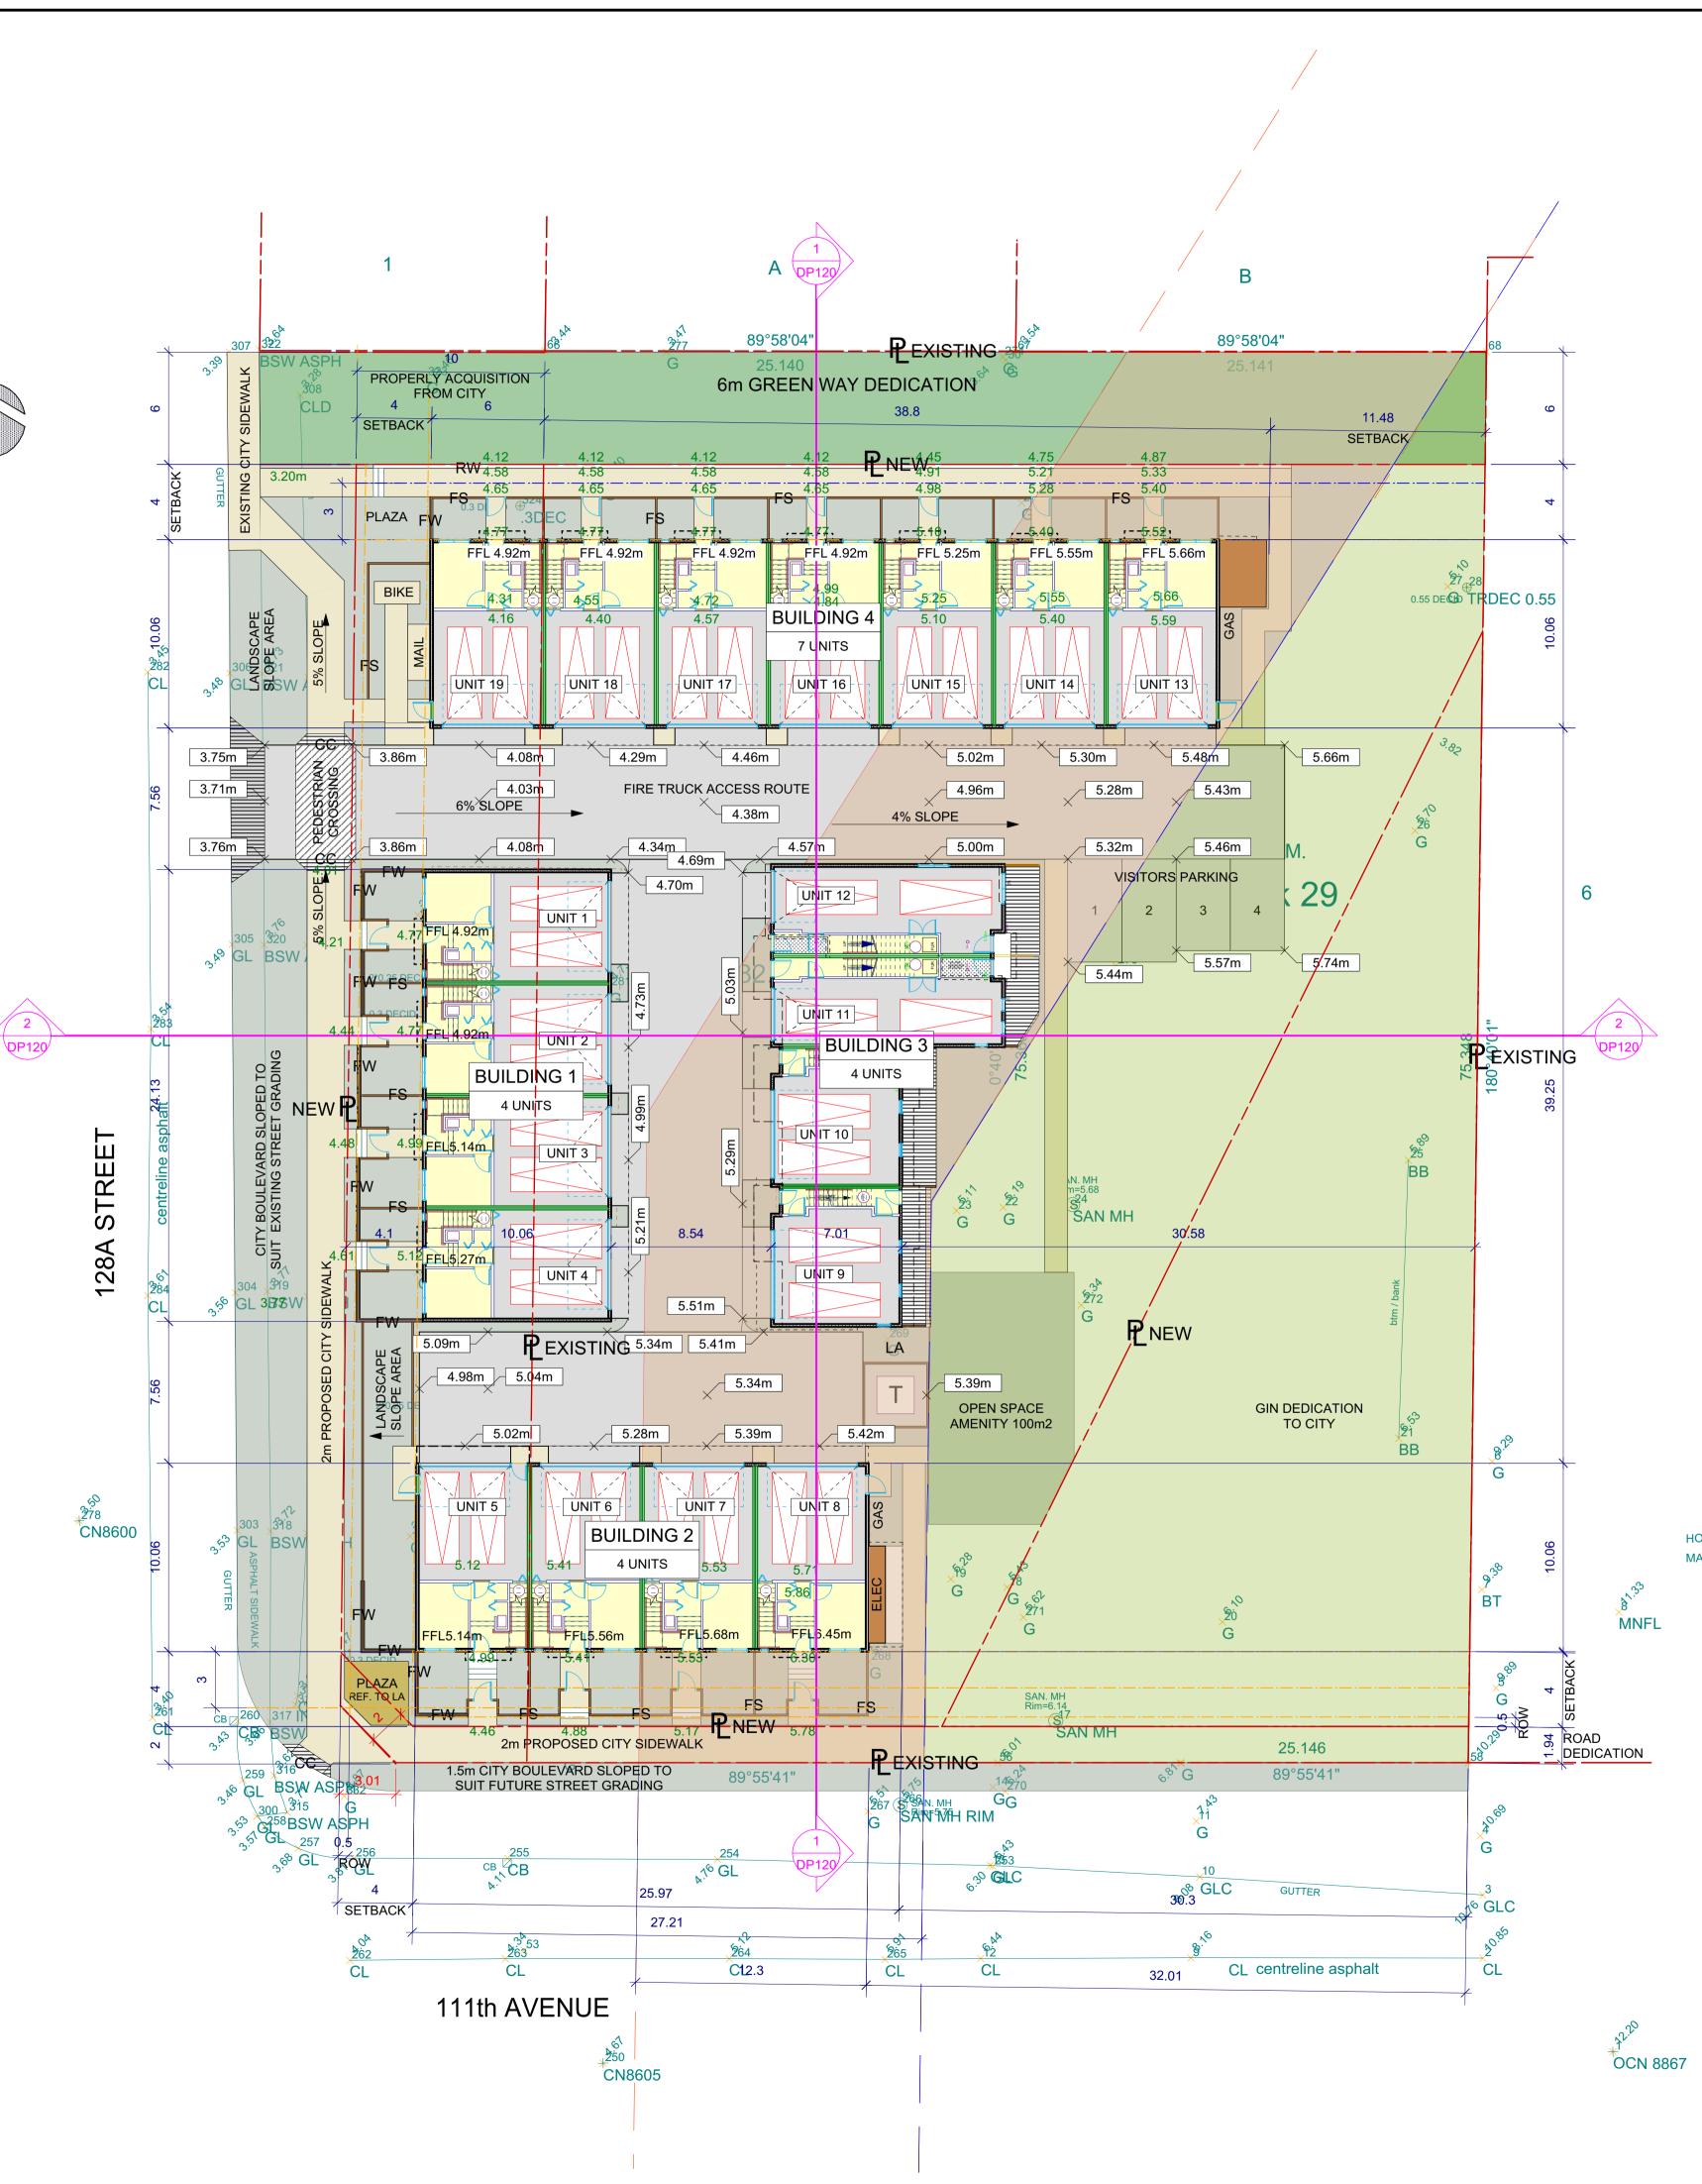

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#	Date		Revision Notes	
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GVRD ROW AREA - A

6m GREEN WAY DEDICATION

GVRD ROW AREA - B

### **PROJECT STATISTICS**

CIVIC ADDRESS 12855 + 12869 111th AVENUE SURREY, B.C.

### LOT AREA CALCULATIONS

EXISTING SITE AREA ROAD ACQUISITION- 10m FROM 128A St **GREEN WAY DEDICATION 6m** 111th. AVE. DEDICATION 1.94m GIN DEDICATION

3,787.10m2

+ 665.78m2

- 301.80m2

- 97.56m2 - 822.61m2

1,539.29 m2

NET LOT AREA 3230.90m2 =0.80 acre

NET DENSITY 23.75 UPA 58.80 UPH

GVRD AREA "A"

SETBACKS NORTH - 4.0 m - 4.0 m

SOUTH EAST - 21.4m WEST - 4.0 m

**BUILDING HEIGHT** 3 STOREYS BLDG.#2 - 11.80m (39'-8")

**BUILDING FLOOR AREA:** BUILDING 1 : 602.06 m2 BUILDING 2 : 602.13 m2

ELEC. RM.: 5.94 m2 BUILDING 3 : 541.99 m2 BUILDING 4 : 1,046.67 m2 ELEC. RM.: 9.80 m2 2,808.59 m2 TOTAL :

#### GROSS FAR 0.69 NET FAR 0.87

#### SITE COVERAGE: 1,253.52 m2 GROSS SITE COVERAGE 31% NET SITE COVERAGE 39%

NUMBER OF UNITS BUILDING #1: 4 (4 Double G.) BUILDING #2 : 4 (4 Double G.) BUILDING #3 : 4 (2 Double G. + 2 Tandem G) BUILDING #4 : 7 (7 Double G)

TOTAL 19 (2 Tandem G. + 17 Double G.)

#### **OFF - STREET PARKING** RESIDENTS

19 UNITS x 2 = 38

VISITORS REQUIRED:  $19 \times 0.2 = 3.8 (4)$ PROVIDED: TOTAL PARKING PROVIDED 42

### OUTDOOR AMENITY

REQUIRED 51sq.m. PROVIDED 100.00 sq.m.


LEGEND


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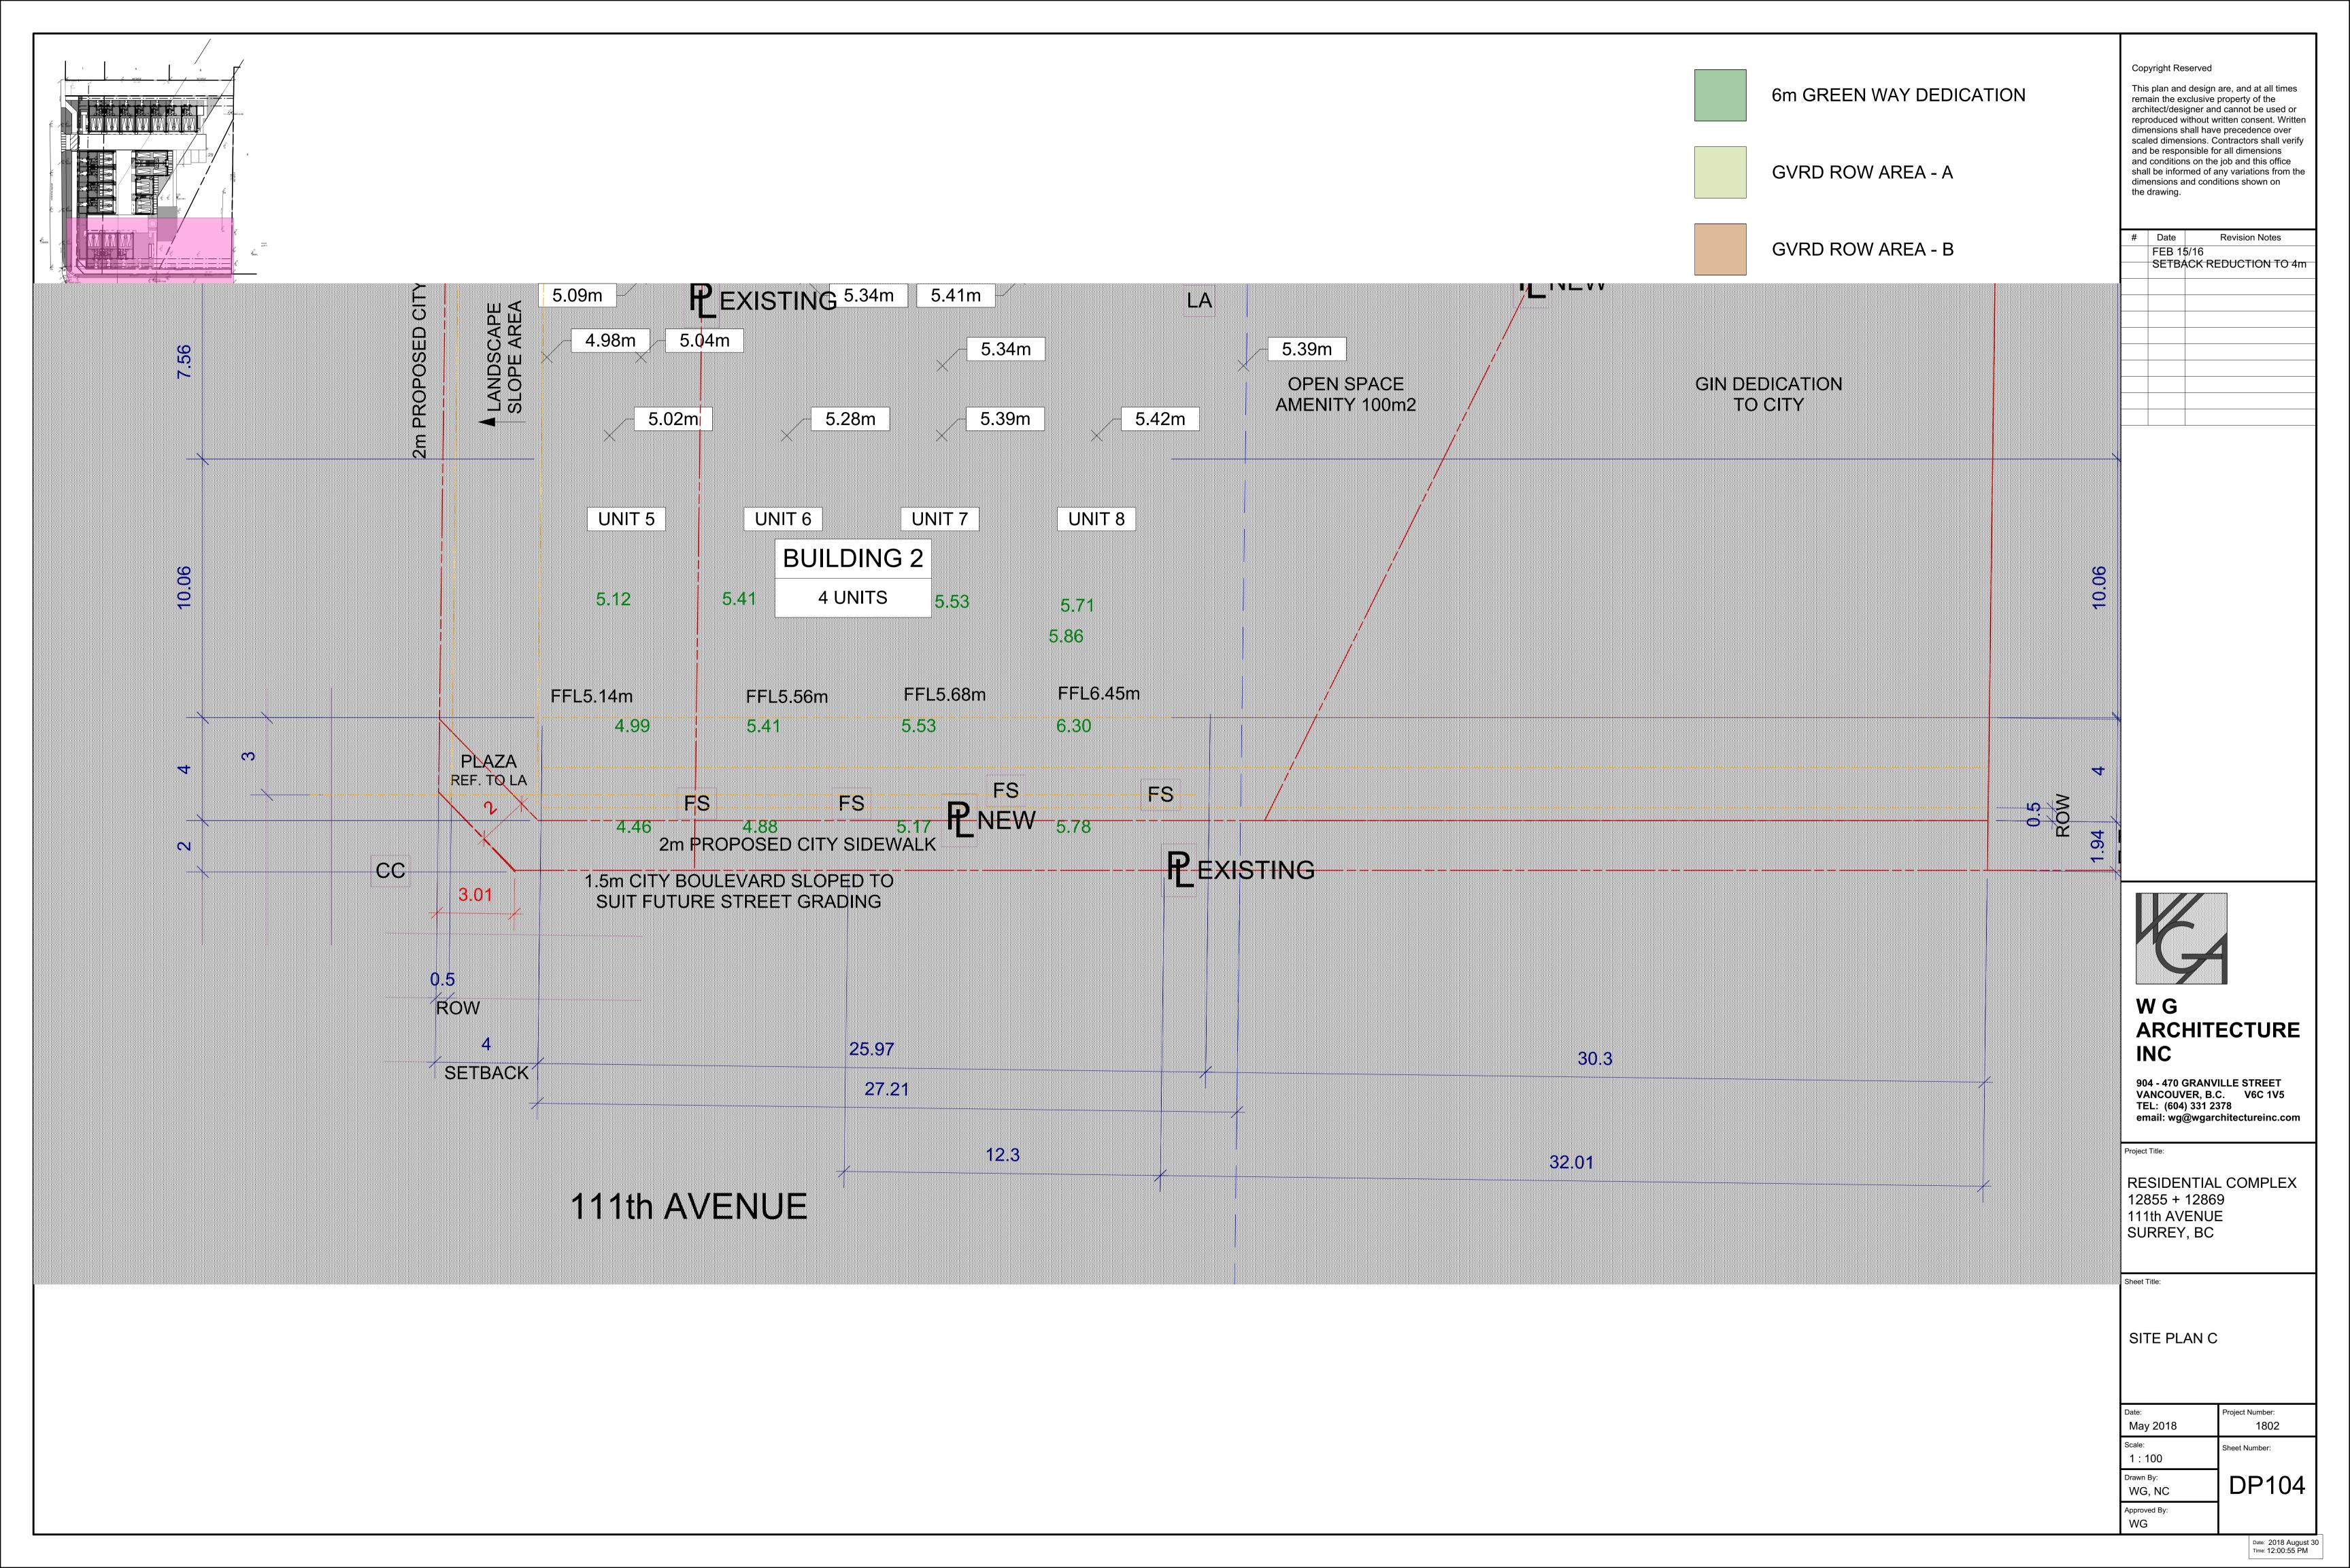
HOUSE 12883 MAIN FLOOR=11.33

> Date: 2018 August 30 Time: 12:00:50 PM

WG



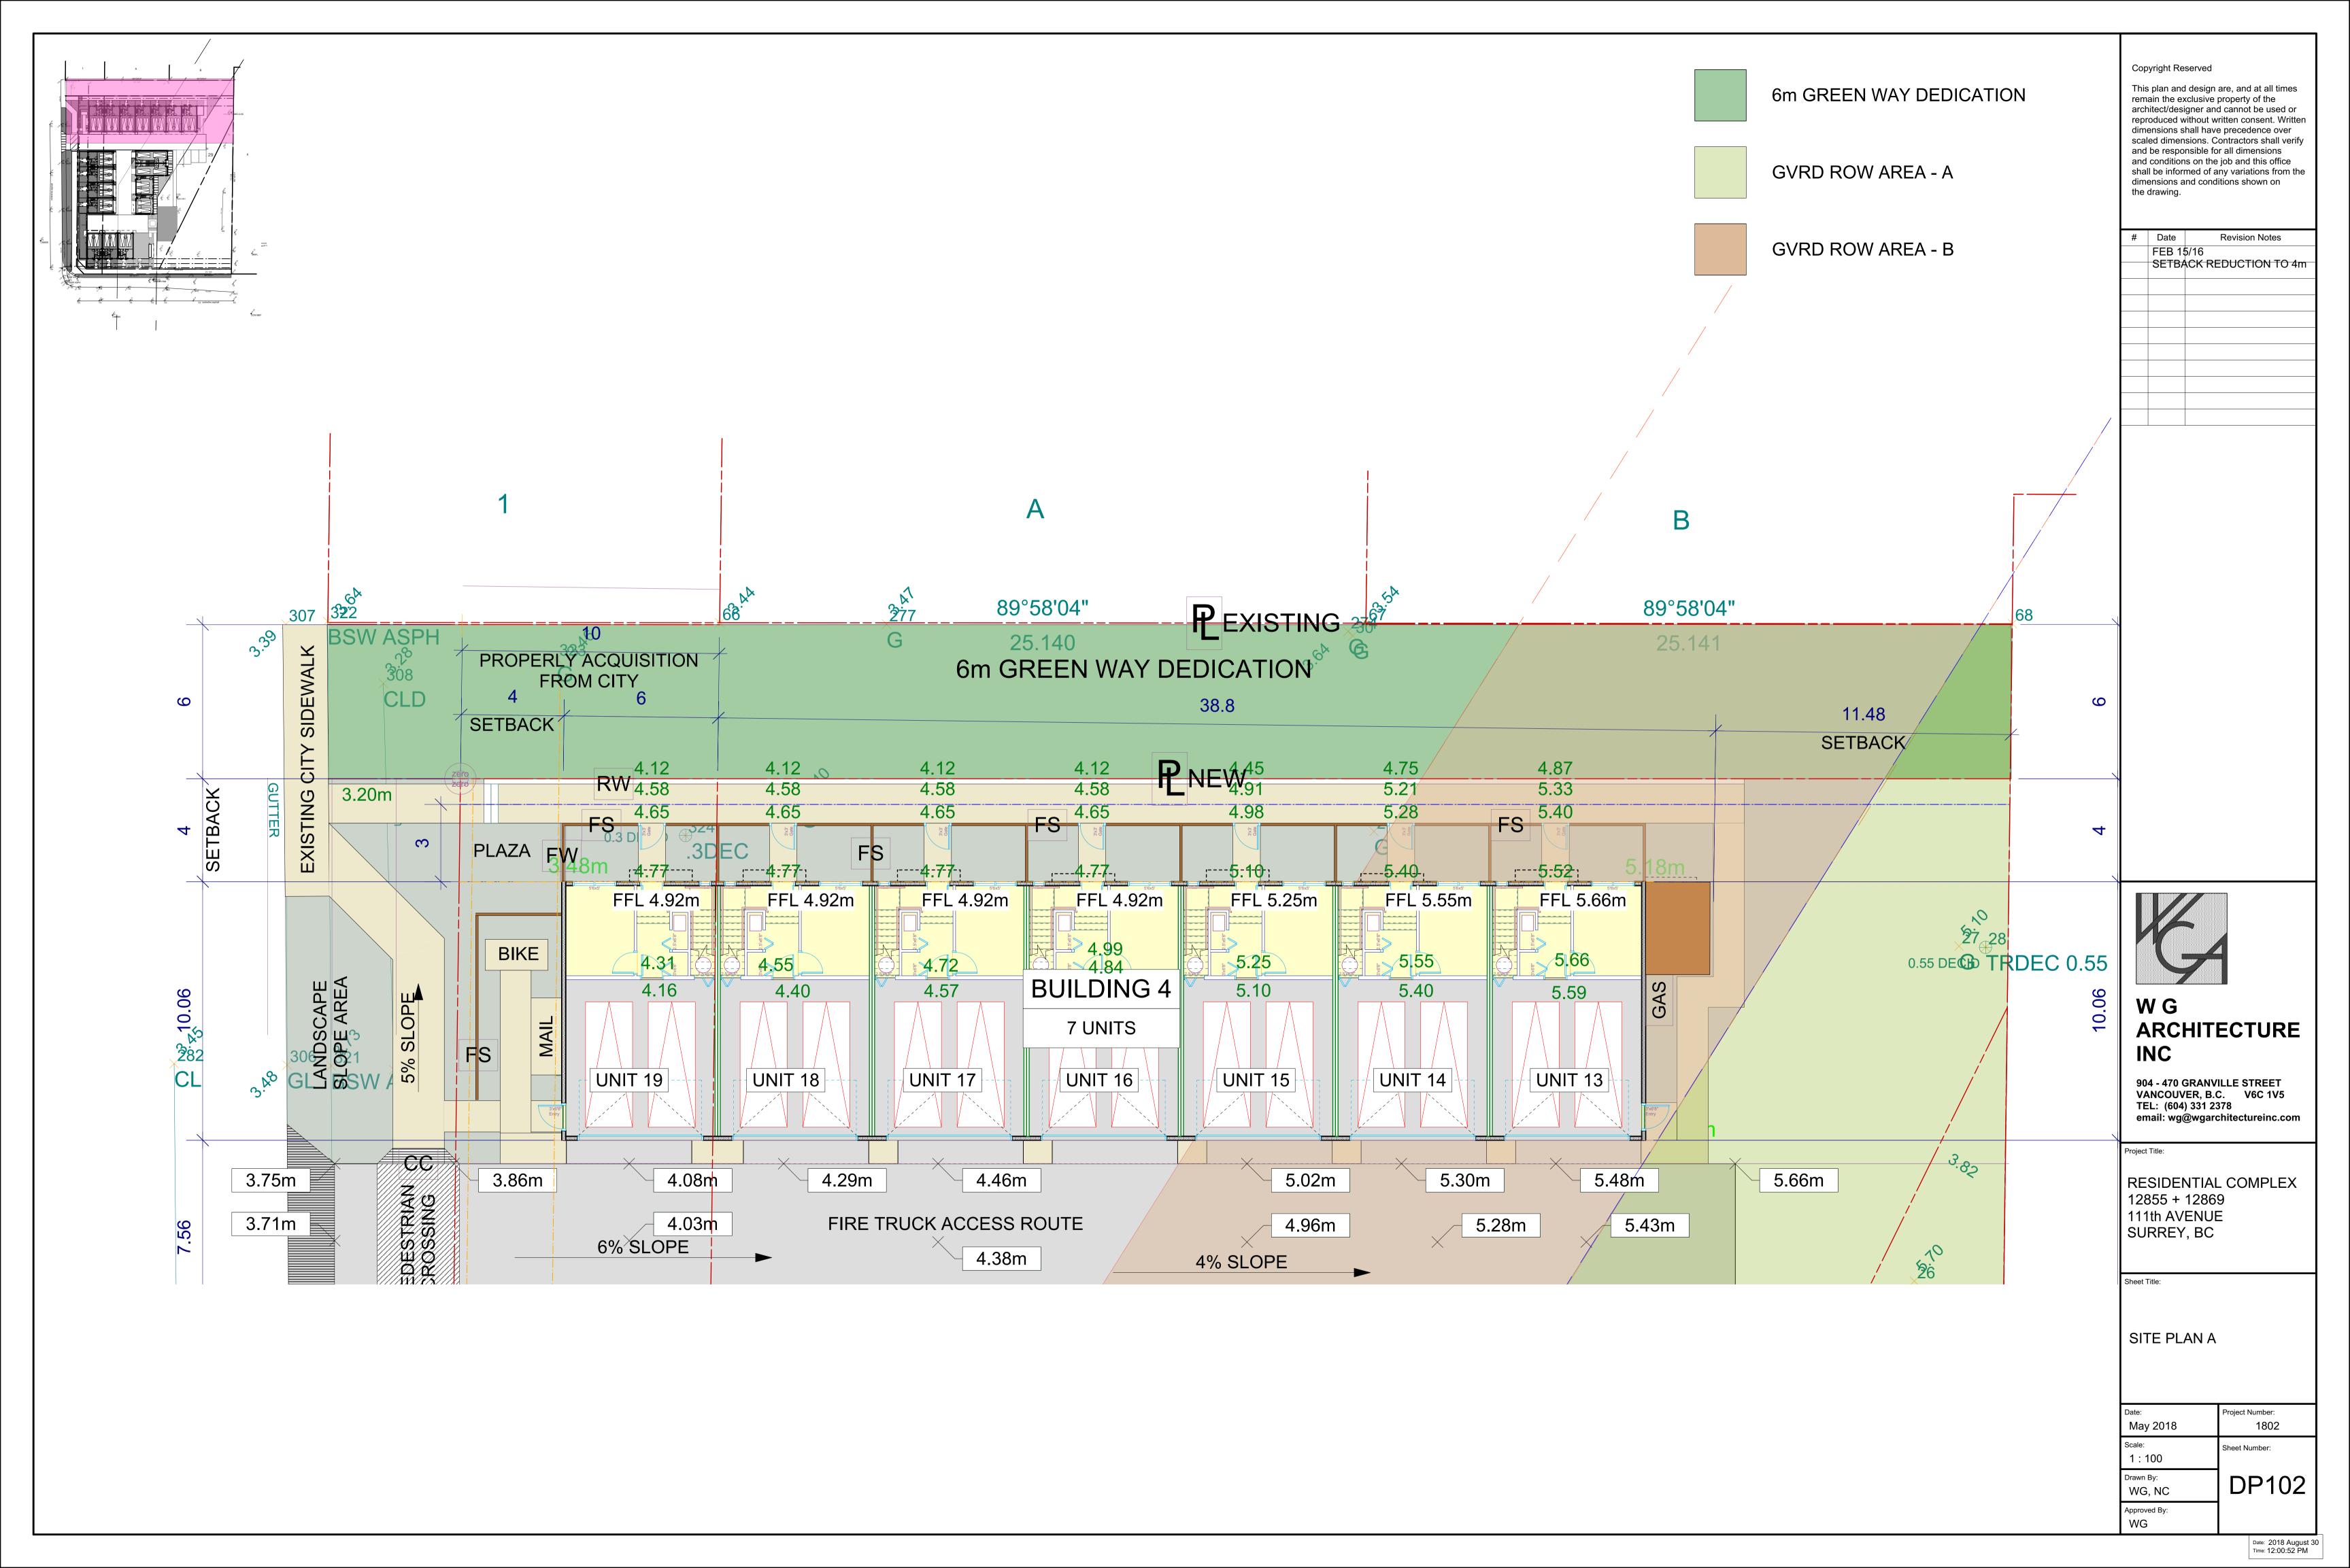

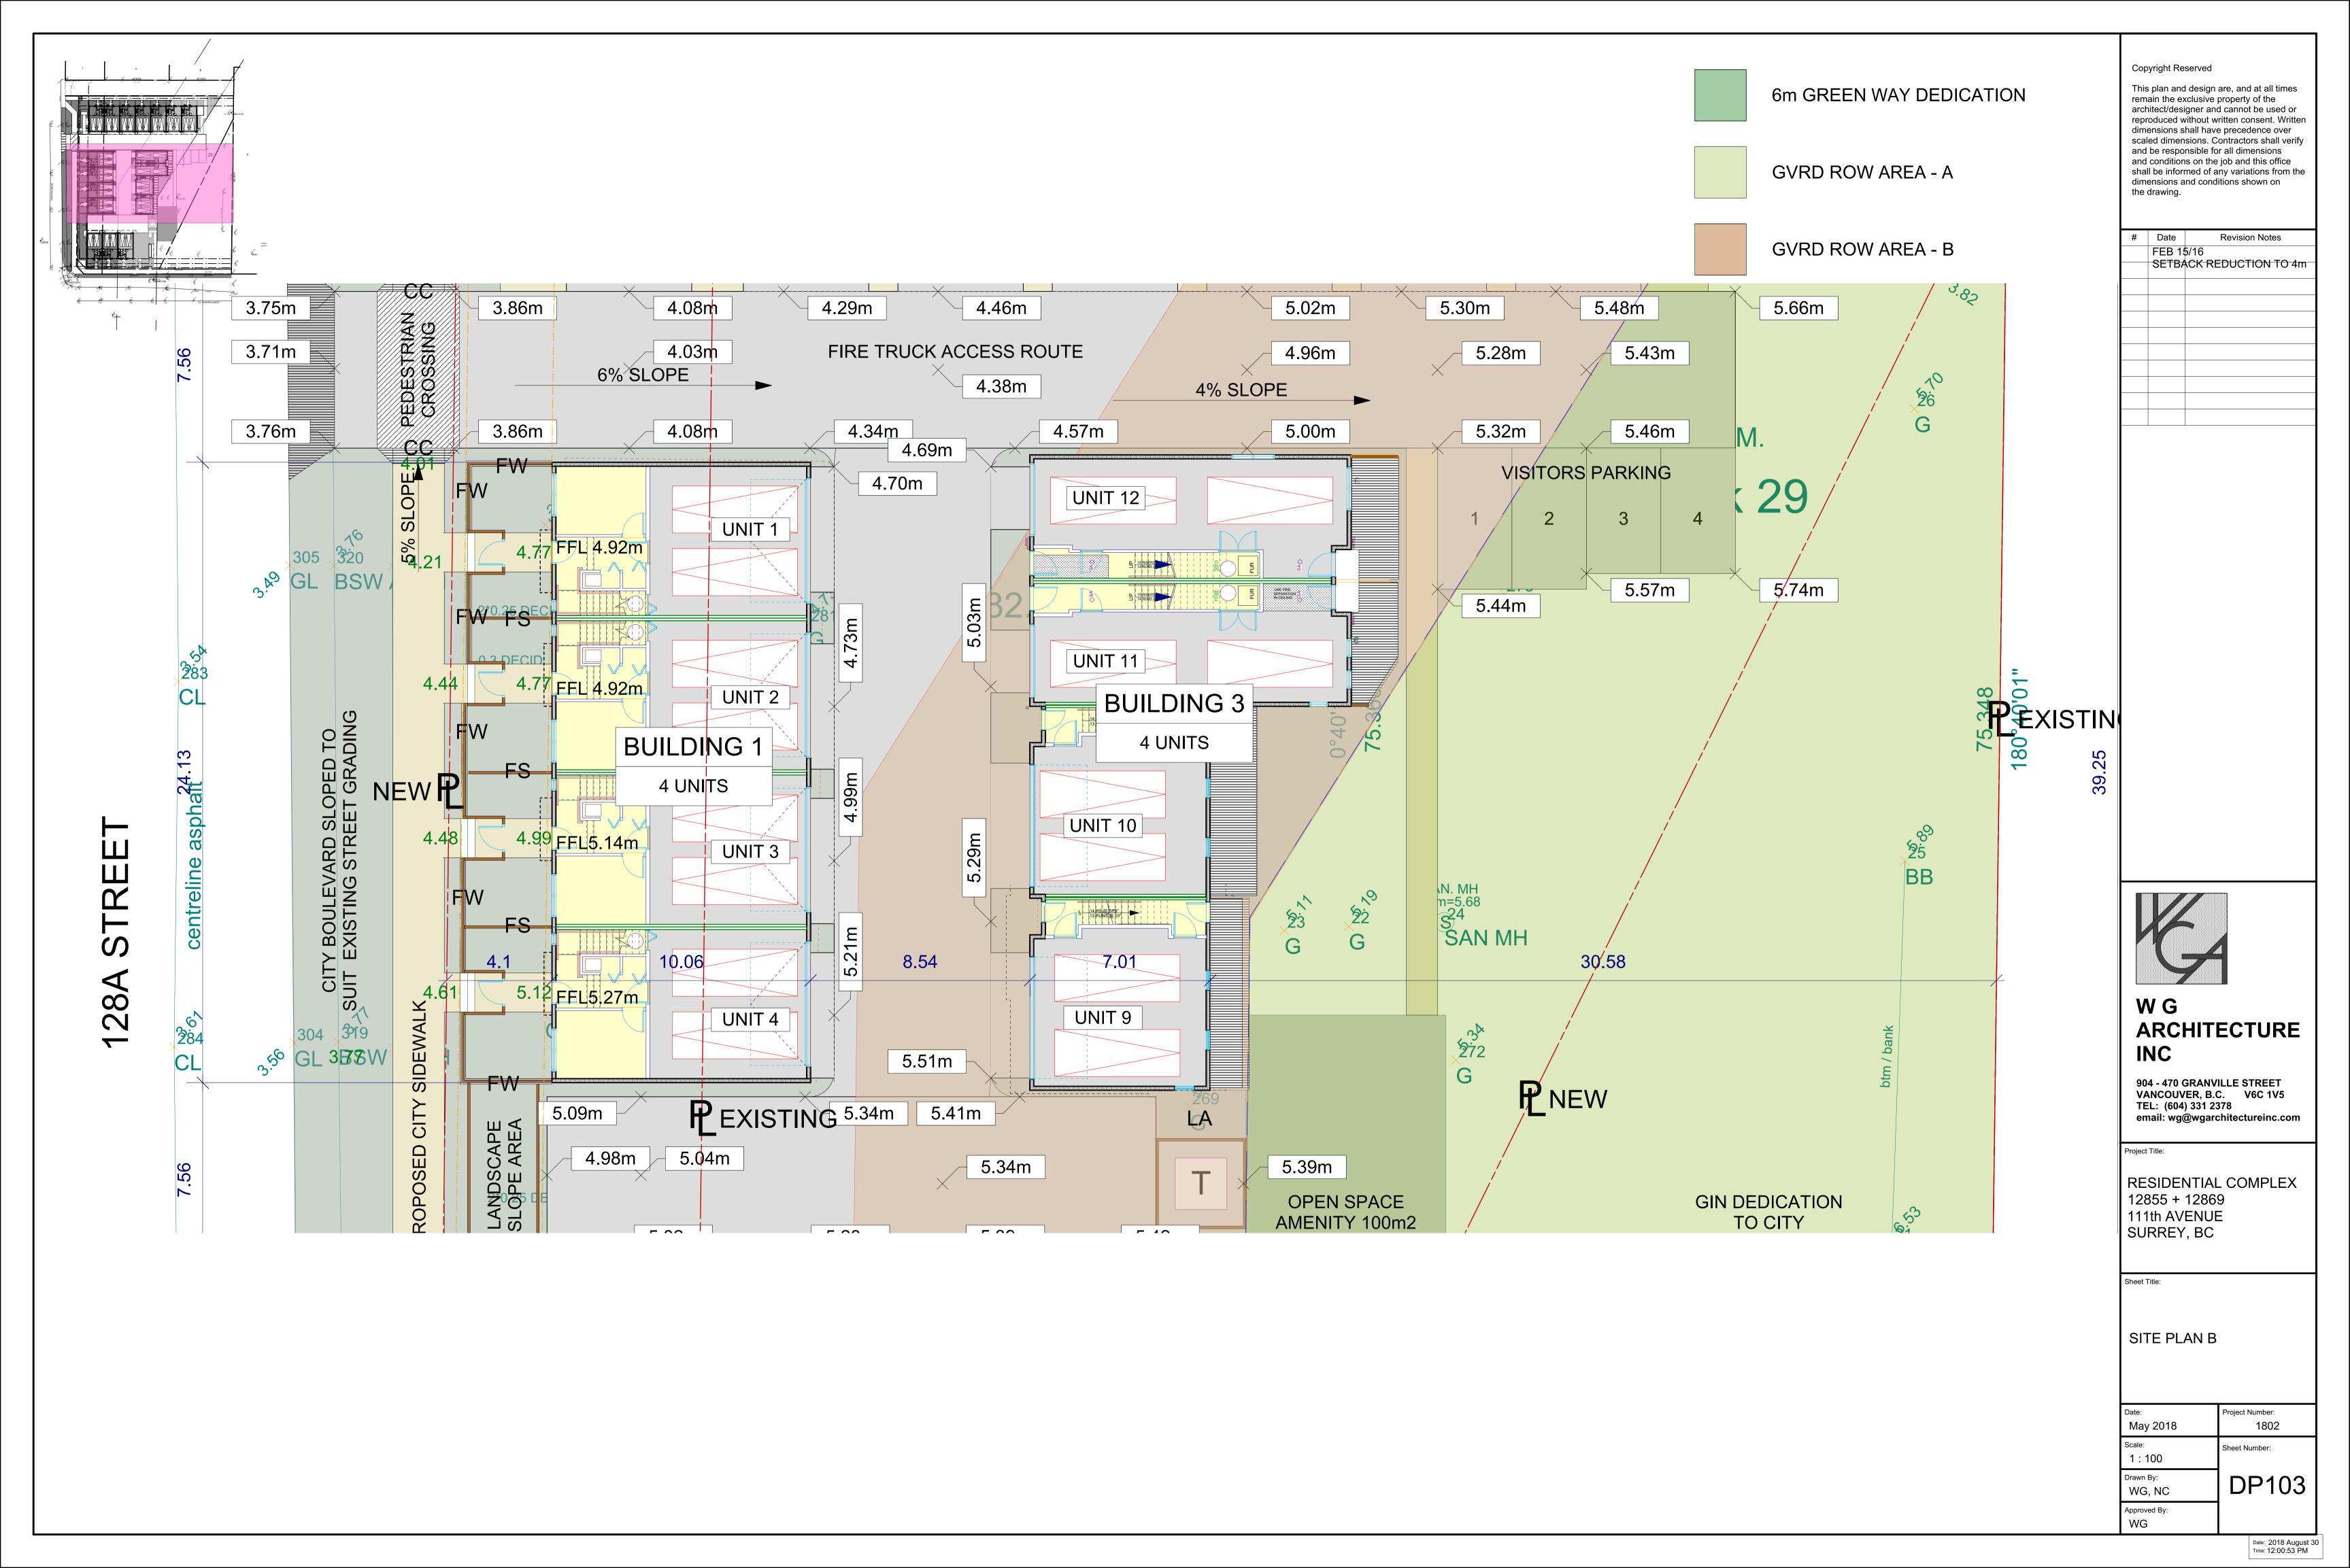



## PROPOSED STREETSCAPE ALONG 128A STREET



# MAX 0.9m HIGH (TYP)

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#	Date	Revision Notes



### WG ARCHITECTURE INC

904 - 470 GRANVILLE STREET VANCOUVER, B.C. V6C 1V5 TEL: (604) 331 2378 email: wg@wgarchitectureinc.com

Project Title:

RESIDENTIAL COMPLEX 12855 + 12869 111th AVENUE SURREY, BC

Sheet Title:

STREETSCAPE

Project Number: 1802
Sheet Number:
DP110



## PROPOSED STREETSCAPE ALONG GREENWAY

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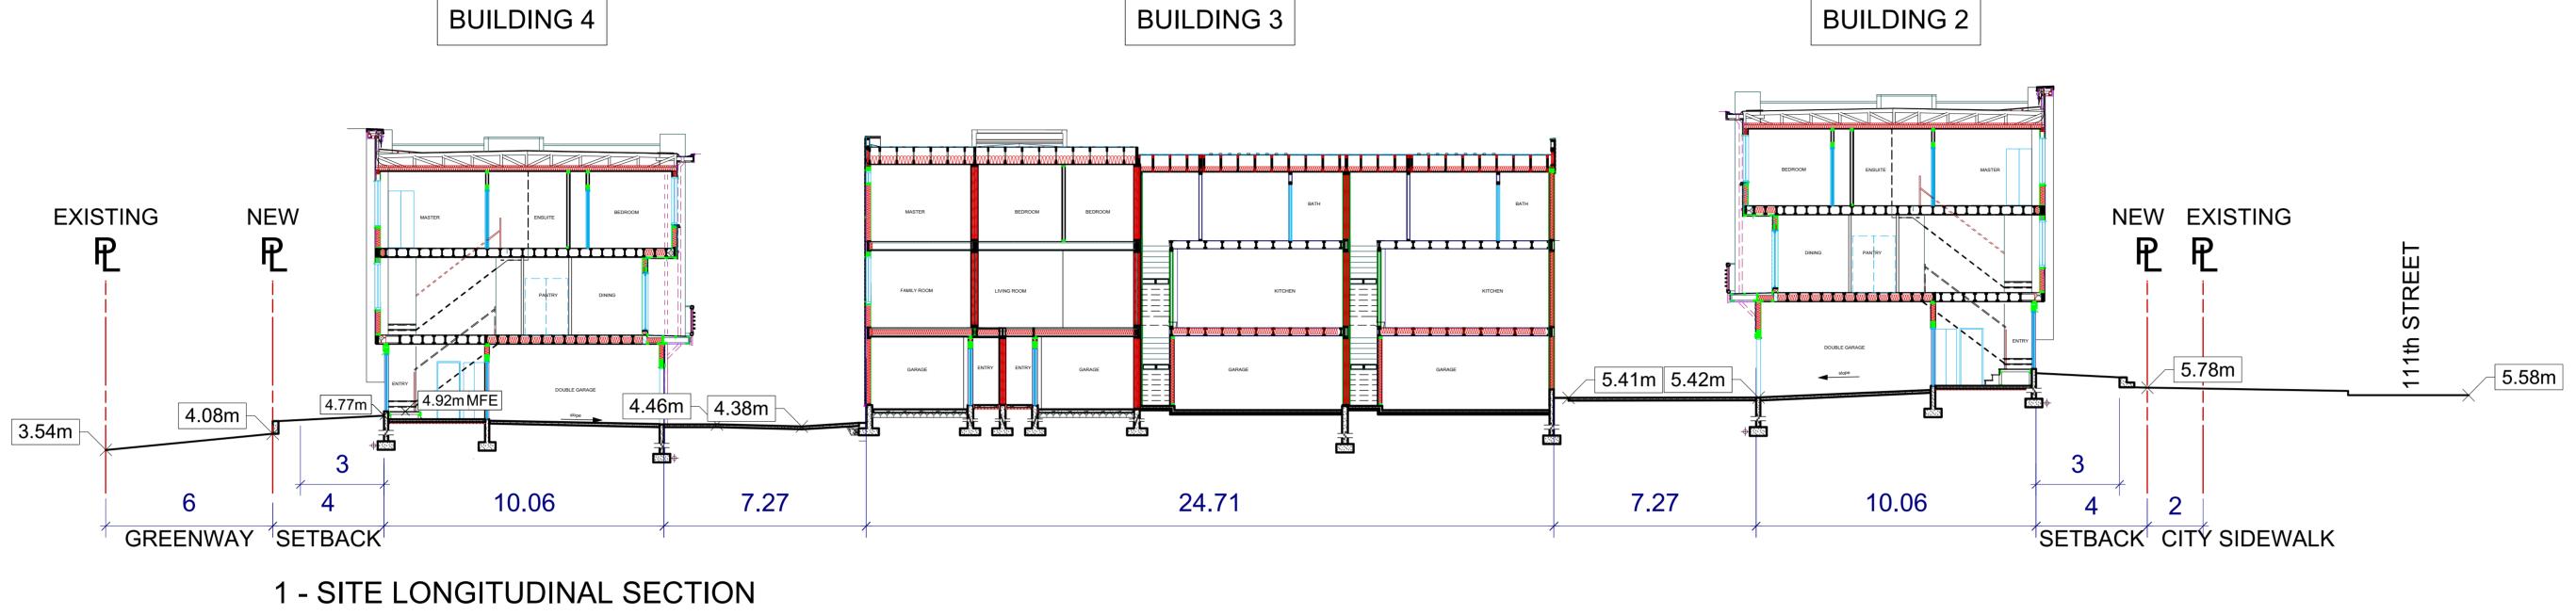
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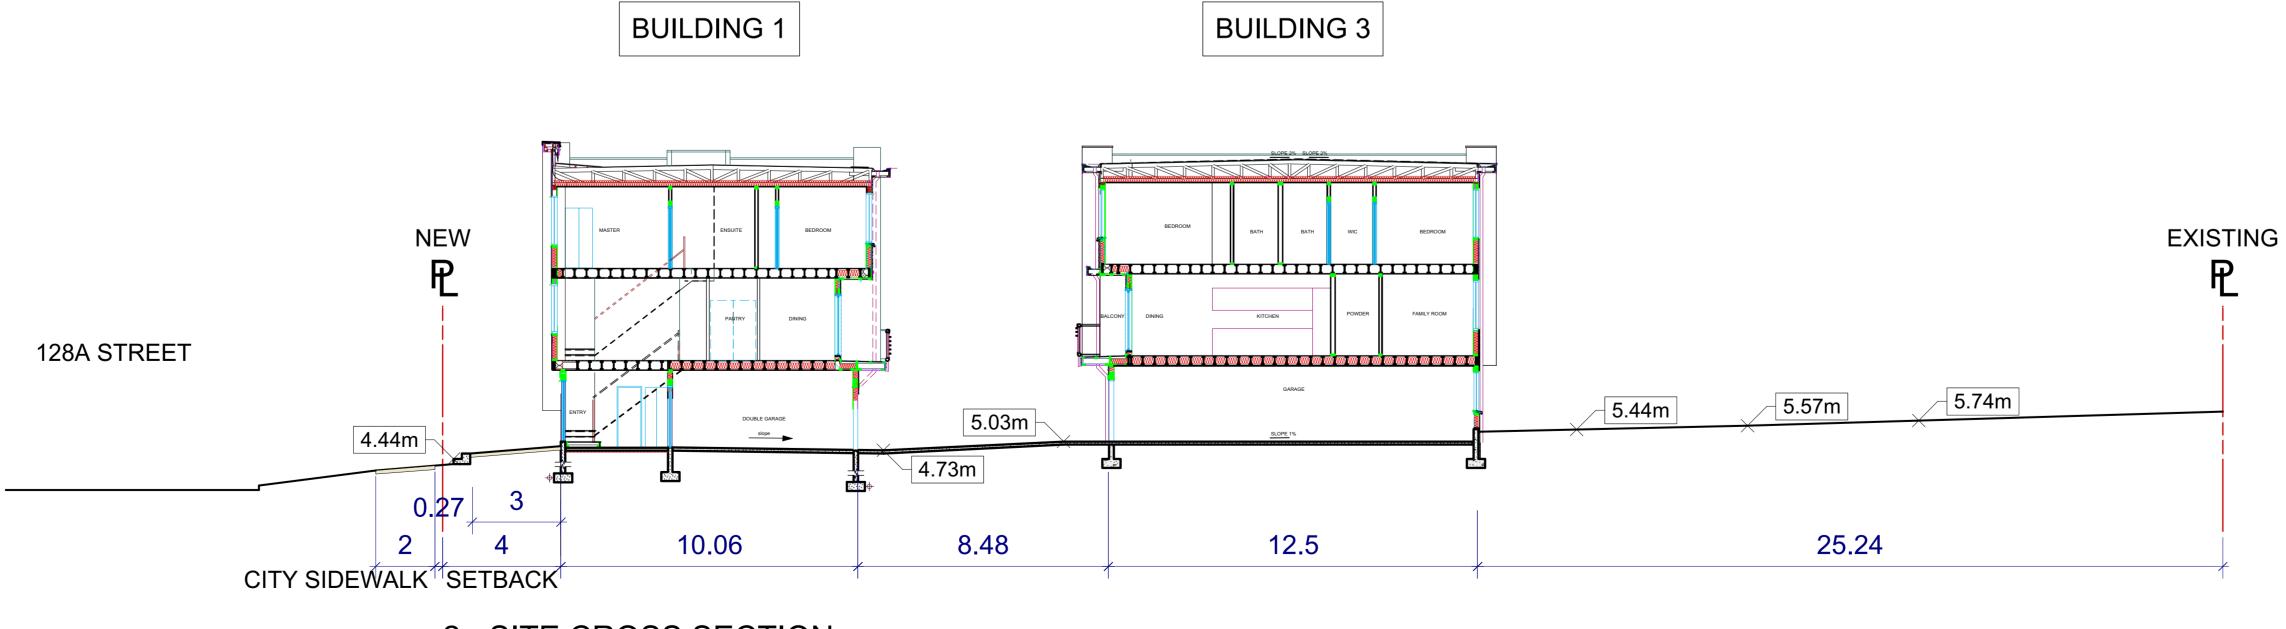
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Drawn By: WG, NC Approved By: WG

DP111









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EAST ELEVATION

NORTH ELEVATION

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1/8" = 1' - 0"

Drawn By:

Approved By:

WG

EB

### **COLOUR SCHEME**

- NATURAL RED CEDER clear weather protection coating - Doors & Fascias
- " RED CENT " SHERWIN-WILLIAM, ART: SW 6341 (124-C6)
   Hardie Board Panels painted, General Paint
- " Scioto" H1005 LEDGE STONE Exterior stone veneer, Heritage Stone
- " WHITETAIL " SHERWIN-WILLIAM, ART: SW 6385 (261-C1) Hardie Board Panels painted, General Paint
- " SUN DRIED TOMATO " SHERWIN-WILLIAM, ART: SW 7585 (275-C4) - Hardie Board Panels painted, General Paint
- " ONLINE" SHERWIN-WILLIAM, ART: SW 7072 (235-C2 ) Hardie Plank, Trim & Rim Board w/ wood texture
- " MONTEREY TAUPE" prepainted - 6" Hardie Plank, Trim & Rim Board w/ wood texture
- " WEB GRAY " SHERWIN-WILLIAM, ART: SW 7075 (235-C6) Hardie Board Panels painted, General Paint
- " BUTTERFIELD " SHERWIN-WILLIAM, ART: SW 6676 (133-C5) Hardie Board Panels painted, General Paint
- " CYBERSPACE " SHERWIN-WILLIAM, ART: SW 7076 (235-C7) Hardie Board Panels painted, General Paint
- " SOFTWARE " SHERWIN-WILLIAM, ART: SW 7074 (235-C5) Hardie Board Fascia & Panels painted, General Paint
- "ONLINE" SHERWIN-WILLIAM, ART: SW 7072 (235-C2)
   Garage Door painted and canopy metal clading ( amenity unit ) General Paint
- " GRAY SCREEN " SHERWIN-WILLIAM, ART: SW 7071 (235-C1) Hardie Board Panels painted, General Paint






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SOUTH ELEVATION



NORTH ELEVATION



WEST ELEVATION

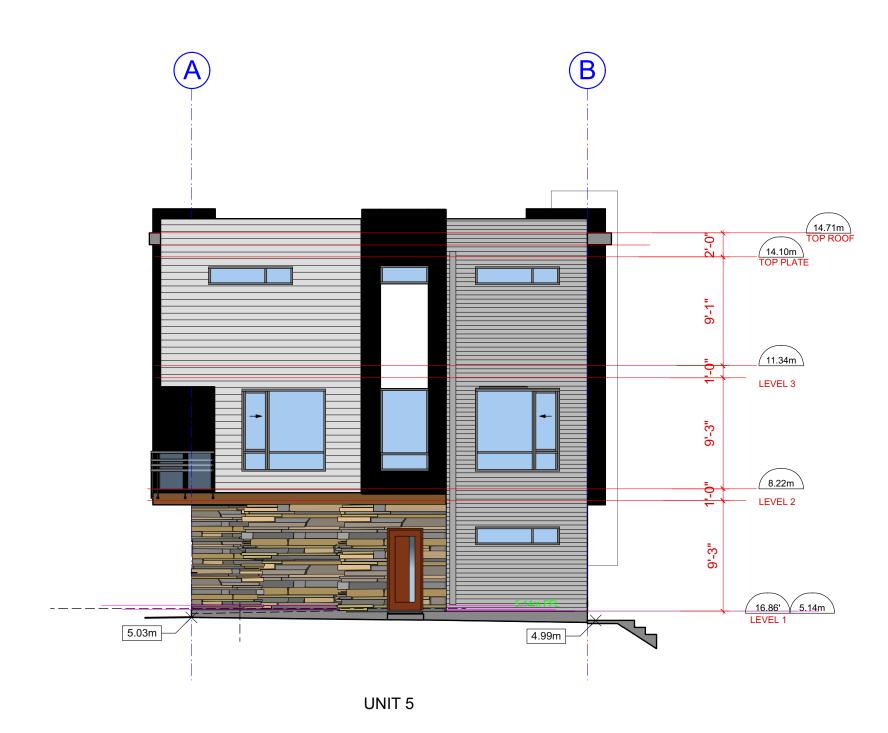 B
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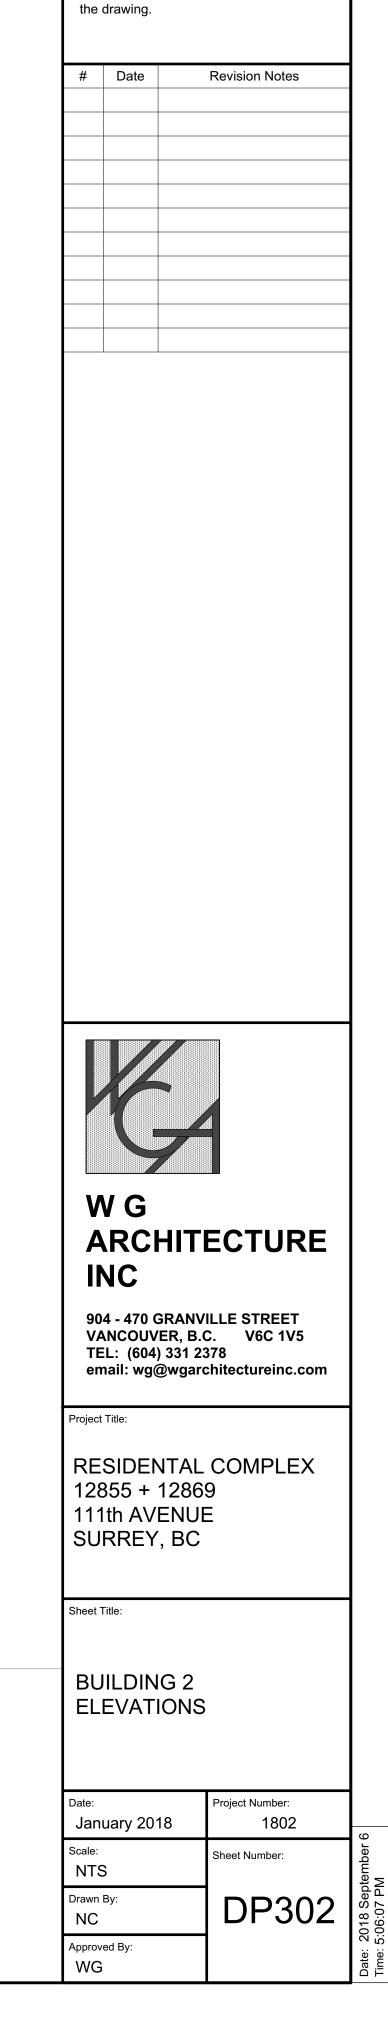
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UNIT 8

EAST ELEVATION

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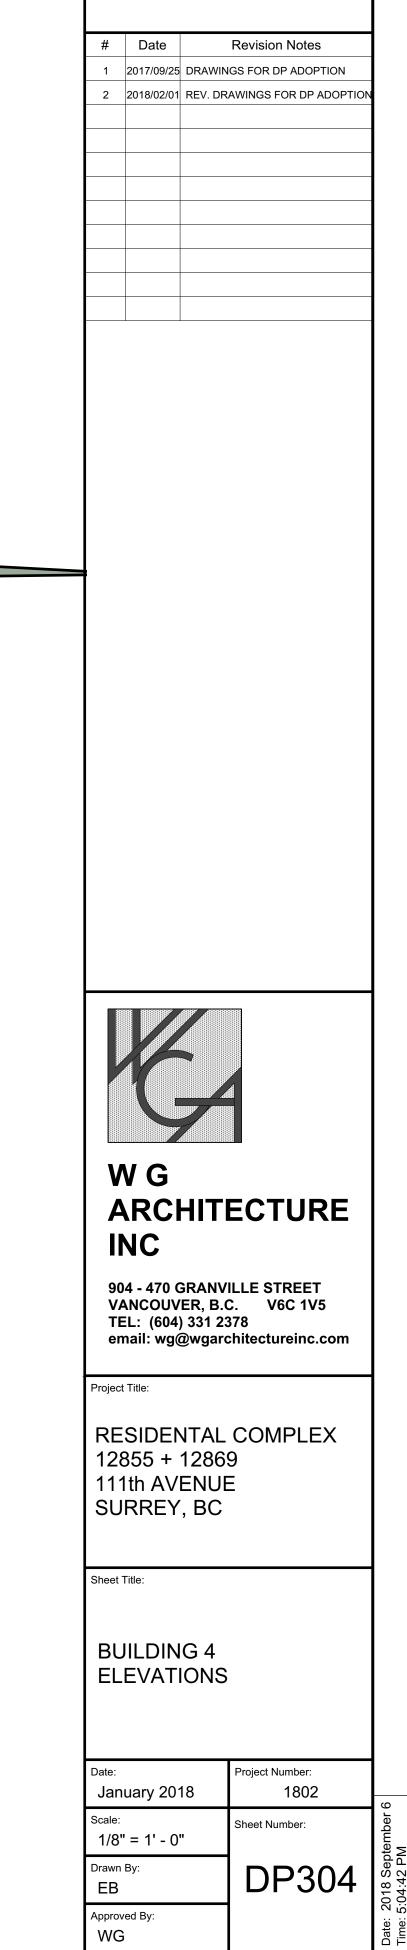
Image: Street Tile:     BUILDING 3     Built 1'' - 0''
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ARCHITECTURE INC         904 - 470 GRANVILLE STREET VANCOUVER, B.C. V6C 1V5 TEL: (604) 331 2378 email: wg@wgarchitectureinc.com         roject Title:         RESIDENTAL COMPLEX 12855 + 12869 111th AVENUE SURREY, BC         wheet Title:         BUILDING 3 ELEVATIONS         sheet Title:         Project Number: January 2018         scale: 1/8" = 1' - 0"         DP3003
ARCHITECTURE INC         904 - 470 GRANVILLE STREET VANCOUVER, B.C. V6C 1V5 TEL: (604) 331 2378 email: wg@wgarchitectureinc.com         roject Title:         RESIDENTAL COMPLEX 12855 + 12869 111th AVENUE SURREY, BC         wheet Title:         BUILDING 3 ELEVATIONS         sheet Title:         Project Number: January 2018         scale: 1/8" = 1' - 0"         DP3003
ARCHITECTURE INC         904 - 470 GRANVILLE STREET VANCOUVER, B.C. V6C 1V5 TEL: (604) 331 2378 email: wg@wgarchitectureinc.com         roject Title:         RESIDENTAL COMPLEX 12855 + 12869 111th AVENUE SURREY, BC         wheet Title:         BUILDING 3 ELEVATIONS         sheet Title:         Project Number: January 2018         scale: 1/8" = 1' - 0"         DP3003
INC   904 - 470 GRANVILLE STREET   YANCOUVER, B.C.   YGE   email: wg@wgarchitectureinc.com   Project Title: RESIDENTAL COMPLEX 12855 + 12869 111th AVENUE SURREY, BC Sweet Title: BUILDING 3 ELEVATIONS Steet Title: Nature: January 2018 Steet Number: 1802 Steet Number: 1802 Steet Number: 1802 Steet Number: 1802 DP303
904 - 470 GRANVILLE STREET   VANCOUVER, B.C.   V6C 1V5   TEL: (604) 331 2378   email: wg@wgarchitectureinc.com   Project Title:   RESIDENTAL COMPLEX   12855 + 12869   111th AVENUE   SURREY, BC   Sweet Title:   BUILDING 3   BUILDING 3   ELEVATIONS     Project Number:   1802   State:   1/8" = 1' - 0"   DP3003
VANCOUVER, B.C. V6C 1V5 TEL: (604) 331 2378 email: wg@wgarchitectureinc.com <sup>broject Title:</sup> RESIDENTAL COMPLEX 12855 + 12869 111th AVENUE SURREY, BC sheet Title: BUILDING 3 ELEVATIONS sheet Title: Project Number: 1802 Scale: 1/8" = 1' - 0" Drawn By: EB DP303
Project Title: RESIDENTAL COMPLEX 12855 + 12869 111th AVENUE SURREY, BC Sheet Title: BUILDING 3 ELEVATIONS Project Number: 1802 Sheet Number: 1802 Sheet Number: 1802 Sheet Number: 1802 Sheet Number: 1802 Sheet Number: 1802 Sheet Number: 1802 Sheet Number: 1802 Sheet Number: 1802
RESIDENTAL COMPLEX 12855 + 12869 111th AVENUE SURREY, BC wheet Title: BUILDING 3 ELEVATIONS Date: January 2018 Cale: 1/8" = 1' - 0" Project Number: 1802 Sheet Number: 1802 Sheet Number: 1802 DP303
12855 + 12869111th AVENUESURREY, BCSheet Title:BUILDING 3BUILDING 3ELEVATIONSDate:January 2018Scale:1/8" = 1' - 0"Drawn By:EBDP303
111th AVENUE SURREY, BCSheet Title:BUILDING 3 ELEVATIONSDate: January 2018Project Number: 1802Scale: 1/8" = 1' - 0"Drawn By: EBB
SURREY, BC Sheet Title: BUILDING 3 ELEVATIONS Date: January 2018 Scale: 1/8" = 1' - 0" Drawn By: EB DP303
BUILDING 3 ELEVATIONS Date: January 2018 Scale: 1/8" = 1' - 0" Drawn By: EB
BUILDING 3 ELEVATIONS Date: January 2018 Scale: 1/8" = 1' - 0" Drawn By: EB
ELEVATIONS Project Number: January 2018 Project Number: 1802 Scale: 1/8" = 1' - 0" Project Number: 1802 Sheet Number: DP303
ELEVATIONS Project Number: January 2018 Project Number: 1802 Scale: 1/8" = 1' - 0" Project Number: 1802 Sheet Number: DP303
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January 2018     1802       Scale:     1/8" = 1' - 0"       Jrawn By:     B       EB     DP303
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EB DP303


Approved By: WG



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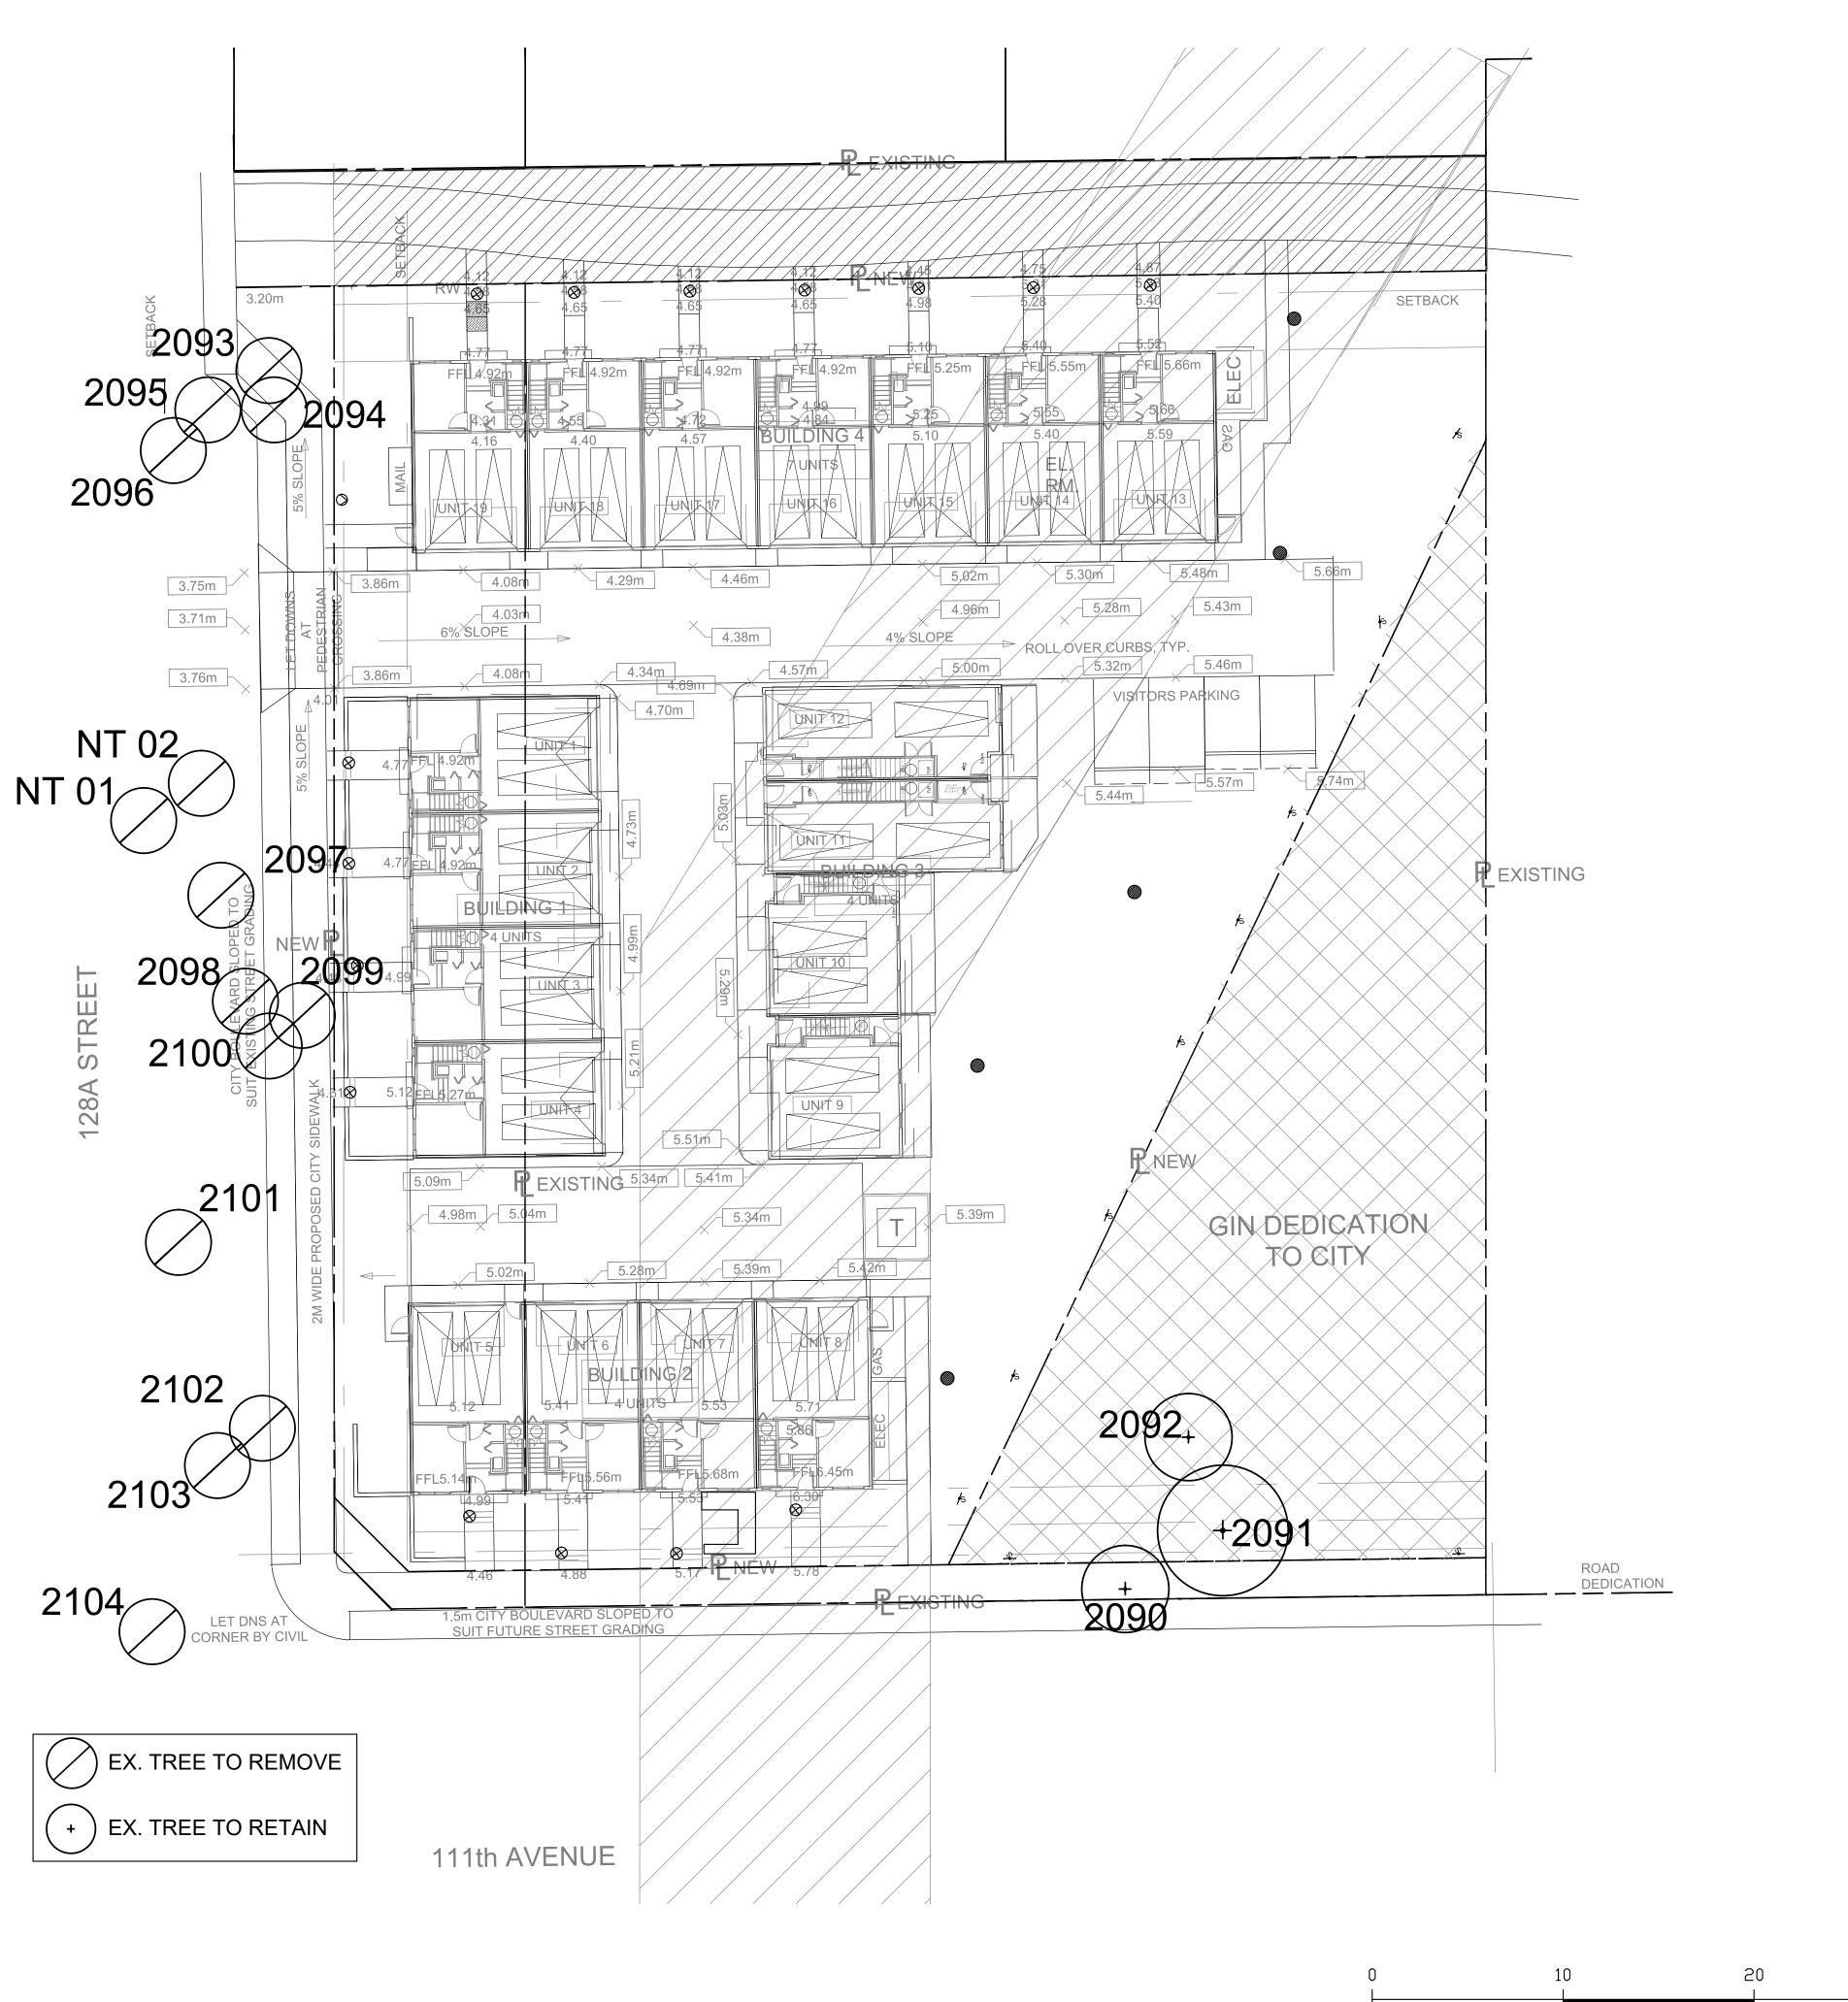
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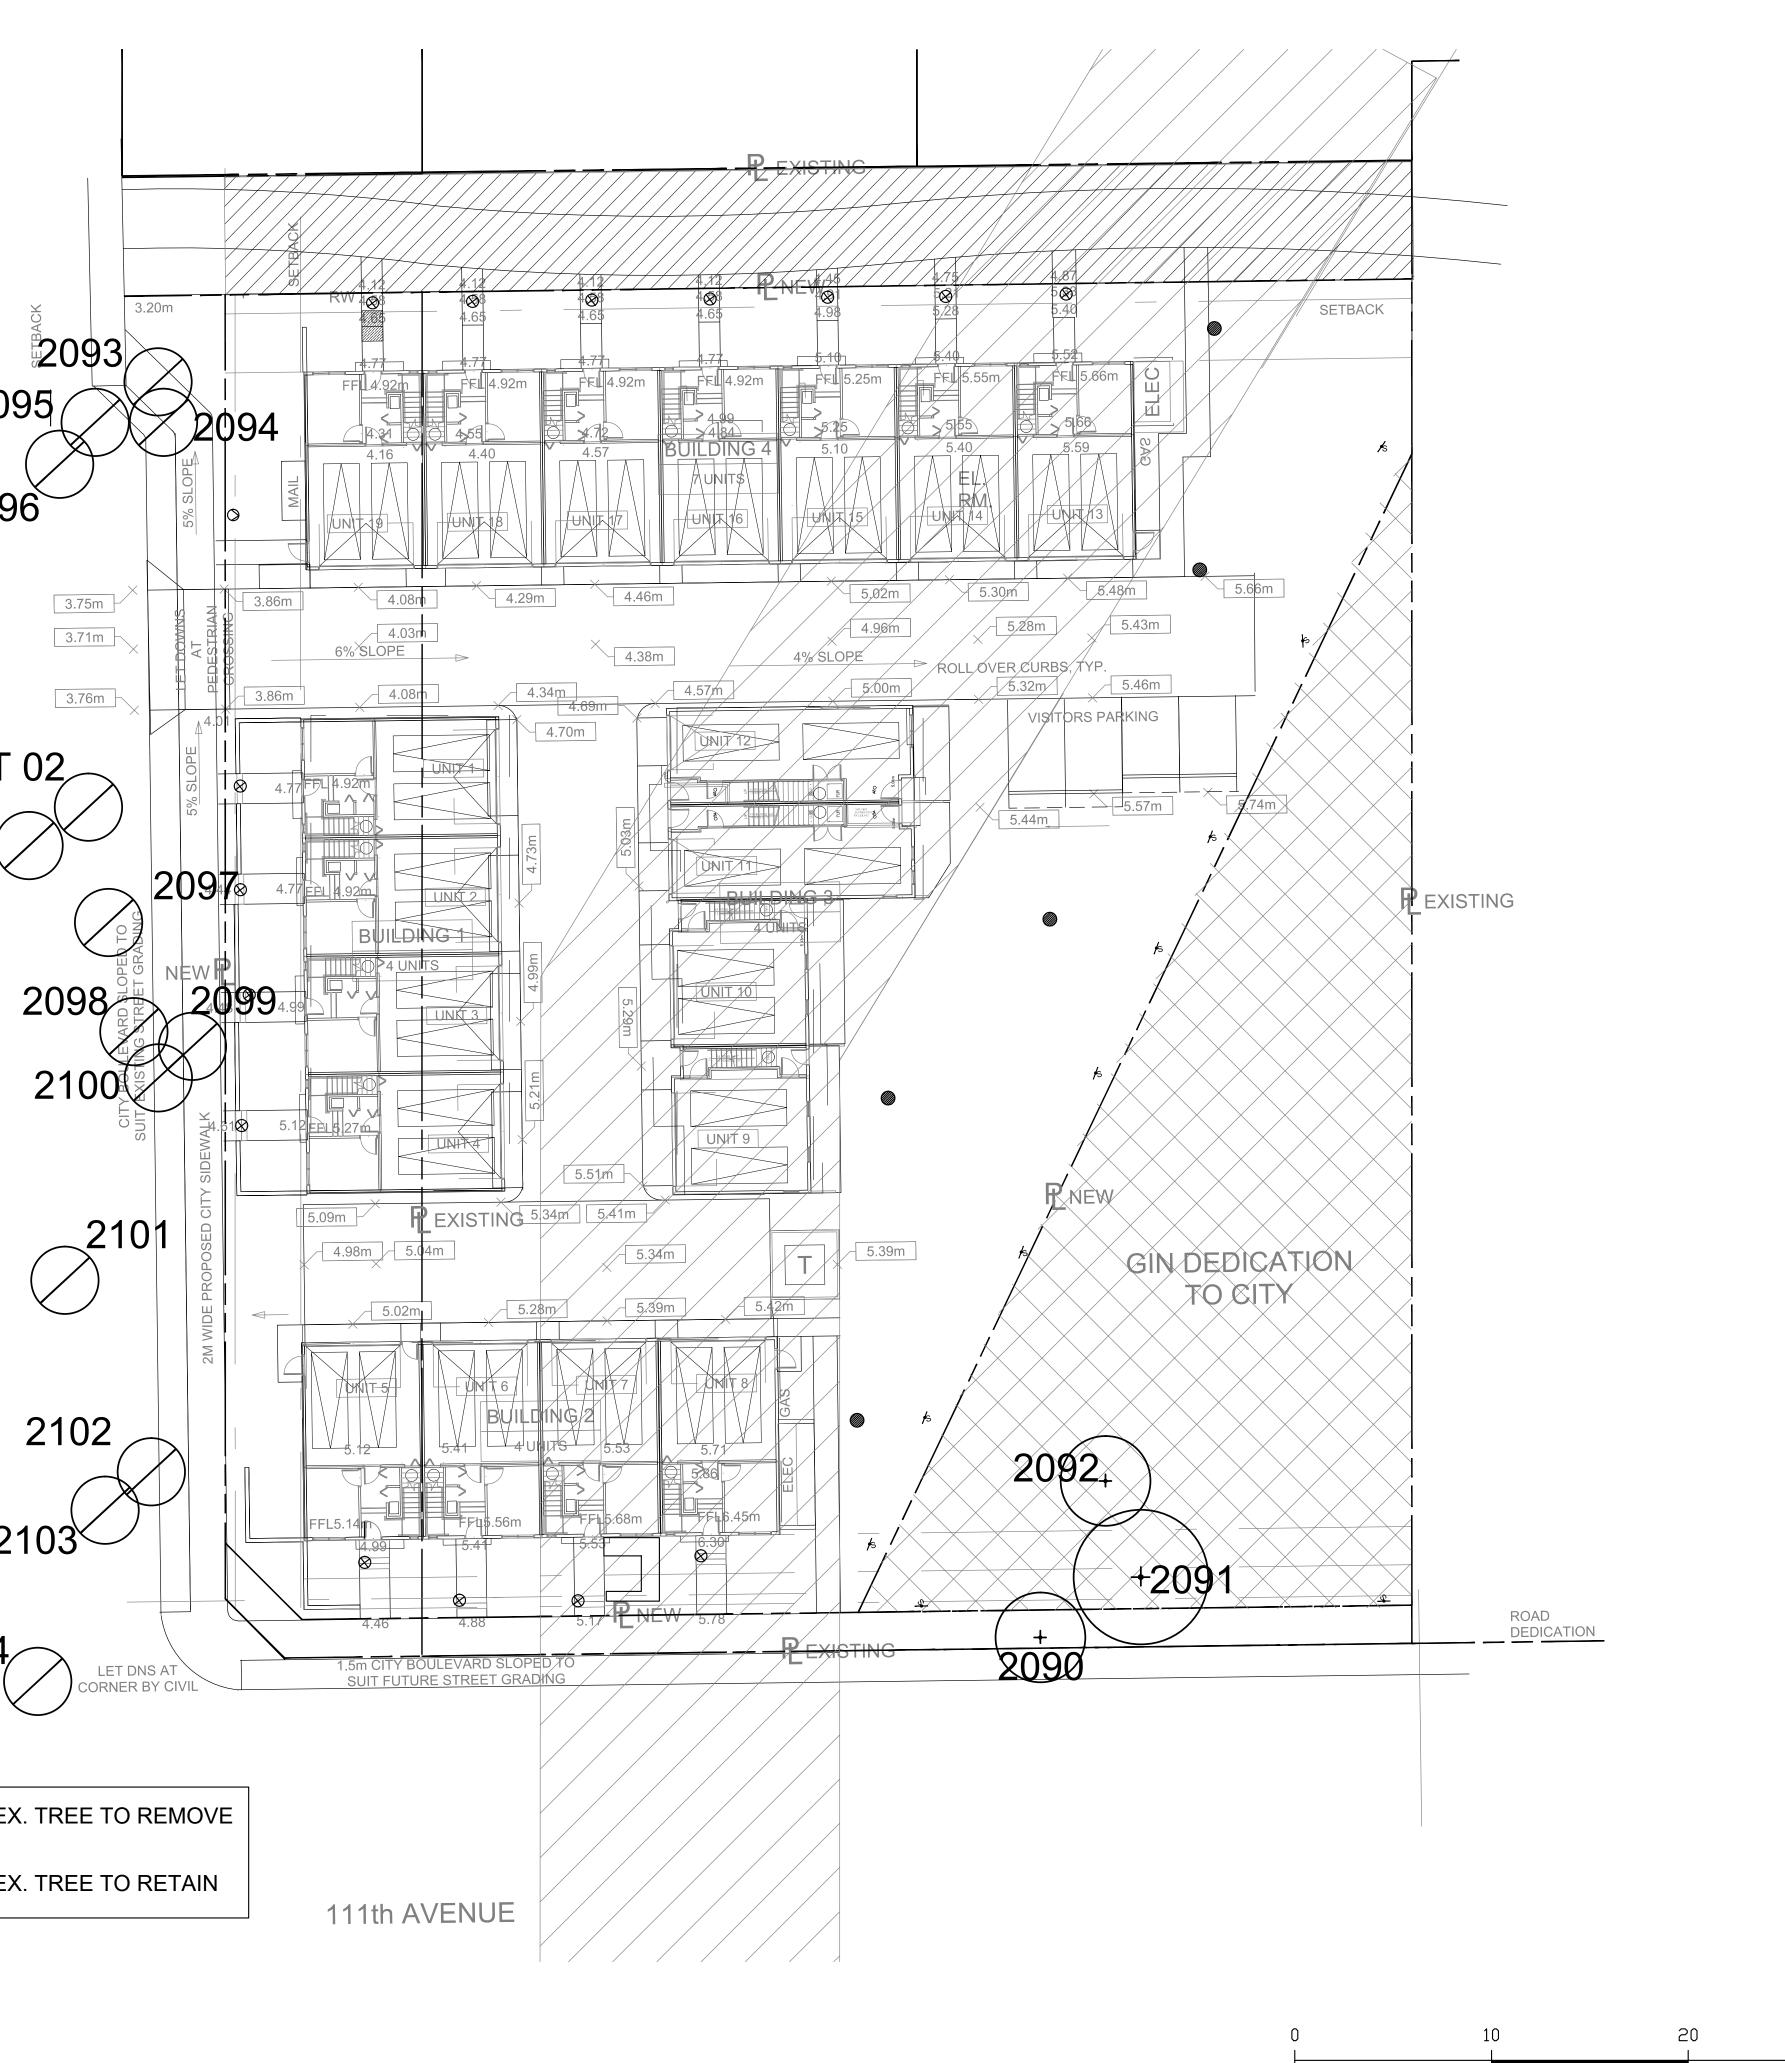








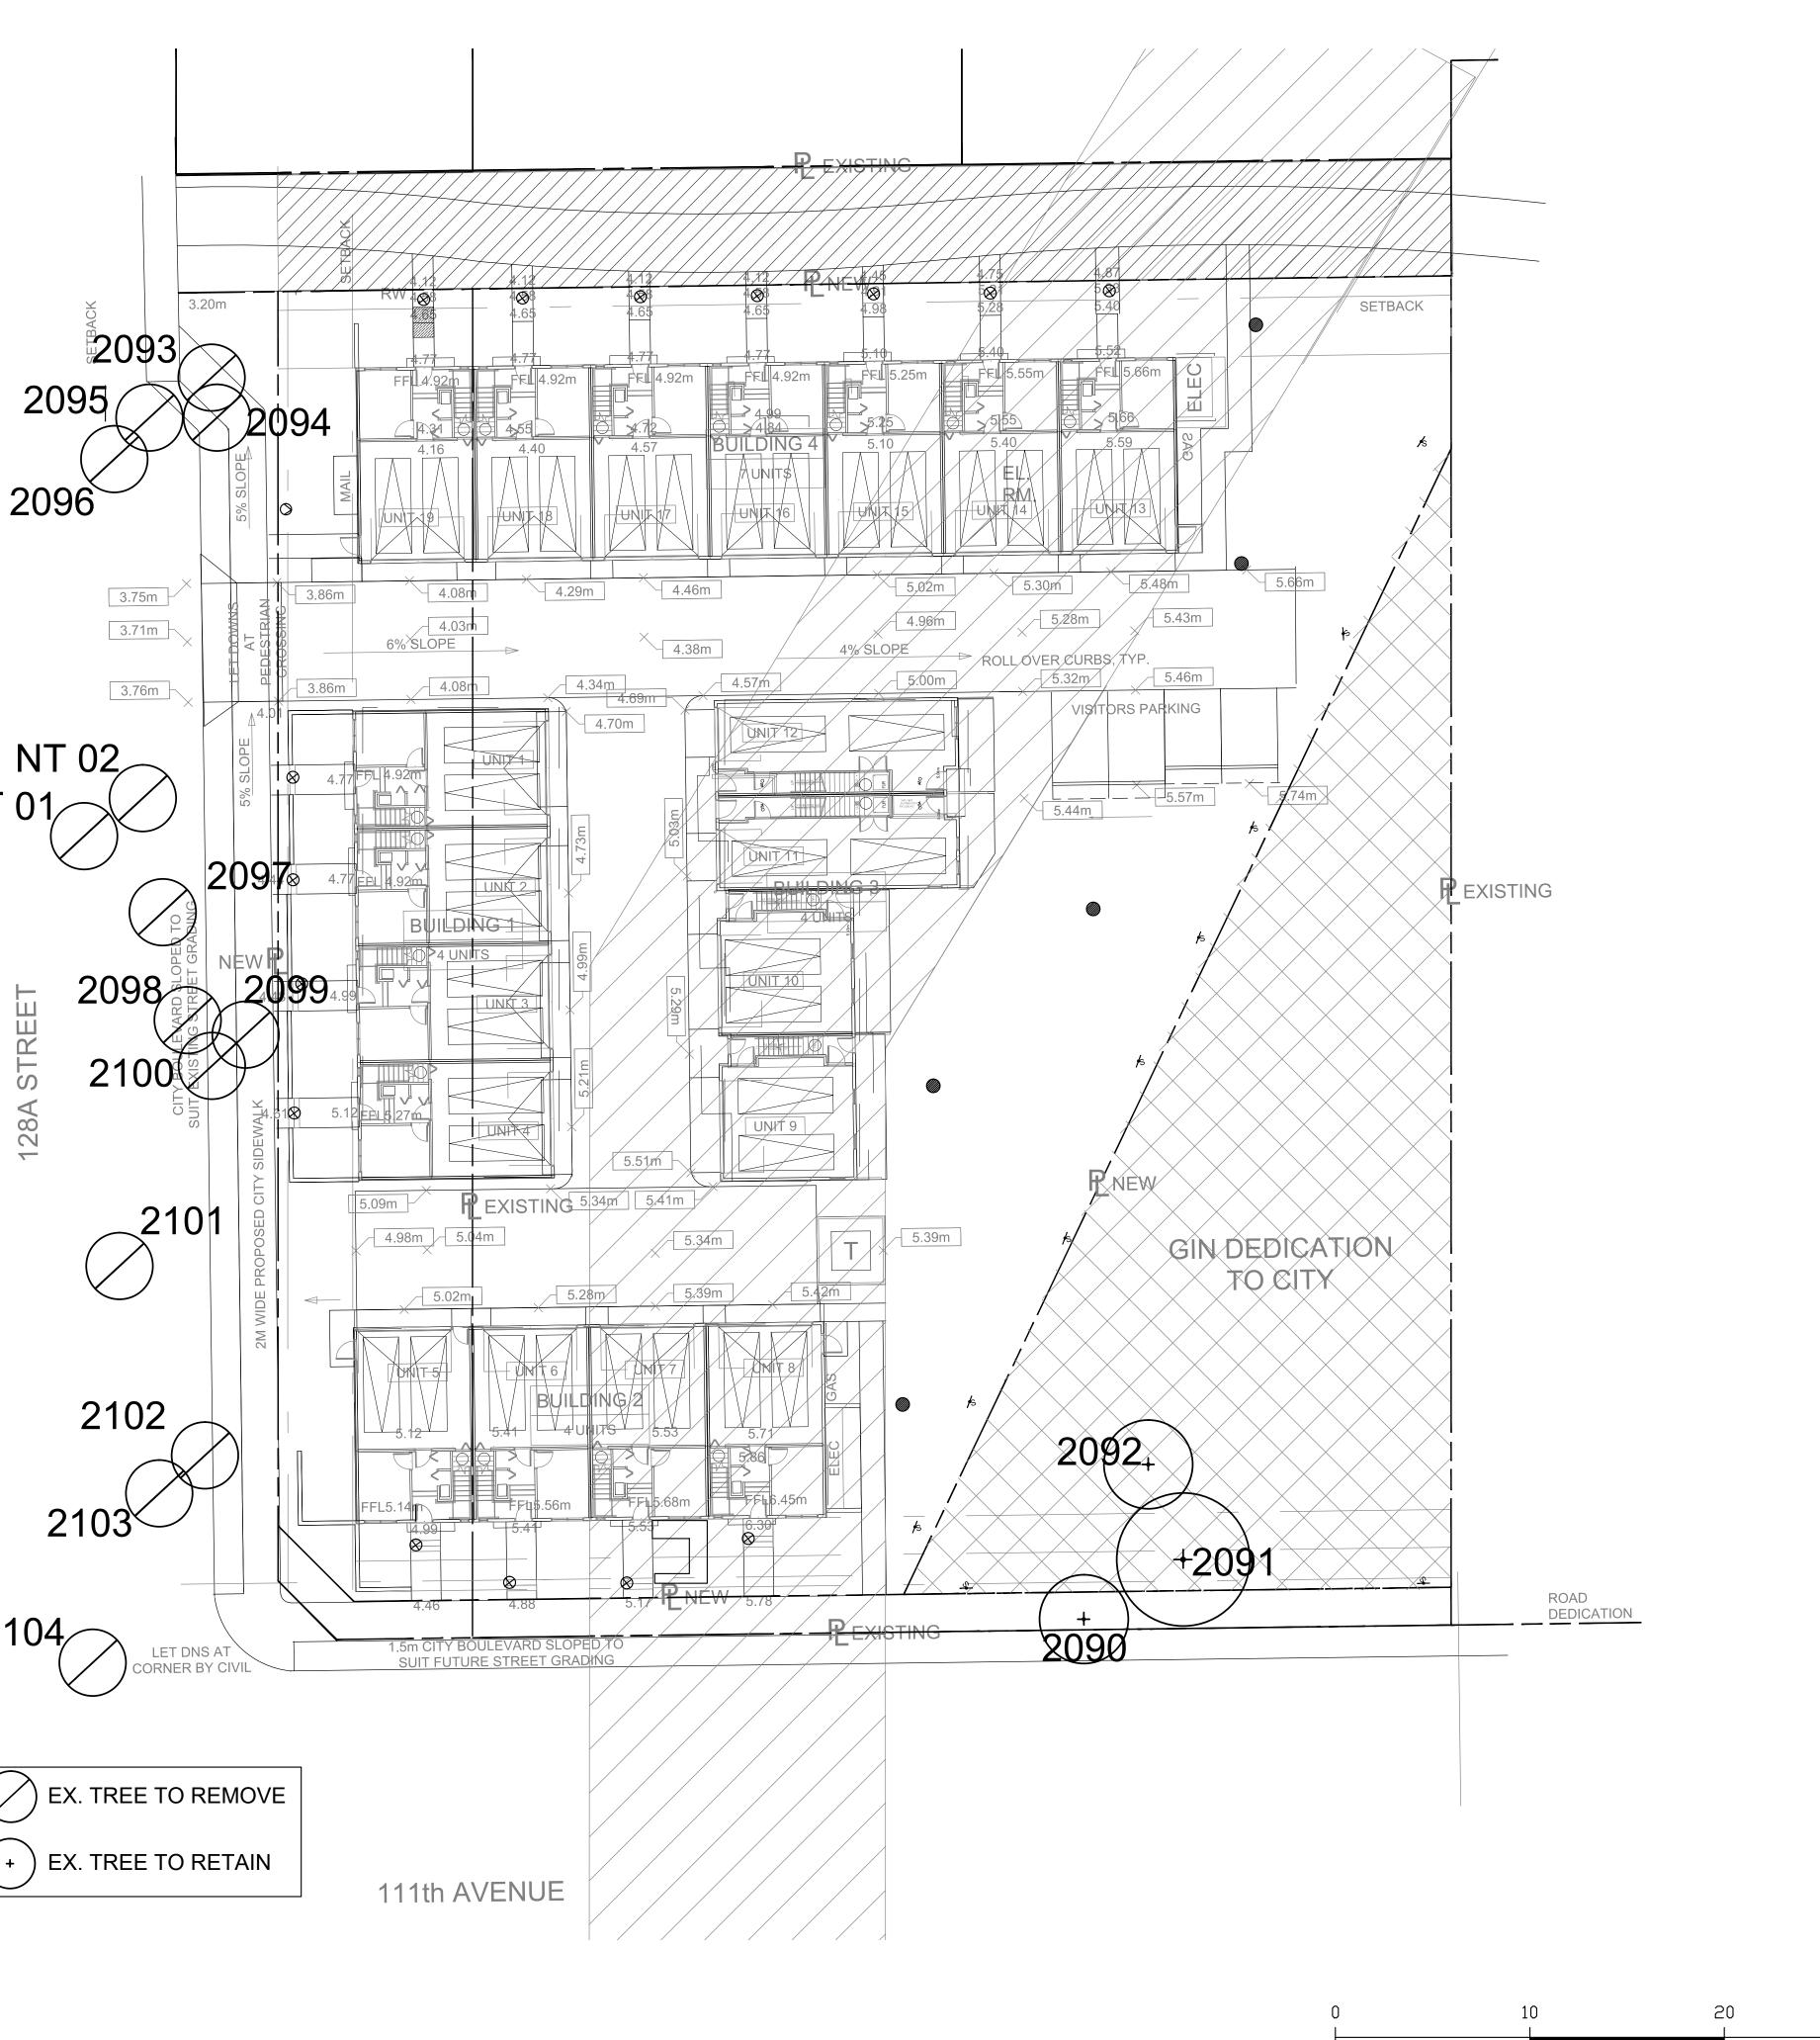






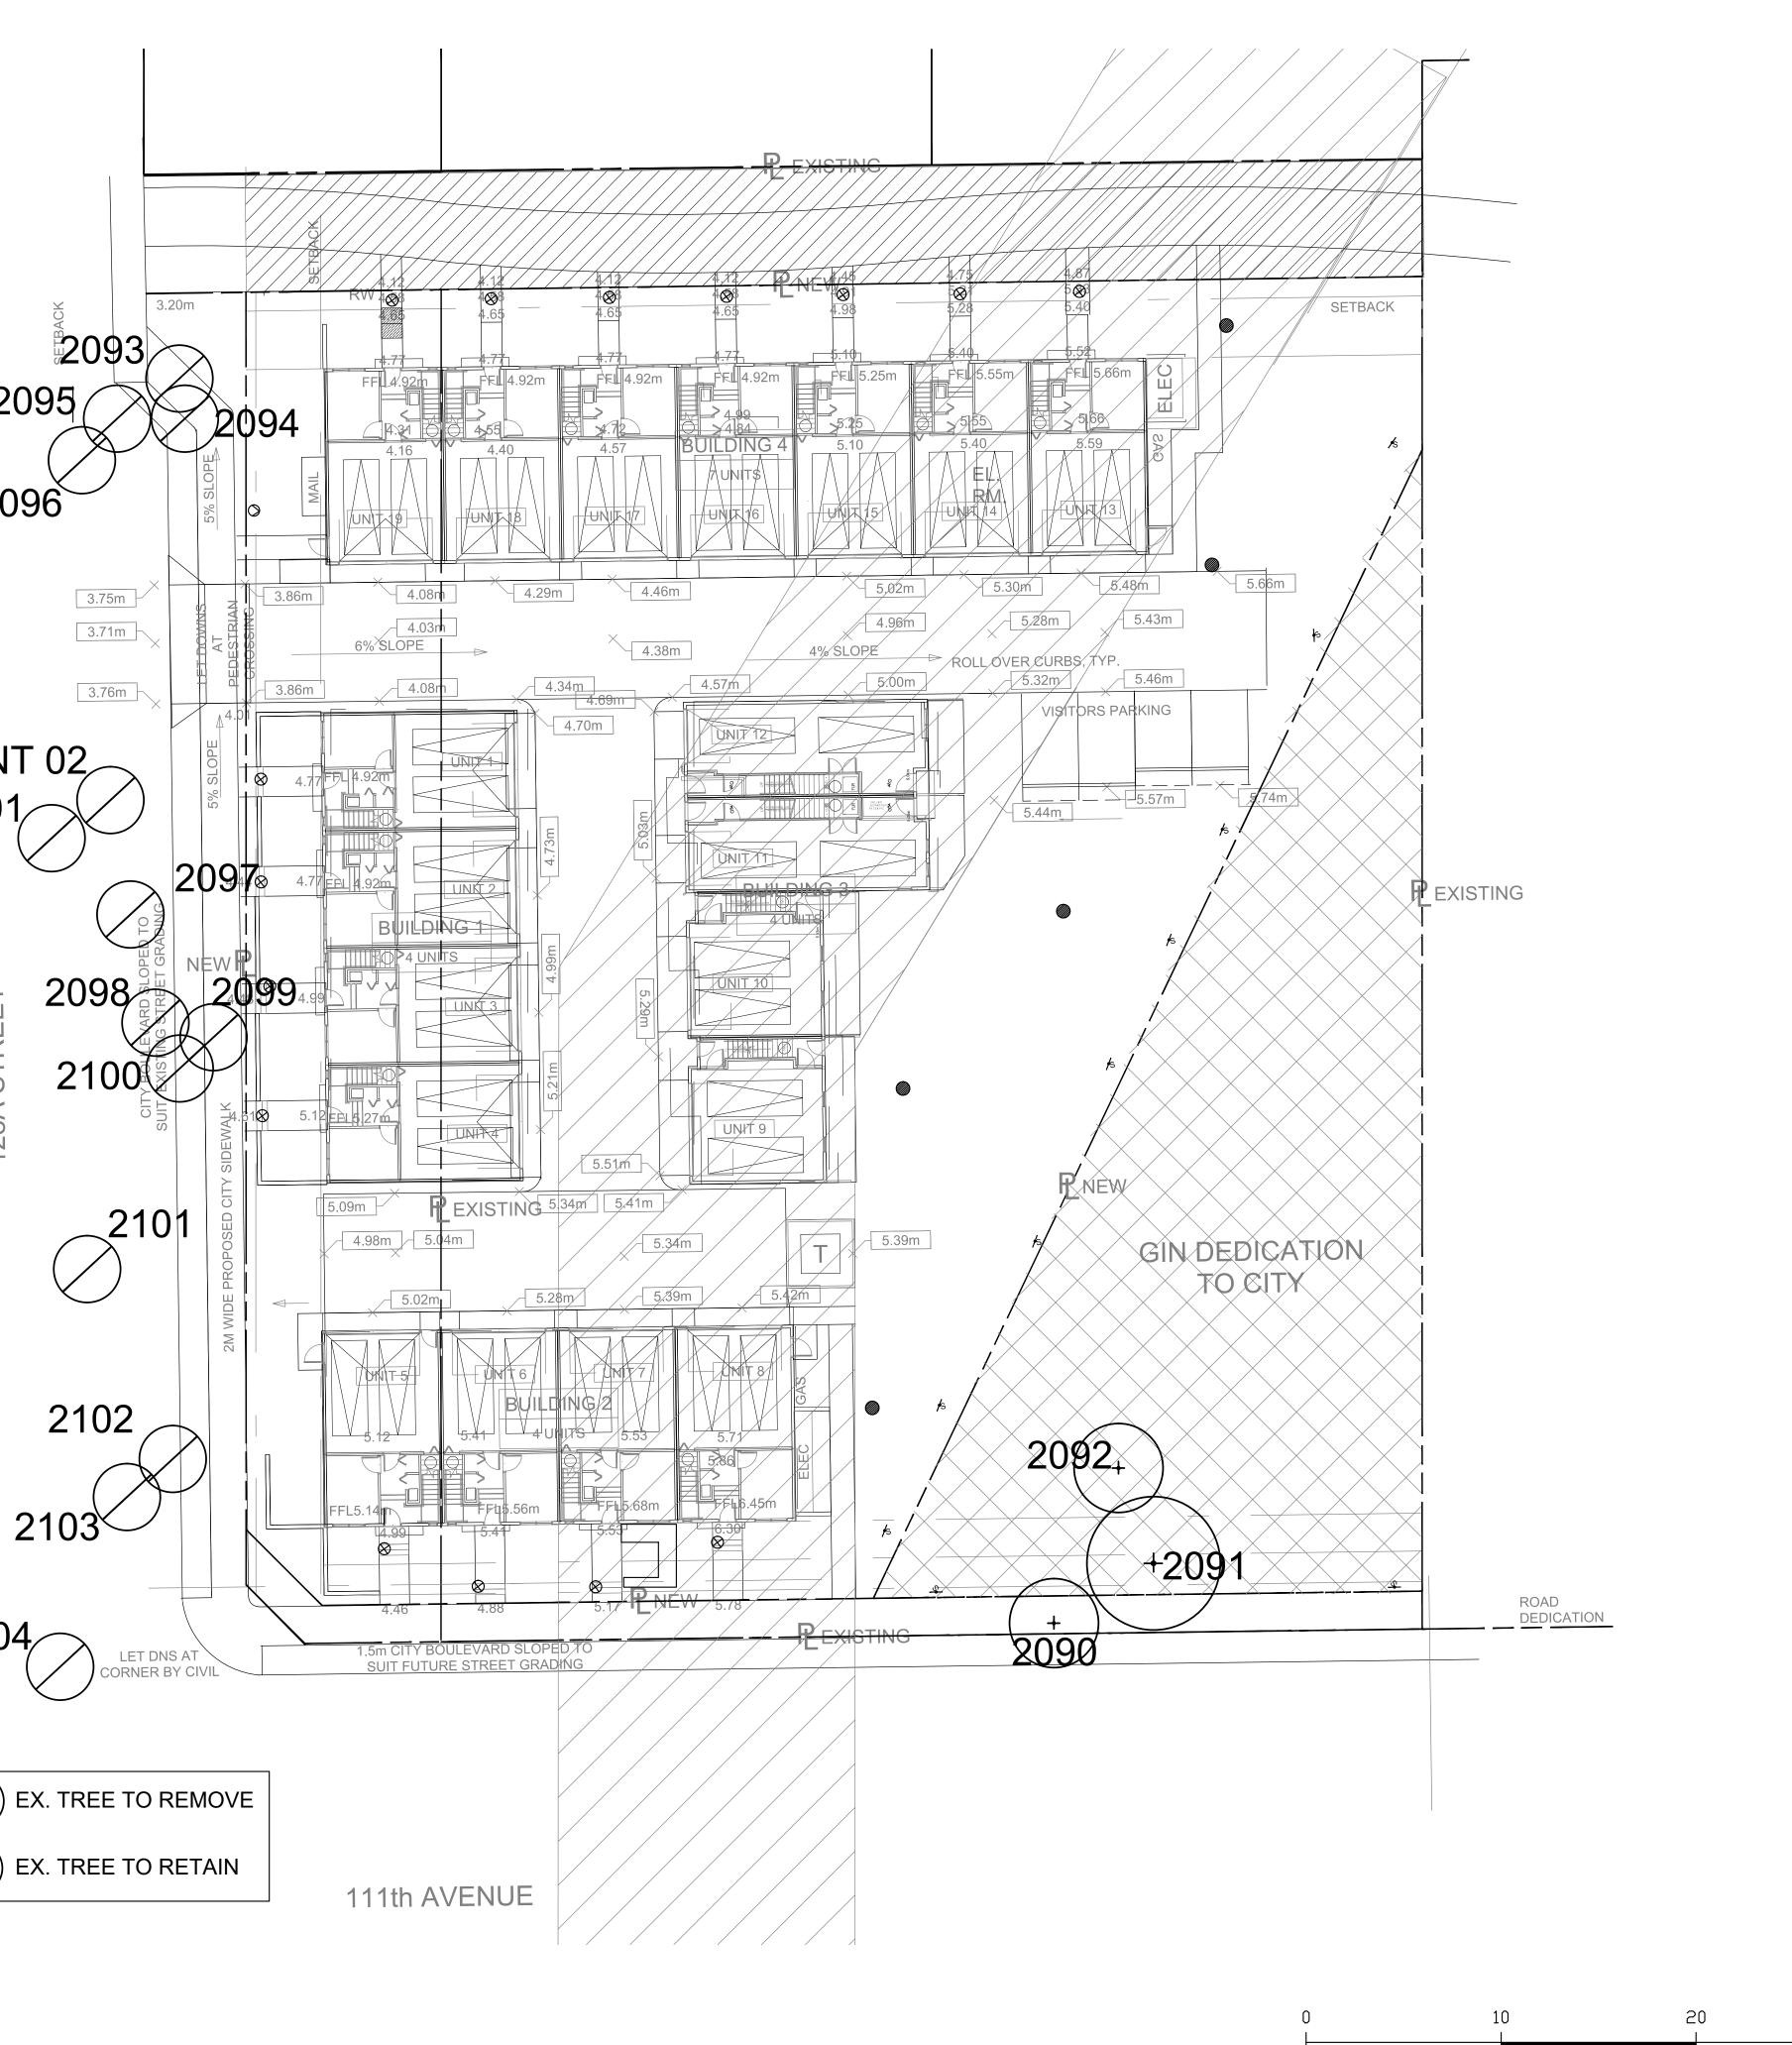

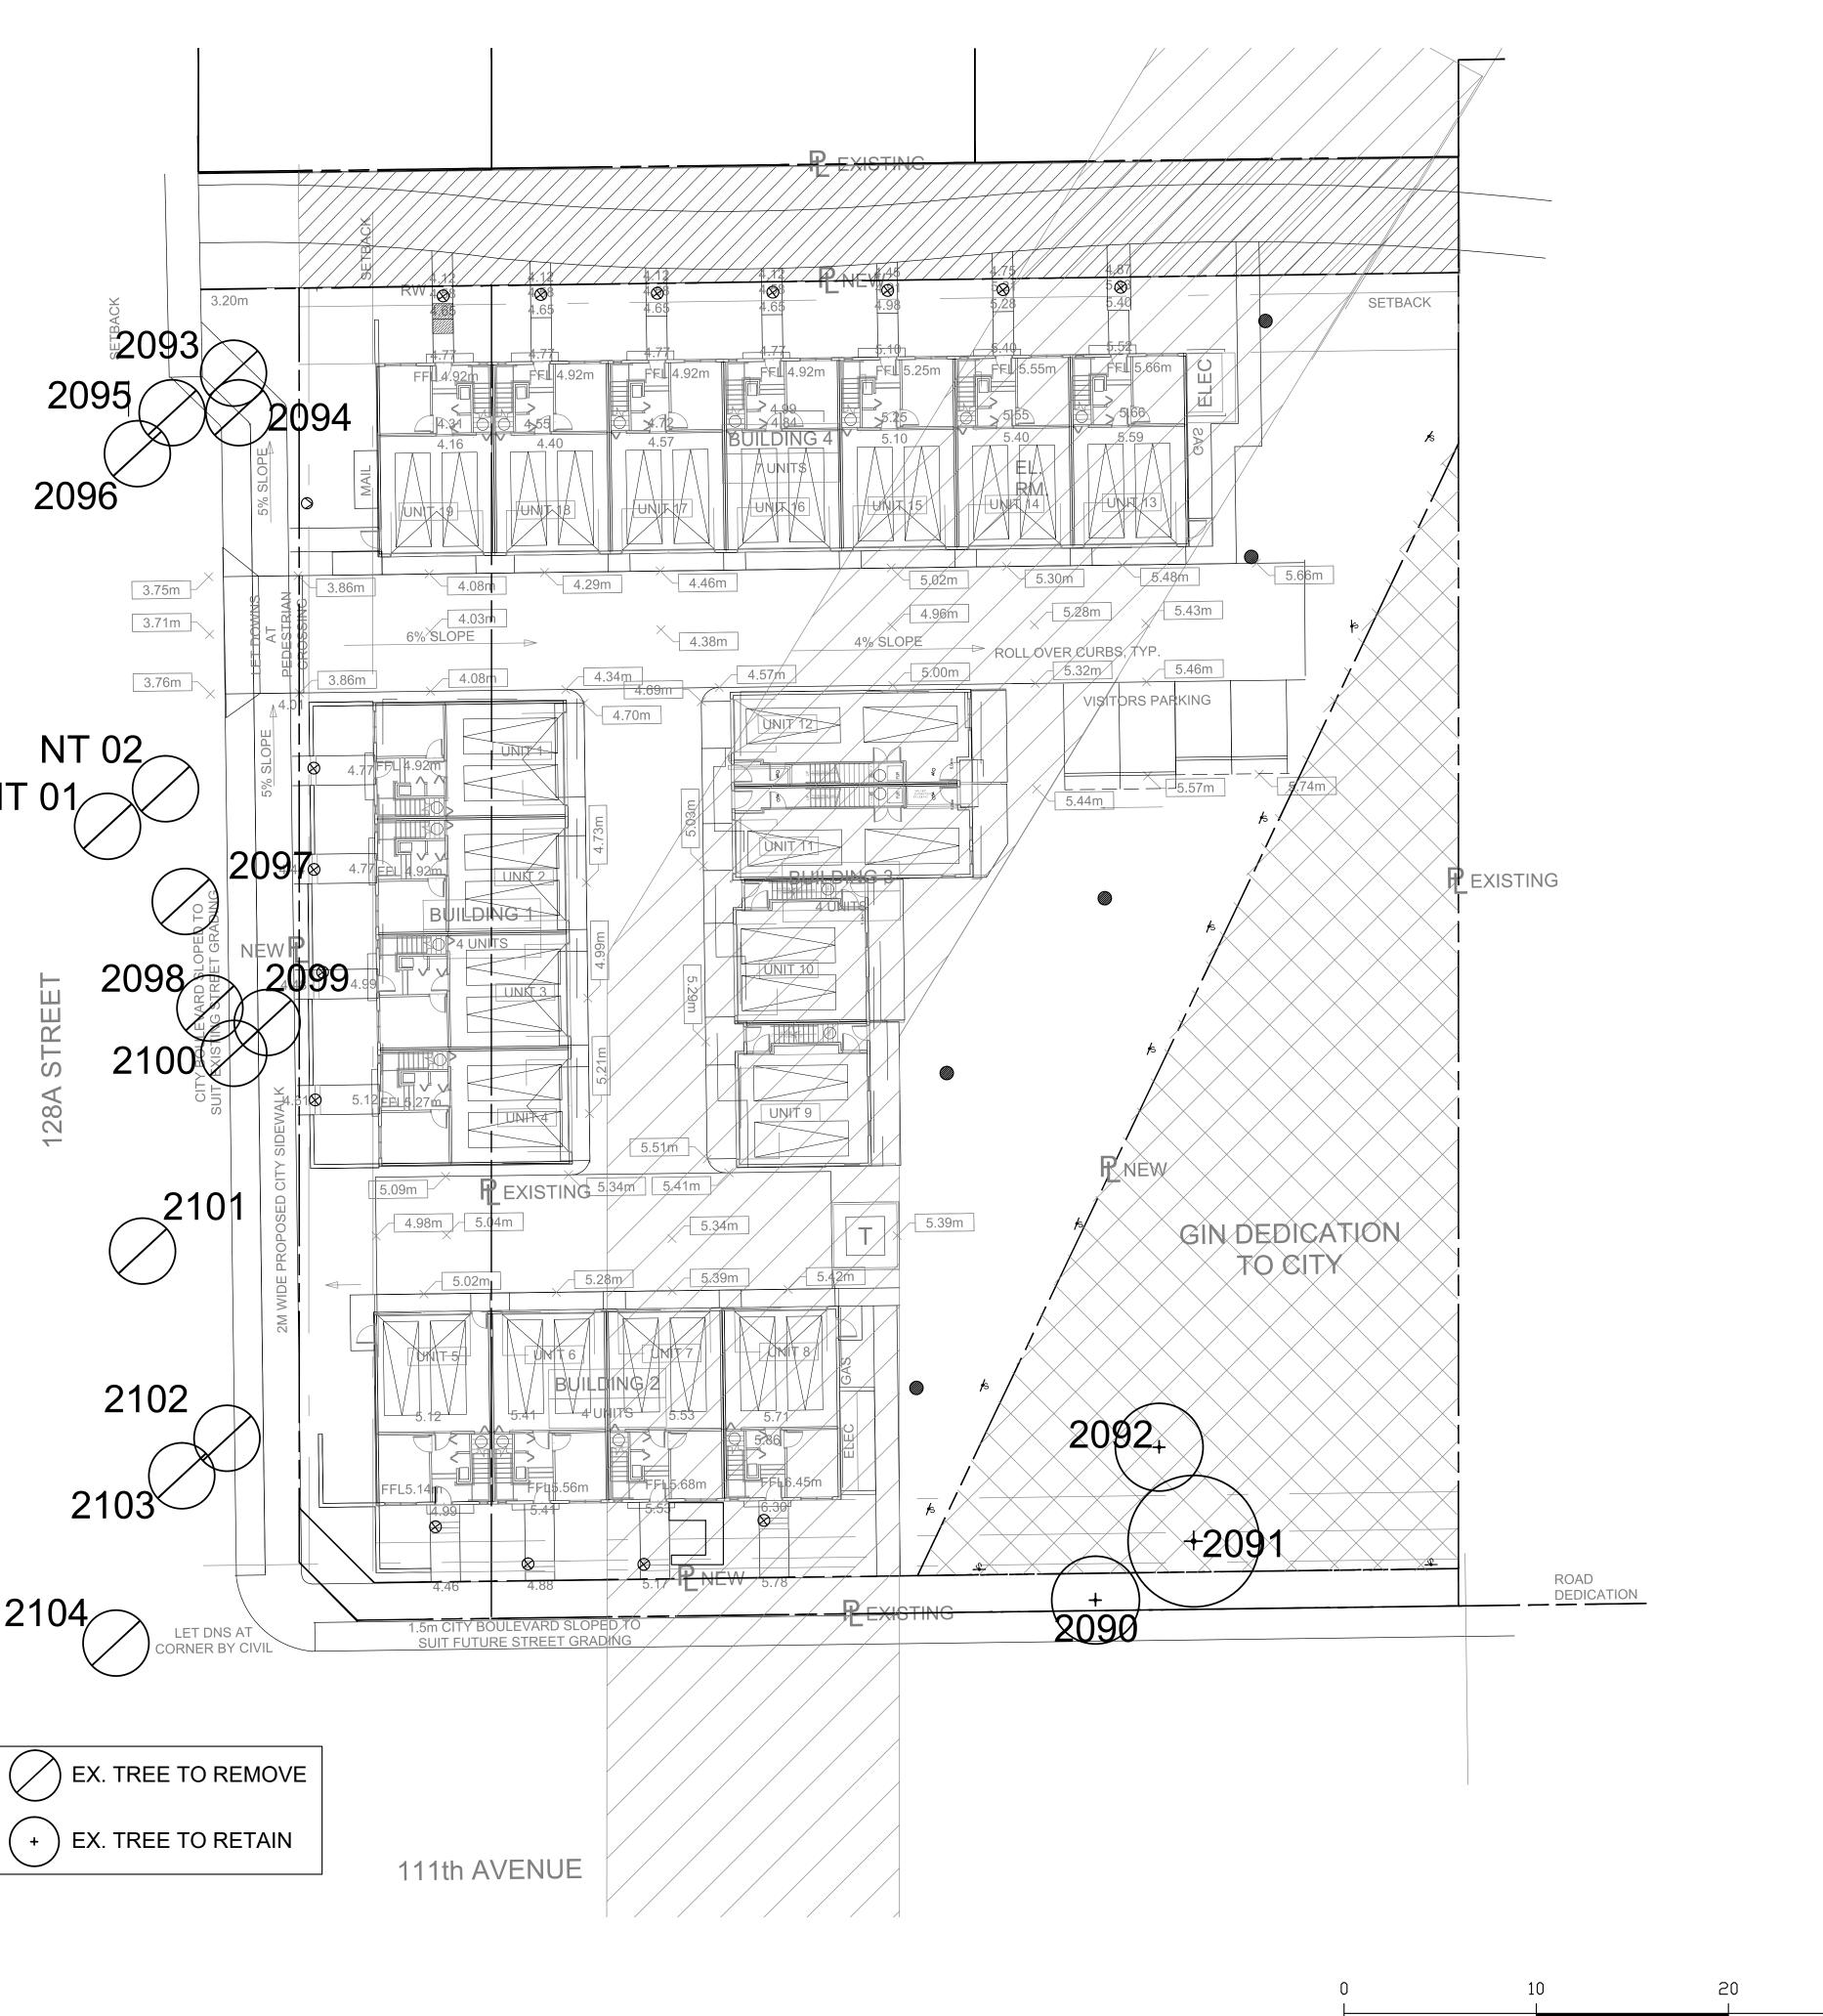


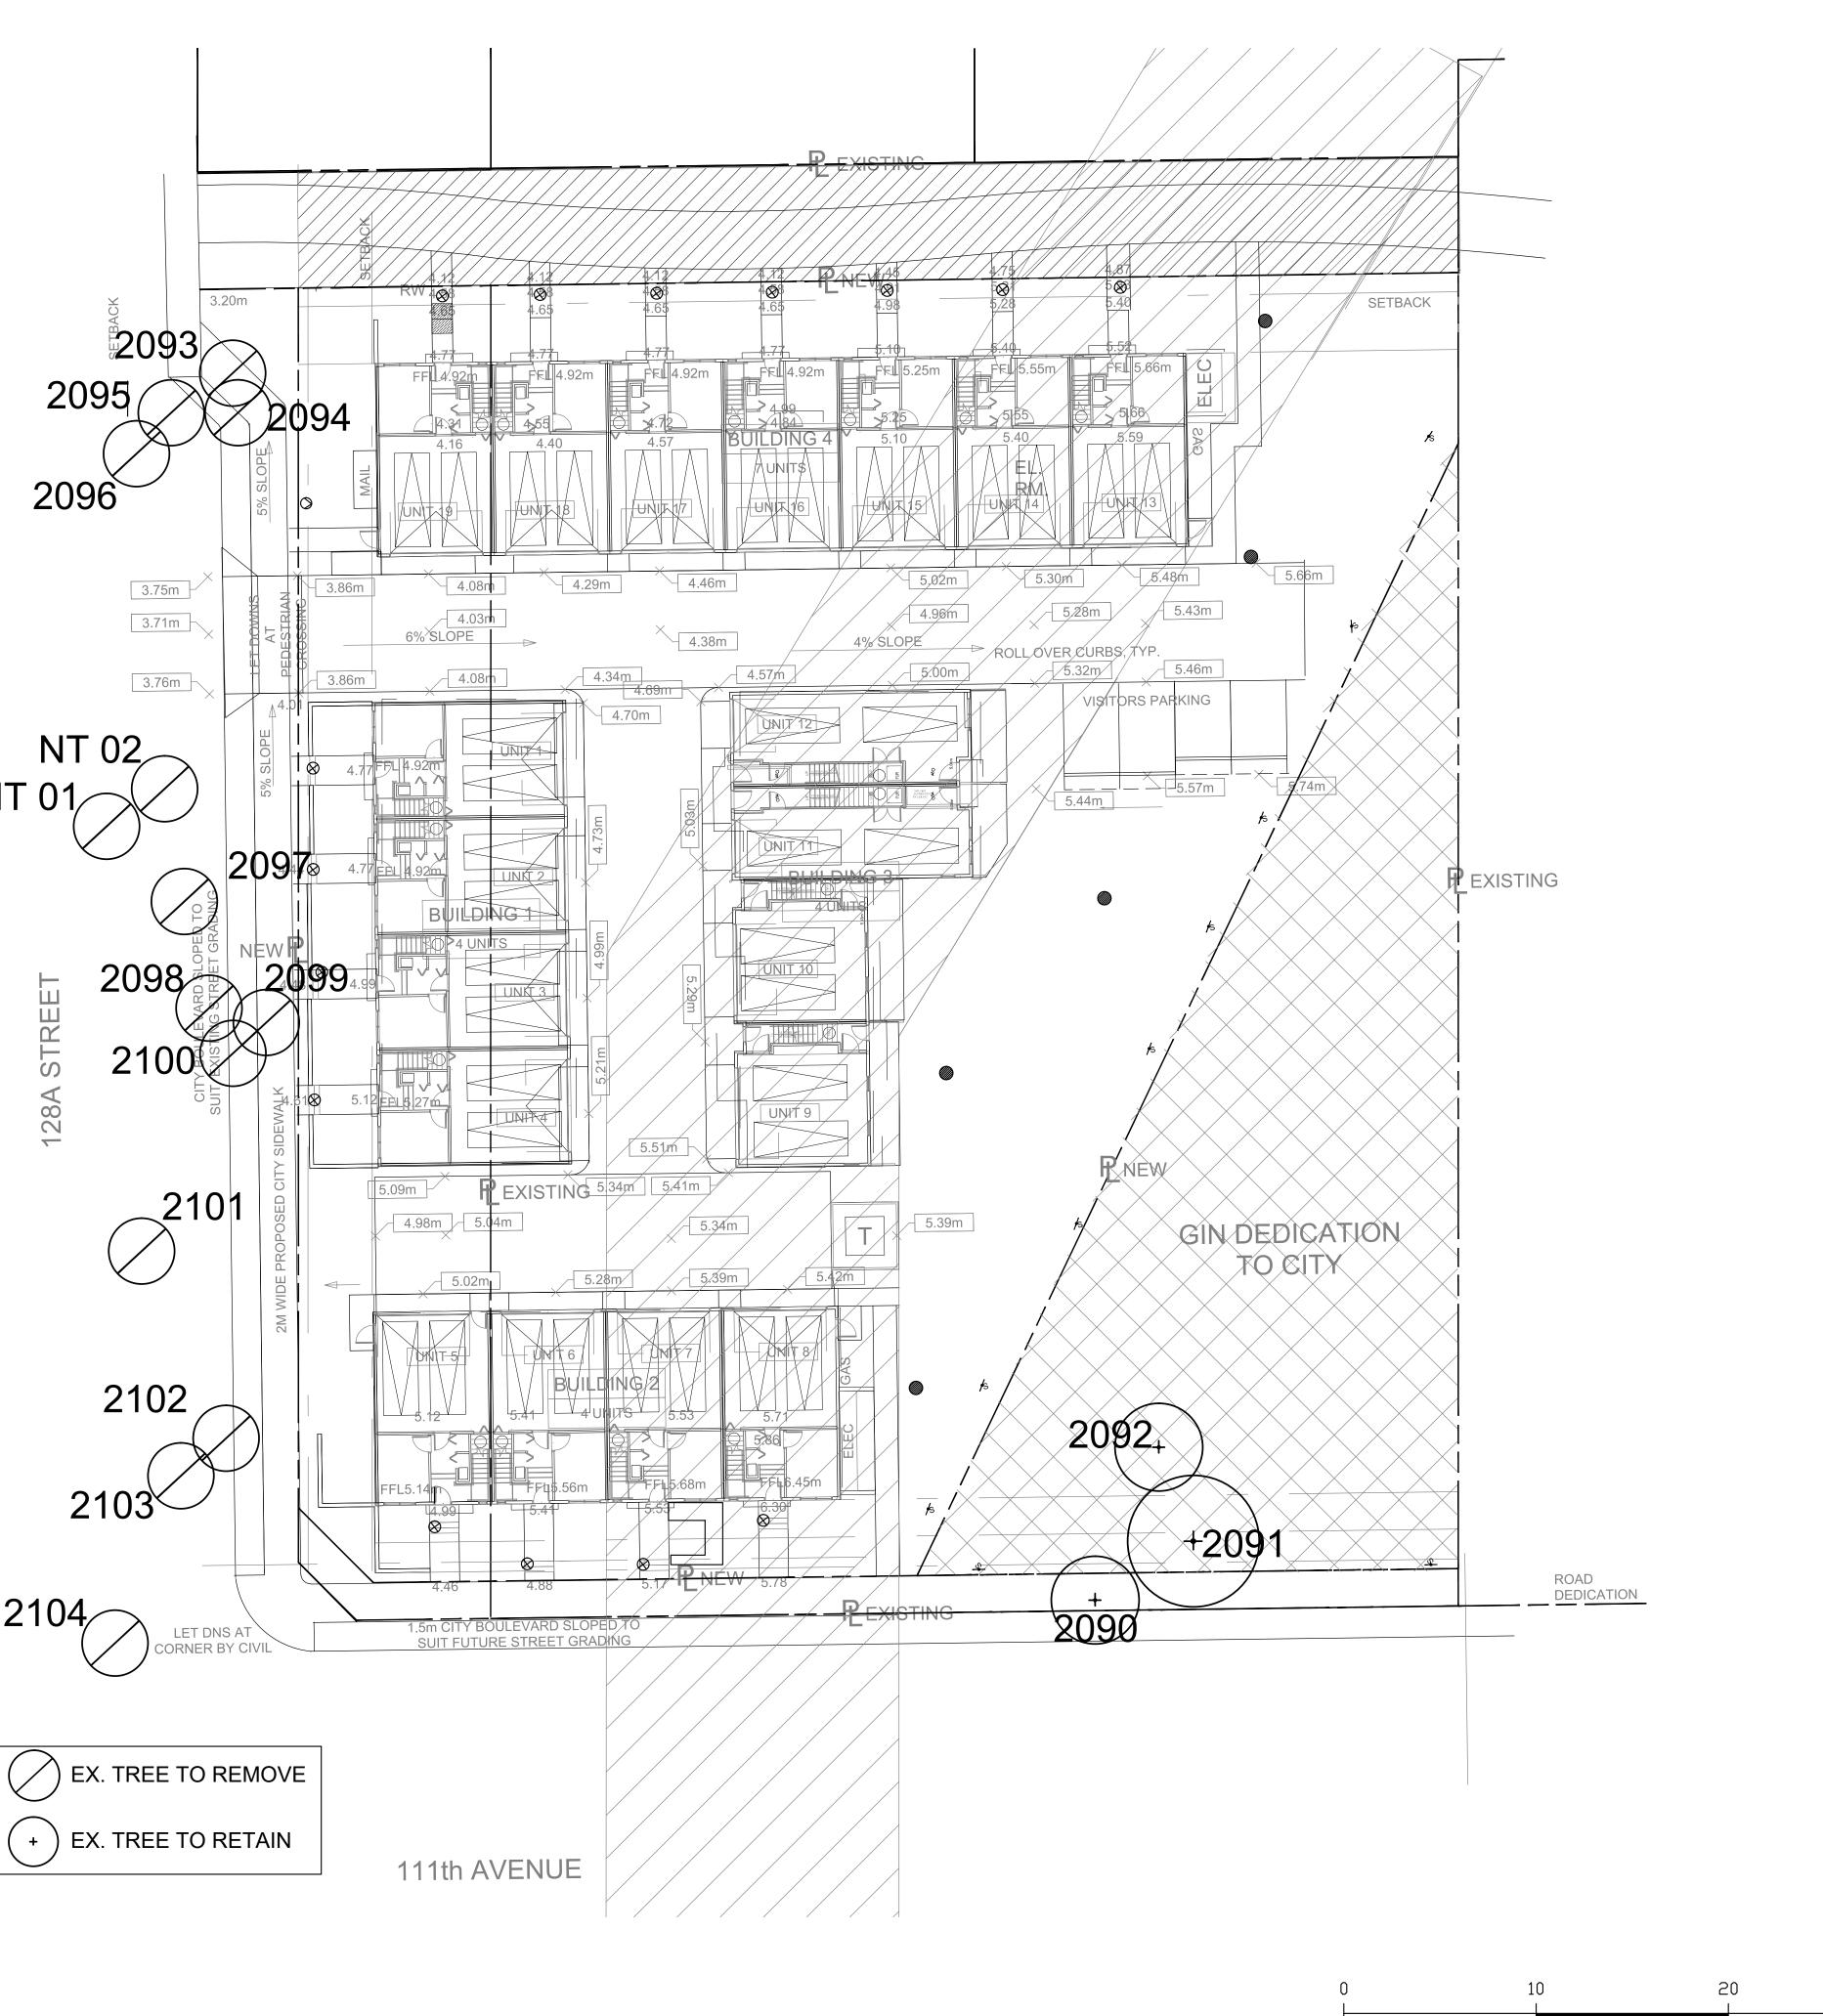

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8	18.SEP.25	UPDATE PER CITY COMMENTS/REISSUE	CLG
7	18.SEP.07	UPDATE PER CLIENT COMMENTS / REISSUE	CLG
6	18.SEP.06	UPDATE PER CITY COMMENTS / REISSUE	CLG
5	18.JUN.01	REVISION AS PER ENVIROWEST REPORT	DD
4	18.MAY.30	NEW SITE PLAN/ CITY COMMENTS	DD
3	16.JUN.08	REVISIONAS PER CITY REQUEST	DD
2	16.APR.06	UPDATE ROW AND REISSUE	CLG
1	16.AP.05	REISSUE	PC
NO.	DATE	REVISION DESCRIPTION	DR.

CLIENT:

PROJECT:
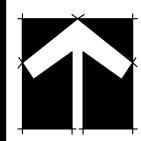
### **TOWNHOUSE DEVELOPMENT**

**111 AVENUE AND 128A STREET** SURREY, BC

DRAWING TITLE:

### TREE MANAGEMENT PLAN

DATE: SCALE: DRAWN: DESIGN: CHK'D:

16.JUL.07 1/16"=1'-0" MR MR

DRAWING NUMBER:

LO **OF 6** 

30m

15098-7.ZIP PMG PROJECT NUMBER:

PC

### Materials Legend

Symbol Model

### Site Furnishing Legend

Symbol	Model
	11x WISHBONE INDUSTRIES MODENA PARK BENCH 'M-5' BLACK POWDERCO/ & WALNUT COLOURED SLATS
	BIKE RACK FRANCES ANDREW EXPRESS LOLLIPOP E12-BR02, BOLTDOWN, COLOUR: MIDNIGHT BLUE. USE TAMPER RESISTANT HARDWARE
	BOULDERS, BURY 1/3RD MIN. 24" & MAX 48" DIAMETER. WHERE POSSIBLE RECUPERATE FROM EXISTING SITE.
	BALANCE LOGS, REFER TO DETAIL #7
00	BALANCE LOGS ON END, REFER TO DETAIL #7
	KOMPAN ELE400205-3717GR GREEN COLOUR, IN-GROUND MOUNTING, MODERN COTTAGE


	ABBOTSFORD CONCRETE PRODUCTS, CLASSIC STANDARD CONCRETE UNIT PAVER, 8.0CM DEPTH VEHICLE DUTY, COLOUR: SAND BROWN, HERRINGBONE PATTERN, INSTALL PER MANUFACTURERS SPECIFICATIONS
	'GRASSCRETE, PERMEABLE PAVERS ON WEED MAT, SAND WITH ¾''CRUSH INFILL. REFER TO MANUFACTURER'S SPECIFICATIONS AND ENGINEERING DRAWINGS FOR DRAINAGE AND BASE PREPARATION DETAILS. NOTIFY ENGINEERING CONSULTANT & LANDSCAPE ARCHITECT FOR REVIEW PRIOR TO INSTALL.
C	CONCRETE PATIO, BROOM FINISHED, DECORATIVE TROWEL TOOLING. REFER TO CIVIL DETAILS FOR STANDARD REINFORCEMENT AND SUBGRADE PREPARATION.
D	ENGINEERED WOOD FIBRE PLAY SURFACING: FIBAR OR APPROVED EQUIVALENT. 12" DEPTH. REFER TO DETAIL #6 'PLAYGROUND SAFETY SURFACE' FOR MORE INFORMATION.
	CONCRETE BROOM FINISHED WALKWAY WITH ABBOTSFORD CONCRETE 1'X2' SATURNA HYDRAPRESSED SLAB BANDING, COLOUR 'DESERT SAND'.
	WILDFLOWER AND GRASS MEADOW: SEEDED WITH 'COASTAL WILDFLOWER MIX WITH HARD FESCUE, PREMIER PACIFIC SEEDS LTD604 881-1323. OR APPROVED EQUIVALENT.
G	CRUSHER DUST PATH, 4" DEPTH ON LANDSCAPE CLOTH FOR WEED SUPPRESSION. MIX WITH NATURAL STABILIZER AVAILABLE FROM VERATEC.
	ABBOTSFORD CONCRETE PRODUCTS, VENETIAN COBBLE PAVER, PEDESTRIAN GRADE, 6.0CM DEPTH.

### Lighting Legend

Symbol	Model
	LIGHTING BOLLARD
$\otimes$	STEP LIGHT
$\bigcirc$	SIGNAGE UPLIGHTING

### Fencing Legend

Symbol	Model
	42" HT. ALUMINUM FENCE, REFER TO LANDSCAPE DETAILS SHEET
	6' HT. WOOD PERIMETER FENCE, REFER TO LANDSCAPE DETAILS SHEET
x	THREE RAIL SPLIT FENCE: REFER TO SURREY STANDARD DETAIL SSDPK6112

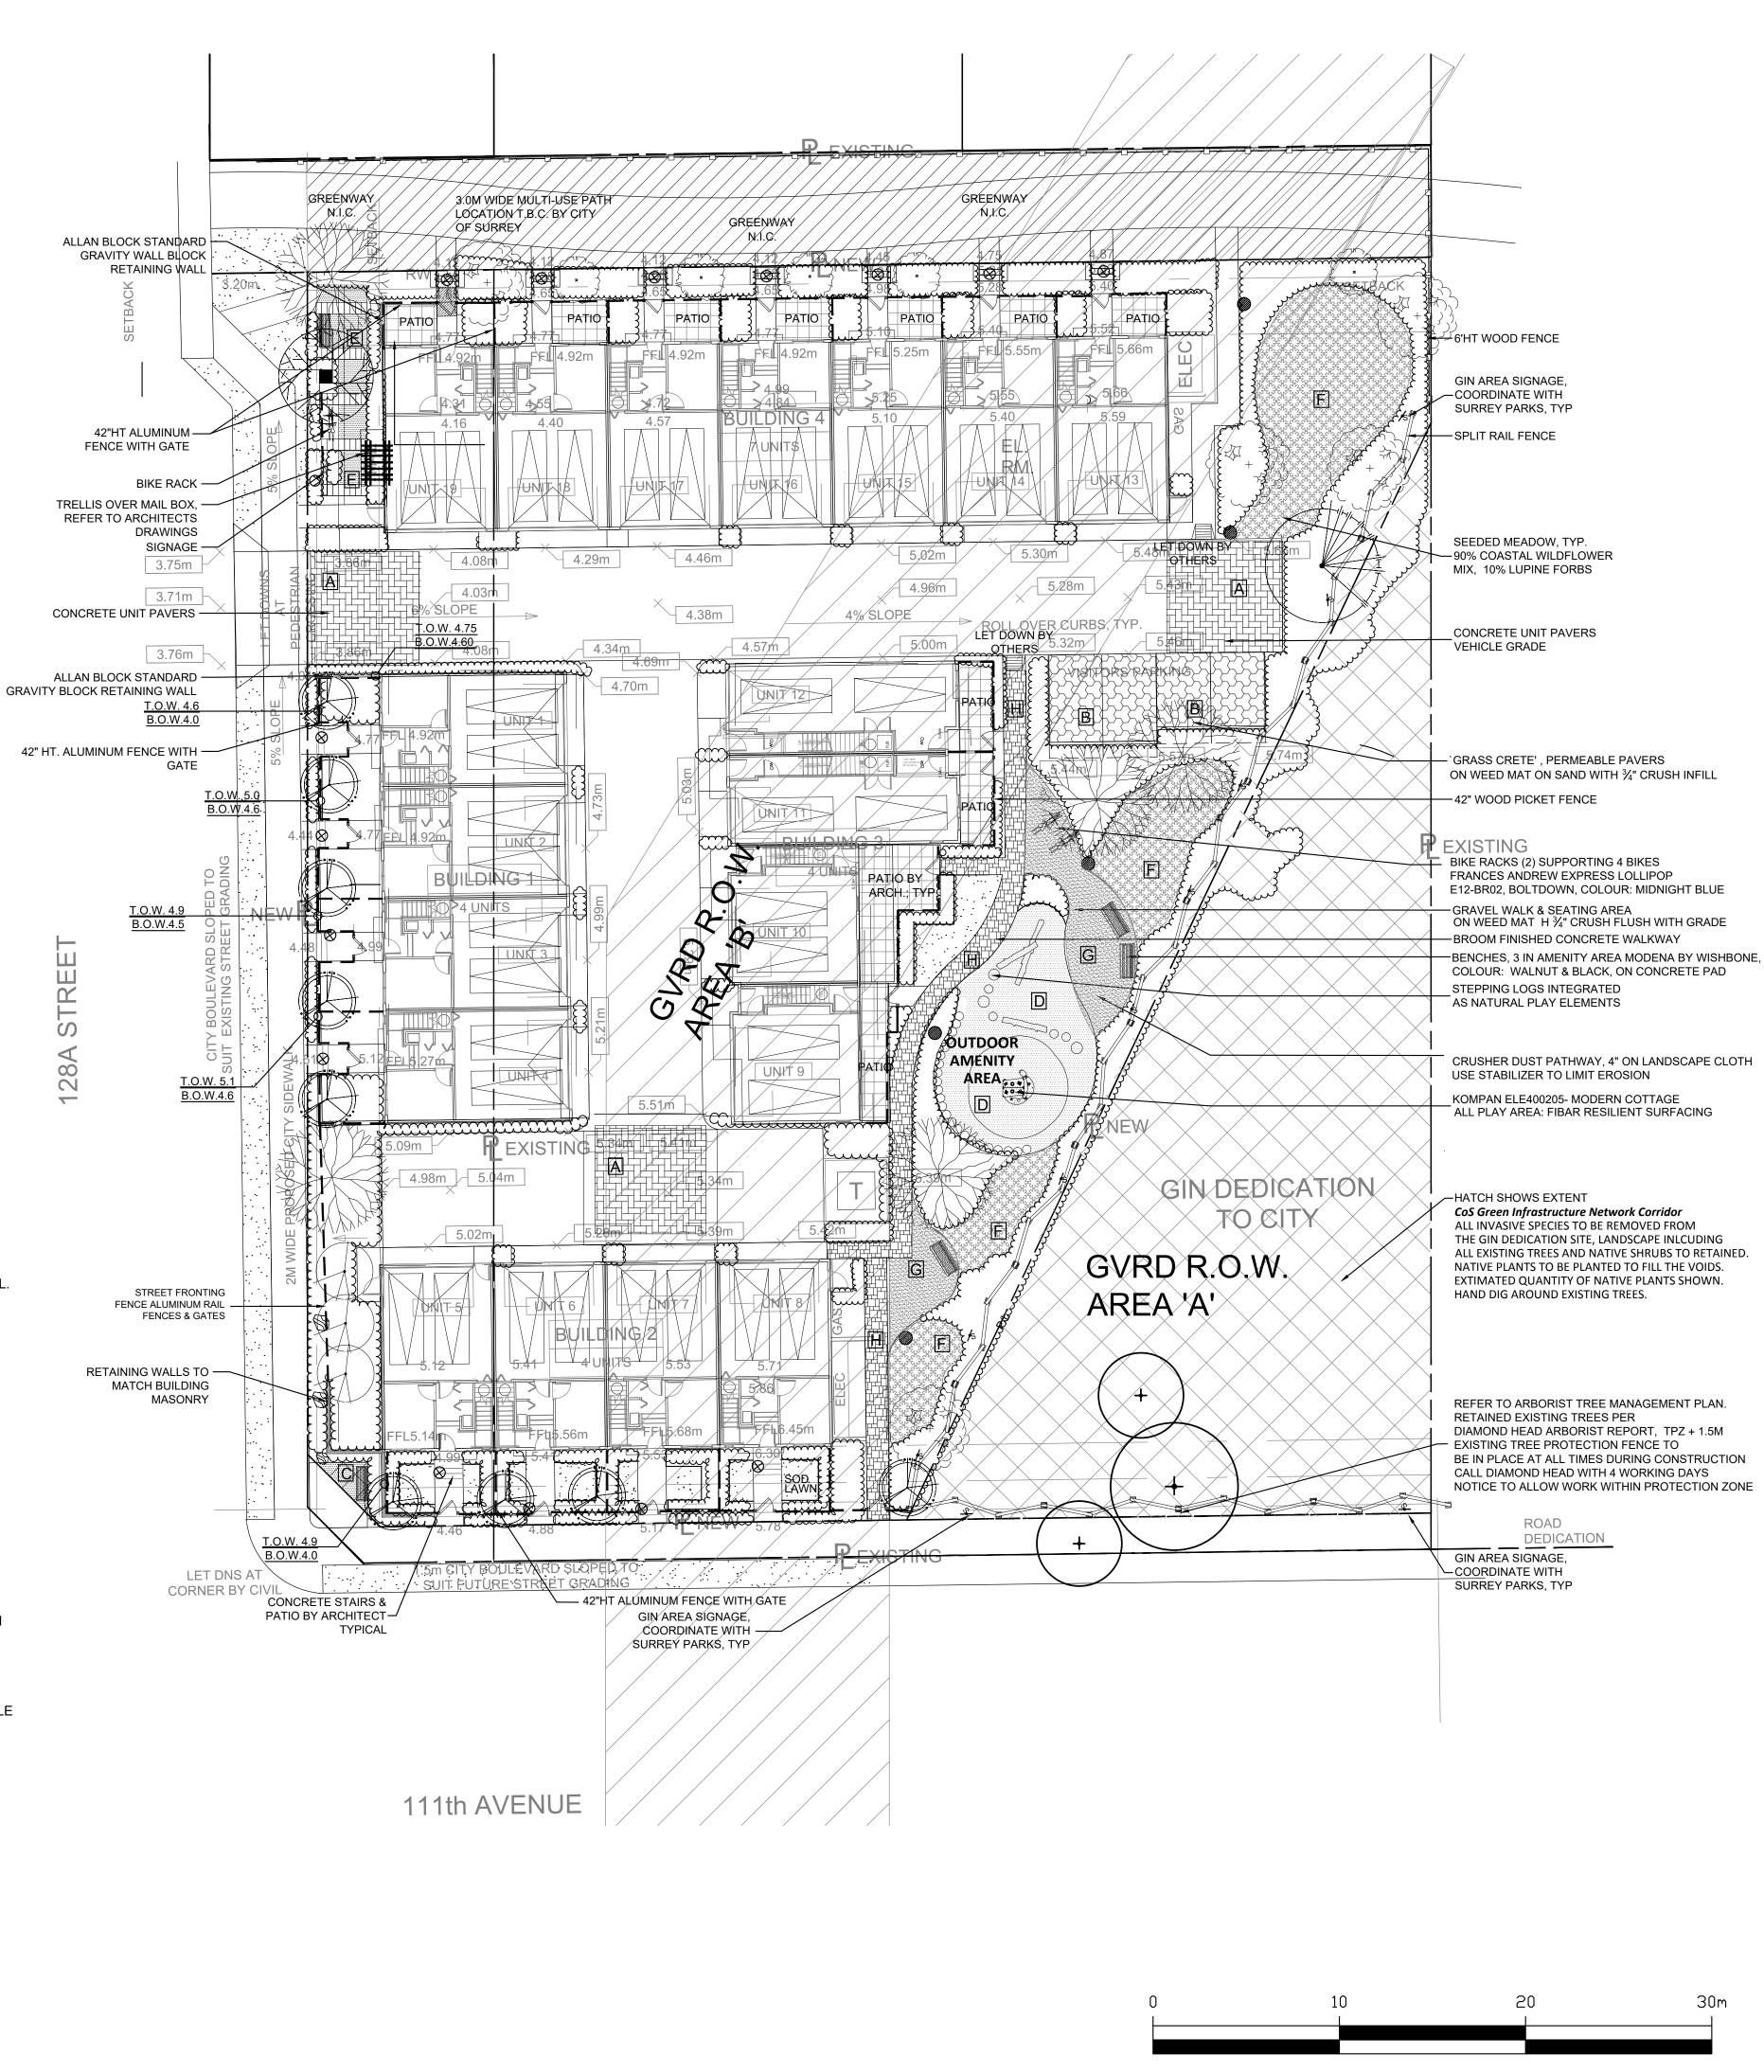

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6	18.SEP.06	UPDATE PER CITY COMMENTS / REISSUE	CLG
5 4	18.JUN.01 18.MAY.30	REVISION AS PER ENVIROWEST REPORT NEW SITE PLAN/ CITY COMMENTS	DD DD
3	16.JUN.08	REVISIONAS PER CITY REQUEST	DD
2	16.APR.06 16.AP.05	UPDATE ROW AND REISSUE REISSUE	CLG PC
NO.		REVISION DESCRIPTION	DR.

CLIENT:

PROJECT:

### TOWNHOUSE DEVELOPMENT

**111 AVENUE AND 128A STREET** SURREY, BC

DRAWING TITLE:



DATE:
SCALE:
DRAWN:
DESIGN:
CHK'D:

16.JUL.07 1/16"=1'-0" MR MR


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DRAWING NUMBER:

**OF 6** 


15098-7.ZIP PMG PROJECT NUMBER:

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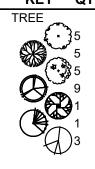
1 /8"=1'-0"

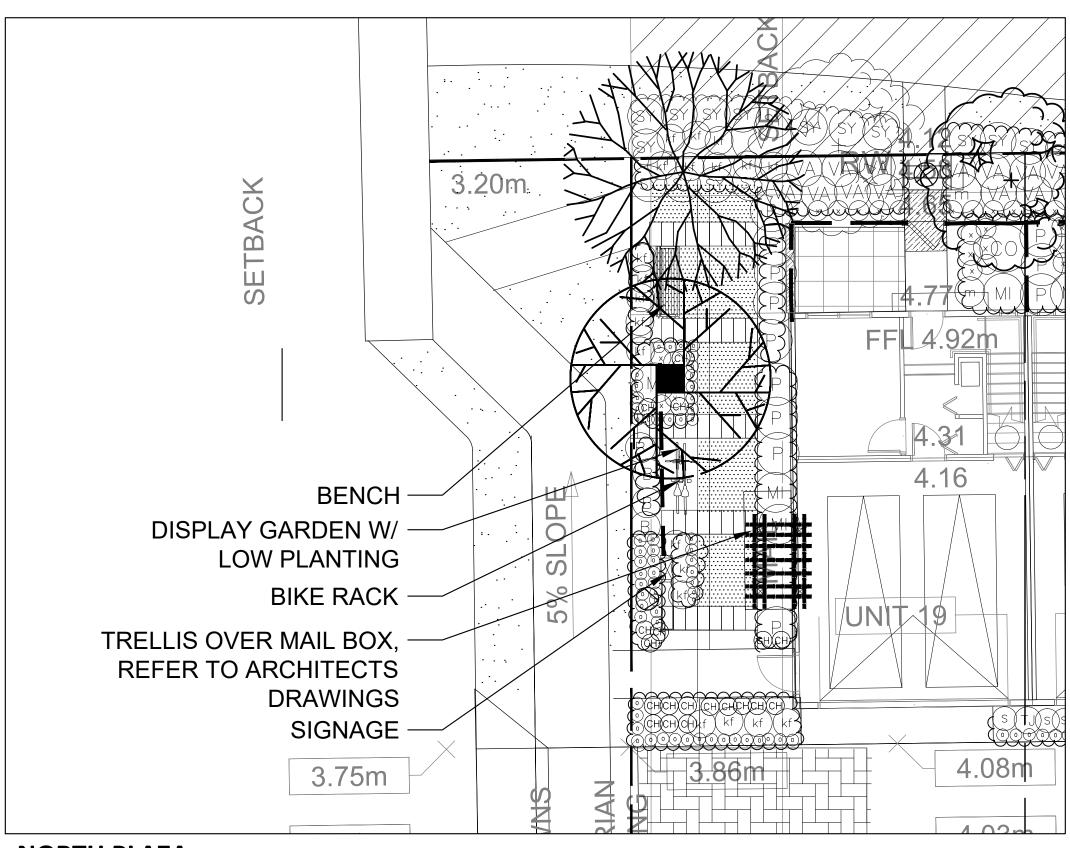

SOUTH PLAZA

1 /8"=1'-0"
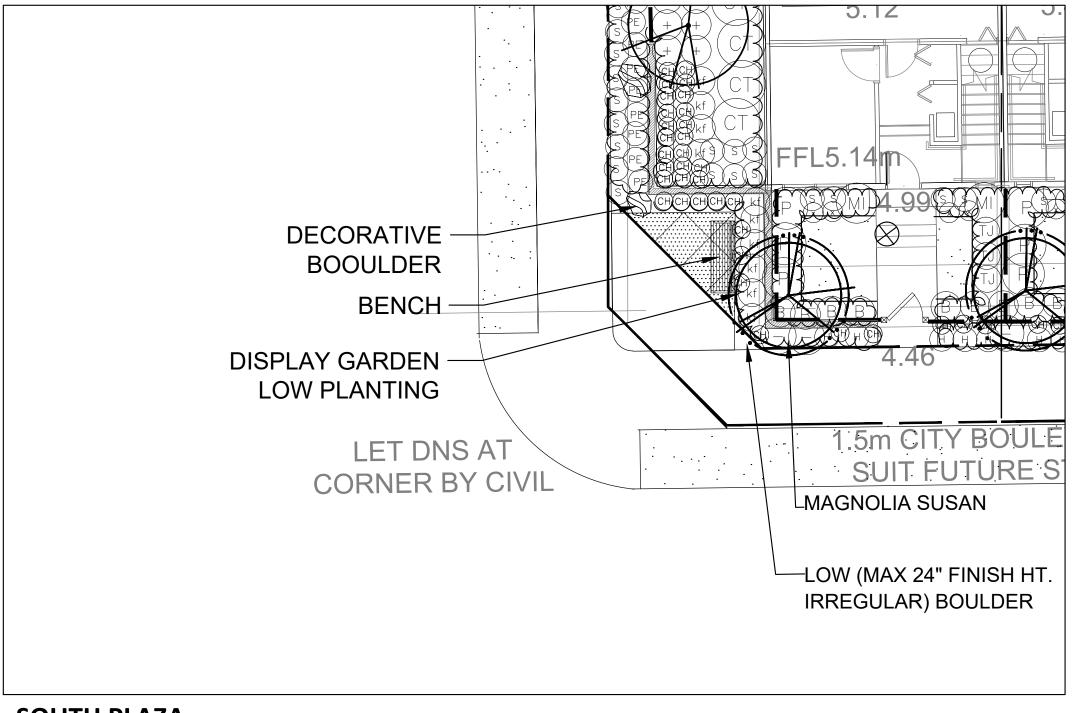
### **PLANT SCHEDULE: TREES** KEY QTY BOTANICAL NAME



ACER PALMATUM 'SEIRYU' ACER RUBRUM 'OCTOBER GLORY' CORNUS NUTTALLII MAGNOLIA x 'SUSAN' PARROTIA PERSICA 'RUBY VASE' PSEUDOTSUGA MENZIESII PYRUS CALLERYANA 'CHANTICLEER'


SEIRYU JAPANESE MAPLE OCTOBER GLORY MAPLE PACIFIC DOGWOOD SUSAN MAGNOLIA (RED-PURPLE) RUBY VASE PERSIAN IRONWOOD DOUGLAS FIR CHANTICLEER PEAR

COMMON NAME

PLANTED SIZE / REMARKS

5CM CAL; B&B 6CM CAL; 2M STD; B&B 3M HT; B&B 5 CM CAL; B&B 6CM CAL; 1.5M STD; B&B 3M HT; B&B 6CM CAL; 1.5M STD; B&B

NOTES: \* PLANT SIZES IN THIS LIST ARE SPECIFIED ACCORDING TO THE BC LANDSCAPE STANDARD, LATEST EDITION. CONTAINER SIZES SPECIFIED AS PER CNLA STANDARDS. BOTH PLANT SIZE AND CONTAINER SIZE ARE THE MINIMUM ACCEPTABLE SIZES. \* REFER TO SPECIFICATIONS FOR DEFINED CONTAINER MEASUREMENTS AND OTHER PLANT MATERIAL REQUIREMENTS. \* SEARCH AND REVIEW: MAKE PLANT MATERIAL AVAILABLE FOR OPTIONAL REVIEW BY LANDSCAPE ARCHITECT AT SOURCE OF SUPPLY. AREA OF SEARCH TO INCLUDE LOWER MAINLAND AND FRASER VALLEY. \* SUBSTITUTIONS: OBTAIN WRITTEN APPROVAL FROM THE LANDSCAPE ARCHITECT PRIOR TO MAKING ANY SUBSTITUTIONS TO THE SPECIFIED MATERIAL. UNAPPROVED SUBSTITUTIONS WILL BE REJECTED. ALLOW A MINIMUM OF FIVE DAYS PRIOR TO DELIVERY FOR REQUEST TO SUBSTITUTE. SUBSTITUTIONS ARE SUBJECT TO BC LANDSCAPE STANDARD - DEFINITION OF CONDITIONS OF AVAILABILITY. ALL LANDSCAPE MATERIAL AND WORKMANSHIP MUST MEET OR EXCEED BC LANDSCAPE STANDARD'S LATEST EDITION. ALL PLANT MATERIAL MUST BE PROVIDED FROM CERTIFIED DISEASE FREE NURSERY

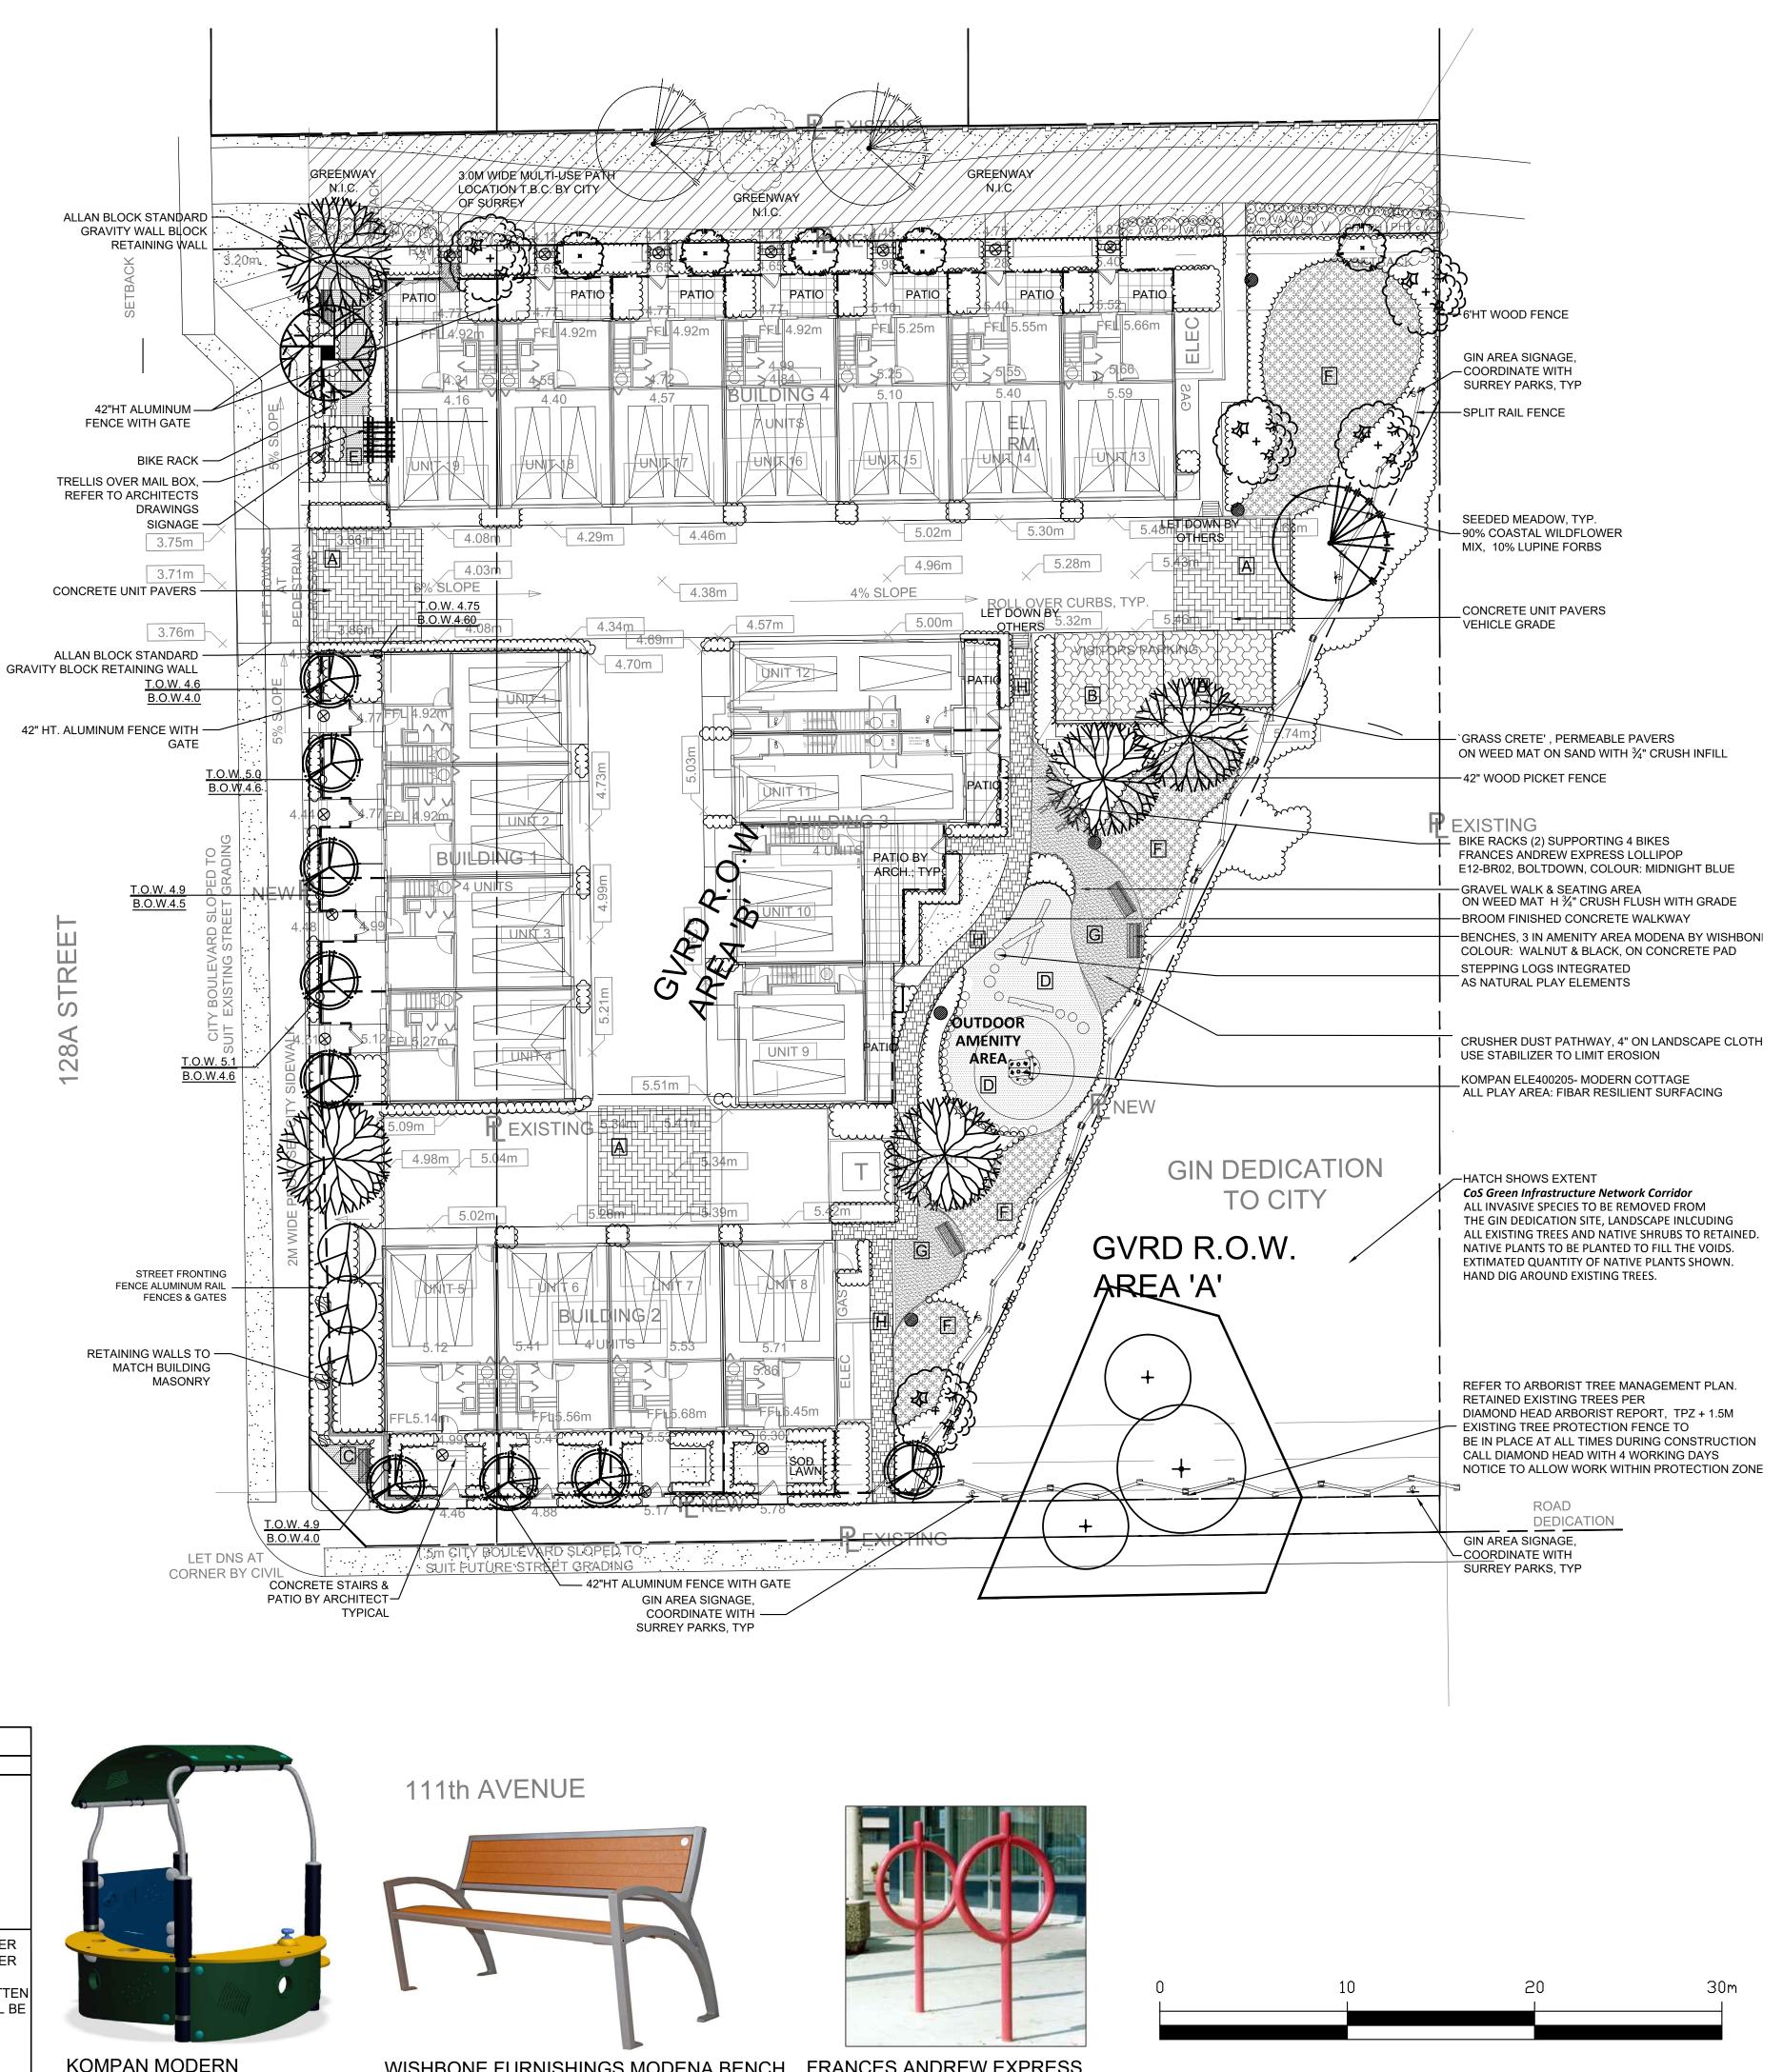



KOMPAN MODERN COTTAGE ELE400205



WISHBONE FURNISHINGS MODENA BENCH COLOUR, WALNUT BLACK POWDERCOAT



FRANCES ANDREW EXPRESS LOLLIPOP BIKE RACK

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Su		- 4185 Still Creek Drive	
Bu	ırnaby, Br	itish Columbia, V5C 6G9	
p:	604 294-	0011 ; f: 604 294-0022	
SEA	AL:		
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8	18.SEP.25	UPDATE PER CITY COMMENTS/REISSUE	CLG
7	18.SEP.07	UPDATE PER CLIENT COMMENTS /REISSUE	CLG
6 5	18.SEP.06 18.JUN.01	UPDATE PER CITY COMMENTS / REISSUE REVISION AS PER ENVIROWEST REPORT	CLG DD
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2	16.APR.06 16.AP.05	UPDATE ROW AND REISSUE REISSUE	CLG PC
NO.		REVISION DESCRIPTION	DR.
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CLIENT:

PROJECT:

### **TOWNHOUSE DEVELOPMENT**

**111 AVENUE AND 128A STREET** SURREY, BC

DRAWING TITLE:

### LANDSCAPE PLAN

DATE:
SCALE:
DRAWN:
DESIGN:
CHK'D:

16.JUL.07 1/16"=1'-0" MR

MR

DRAWING NUMBER:

15-098

**OF 6** 

PLA	NT S	CHEDULE- S	SHRUBS & GROUNDCOVERS
KEY	QTY	BOTANICAL NAME	COMMON NAME


PMG FILE: 15-098 PLANTED SIZE / REMARKS

SHRUB				
В	132	BUXUS SEMPERVIRENS `GREEN VELVET'	BOXWOOD	#2 POT; 60CM
B CT	8	CHOISYA TERNATA	MEXICAN MOCK ORANGE	#3 POT; 50CM
$\overline{(0)}$	3	CORNUS SERICEA	RED OSIER DOGWOOD	#2 POT; 50CM
	25	CORNUS STOLONIFERA	RED OSIER DOGWOOD	#2 POT; 50CM
MA	24	MAHONIA AQUIFOLIUM	OREGON GRAPE	#3 POT; 50CM
$\bigtriangledown$	15	OEMLERIA CERASIFORMIS	INDIAN PLUM	#3 POT; 50CM
	61	PIERIS JAPONICA 'VALLEY VALENTINE'	PIERIS; RED BLOOMS	#3 POT; 50CM
PH	15	RUBUS SPECTABILIS	SALMONBERRY	#2 POT; 40CM
SY	50	SYMPHORICARPOS MOLLIS	TRAILING SNOWBERRY	#2 POT; 30CM
TJ	53	THUJA OCCIDENTALIS 'SMARAGD'	EMERALD GEM HEDGING CEDAR	1.5M B&B
(VA)	53	VACCINIUM OVATUM	EVERGREEN HUCKLEBERRY	#2 POT; 50CM
RASS				
kf	112	CALAMAGROSTIS ACUTIFLORA 'KARL FOERSTER'	FEATHER REED GRASS	#1 POT
kf HA H + MI S	27	HAKONECHLOA MACRA 'AUREOLA'	GOLD VARIEGATED JAPANESE FOREST GRASS	#1 POT
(H)	27	HELICTOTRICHON SEMPERVIRENS	BLUE OAT GRASS	#1 POT
(+)	27	MISCANTHUS SINENSIS 'YAKU JIMA'	YAKU JIMA GRASS	#1 POT
MI	48	MISCANTHUS SINENSIS `PURPURASCENS'	FLAME GRASS	#2 POT
s	73	STIPA TENUISSIMA	MEXICAN FEATHER GRASS	#1 POT
ERENN	NIAL			
$\bigcirc$	302	BERGENIA CORDIFOLIA	HEARTLEAF BERGENIA; ROSE PINK	15CM POT
0 m CH PE	107	MONARDA `PRAIRIE NIGHT'	BEE BALM; PINK-VIOLET	15CM POT
СН	96	NEPETA x FAASSENII 'DROPMORE'	BLUE CATMINT	15 CM POT
PE	20	PENSTEMON DAVIDSONII	DAVIDSON'S PENSTEMON	15 CM POT
SC				
(A)	120	ARCTOSTAPHYLOS UVA-URSI	KINNICKINICK	#1 POT; 20CM
$\mathbf{x}$	355	GAULTHERIA SHALLON	SALAL	#1 POT; 20CM
(-)	49	LONICERA PILEATA	HONEYSUCKLE	#2 POT; 25CM

NOTES: \* PLANT SIZES IN THIS LIST ARE SPECIFIED ACCORDING TO THE BC LANDSCAPE STANDARD, LATEST EDITION. CONTAINER SIZES SPECIFIED AS PER CNLA STANDARDS. BOTH PLANT SIZE AND CONTAINER SIZE ARE THE MINIMUM ACCEPTABLE SIZES. \* REFER TO SPECIFICATIONS FOR DEFINED CONTAINER MEASUREMENTS AND OTHER PLANT MATERIAL REQUIREMENTS. \* SEARCH AND REVIEW: MAKE PLANT MATERIAL AVAILABLE FOR OPTIONAL REVIEW BY LANDSCAPE ARCHITECT AT SOURCE OF SUPPLY. AREA OF SEARCH TO INCLUDE LOWER MAINLAND AND FRASER VALLEY. \* SUBSTITUTIONS: OBTAIN WRITTEN APPROVAL FROM THE LANDSCAPE ARCHITECT PRIOR TO MAKING ANY SUBSTITUTIONS TO THE SPECIFIED MATERIAL. UNAPPROVED SUBSTITUTIONS WILL BE REJECTED. ALLOW A MINIMUM OF FIVE DAYS PRIOR TO DELIVERY FOR REQUEST TO SUBSTITUTE. SUBSTITUTIONS ARE SUBJECT TO BC LANDSCAPE STANDARD - DEFINITION OF CONDITIONS OF AVAILABILITY. ALL LANDSCAPE MATERIAL AND WORKMANSHIP MUST MEET OR EXCEED BC LANDSCAPE STANDARD'S LATEST EDITION. ALL PLANT MATERIAL MUST BE PROVIDED FROM CERTIFIED DISEASE FREE NURSERY

PLANT SCHEDULE - GIN AREA ONLY				PMG PROJECT NUMBER: 15-09	
KEY	QTY	BOTANICAL NAME	COMMON NAME	PLANTED SIZE / REMARKS	
HRUB					
(co)	2	CORNUS SERICEA	RED OSIER DOGWOOD	#2 POT; 50CM	
$\widetilde{\mathbf{c}}$	98	CORNUS STOLONIFERA	RED OSIER DOGWOOD	#2 POT; 50CM	
(MA)	52	MAHONIA AQUIFOLIUM	OREGON GRAPE	#3 POT; 50CM	
$\bowtie$	36	OEMLERIA CERASIFORMIS	INDIAN PLUM	#3 POT; 50CM	
(R)	32	RIBES SANGUINEUM	RED FLOWERING CURRANT	#3 POT; 80CM	
PH	29	RUBUS SPECTABILIS	SALMONBERRY	#2 POT; 40CM	
(SY)	2	SYMPHORICARPOS MOLLIS	TRAILING SNOWBERRY	#2 POT; 30CM	
SY VA C	3	VACCINIUM OVATUM	EVERGREEN HUCKLEBERRY	#2 POT; 50CM	
A	2	ARCTOSTAPHYLOS UVA-URSI	KINNICKINICK	#1 POT; 20CM	
$\times$	12	GAULTHERIA SHALLON	SALAL	#1 POT; 20CM	
ECIFIED ASURE JRCE (	D AS PE MENTS DF SUPI	R CNLA STANDARD. BOTH PLANT SIZE AND AND OTHER PLANT MATERIAL REQUIREMEN PLY. AREA OF SEARCH TO INCLUDE LOWER	CONTAINER SIZE ARE THE MINIMUM ACCEPTABLE SIZES NTS. * SEARCH AND REVIEW: MAKE PLANT MATERIAL AV	ANDSCAPE STANDARD, LATEST EDITION. CONTAINER SIZ 3. * REFER TO SPECIFICATIONS FOR DEFINED CONTAINER AILABLE FOR OPTIONAL REVIEW BY LANDSCAPE ARCHITEC FAIN WRITTEN APPROVAL FROM THE LANDSCAPE ARCHITE	

AVAILABILITY. \* ALL LANDSCAPE MATERIAL AND WORKMANSHIP MUST MEET OR EXCEED BC LANDSCAPE STANDARD AND CANADIAN LANDSCAPE STANDARD LATEST EDITION. \* ALL PLANT MATERIAL MUST BE PROVIDED FROM CERTIFIED DISEASE FREE NURSERY. \* BIO-SOLIDS NOT PERMITTED IN GROWING MEDIUM UNLESS AUTHORIZED BY LANDSCAPE ARCHITECT.

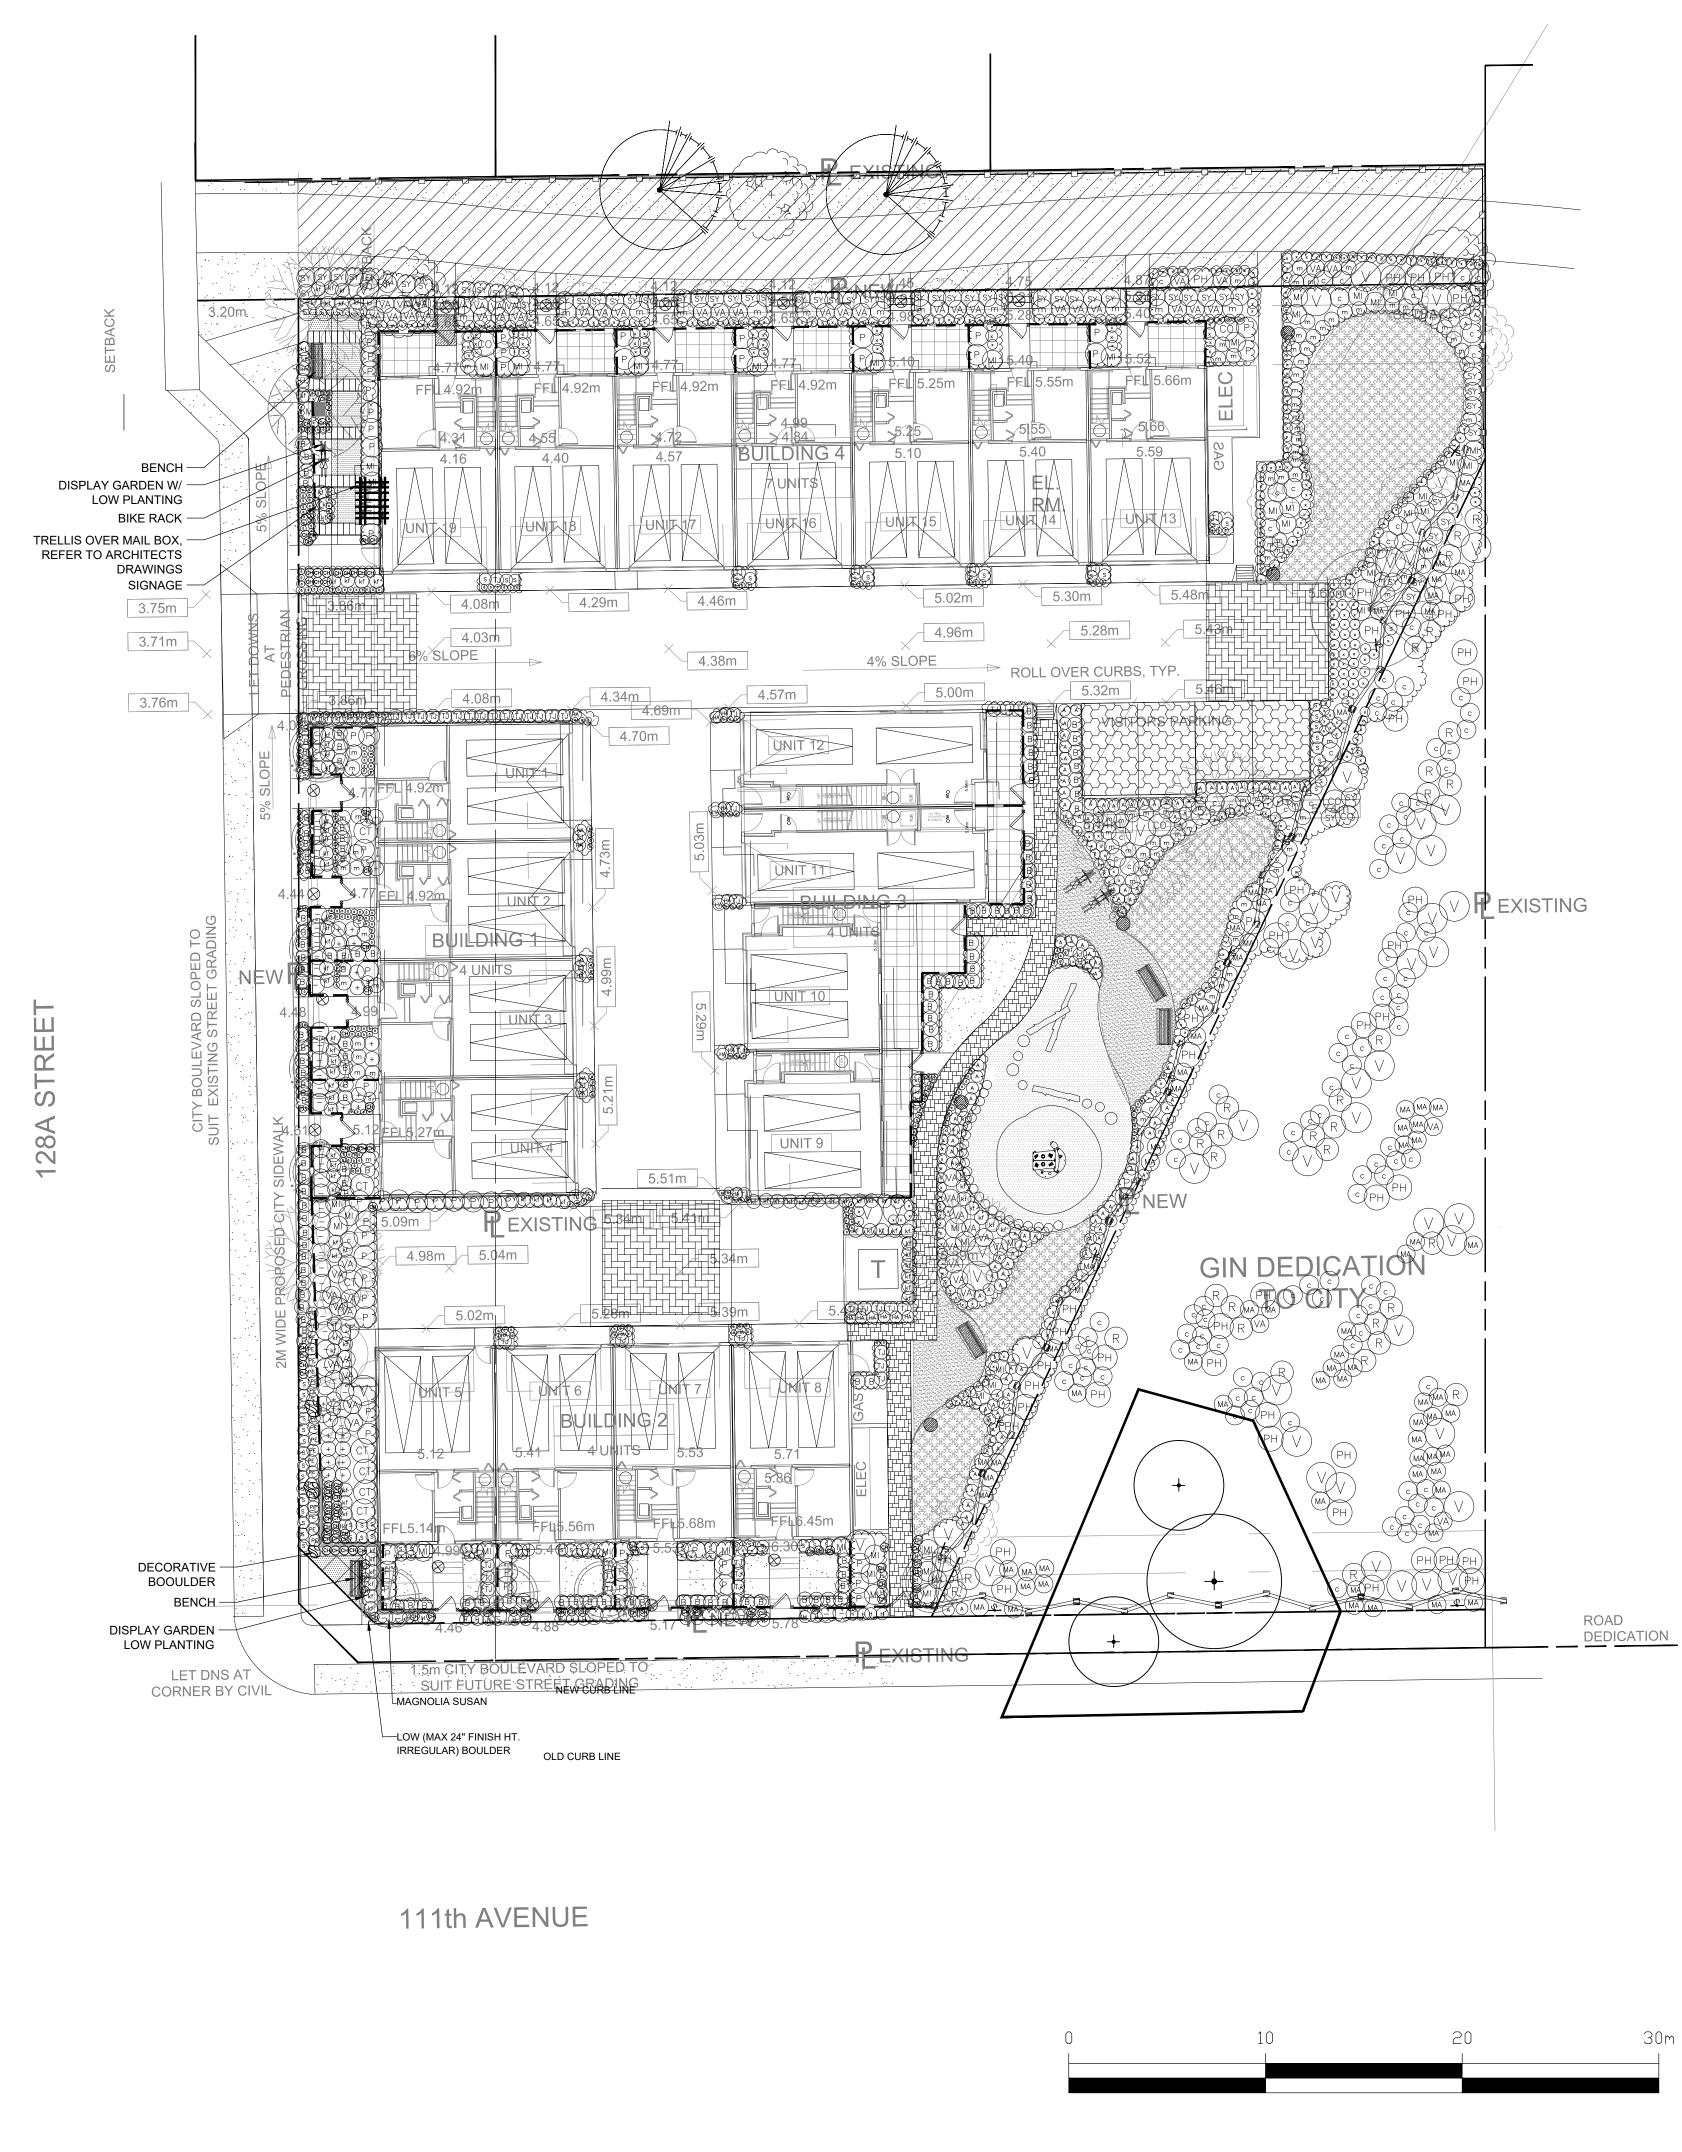

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LANDSCAPE O
Suite C100 - 4185 Still Creek Drive Burnaby, British Columbia, V5C 6G9 p: 604 294-0011 ; f: 604 294-0022
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8	18.SEP.25	UPDATE PER CITY COMMENTS/REISSUE	CLG
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2	16.APR.06	UPDATE ROW AND REISSUE	CLG
1	16.AP.05	REISSUE	PC
NO.	DATE	REVISION DESCRIPTION	DR.

CLIENT:

PROJECT:

### TOWNHOUSE DEVELOPMENT

**111 AVENUE AND 128A STREET** SURREY, BC

DRAWING TITLE: SHRUB PLAN

DATE: SCALE: DRAWN: DESIGN: CHK'D:

16.JUL.07 1/16"=1'-0" MR MR

PC

DRAWING NUMBER:

.3


15098-7.ZIP PMG PROJECT NUMBER:

15-098

OF 6

### Fencing Legend


Symbol	Model
	42" HT. ALUMINUM FENCE, REFER TO LANDSCAPE DETAILS SHEET
	6' HT. WOOD PERIMETER FENCE, REFER TO LANDSCAPE DETAILS SHEET
×	THREE RAIL SPLIT FENCE: REFER TO SURREY STANDARD DETAIL SSDPK6112

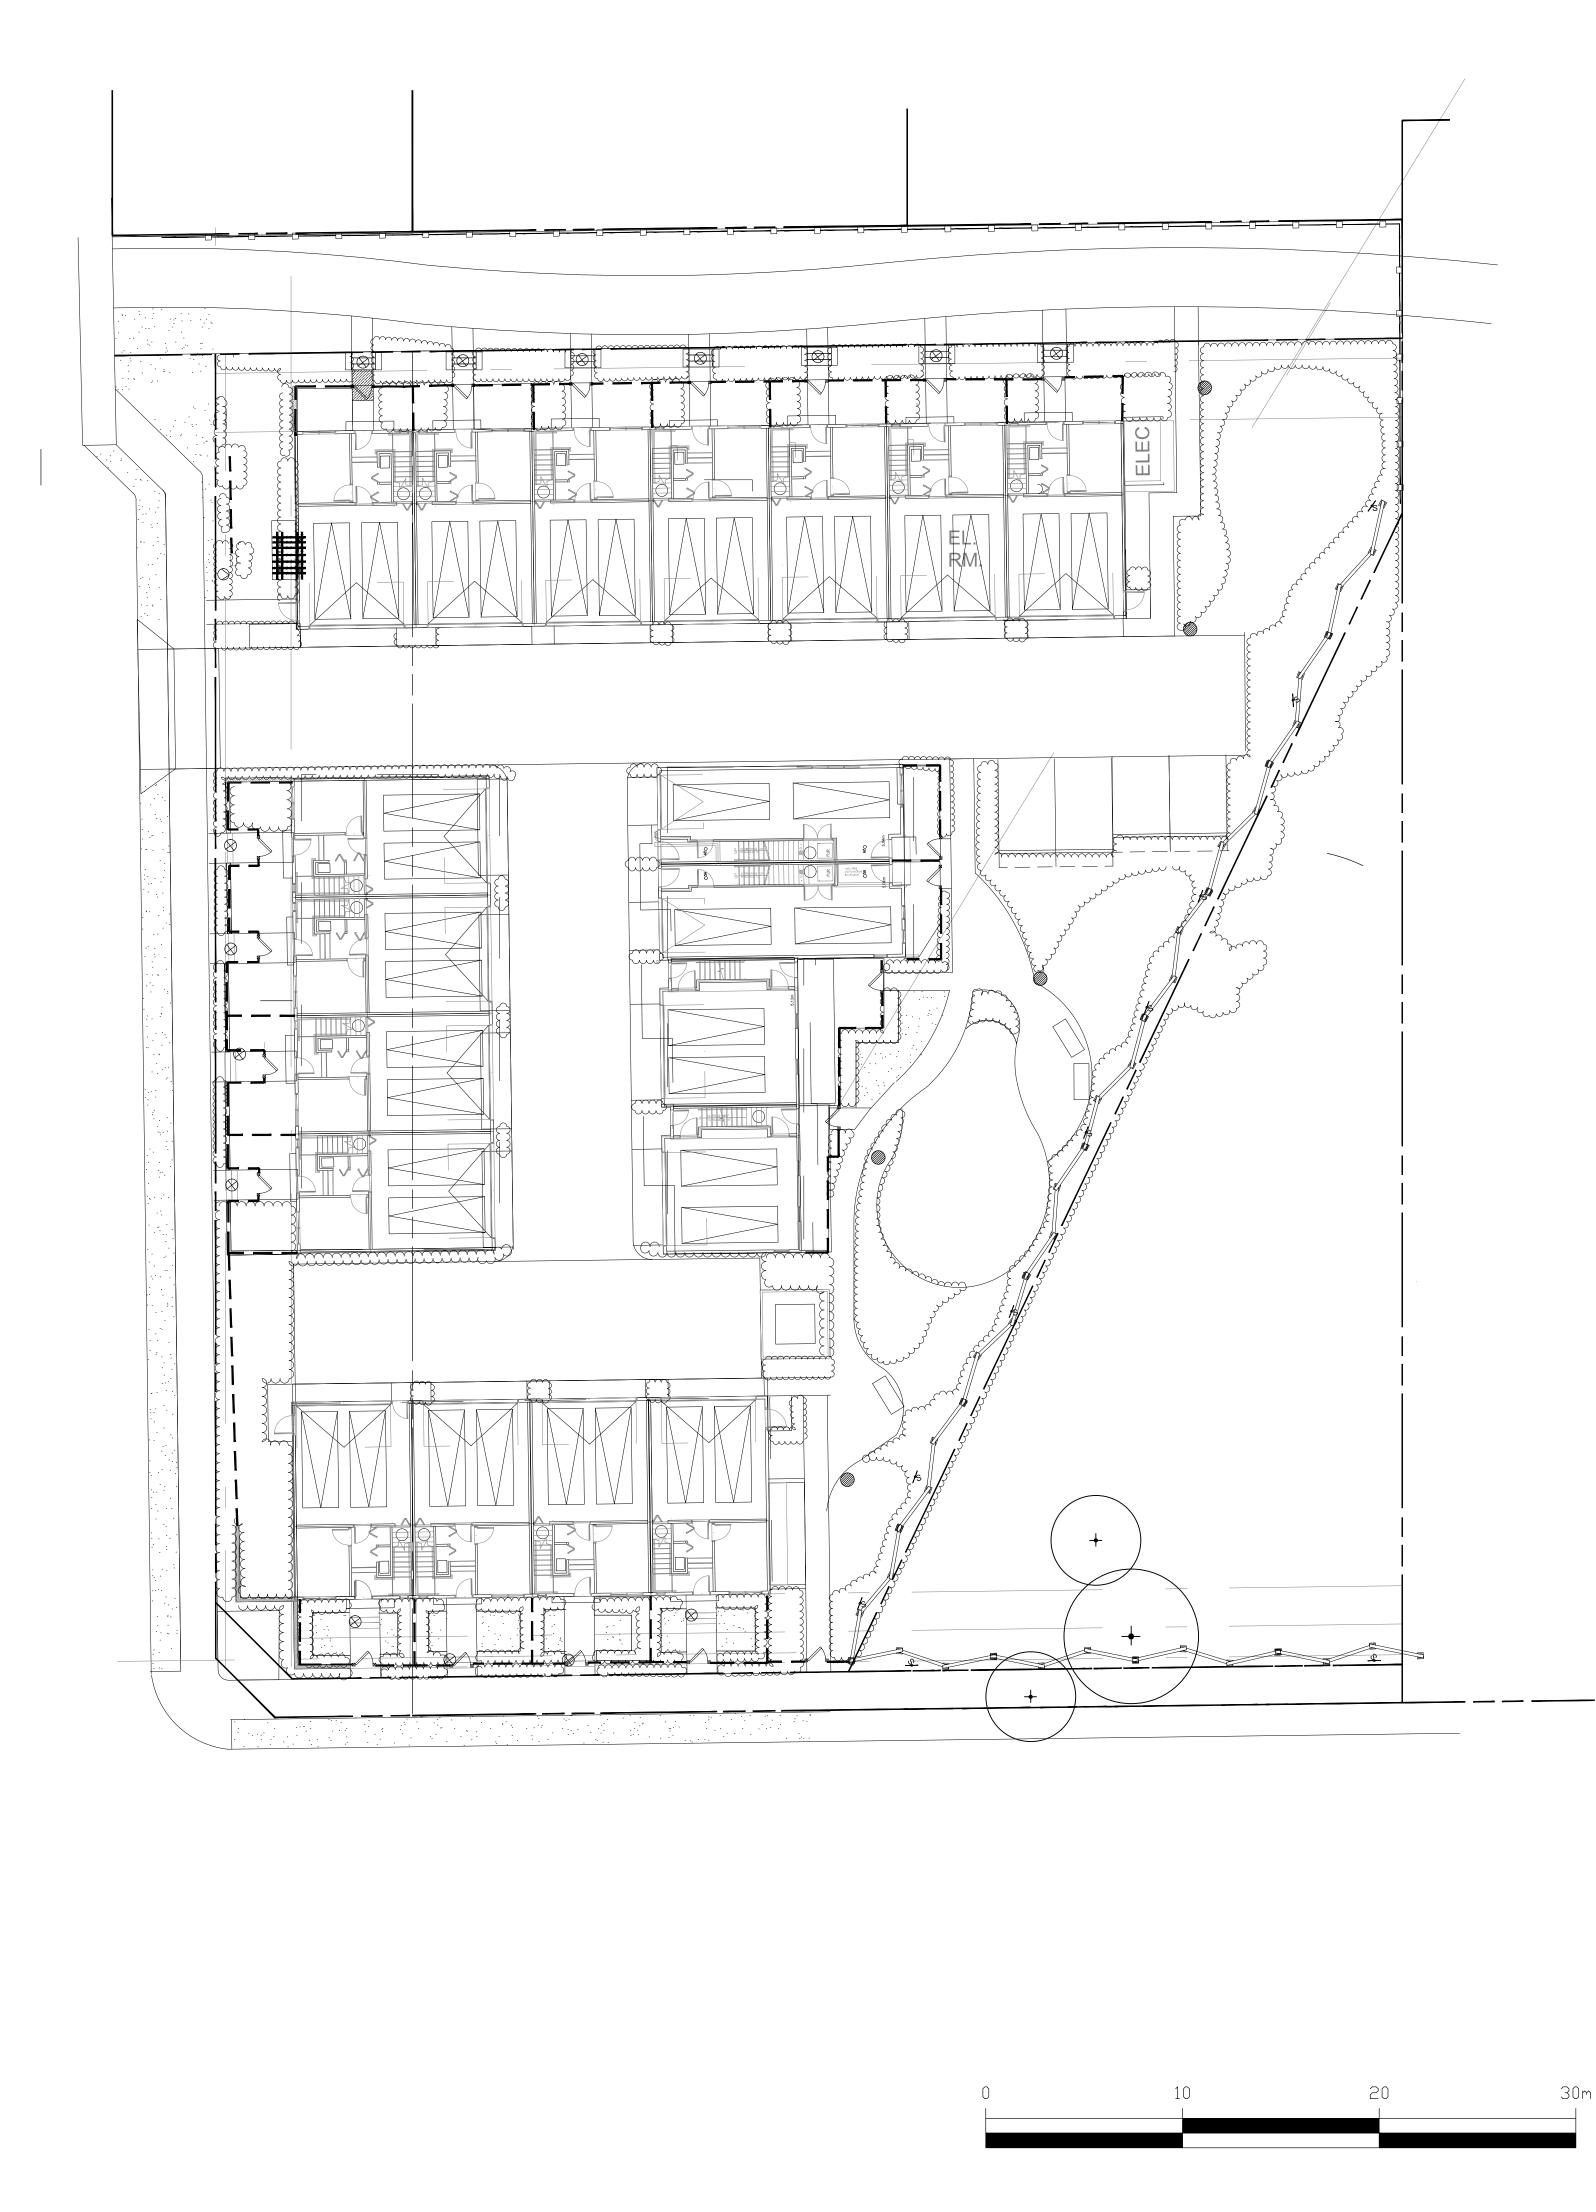

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1	16.AP.05	REISSUE	PC
NO.	DATE	REVISION DESCRIPTION	DR.

CLIENT:

PROJECT:
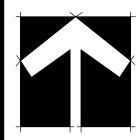
### TOWNHOUSE DEVELOPMENT

111 AVENUE AND 128A STREET SURREY, BC

DRAWING TITLE: FENCING PLAN

DATE: SCALE: DRAWN: DESIGN: CHK'D:


16.JUL.07 1/16"=1'-0" MR MR


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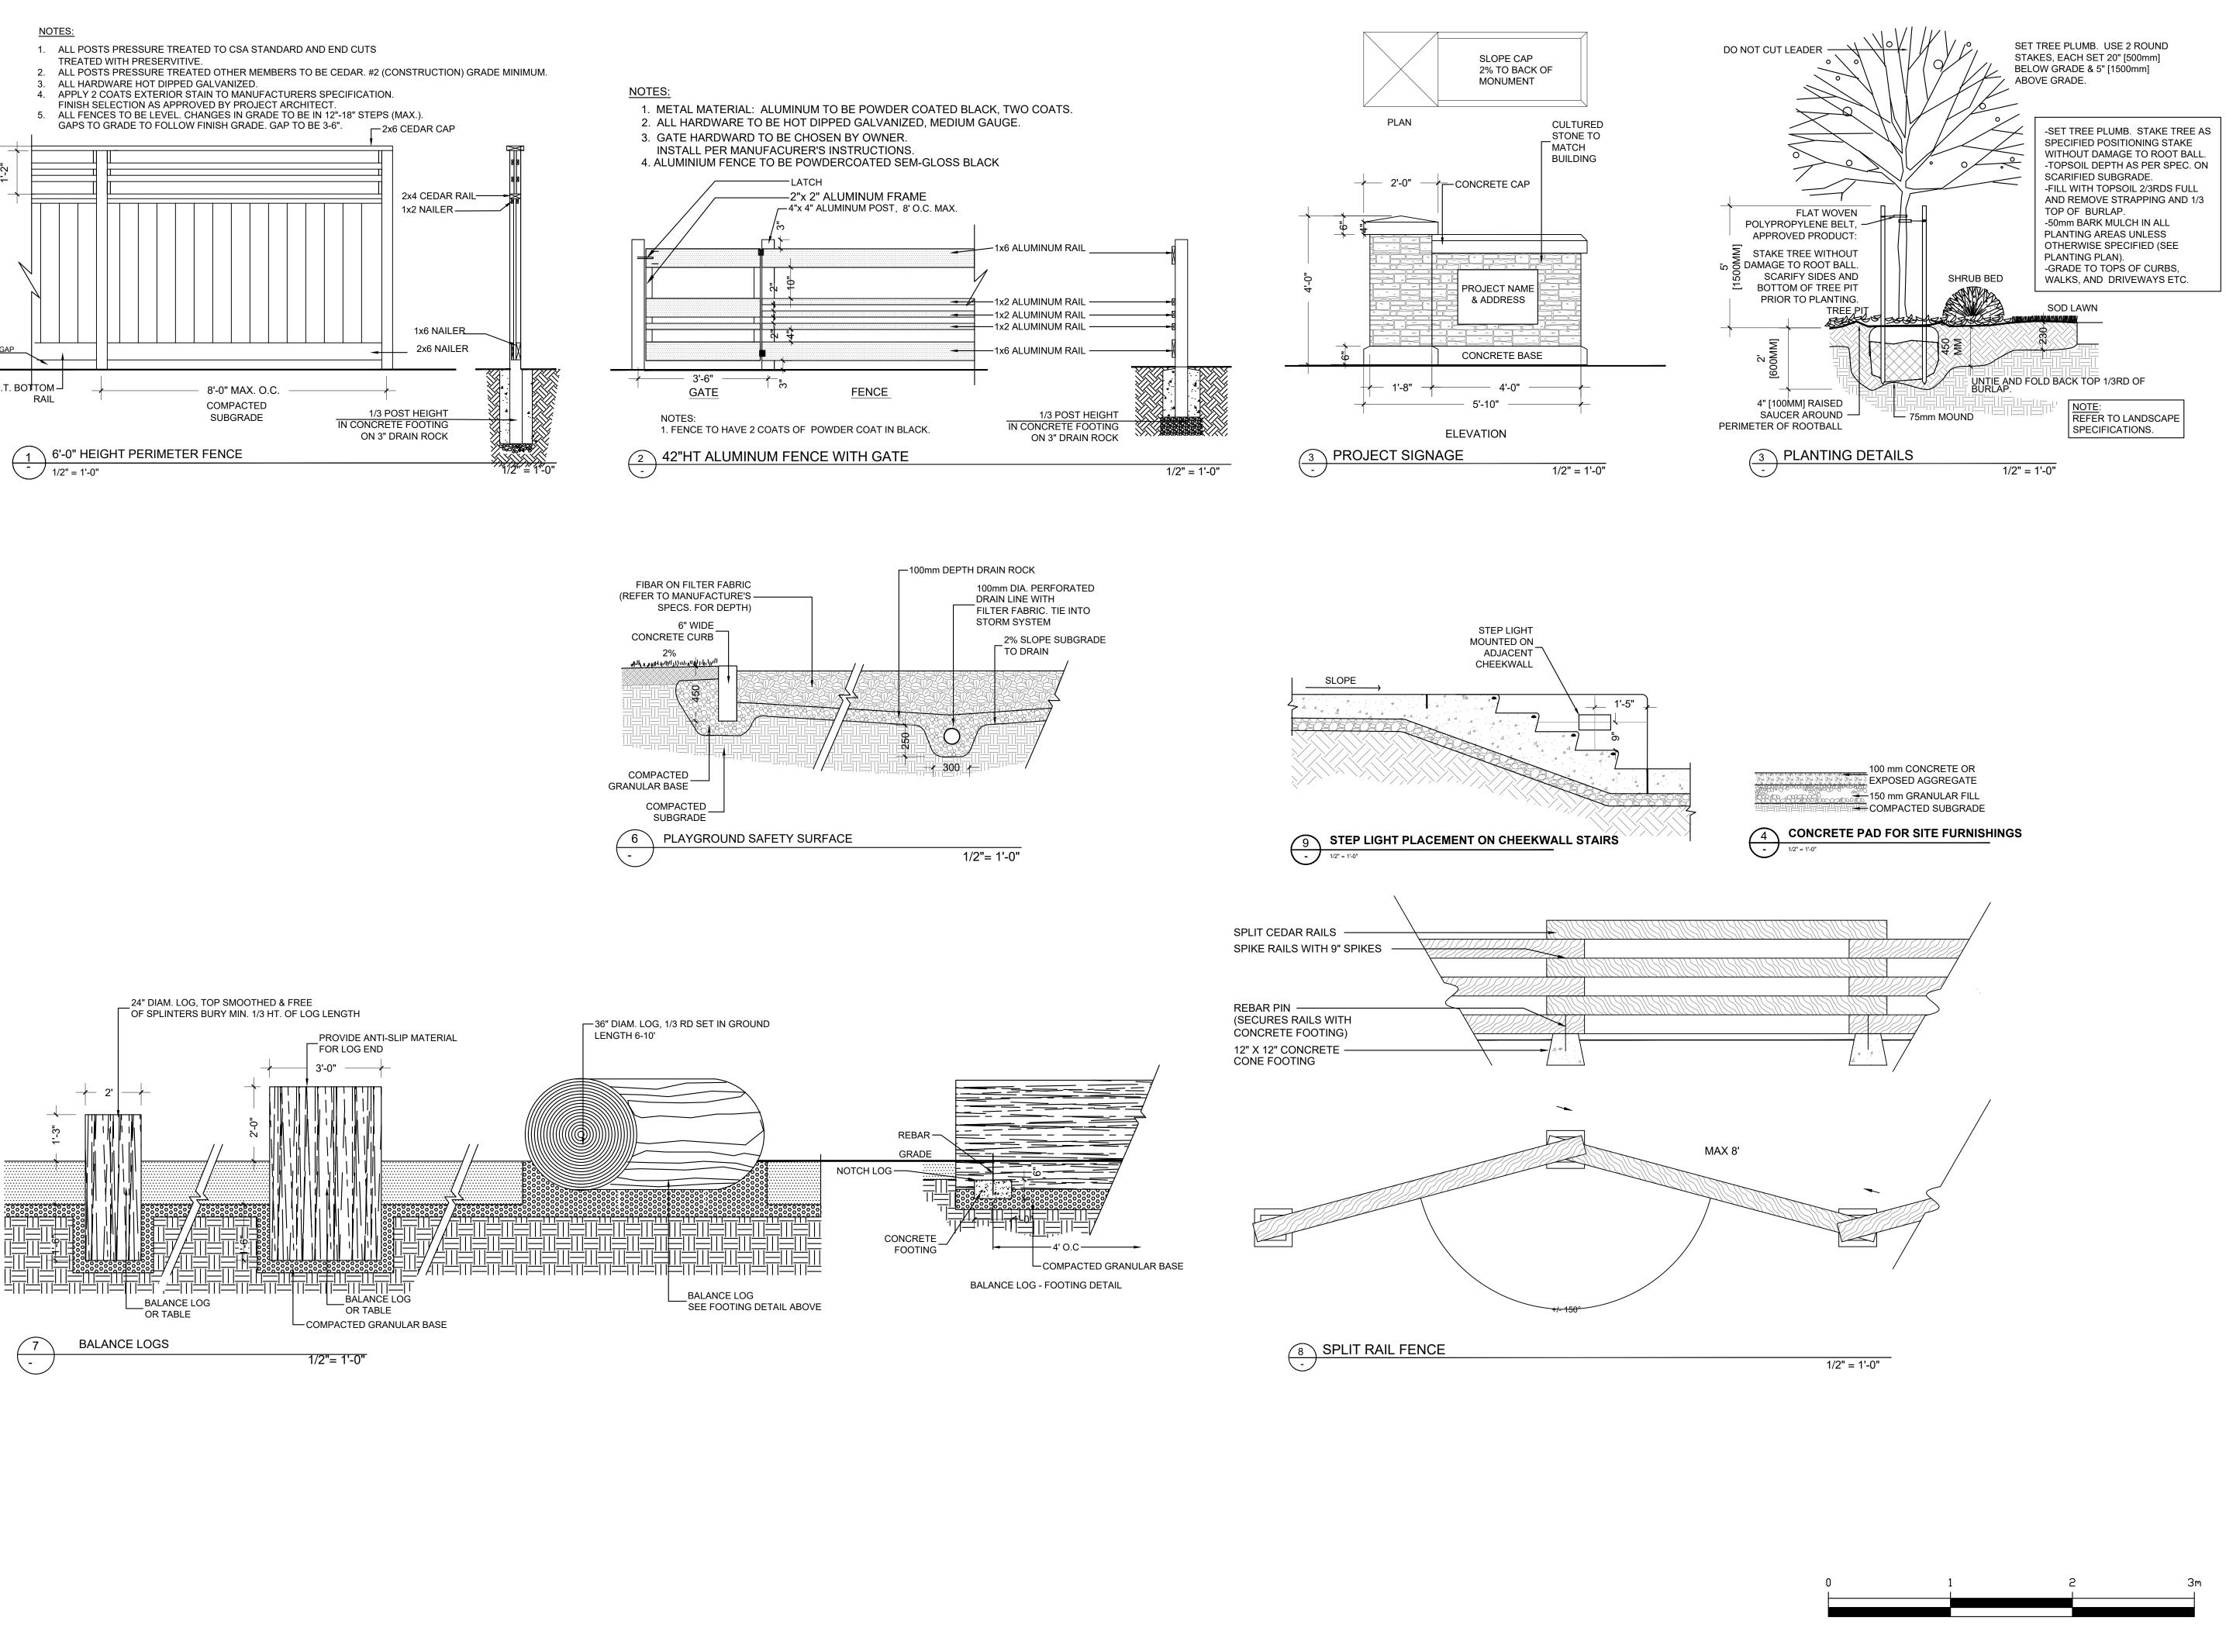
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L4 OF 6

15-098





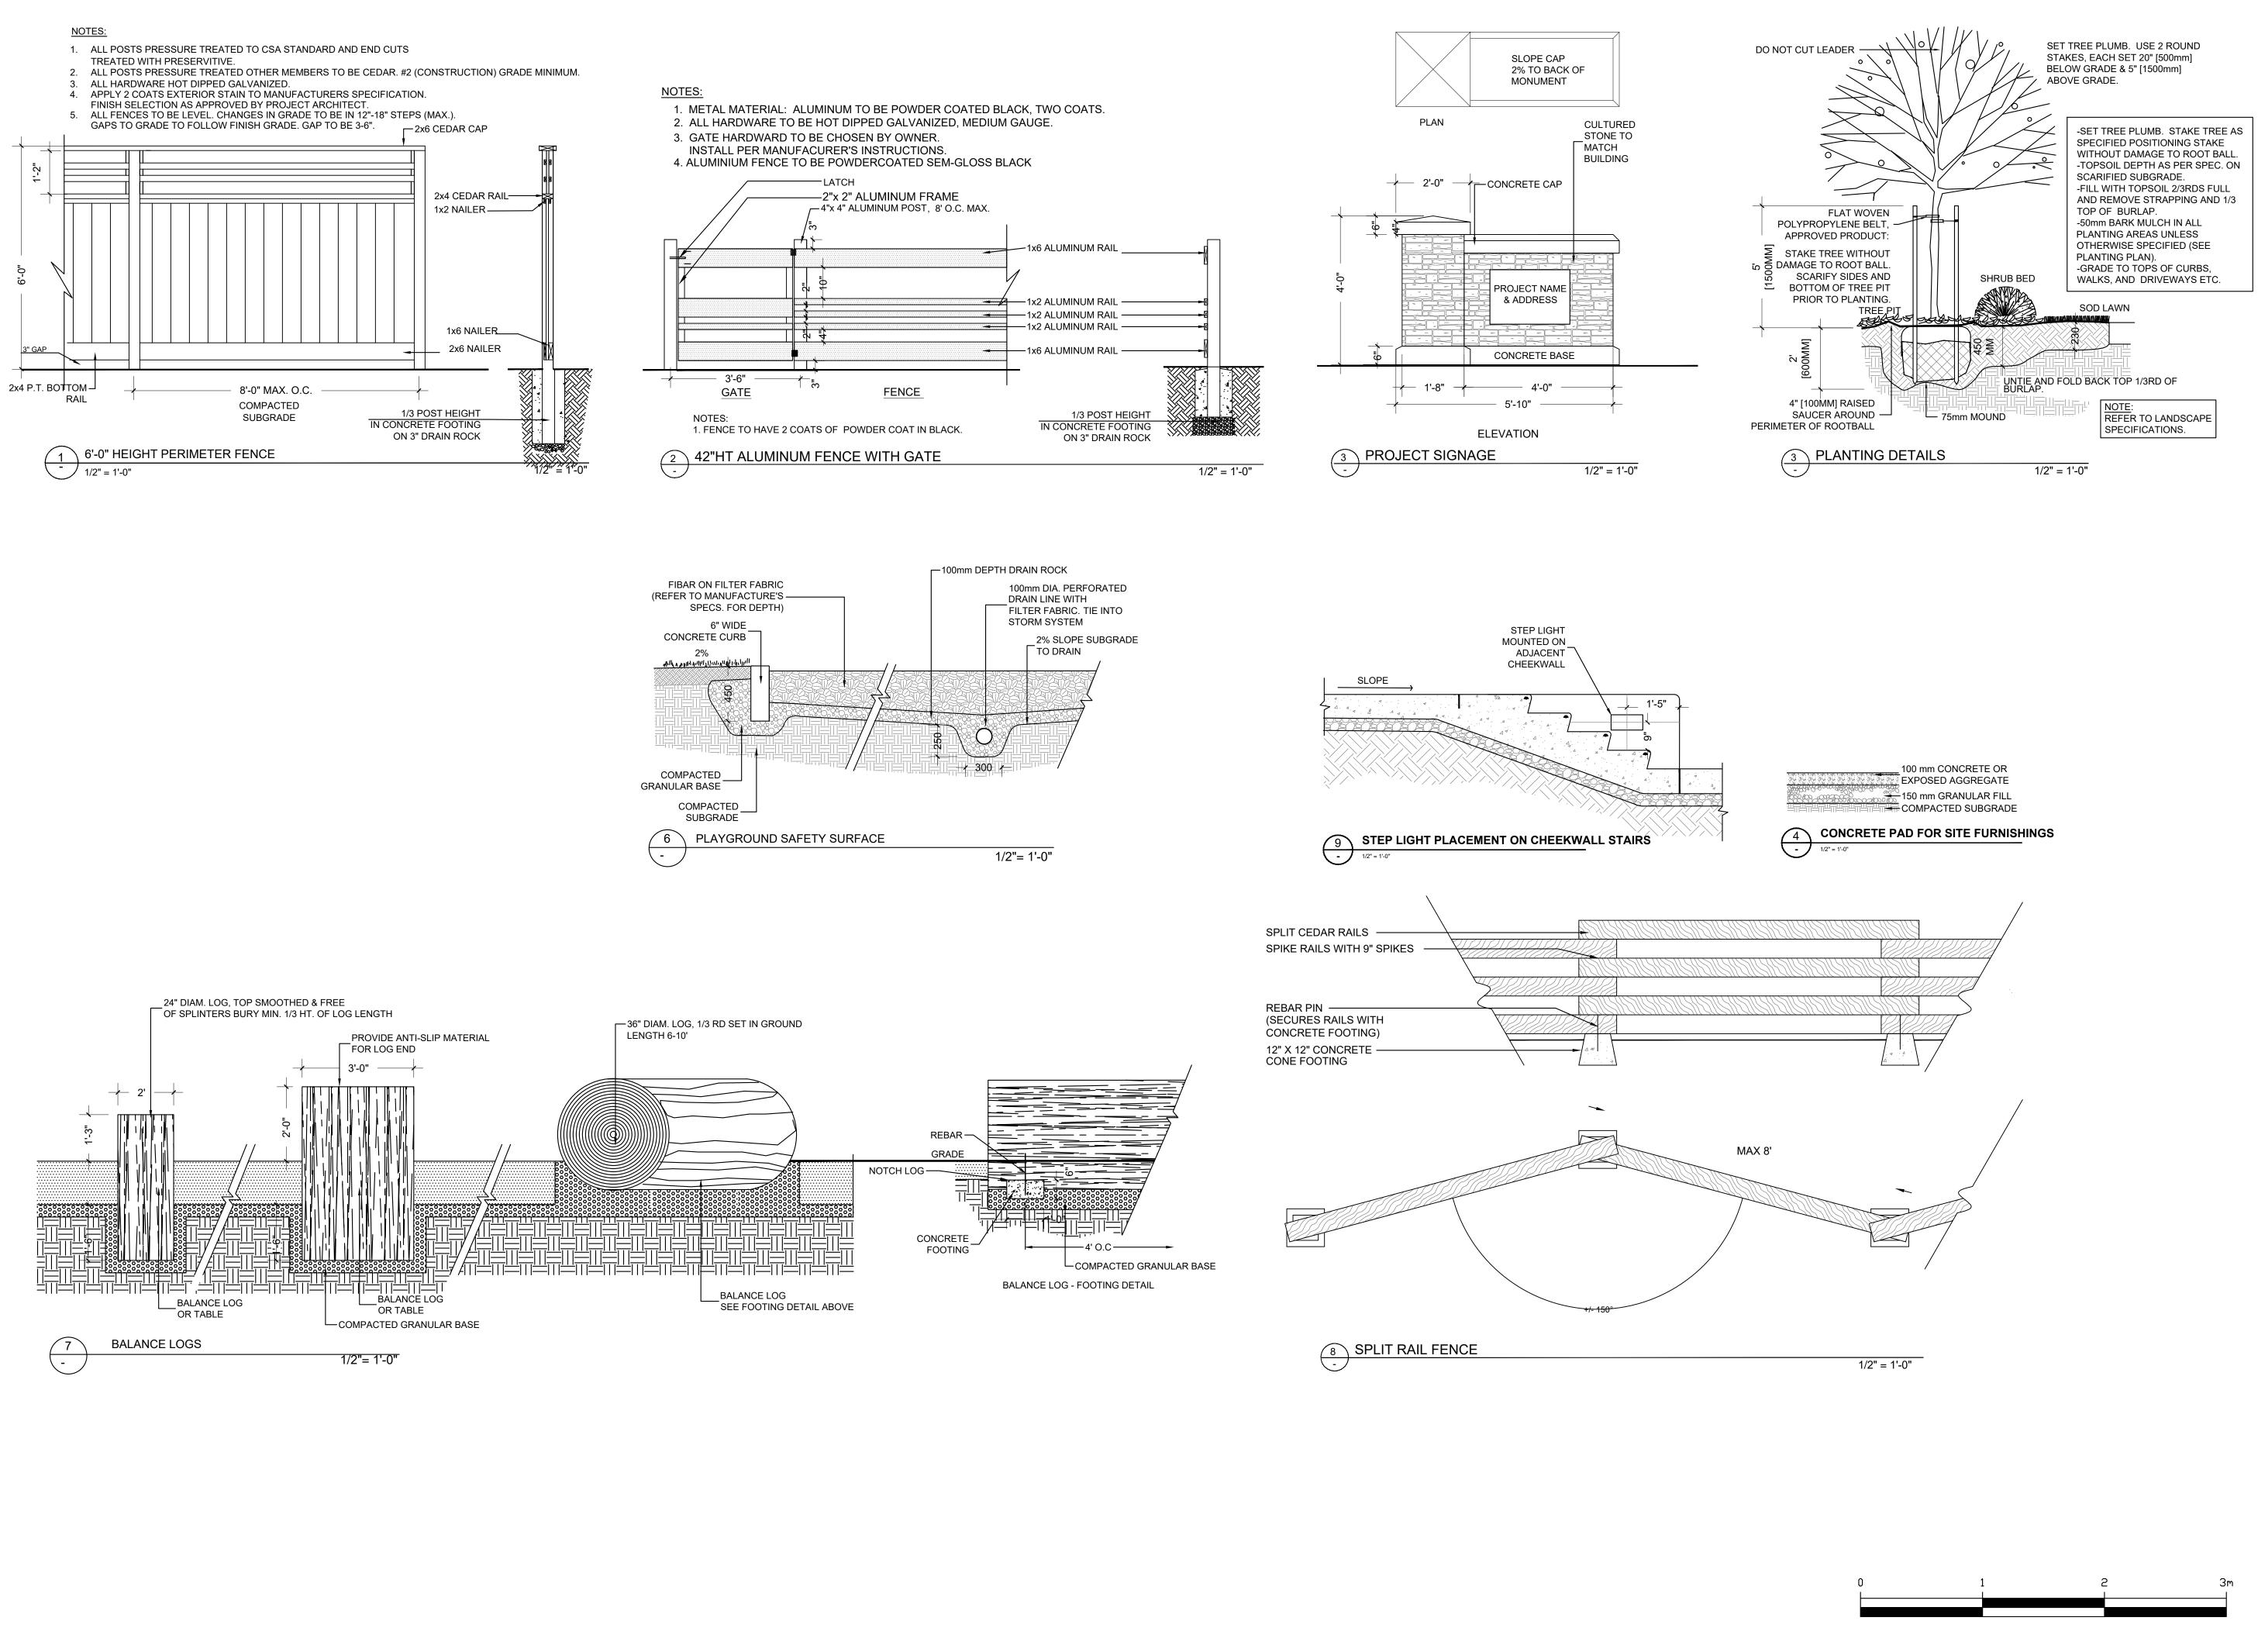
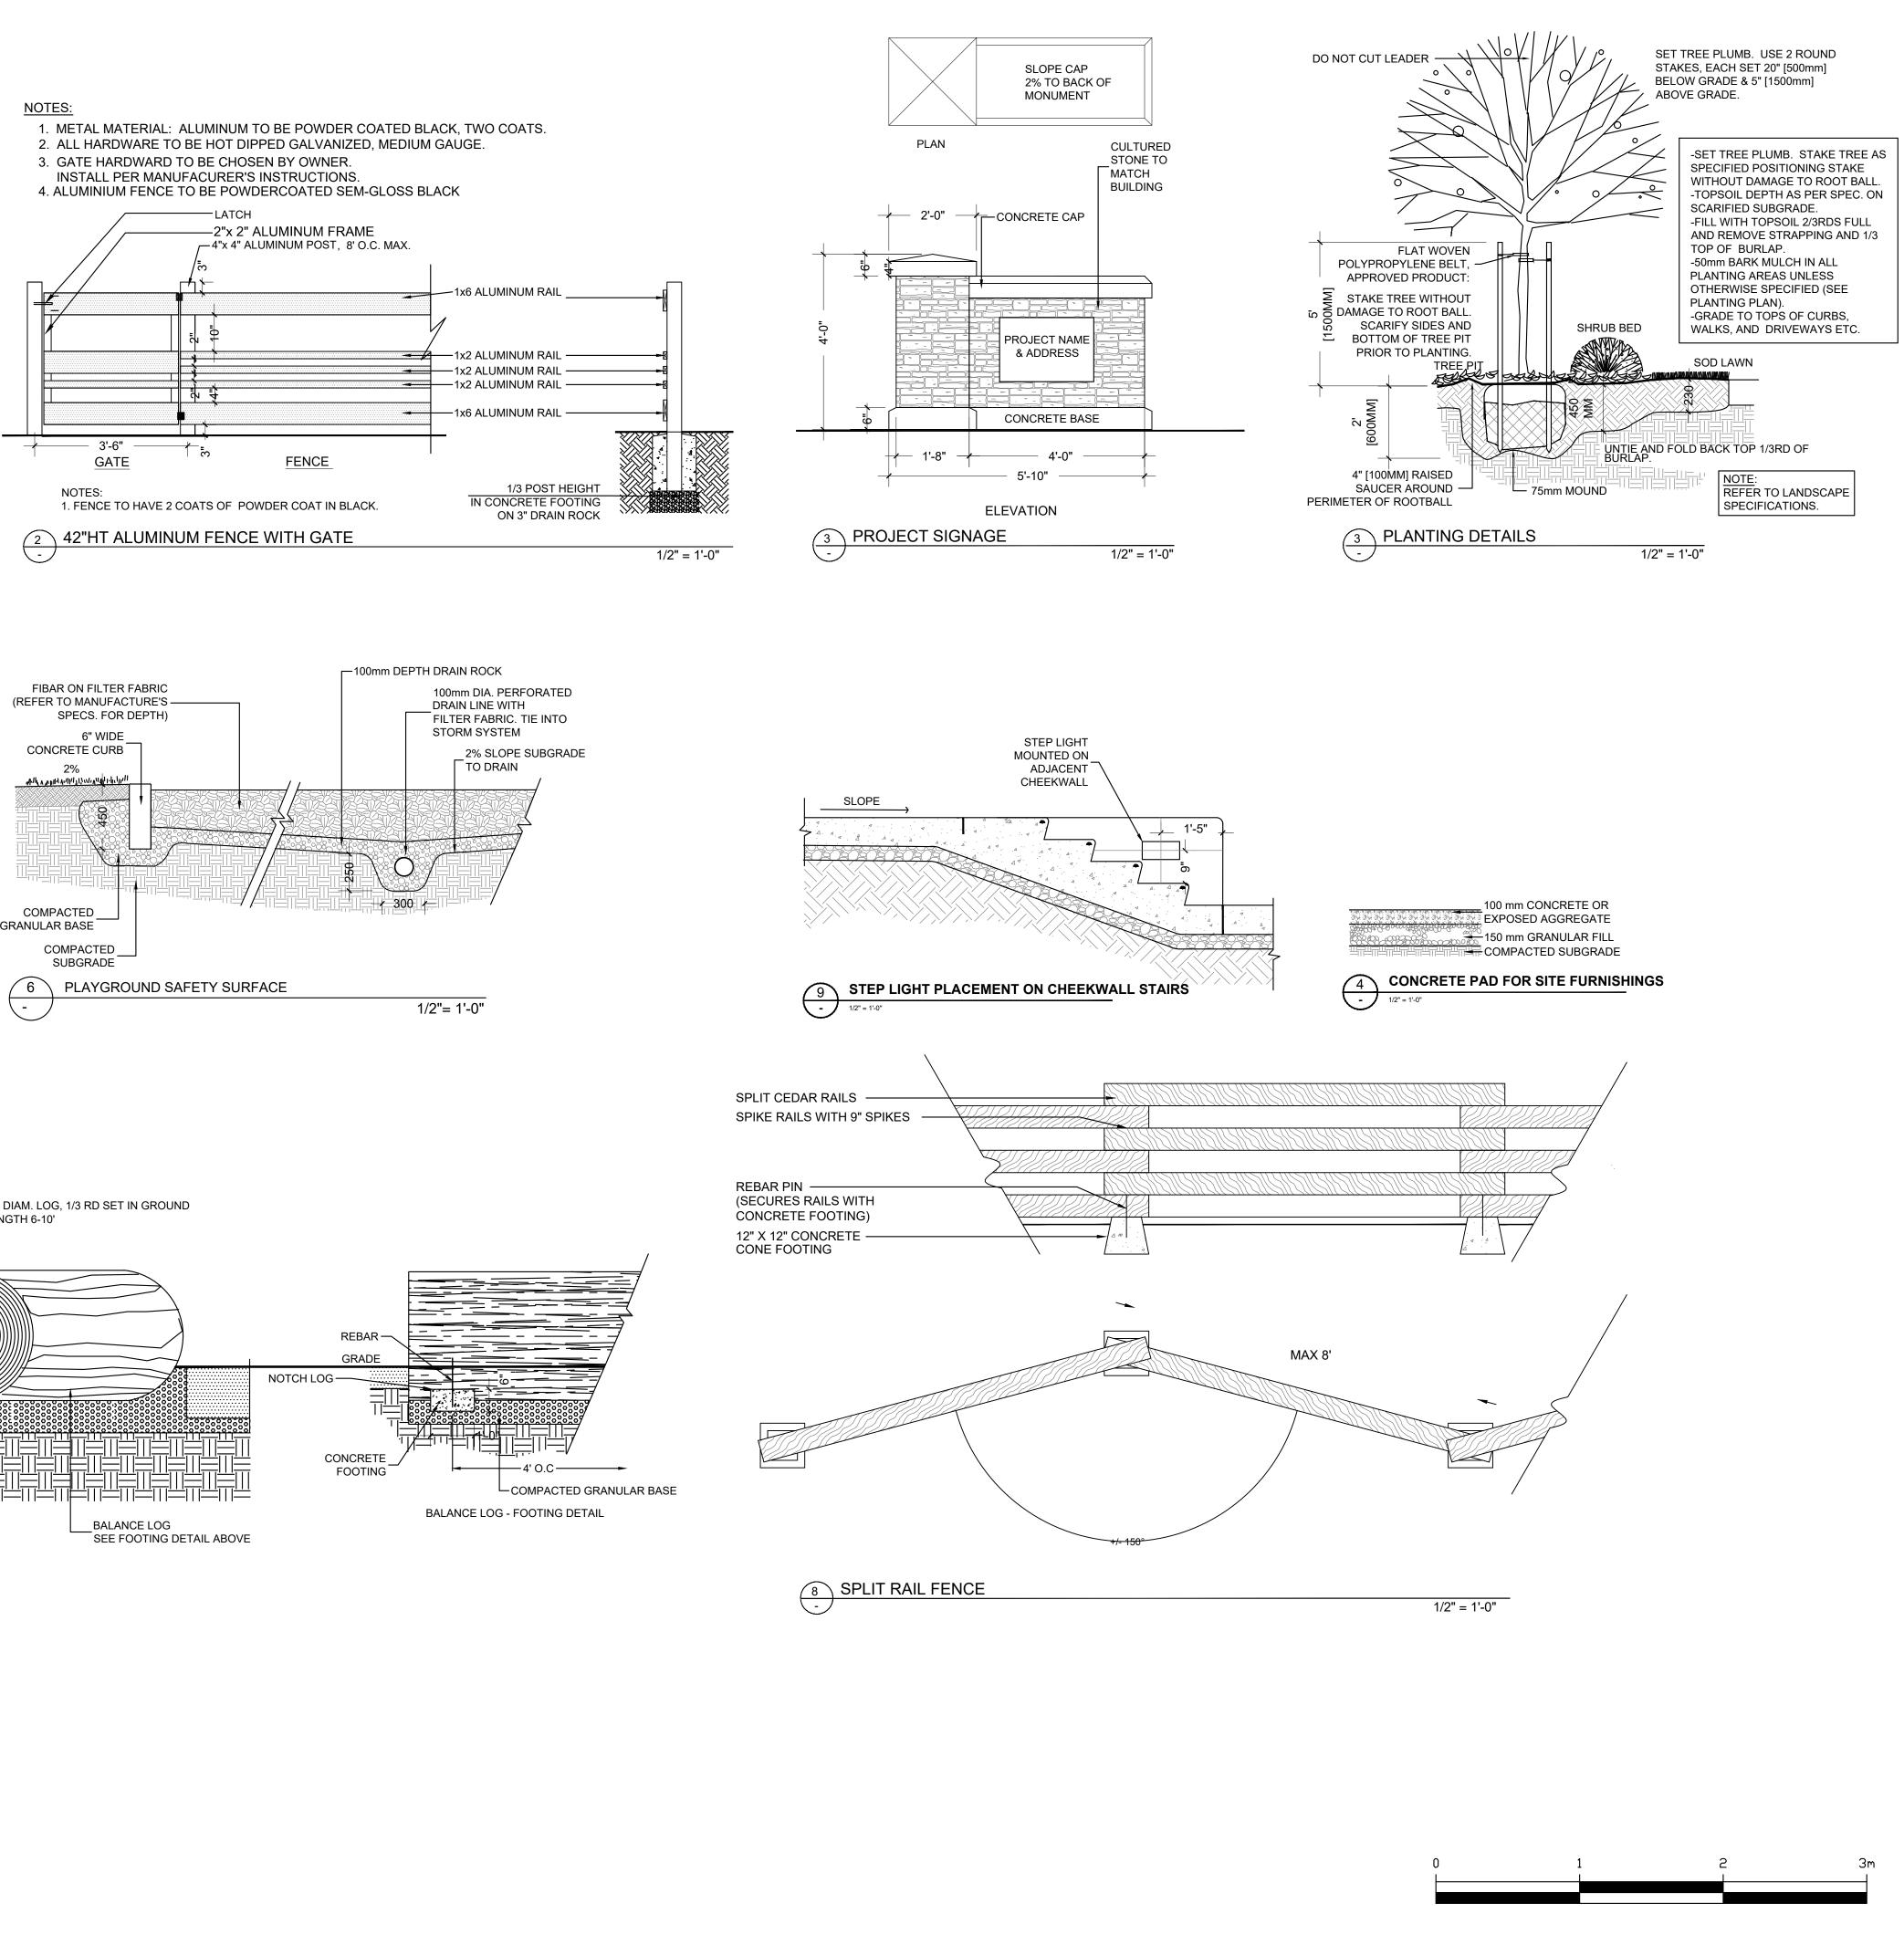
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SEAL:

8	18.SEP.25	UPDATE PER CITY COMMENTS/REISSUE	CLG
7	18.SEP.07	UPDATE PER CLIENT COMMENTS /REISSUE	CLG
6	18.SEP.06	UPDATE PER CITY COMMENTS / REISSUE	CLG
5	18.JUN.01	REVISION AS PER ENVIROWEST REPORT	DD
4	18.MAY.30	NEW SITE PLAN/ CITY COMMENTS	DD
3	16.JUN.08	<b>REVISIONAS PER CITY REQUEST</b>	DD
2	16.APR.06	UPDATE ROW AND REISSUE	CLG
1	16.AP.05	REISSUE	PC
NO.	DATE	<b>REVISION DESCRIPTION</b>	DR.

CLIENT:

### PROJECT:

## **TOWNHOUSE DEVELOPMENT**

**111 AVENUE AND 128A STREET** SURREY, BC

DRAWING TITLE:

# LANDSCAPE DETAILS

DATE: SCALE: DRAWN: DESIGN: CHK'D:

16.JUL.07 1/16"=1'-0" MR MR

PC


DRAWING NUMBER:

15098-7.ZIP PMG PROJECT NUMBER:

15-098

**OF 6** 

		LECEND LOT Y LOT NAMERY FORGED LEVELONS 2.00% 2
3       LC       DMBD       18/08/31       ISSUED FOR REVIEW       Benchmark       CITY OF SURREY GEODETIC DATUM, MONUMENT NO.5344       CLIENT         1       MS       DMBD       18/05/09       ISSUED FOR REVIEW       Benchmark       ORDOLUTION       PROJECT         0       AA       DMBD       16/07/24       ISSUED FOR INFORMATION       Scale       Scale       AS-SHOWN       AS-SHOWN       CLIENT	The Arlington Group       PRELIMINARY SERVICING       Image: consulting civil & structural engineers       Image: consulting civ	8 GRADING PLAN SURREY DRAWING NUMBER - ULA OMEGA DRAWING NUMBER

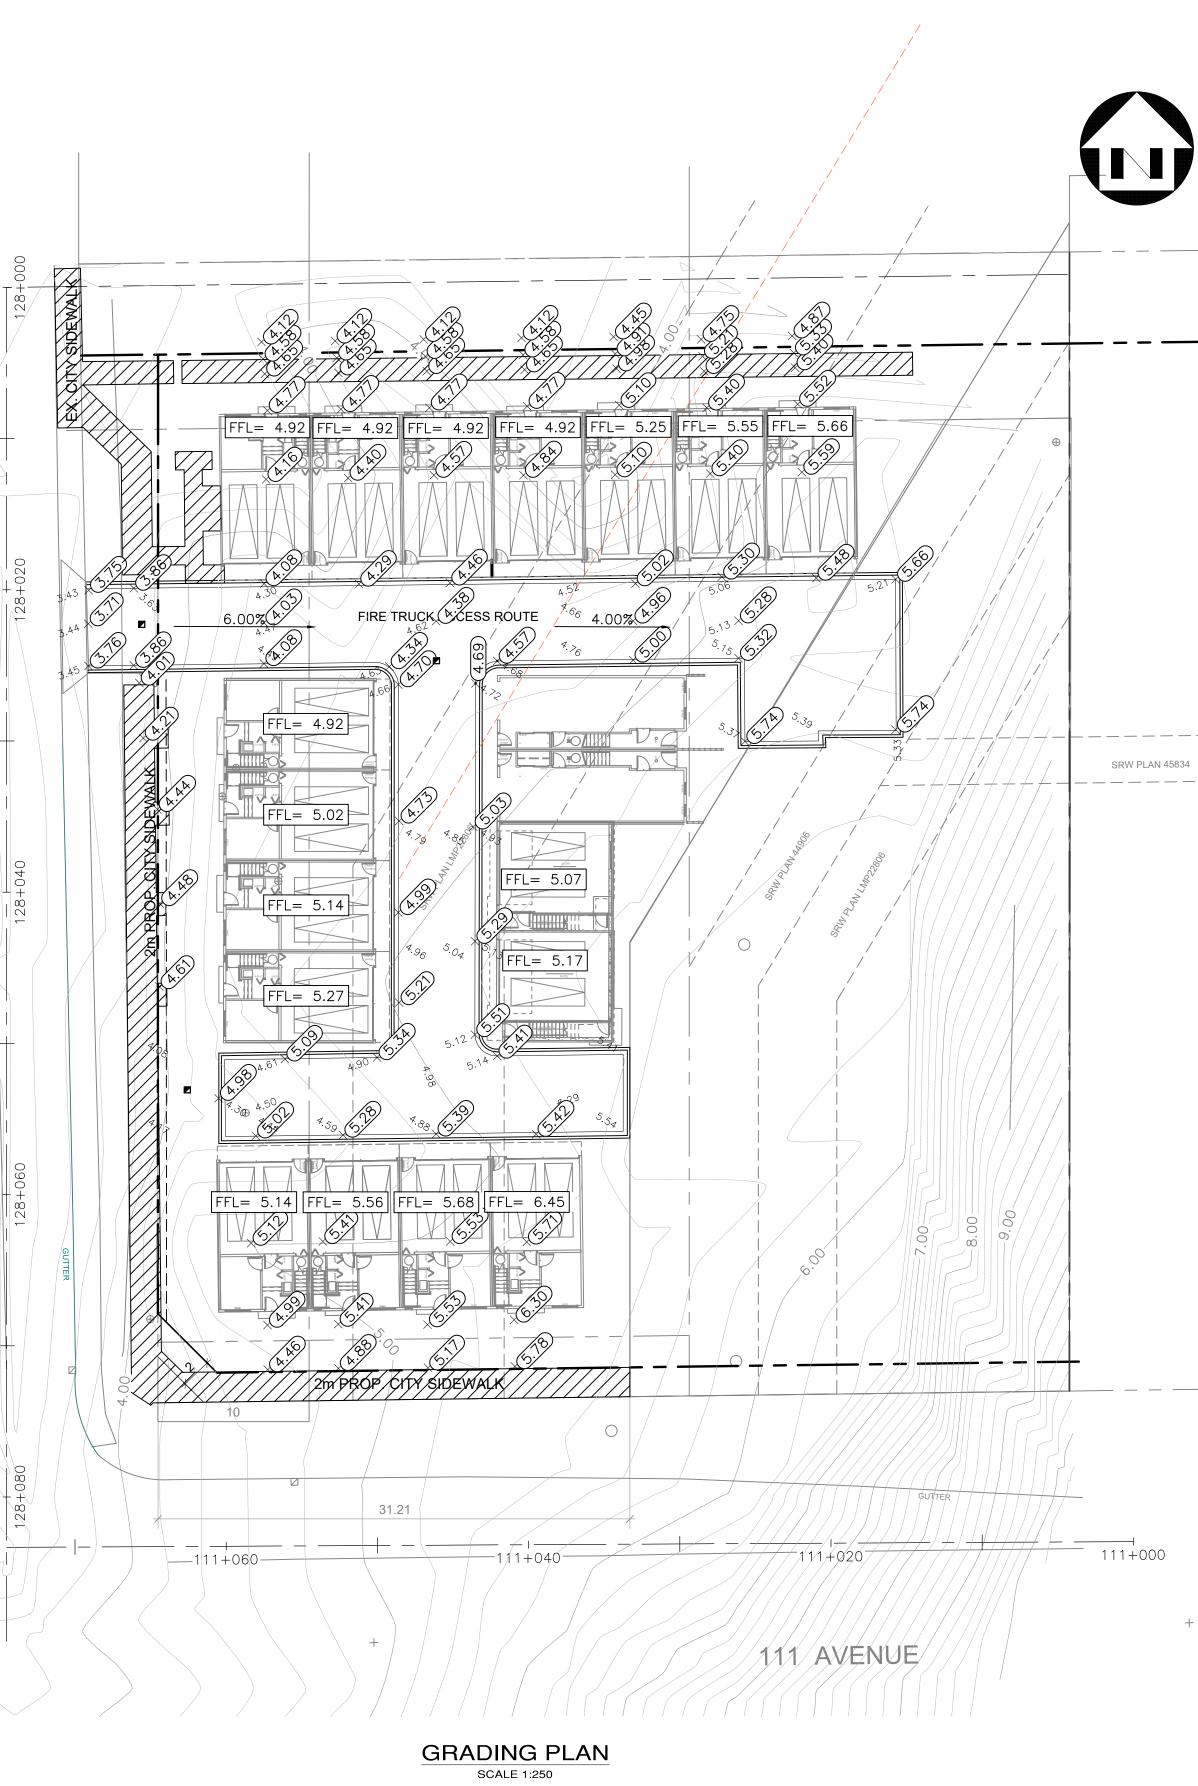

LEGEND		
lot #	LOT NUMBER	1
26.9	PROPOSED ELEVATIONS	
× 2°.	EXISTING ELEVATIONS	
-2.00%	PROPOSED SLOPES	-
MBE 27.90	MINIMUM BUILDING ELEVATION	
28.0	EX. MAJOR CONTOURS	
27.5	EX. MINOR CONTOURS	
	PROPOSED FENCE	2
$\sim$	EXISTING DITCH PROPOSED DITCH	
$\sim$	SWALE BY OWNER'S CONTRACTOR	-
<b></b>	SWALE BY BUILDER	
	DIRECTION OF FLOW FOR SURFACE RUNOFF	
	FILL >0.45m	-
	FILL >1.0m	
	6000 LAWN BASIN	
	MAJOR FLOW PATH (IN PIPE)	
	MAJOR FLOW PATH (SURCHARGED PIPE)	
	MAJOR FLOW PATH (OVERLAND)	,
MAJOR	FLOW = 100YR FLOW	



# APPENDIX III

TO:	Manager, Area Planning & - North Surrey Division Planning and Developmer	*	FILE COPY
FROM:	Development Engineer, E	ngineering Department	
DATE:	Sep 25, 2018	PROJECT FILE:	7814-0324-00
RE:	Engineering Requirement	ts	

Location: 12855 111 Ave

### **OCP AMENDMENT**

There are no engineering requirements relative to the OCP Amendment beyond those noted below.

### **REZONE/SUBDIVISION**

### Property and Right-of-Way Requirements

- dedicate 1.942-metre along 111 Avenue collector road to achieve 12.0-metre from centerline.
- register 0.5-metre statutory right-of-way along 111 Avenue and 128A Street.

### Works and Services

- construct northside of 111 Avenue to the collector.
- construct east side of 128A Street to the through local standard.
- construct storm mains to service the development and provide road drainage.
- Construct onsite features as outlined in the South Westminster Integrated Stormwater Management Plan.
- extend watermains to service the development and meet the domestic and fireflow requirements.
- complete analysis of the existing sanitary sewer infrastructure to confirm adequate capacity is available for the catchment, and complete upgrades as required.
- extend low pressure sanitary main along full frontage of 128A Street from the existing stub on 111 Avenue.
- construct storm, water, and sanitary service connections to the lot.
- secure necessary approvals from Metro Vancouver to support the development.
- Register applicable restrictive covenants as determined through the detail design.

A Servicing Agreement is required prior to Rezone/Subdivision.

### **DEVELOPMENT PERMIT**

There are no engineering requirements relative to issuance of the Development Permit beyond those noted above.

Tommy Buchmann, P.Eng. Acting Development Services Manager SK2

NOTE: Detailed Land Development Engineering Review available on file

# APPENDIX IV



Planning

August 20, 2018

14 0324 00

townhouse units

19

#### School Enrolment Projections and Planning Update:

The following tables illustrate the enrolment projections (with current/approved ministry capacity) for the elementary and secondary schools serving the proposed development.

KB Woodward Elementary is operating at 133% capacity. The 10 year enrolment projections indicate that the school could grow as high as 900 students due to future development. As for September 2017, there are currently 6 portables on site used for enrolling space. Any immediate future growth will need to be addressed by bringing on portables.

There is potential for significant redevelopment located along King George Boulevard, in particular, with the current building form potentially changing into high rise residential development and/or mixed use. The timing of these future high rise developments, with good market conditions, will impact the enrolment growth upwards. Along with this development, growth could be further compounded with the densification of 104th Ave to meet LRT requirements.

As part of the Surrey School District's 2018/19 Capital Plan submission to the Ministry of Education, the District is requesting a 200 capacity addition to relieve the short term pressure at the school. (The project has not been approved by the Ministry to move to design and construction) The District is considering the need to build another future elementary school in the area to accommodate longer term demand.

As of September 2017, Kwantlen Park Secondary is currently operating at 121% with 11 portables on site used for enrolling classes. Currently there are no capital plan requests for Kwantlen Secondary.

#### THE IMPACT ON SCHOOLS

APPLICATION #:	


SUMMARY	
The proposed	

are estimated to have the following impact	
on the following schools:	


#### Projected # of students for this development:

Elementary Students: Secondary Students:	5 2
September 2017 Enrolment/School Capacity	
K.B. Woodward Elementary	
Enrolment (K/1-7):	87 K + 519
Operating Capacity (K/1-7)	38 K + 419
Kwantlen Park Secondary	
Enrolment (8-12):	1459
Capacity (8-12):	1200

### K.B. Woodward Elementary

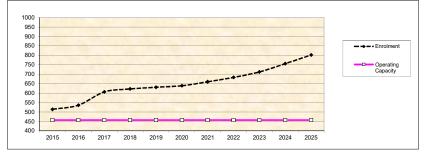

#### Kwantlen Park Secondary

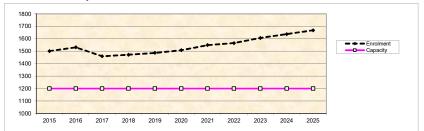

\* Nominal Capacity is estimated by multiplying the number of enrolling spaces by 25 students. Maximum operating capacity is estimated by multipying the number of enrolling spaces by 27 students.

•

Arborist Report – 12855 & 12869 111 Avenue, Surrey BC

### Table 4. Tree Preservation Summary

### TREE PRESERVATION SUMMARY

Surrey Project No:	
Address:	12855 & 12869 111 Avenue, Surrey BC
Registered Arborist:	Trevor Cox, MCIP
	ISA Certified Arborist (PN1920A)
	Certified Tree Risk Assessor (43)
	BC Parks Wildlife and Danger Tree Assessor

On-Site Trees	Number of Trees
Protected Trees Identified	
(on-site and shared trees, including trees within boulevards and proposed	14
streets and lanes, but excluding trees in proposed open space or riparian	14
areas)	
Protected Trees to be Removed	14
Protected Trees to be Retained	0
(excluding trees within proposed open space or riparian areas)	0
Total Replacement Trees Required:	
<ul> <li>Alder &amp; Cottonwood Trees Requiring 1 to 1 Replacement Ratio</li> </ul>	
14 X one (1) = 14	14
- All other Trees Requiring 2 to 1 Replacement Ratio	
X  two (2) = 0	
Replacement Trees Proposed	36
Replacement Trees in Deficit	0
Protected Trees to be Retained in Proposed [Open Space / Riparian Areas]	3
Off-Site Trees	Number of Trees
Protected Off-Site Trees to be Removed	0
Total Replacement Trees Required:	
<ul> <li>Alder &amp; Cottonwood Trees Requiring 1 to 1 Replacement Ratio</li> </ul>	
X one (1) = 0	0
- All other Trees Requiring 2 to 1 Replacement Ratio	
X two (2) = 0	
Replacement Trees Proposed	
Replacement Trees in Deficit	0

Summary prepared and submitted by:

September 10, 2018

Arborist

Date



	LEGEND TREE PROTECTION ZONE NO-BUILD ZONE TREE PROTECTION FENCE TREE TO BE RETAINED UN-SURVEYED TREE TREE TO BE REMOVED
twork Corridor REMOVED FROM ANDSCAPE INICUDING TIVE SHARUS TO RETAINED. TED TO FILL THE VOIDS. ATTVE PLANTS SHOWN. G TREES.	<ol> <li>NOTES</li> <li>The location of un-surveyed trees on this plan is approximate. Their location and ownership cannot be confirmed without being surveyed by a Registered BC Land Surveyor.</li> <li>All tree protection fencing must be built to the relevant municipal bylaw specifications. The dimensions shown are from the outer edge of the stem of the tree.</li> <li>The tree protection zone shown is a graphical representation of the critical root zone, measured from the outer edge of the stem of the tree. (<sup>1</sup>/<sub>2</sub> the trees diameter was added to the graphical tree protection circles to accommodate the survey point being in the center of the tree)</li> <li>Any construction activities or grade changes within the Root Protection Zone must be approved by the project arborist.</li> <li>This plan is based on a topographic and tree location survey provided by the owners' Registered British Columbia Land Surveyor (BCLS) and layout drawings provide by the owners' Engineer (P Eng).</li> <li>This plan is provided for context only, and is not certified as to the accuracy of the location of features or dimensions that are shown on this plan. Please refer to the original survey plan and engineering plans.</li> <li>Base Drawings by: The Arlington Group.</li> </ol>
	Date: 2018/09/07         Page #           Drawn by: KW         1 of 1           Page Size: TABLOID         1 of 1

### CITY OF SURREY

# APPENDIX VI

### BYLAW NO.

A by-law to amend Surrey Zoning By-law, 1993, No. 12000, as amended

### THE CITY COUNCIL of the City of Surrey ENACTS AS FOLLOWS:

- Surrey Zoning By-law, 1993, No. 12000, as amended, is hereby further amended, pursuant to the provisions of Section 479 of the <u>Local Government Act</u>, R.S.B.C. 2015 c. 1, as amended by changing the classification of the following parcels of land, presently shown upon the maps designated as the Zoning Maps and marked as Schedule "A" of Surrey Zoning By-law, 1993, No. 12000, as amended as follows:
  - FROM: SINGLE FAMILY RESIDENTIAL ZONE (RF)

TO: COMPREHENSIVE DEVELOPMENT ZONE (CD)

Parcel Identifier: 000-836-681

West 82 and ½ Feet Lot 29 Except: Firstly: North 33 Feet Secondly: Parcel "B" (Explanatory Plan 103019), Section 16 Block 5 North Range 2 West New Westminster District Plan 493 12869 111 Avenue

Parcel Identifier: 000-890-936 The East 82.5 Feet of Lot 30 Except: Parcel "A" (Explanatory Plan 8949); Section 16 block 5 North Range 2 West New Westminster District Plan 493 12855 111 Avenue

Portion of Road (128A Street) as shown on the Survey Plan attached hereto and forming part of this Bylaw, as Schedule A, certified correct by Mark J.R. Dailey, B.C.L.S. on the 13<sup>th</sup> day of September, 2018, containing 722.0 square metres, called Block A.

(hereinafter referred to as the "Lands")

2. The following regulations shall apply to the *Lands*:

### A. Intent

This Zone is intended to accommodate and regulate the development of medium *density*, *ground-oriented multiple unit residential buildings* and related *amenity spaces*.

### B. Permitted Uses

The *Lands* and *structures* shall be used for *ground-oriented multiple unit residential buildings* only.

### C. Lot Area

Not applicable to this Zone.

### D. Density

For the purpose of *building* construction:

- The unit density shall not exceed 2.5 dwelling units per hectare [1 u.p.a.]. The maximum density may be increased to that prescribed in Section D.2 of this Zone if amenities are provided in accordance with Schedule G of Surrey Zoning By-law, 1993, No. 12000, as amended.
- 2. (a) The *floor area ratio* shall not exceed 1.10; and
  - (b) The *unit density* shall not exceed 75 *dwelling units* per hectare [30 u.p.a.].
- 4. The indoor *amenity space* required in Sub-section J.1(b) is excluded from the calculation of *floor area ratio*.

### E. Lot Coverage

The *lot coverage* shall not exceed 49%.

### F. Yards and Setbacks

*Buildings* and *structures* shall be sited in accordance with the following minimum *setbacks*:

Setback	North	South	East	West
	Yard	Yard	Yard	Yard
Principal Buildings Accessory Buildings and Structures	4.0 m [13 ft.]	4.0 m [13 ft.]	5.0 m [16 ft.]	4.0 m [13 ft.]

Measurements to be determined as per Part 1 Definitions of Surrey Zoning By-law, 1993, No. 12000, as amended.

### G. Height of Buildings

Measurements to be determined as per Part 1 Definitions of Surrey Zoning By-law, 1993, No. 12000, as amended.

- 1. <u>Principal buildings</u>: The building height shall not exceed 13 metres [43 ft.].
- 2. <u>Accessory buildings and structures</u>:
  - (a) Indoor *amenity space buildings*: The *building height* shall not exceed 11 metres [36 ft.]; and
  - (b) Other *accessory buildings* and *structures*: The *height* shall not exceed 4.5 metres [15 ft.].

### H. Off-Street Parking

- 1. Resident and visitor *parking spaces* shall be provided in accordance with Part 5 Off-Street Parking and Loading/Unloading of Surrey Zoning By-law, 1993, No. 12000, as amended.
- 2. All required resident *parking spaces* shall be provided as *parking within building envelope*.
- 3. Parking within the required north, west, and south *yard setbacks* is not permitted.
- 4. *Tandem parking* is permitted, subject to the following:
  - (a) A maximum of fifteen percent (15%) of all required resident *parking spaces* may be provided as *tandem parking spaces*;
  - (b) *Parking spaces* provided as *tandem parking* must be enclosed and attached to each *dwelling unit*;
  - (c) *Parking spaces* provided as *tandem parking* must be held by the same owner; and
  - (d) Access to *parking spaces* provided as *tandem parking* is not permitted within 6 metres [20 ft.] from *lot* entrances/exits.

### I. Landscaping

- 1. All developed portions of the *lot* not covered by *buildings*, *structures* or paved areas shall be landscaped including the retention of mature trees. This *landscaping* shall be maintained.
- 2. Along the developed sides of the *lot* which abut a *highway*, a continuous *landscaping* strip of not less than 1.5 metres [5 ft.] in width shall be provided within the *lot*.
- 3. The boulevard areas of *highways* abutting a *lot* shall be seeded or sodded with grass on the side of the *highway* abutting the *lot*, except at *driveways*.

4. Garbage containers and *passive recycling containers* shall be screened to a height of at least 2.5 metres [8 ft.] by *buildings*, a *landscaping* screen, a solid decorative fence, or a combination thereof.

### J. Special Regulations

- 1. *Amenity space* shall be provided on the *lot* as follows:
  - (a) Outdoor *amenity space*, in the amount of 3.0 square metres [32 sq.ft.] per *dwelling unit* and shall not be located within the required *setbacks*; and
  - (b) Indoor *amenity space*, in the amount of 3.0 square metres [32 sq.ft.] per *dwelling unit*.

### K. Subdivision

*Lots* created through subdivision in this Zone shall conform to the following minimum standards:

Lot Size	Lot Width	Lot Depth
800 sq.m.	25 metres	30 metres
[0.20 acre]	[82 ft.] [100 ft.]	
<b>D</b> I I III	1. 1	

Dimensions shall be measured in accordance with Section E.21 of Part 4 General Provisions of Surrey Zoning By-law, 1993, No. 12000, as amended.

### L. Other Regulations

In addition to all statutes, bylaws, orders, regulations or agreements, the following are applicable, however, in the event that there is a conflict with the provisions in this Comprehensive Development Zone and other provisions in Surrey Zoning By-law, 1993, No. 12000, as amended, the provisions in this Comprehensive Development Zone shall take precedence:

- 1. Definitions are as set out in Part 1 Definitions of Surrey Zoning By-law, 1993, No. 12000, as amended.
- 2. Prior to any use, the *Lands* must be serviced as set out in Part 2 Uses Limited, of Surrey Zoning By-law, 1993, No. 12000, as amended and in accordance with the servicing requirements for the RM-30 Zone as set forth in the Surrey Subdivision and Development By-law, 1986, No. 8830, as amended.
- 3. General provisions are as set out in Part 4 General Provisions of Surrey Zoning By-law, 1993, No. 12000, as amended.
- 4. Additional off-street parking requirements are as set out in Part 5 Off-Street Parking and Loading/Unloading of Surrey Zoning By-law, 1993, No. 12000, as amended.

- 5. Sign regulations are as set out in Surrey Sign By-law, 1999, No. 13656, as amended.
- 6. Special *building setbacks* are as set out in Part 7 Special Building Setbacks, of Surrey Zoning By-law, 1993, No. 12000, as amended.
- 7. *Building* permits shall be subject to the Surrey Building Bylaw, 2012, No. 17850, as amended.
- 8. *Building* permits shall be subject to Surrey Development Cost Charge Bylaw, 2016, No. 18664, as may be amended or replaced from time to time, and the development cost charges shall be based on the RM-30 Zone.
- 9. Tree regulations are set out in Surrey Tree Protection Bylaw, 2006, No. 16100, as amended.
- 10. Development permits may be required in accordance with the Surrey *Official Community Plan* By-law, 2013, No. 18020, as amended.
- 3. This By-law shall be cited for all purposes as "Surrey Zoning By-law, 1993, No. 12000, Amendment By-law, , No. ."


PASSED FIRST READING on the	th day of	,20.		
PASSED SECOND READING on the	th day of	, 20 .		
PUBLIC HEARING HELD thereon on the	e th day of		,20.	
PASSED THIRD READING on the	th day of	,20.		
RECONCIDERED AND ENIALLY ADOR		1.61.1	1	1 1 1.1.1

RECONSIDERED AND FINALLY ADOPTED, signed by the Mayor and Clerk, and sealed with the Corporate Seal on the th day of , 20.

MAYOR

\_\_\_\_\_ CLERK

# SCHEDULE 'A'

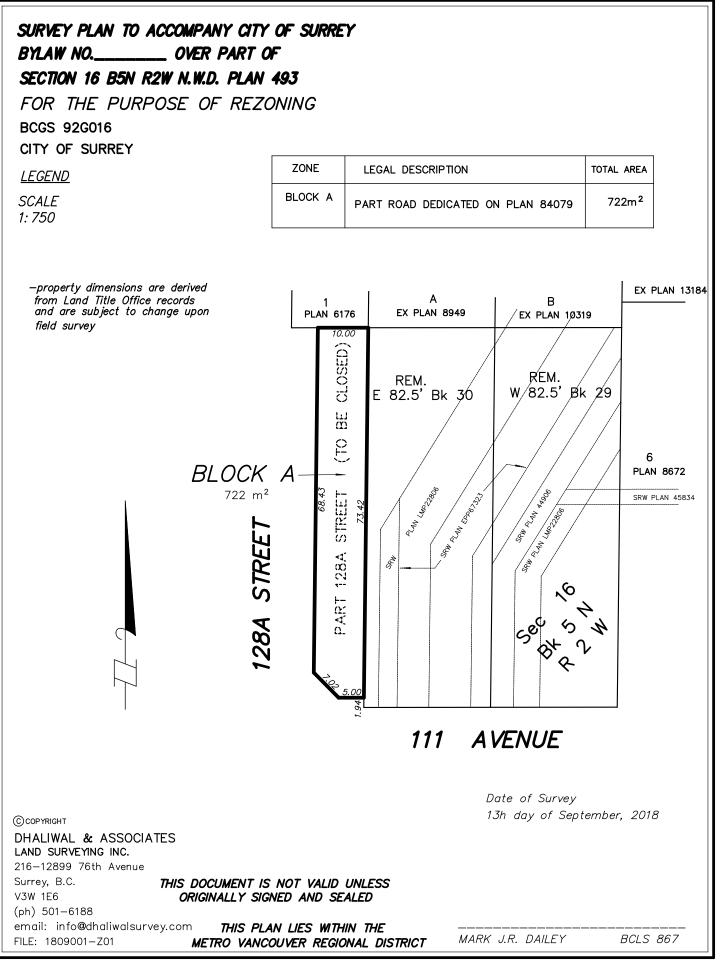



7914-0324-00 12855 & 12869 - 111 Avenue Aerial View of Site

