

INTER-OFFICE MEMO

Regular Council - Land Use Addendum Agenda #1 E.2 7918-0134-00 Monday July 8, 2024

TO:

City Clerk, Legislative Services Division

FROM:

Chief Development Approvals Officer, Development Planning, Planning &

Development Department

DATE:

July 8, 2024

FILE:

7918-0134-00

RE:

Agenda Item E.2, July 8, 2024 Regular Council - Land Use Meeting

Development Application No. 7918-0134-00 Replacement Page for the Planning Report

Development Application No. 7918-0134-00 is on the agenda for consideration by Council at the July 8, 2024 Regular Council – Land Use Meeting under Item E.2.

After finalizing the Planning Report for the July 8, 2024 Regular Council – Land Use Agenda, it was noted that there was an error on the OCP Redesignation Map attached as Appendix VI.

This map has been corrected and is provided as Appendix I to this memo.

A copy of bylaw "Surrey Official Community Plan Bylaw, 2013, No. 18020, Amendment Bylaw, 2024, No. 21315" was not included in the agenda package and is now provided as Appendix II to this memo with the correct OCP Redesignation Map.

Ron Gill

Chief Development Approvals Officer

Planning & Development Department

Attachment - 7918-0134-00- Appendix VI Replacement Page

c.c. - City Manager


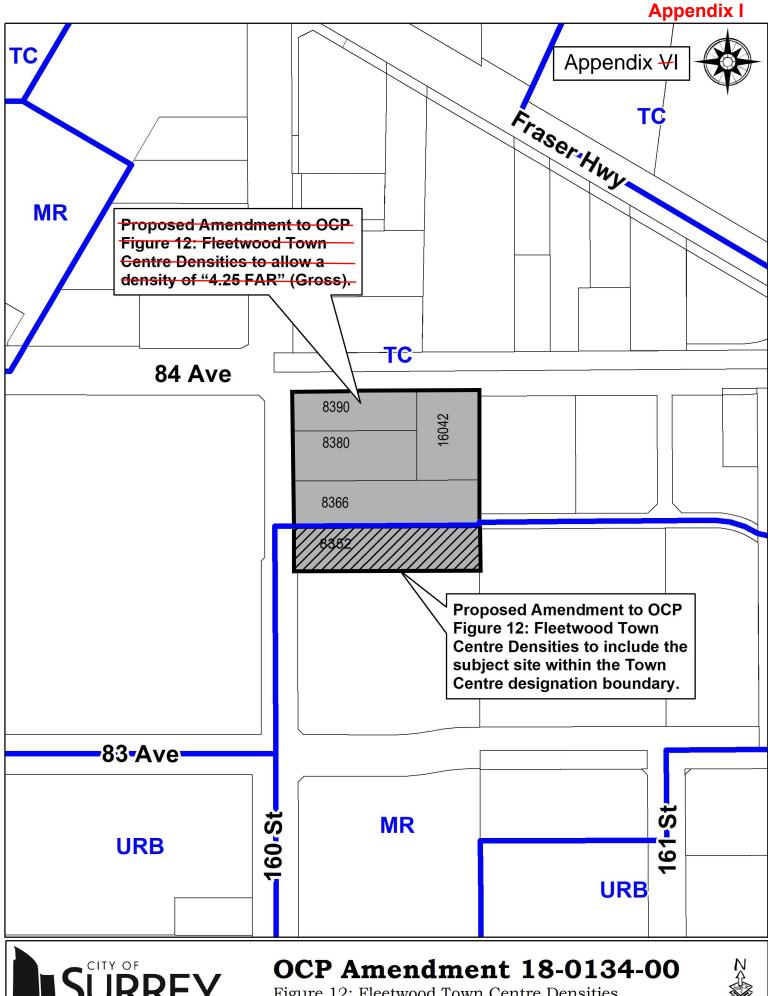




Figure 12: Fleetwood Town Centre Densities with a density of "4.25 FAR".





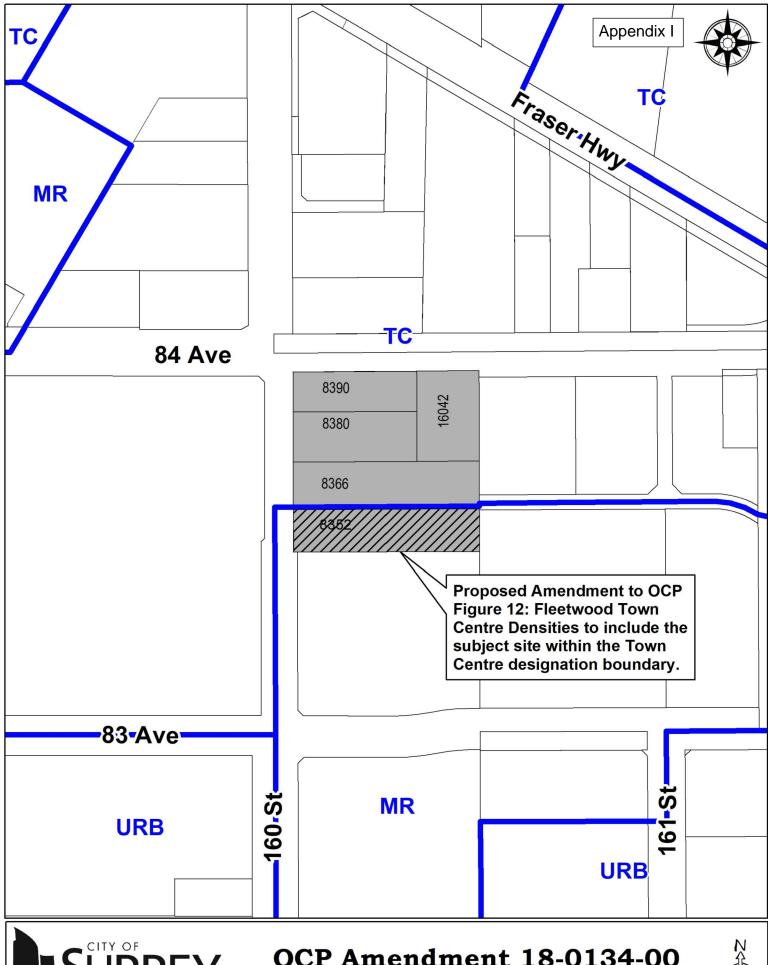

OCP Amendment 18-0134-00

Figure 12: Fleetwood Town Centre Densities



CITY OF SURREY

BYLAW NO. 21315

A bylaw to amend the provisions of Surrey Official
Community Plan Bylaw, 2013, No. 18020, as amended.

The Council of the City of Surrey ENACTS AS FOLLOWS:

- 1. Surrey Official Community Plan Bylaw, 2013, No. 18020, as amended, is amended as follows:
 - a. "Figure 3, General Land Use Designations" of the Land Uses and Densities Section by changing the land use designation for the area shown shaded on the plan labelled Schedule A, attached hereto and forming part of this bylaw:

FROM: MULTIPLE RESIDENTIAL (MR)

TO: TOWN CENTRE (TC)

PID: 009-741-887 Lot 3 Section 25 Township 2 New Westminster District Plan 12786

(8352 - 160 Street)


b. "Figure 12: Fleetwood Town Centre Densities" is amended by including
 8352 - 160 Street within the Town Centre boundary, shown hatched on the plan labelled Schedule B, attached to this Bylaw.

c. "Table 7a: Land Use Designation Exceptions" is amended to include 8352, 8366, 8380, 8390 - 160 Street and 16042 - 84 Avenue, as shown below:


Bylaw	Land Use	Site Specific	Site Specific
No.	Designation	Property	Permission
"Bylaw #	Town Centre	8352 - 160 Street	Density permitted
21315		009-741-887	up to 4.25 FAR
		Lot 3 Section 25 Township 2	(net calculation)"
		New Westminster District	
		Plan 12786	
		8366 - 160 Street	
		007-791-437	
		Lot 2 Section 25 Township 2	
		NWD Plan 12786	
		9290 160 Stroot	
		8380 - 160 Street 000-483-745	
		Lot 1 Except: North 70 Feet,	
		Section 25 Township 2 NWD	
		Plan 12786	
		F Idii 12/80	
		8390 - 160 Street	
		009-741-836	
		North 70 Feet Lot 1 Section	
		25 Township 2 NWD Plan	
		12786	
		16042 - 84 Avenue	
		012-702-820	
		Parcel "C" (N99040E)	
		Northerly Half Lot 1	
		Section 25, Township 2 NWD	
		Plan 2425	


2.	This Bylaw shall be cited for all purposes as "Surrey Official Community Plan Bylaw, 2013, No. 18020, Amendment Bylaw, 2024, No. 21315".
PASSE	D FIRST READING on the th day of , 20
PASSE	D SECOND READING on the th day of , 20
PUBLI	C HEARING HELD thereon on the th day of , 20
PASSE	D THIRD READING on the th day of , 20
	NSIDERED AND FINALLY ADOPTED, signed by the Mayor and Clerk, and sealed with the rate Seal on the th day of , 20
	MAYOR
	CLERK

SCHEDULE A

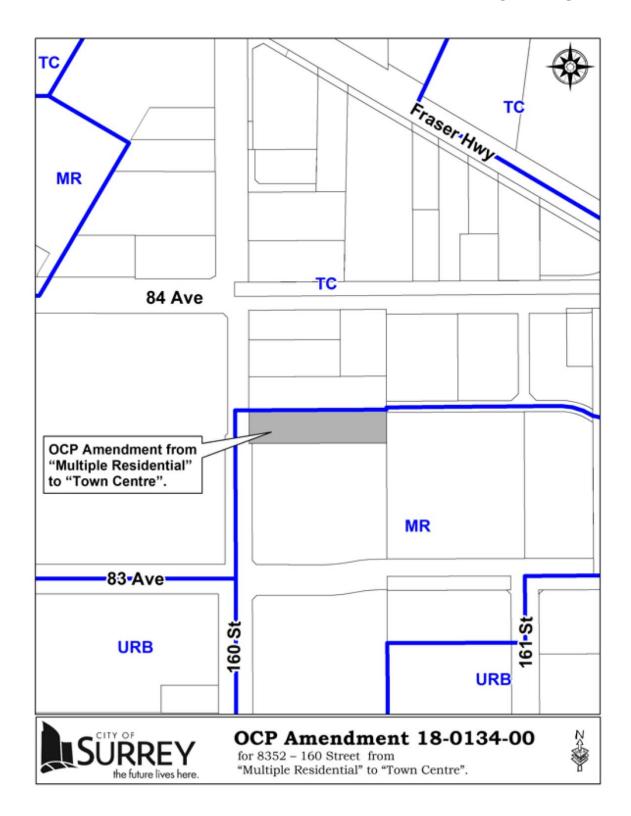

SCHEDULE B

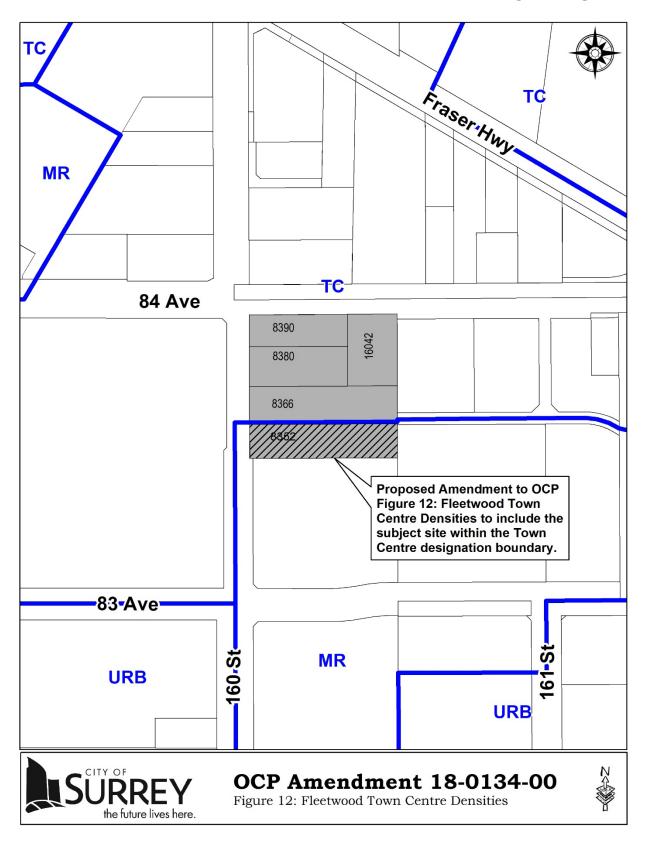

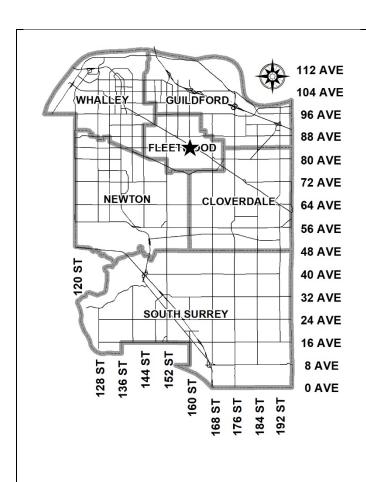

City of Surrey PLANNING & DEVELOPMENT REPORT Application No.: 7918-0134-00

Planning Report Date: July 8, 2024

PROPOSAL:

- Partial OCP Amendment from Multiple Residential to Town Centre
- OCP Text Amendment to allow a higher density in the Town Centre designation
- TCP Amendment from Low to High Rise Mixed Use and Low Rise Residential to High Rise Mixed Use
- Rezoning from RA to CD (based on RM-135 and C-5)
- Development Permit

to permit the development of one 5-storey, one 6-storey and one 30-storey mixed-use building with 529 dwelling units and 1,846 square metres of atgrade commercial space, including a child care centre, in Fleetwood.

LOCATION: 16042 – 84 Avenue, 8390 – 160 Street

8380 - 160 Street, 8366 - 160 Street

8352 - 160 Street


ZONING: RA

OCP DESIGNATION: Town Centre and Multiple

Residential

TCP DESIGNATION: Low to High Rise Mixed Use

and Low Rise Residential

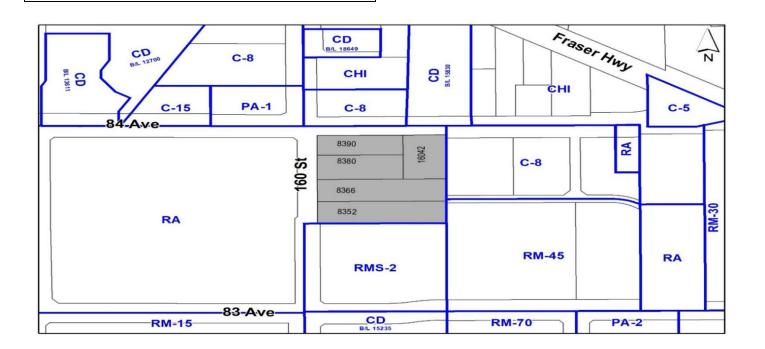

RECOMMENDATION SUMMARY

- Bylaw introduction and set date for Public Hearing for:
 - Partial OCP Amendment:
 - o OCP Text Amendment; and
 - o Rezoning.
- Approval to draft Development Permit for Form and Character.

DEVIATION FROM PLANS, POLICIES OR REGULATIONS

- Proposed a partial amendment to the Official Community Plan (OCP) from "Multiple Residential" to "Town Centre" and a text amendment to increase the maximum density permitted in the Town Centre designation.
- Proposed amendment to the Fleetwood Plan (Stage 1) from "Low to High Rise Mixed Use" and "Low Rise Residential" to "High Rise Mixed Use".

RATIONALE OF RECOMMENDATION

- The proposed partial amendment to the OCP from "Multiple Residential" to "Town Centre" and proposed text amendment to allow a higher density in the Town Centre designation is required to achieve the proposed high-rise mixed-use development on the subject site. The OCP Amendment is considered to have merit given the subject site is located within close proximity to transit service along Fraser Highway (a Frequent Transit Network [FTN]) and a future SkyTrain station at the intersection of 160 Street and Fraser Highway.
- The applicant further proposes to amend the Fleetwood Plan (Stage 1) from "Low to High Rise Mixed Use" and "Low Rise Residential" to "High Rise Mixed Use" to accommodate the proposed density and built form.
- The provincial legislation introduced in December, 2023 designates the site within a SkyTrain Station Transit Oriented Area (TOA), Tier 2, which requires a minimum FAR of 4.0 as well as a minimum building height of 12-storeys.
- The subject site is located within 85 metres of an existing bus stop and 230 metres of a future SkyTrain station. As such, the proposed density and built form are considered appropriate for a Town Centre designated site. In addition, the proposal supports the goal of achieving higher density development along transit corridors.
- The proposed mixed-use buildings are attractive, well-designed and utilize high-quality natural materials as well as contemporary lines. The applicant is proposing reduced building setbacks that benefit the streetscape by providing connectivity to the street. Appropriate landscaping is provided along the street frontages which helps to promote a pedestrian friendly environment and positive urban experience between the proposed buildings and public realm.

• The applicant will provide a density bonus amenity contribution consistent with the Tier 2 Capital Projects Community Amenity Contributions (CACs), in support of the requested increase in density.

RECOMMENDATION

The Planning & Development Department recommends that:

- 1. An OCP Amendment Bylaw be introduced to:
 - (a) Amend the OCP Figure 3: General Land Use Designations for a portion of the subject site from "Multiple Residential" to "Town Centre" (Appendix V);
 - (b) Amend the OCP Figure 12: Fleetwood Town Centre Densities to include a portion of the subject site within the Town Centre boundary (Appendix VI); and
 - (c) Amend the OCP, 'Table 7a: Land Use Designation Exceptions' by adding the following site-specific notation for the subject site:

"Bylaw	Land Use Designation	Site Specific Properties	Site Specific
No.			Permission
Bylaw # xxxxx	Town Centre	16042 – 84 Avenue, 8390 – 160 Street, 8380 – 160 Street, 8366 – 160 Street, and 8352 – 160 Street	Density permitted up to 4.25 FAR (Gross)"

and a date be set for Public Hearing.

- 2. Council determine the opportunities for consultation with persons, organizations and authorities that are considered to be affected by the proposed amendment to the Official Community Plan, as described in the Report, to be appropriate to meet the requirement of Section 475 of the <u>Local Government Act</u>.
- 3. A Bylaw be introduced to rezone the subject site from "One-Acre Residential Zone (RA)" to "Comprehensive Development Zone (CD)" and a date be set for Public Hearing.
- 4. Council authorize staff to draft Development Permit No. 7918-0134-00 generally in accordance with the attached drawings (Appendix I).
- 5. Council instruct staff to resolve the following issues prior to final adoption:
 - (a) ensure that all engineering requirements and issues including restrictive covenants, dedications, and rights-of-way where necessary, are addressed to the satisfaction of the General Manager, Engineering;
 - (b) submission of a subdivision plan to the satisfaction of the Approving Officer;
 - (c) resolution of all urban design issues to the satisfaction of the Planning and Development Department;
 - (d) review of the project by the Advisory Design Panel and resolution of design comments to the satisfaction of the General Manager, Planning & Development Department;

- (e) submission of a finalized landscaping plan and landscaping cost estimate to the specifications and satisfaction of the Planning and Development Department;
- (f) submission of a finalized tree survey and a statement regarding tree preservation to the satisfaction of the City Landscape Architect;
- (g) the applicant satisfy the deficiency in tree replacement on the site, to the satisfaction of the Planning and Development Department;
- (h) the applicant provide a density bonus amenity contribution consistent with the Tier 2 Capital Projects CACs in support of the requested increased density, to the satisfaction of the General Manager, Planning and Development Department;
- (i) demolition of existing buildings and structures to the satisfaction of the Planning and Development Department;
- (j) registration of a right-of-way for public rights-of-passage for the area between the building face and the street edges;
- (k) provision of a cash-in-lieu contribution to satisfy the indoor amenity space requirement of the Zoning By-law, at the rate in effect at the time of Final Adoption;
- (l) Registration of a Section 219 Restrictive Covenant to adequately address the City's needs with respect to public art, to the satisfaction of the General Manager Parks, Recreation and Culture and with respect to the City's Affordable Housing Strategy and Tier 1 Capital Project CACs, to the satisfaction of the General Manager, Planning & Development Services; and
- (m) Council approval for Stage 2 of the Fleetwood Plan.
- 6. Council pass a resolution to amend the Fleetwood Plan (Stage 1) to redesignate the land from "Low to High Rise Mixed Use" and "Low Rise Residential" to "High Rise Mixed Use" when the project is considered for final adoption (Appendix VII).

SITE CONTEXT & BACKGROUND

Direction	Existing Use	TCP Designation	Existing Zone
Subject Site	Single family residential and vacant parcels	Low to High Rise Mixed Use and Low Rise Residential	RA
North (Across 84 Avenue):	Commercial buildings	High Rise Mixed Use	C-8 and CD (Bylaw No. 15830)

Direction	Existing Use	TCP Designation	Existing Zone
T	X7 , 1 1,1	1 , 11: 1 D:	C 0 1 DM
East:	Vacant parcel and three-storey	Low to High Rise	C-8 and RM-45
	apartment buildings (Fairfield	Mixed Use and Low	
	House)	Rise Residential	
South:	Two-storey senior's residential	Low Rise Residential	RMS-2
	care facility (Fleetwood Place)		
West	Fleetwood Community Centre	Civic/Institutional	RA
(Across 160 Street):	and Francis Park	and Parks & Natural	
		Areas	

Context & Background

- The subject properties are approximately 0.94 hectare in total area and located on the south side of 84 Avenue, just east of 160 Street.
- The subject site is split designated "Multiple Residential" and "Town Centre" in the Official Community Plan OCP) as well as "Low to High Rise Mixed Use" and "Low Rise Residential" in the Fleetwood Plan (Stage 1). The properties are zoned "One-Acre Residential Zone (RA)". One property is occupied by a single-family residential dwelling while the other properties are currently vacant.

DEVELOPMENT PROPOSAL

Planning Considerations

- In order to permit a high-rise mixed-use development on the subject site consisting of 529 dwelling units and at-grade commercial uses with underground parking, the applicant has proposed the following:
 - Partial OCP Amendment from "Multiple Residential" to "Town Centre" and addition of the southernmost property into the Town Centre boundary in Figure 12: Fleetwood Town Centre Densities;
 - o OCP Text Amendment to allow a higher density in the Town Centre designation;
 - TCP Amendment from "Low to High Rise Mixed Use" and "Low Rise Residential" to "High Rise Mixed Use";
 - o Rezoning from RA to CD (based upon RM-135 and C-5); and
 - Development Permit for Form and Character to allow one 5-storey building, one 6-storey building and one 30-storey mixed-use building.
- Development details are provided in the following table:

	Proposed
Lot Area	
Gross Site Area:	9,387.37 sq. m.
Road Dedication:	1,090.52 sq. m.
Undevelopable Area:	N/A
Net Site Area:	8,296.85

	Proposed
Number of Lots:	5 lots (existing)
	ı lot (proposed)
Building Height:	91 m.
Unit Density:	N/A
Floor Area Ratio (FAR):	4.21 (Gross)/4.76 (Net)
Floor Area	
Residential:	37,658.75 sq. m.
Commercial:	1,846.41 sq. m.
Total:	39,505.16 sq. m.
Residential Units:	
Studio:	10 dwelling units
1-Bedroom:	113 dwelling units
1-Bedroom plus den:	201 dwelling units
2-Bedroom:	92 dwelling units
2-Bedroom plus den:	97 dwelling units
3-Bedroom:	16 dwelling units
Adaptable dwelling units:	o dwelling units
Total:	529 dwelling units

Referrals

Engineering: The Engineering Department has no objection to the project subject

to the completion of Engineering servicing requirements as outlined

in Appendix II.

School District: The School District has advised that there will be approximately 60

school-age children generated by this development, of which the

School District has provided the following expected student

enrollment.

35 Elementary students at Walnut Road Elementary School

15 Secondary students at Fleetwood Park Secondary School

(Appendix III)

Note that the number of school-age children is greater than the expected enrollment due to students attending private schools,

home school or different school districts.

The applicant has advised that the dwelling units in this project are

expected to be constructed and ready for occupancy by Fall, 2028.

Application No.: 7918-0134-00 Page 8

Parks, Recreation &

Culture:

No concerns.

The closest active park is Francis Park which is 150 metres walking distance from the development with amenities including a walking loop and children's playground. Walnut Park is the closest park with natural area and is 900 metres walking distance from the

subject site.

Surrey Fire Department: No concerns.

Advisory Design Panel:

The proposal was considered at the ADP meeting on June 27, 2024 and was conditionally supported. The applicant will continue to work with staff to resolve any outstanding items from the ADP review prior to Council's consideration of Final Adoption of the

rezoning bylaw, to the satisfaction of the Planning and

Development Department.

Transportation Considerations

Road Network and Infrastructure

- The applicant will be required to provide the following road frontage improvements to support the subject proposal:
 - o Dedication of 160 Street to the City's collector road standard;
 - o Dedication of 84 Avenue to the City's arterial road standard; and
 - o Dedication of a 6.0 metre wide north-south lane along the eastern property line.

Access and Parking

- The subject site is proposed to be accessed via the north-south lane.
- The applicant is proposing to provide a total of 627 parking spaces on-site which includes 55 commercial parking spaces, 6 designated pick-up and drop-off parking spaces for the child care centre and 27 accessible parking spaces.
- As the subject site is located within a Transit Oriented Area (TOA), there is no minimum residential parking requirement. The applicant will provide the minimum required on-site parking for the ground-level commercial uses and accessible parking, per the Zoning Bylaw.

Transit

• The subject site is located within close proximity to a Frequent Transit Network (FTN) along Fraser Highway, roughly 118 metres form an existing bus stop (#335 – Surrey Central Station to Newton Exchange and #341 – Newton Exchange to Guildford) as well as 240 metres from a future SkyTrain Station (Fleetwood Station).

• The proposed development is appropriate for this part of Fraser Highway and conforms with the goal of achieving higher density development in locations that benefit from direct access to frequent transit service.

Sustainability Considerations

• The applicant has met all of the typical sustainable development criteria, as indicated in the Sustainable Development Checklist.

POLICY & BY-LAW CONSIDERATIONS

Regional Growth Strategy

- The subject property is designated "General Urban" in the Regional Growth Strategy (RGS).
- The proposed development complies with the General Urban RGS designation.

Official Community Plan

Land Use Designation

- The subject site is split-designated "Town Centre" (8366/80/90 160 Street and 16042 84 Avenue) and "Multiple Residential" (8352 160 Street) in the Official Community Plan (OCP).
- In accordance with the OCP, the "Multiple Residential" designation is intended to support a maximum floor area ratio (FAR) of 2.5 in Frequent Transit Development Areas (FTDAs), Urban Centres, sites abutting a Frequent Transit Network and, where specifically noted, in approved Secondary Plan Areas. In addition, this land-use designation is generally intended for apartment buildings up to a maximum of 6-storeys, as well as higher-density townhouse developments.
- The proposed 6-storey apartment building located on the southerly portion of the site, which is designated "Multiple Residential", exceeds the maximum 2.5 FAR permitted in the OCP. As the remainder of the subject site is designated "Town Centre", the applicant proposes an OCP Amendment to Figure 3: General Land Use Designations to redesignate the southerly portion of the subject site from "Multiple Residential" to "Town Centre" in order to accommodate the proposed development (Appendix V). In addition, this will necessitate the boundaries of the Town Centre, as shown on Figure 12: Fleetwood Town Centre Densities, to be amended to include the entirety of the subject site.
- As part of extending the Town Centre boundary to include the subject site, staff recommend that Figure 12: Fleetwood Town Centre Densities be amended to include the subject site and assign a maximum permitted gross density of "4.25 FAR" (Gross), as shown on Appendix VI.

Amendment Rationale

- The subject properties are located within a Transit Oriented Area (TOA), in close proximity to a future SkyTrain Station at the intersection of 160 Street and Fraser Highway as well as within walking distance of existing bus service (Route #335 and #341) which serves Newton, Guildford and Surrey Central Station.
- According to "Figure 12: Fleetwood Town Centre Densities" in the OCP, a maximum density of 2.5 FAR (gross) is permitted on the subject site under the Town Centre designation. As such, a Text Amendment to the OCP is required to increase the maximum allowed density under the Town Centre designation from 2.5 FAR to 4.25 FAR (gross).
- The Town Centre designation allows additional bonus densities in select areas in exchange for the provision of sufficient community amenities in accordance with approved Council policies. The requested increase in density under the Town Centre designation from 2.5 FAR to 4.25 FAR (gross density) can be accommodated in accordance with the City's Density Bonus Program.
- The development proposal will be subject to Tier 2 Capital Plan Project CACs for the proposed density increase greater than the Official Community Plan (OCP) designation, as described in the Community Amenity Contribution section of this report.
- The applicant will be required to provide the per sq. ft. flat rate for the proposed floor area above the approved designation in the Official Community Plan (OCP). The contribution is payable at the rate applicable at the time of Rezoning Final Adoption.
- A higher density multiple residential development on the subject site is supportable given that it promotes walkability, allows for greater housing choice and complies with OCP principles that encourage higher-density developments in areas served by rapid transit.

Public Consultation for Proposed OCP Amendment

• Pursuant to Section 475 of the <u>Local Government Act</u>, it was determined that it was not necessary to consult with any persons, organizations or authorities with respect to the proposed OCP amendment, other than those contacted as part of the pre-notification process.

Themes/Policies

- The proposal will support various policies, outlined in the OCP, including the following:
 - The proposal supports transit-oriented development, focusing growth and increased density along frequent transit corridors which supports transit service expansion and rapid transit infrastructure investment;
 - The proposal supports directing higher-density residential land-uses to locations within walking distance of neighbourhood centres, along main roads, near transit routes and adjacent to major parks or civic amenities;
 - The proposal supports the development of purpose-built market condos with a variety of unit types to support a diversity of household sizes and composition located within walking distance of future rapid transit and Fleetwood Town Centre; and

 The dwelling units along 84 Avenue, 160 Street and the north-south lane have urban design features including ground-floor patio space, outdoor balconies, internal sidewalks, etc. that promote a safe, welcoming public streetscape and urban public realm.

Secondary Plans

<u>Land Use Designation</u>

- The subject property is designated "Low to High Rise Mixed Use" and "Low Rise Residential" in the Stage 1 Fleetwood Town Centre Plan (TCP).
- In order to accommodate the development proposal, an amendment to the Fleetwood Town Centre Plan (Stage 1) is required to re-designate the subject site from "Low Rise Residential" and "Low to High Rise Mixed Use" to "High Rise Mixed Use".

Amendment Rationale

- The provincial legislation introduced in December, 2023 designates the site within a SkyTrain Station Transit Oriented Area (TOA), Tier 2, which allows a minimum FAR of 4.0 as well as a minimum height of 12-storeys.
- The development proposal aligns with the Tier 2 provisions for SkyTrain TOAs but will require an amendment to the Fleetwood Town Centre Plan (Stage 1) from "Low to High Rise Mixed Use" and "Low Rise Residential" to "High Rise Mixed Use" in order to accommodate the proposed density and built form.
- The proposed density and building form are considered appropriate for this part of Fleetwood Town Centre given the subject properties are located within a Transit Oriented Area (TOA), in close proximity to an existing Frequent Transit Network (FTN) and located within 230 metres of a SkyTrain station at 160 Street and Fraser Highway (Fleetwood Station).
- Furthermore, the proposed development supports the goal of achieving higher density along transit corridors and within proximity to rapid transit. As such, the proposal has merit and will provide an appropriate transition between higher-density developments in the "core" (at the intersection of 160 Street and Fraser Highway) and lower-density developments located south of 84 Avenue.

Themes/Objectives

- The proposed development complies with guidelines and strategies outlined in the Fleetwood Plan, as follows:
 - o The proposal supports transit-oriented growth in proximity to future SkyTrain;
 - The proposal includes a broader diversity in terms of housing options which attracts a variety of different household sizes, types and compositions;
 - The proposed buildings create a sense of street enclosure with continuous building forms that include locating buildings near the property line and 6-storey pedestrian

scaled podium/building heights along the street frontage with at-grade commercial uses;

- The indoor amenity space is located away from the ground-level street frontages which allows for an active public realm with residential units fronting the street;
- The proposed buildings incorporate publicly accessible open spaces (i.e. public plazas) that are commensurate to the scale of development and located at the street corners.

Bill 47 - Transit Oriented Development Areas

- On November 30, 2023, the Provincial Government approved "Bill 47: Housing Statutes (Transit-Oriented Areas) Amendment Act". The intent of the legislation is to locate high-density, mixed-use development within walking distance of frequent transit service. This includes prescribing minimum building heights and densities that must be considered in reviewing proposals for increased density within Transit-Oriented Development Areas and the removal of restrictive parking minimums for off-street residential parking.
- As part of Bill 47, all properties located within an 800 metre radius of the future SkyTrain Station located at 160 Street and Fraser Highway (Fleetwood Station) are designated a Transit-Oriented Development Area (TODA). The minimum building height and density that must be considered by Council is based upon the proximity of each subject site to the future SkyTrain Station (i.e. within 200 metres, 200 400 metres and 400 800 metres of Fleetwood Station).
- The subject properties are located within 200 400 metres of a SkyTrain station and, per the TODA requirements, are eligible for a minimum density of 4.0 FAR (Net) and 12-storey building height.
- The current proposal is for a 30-storey mixed-use development with an FAR of 4.80 (Net) on the subject site. The proposed density is higher than required under Bill 47, but aligns with the intent of the Provincial legislation.

Proposed CD Bylaw

- The applicant proposes to rezone the subject site from "Acreage Residential Zone (RA)" to "Comprehensive Development Zone (CD)" (based upon the "Multiple Residential 135 Zone [RM-135]" and "Neighbourhood Commercial Zone [C-5]") in order to permit the proposed 30-storey mixed-use development. The proposed CD Zone for the subject site identifies the uses, densities and setbacks proposed.
- A comparison of the density, lot coverage, setbacks, building height and permitted uses in the RM-135 Zone, C-5 Zone and proposed CD Bylaw are illustrated in the following table:

Zoning	RMC-135 Zone (Part 25)	C-5 Zone (Part 35)	Proposed CD Zone
Floor Area Ratio:	2.50	0.50	4.80
Lot Coverage:	33%	50%	65%
Yards and Setbacks North East South West Principal Building Height: Permitted Uses:	50% of the height of the building N/A Multiple unit residential buildings and ground-oriented multiple unit residential buildings	7.5 m. 7.5 m. 7.5 m. 7.5 m. 9 m. Retail stores Personal service uses Eating establishments excluding drivethrough restaurants Neighbourhood pub Office uses General service uses Indoor recreational facilities Community services Child care centres One dwelling unit	3.0 m. 4.5 m. 9.0 m. 2.5 m. 91 m. • Multiple unit residential buildings and ground-oriented multiple unit residential buildings • Retail stores • Personal service uses • General service uses • Indoor recreational facilities • Eating establishments limited to 150 square metres in gross floor area • Neighbourhood pub • Office uses • Community services • Child care centres
Amenity Space			
Indoor Amenity:	1,211 sq. m.	N/A	The proposed 955 m²
Outdoor Amenity:	1,597 sq. m.	N/A	and CIL meets the Zoning By-law requirement.
			The proposed 1,734 m² exceeds the Zoning By-law requirement.

Parking (Part 5)	Required	Proposed
Number of Stalls	-	
Commercial:	50 spaces	51 spaces
Child Care Centre:	10 spaces	10 spaces
Residential:	N/A	499 spaces
Residential Visitor:	N/A	56 spaces
Accessible:	27 spaces	27 spaces
Total:	60 spaces	616 spaces

Application No.: 7918-0134-00 Page 14

Bicycle Spaces		
Residential Secure Parking:	635 bicycle spaces	652 bicycle spaces
Residential Visitor:	18 bicycle spaces	18 bicycle spaces

- The proposed CD Bylaw will incorporate similar uses as the RM-135 Zone for the residential component and the C-5 Zone for the commercial component, with the exception of eating establishments, which will be limited to a maximum gross floor area of 150 square metres to reflect the parking provided on-site.
- The applicant is proposing a floor area ratio (FAR) of 4.25 (Gross)/4.80 (Net). The proposed density aligns with the 4.0 FAR (Net) permitted in a Tier 2 SkyTrain TOA and "High Rise Mixed Use" designation in the Fleetwood Plan which allows up to 30-storeys and 3.7 FAR (Gross) or 4.0 FAR (Gross) if 0.3 FAR of commercial or institutional space is provided on-site. The FAR proposed on-site is consistent with other high-rise developments in a Town Centre that are located in close proximity to existing or future SkyTrain.
- The maximum lot coverage has been increased from 33% in the RM-135 Zone to a maximum of 65% in the CD Bylaw to accommodate the proposed built form. The proposed lot coverage is typical for a high-rise development on a site of this size.
- The RM-135 Zone requires the setbacks to be 7.5 metres or a minimum of fifty percent (50%) of the building height, whichever is greater. The applicant is proposing reduced setbacks in the CD Bylaw which is supportable given that it allows for more active engagement with the street and, therefore, is consistent with the Fleetwood Plan objectives and design guidelines.

On-site Parking and Bicycle Storage

- The proposed development includes a total of 627 parking stalls consisting of 51 commercial parking spaces, 10 parking stalls for the child care centre, 499 residential parking stalls and 56 parking spaces for visitors. In addition, the applicant will provide 27 accessible parking stalls. All parking spaces will be provided in an enclosed underground parkade that will be accessed from the north-south lane.
- As part of the Provincial legislation (Bill 47), proposed developments located within Transit-Oriented Development Areas are no longer required to provide minimum off-street parking spaces for residents or visitors. The applicant, however, is required to provide the minimum commercial and accessible off-street parking spaces, per the Zoning Bylaw.
- The Surrey Zoning Bylaw allows a maximum of 35% of the total required parking spaces to be provided as "small car" spaces. The applicant is proposing a total of 22 small car spaces which complies with the Zoning Bylaw provisions.
- The Zoning Bylaw requires that no parking facilities be constructed within 2.0 metres of the front lot line or a lot line along a flanking street. The proposed underground parkade will be located within 0.5 metre of the front and flanking street lot lines (84 Avenue and 160 Street). As a result, the proposed CD Zone will allow the underground parkade to extend to 0.5 metre of the lot line along all street frontages.

• The development will provide a total of 652 secure bicycle parking spaces in the underground parkade as well as 18 surface bicycle parking stalls. This will exceed the minimum requirement in the Surrey Zoning Bylaw.

Capital Projects Community Amenity Contributions (CACs)

- On December 16, 2019, Council approved the City's Community Amenity Contribution and Density Bonus Program Update (Corporate Report No. R224; 2019). The intent of that report was to introduce a new City-wide Community Amenity Contribution (CAC) and updated Density Bonus Policy to offset the impacts of growth from development and to provide additional funding for community capital projects identified in the City's Annual Five-Year Capital Financial Plan. A fee update has been approved in April 2023, under Corporate Report No. R037;2023.
- The proposed development is subject to Tier 1 Capital Project CACs and will be required to provide a financial contribution of \$2,227.85 per dwelling unit. The contributions are payable at the rate applicable at the time of Building Permit issuance.
- In addition, the applicant is required to provide Tier 2 Capital Project CACs for the proposed density that is greater than currently allowed under the Fleetwood Plan (Stage 1) designation. At present, the current rate is \$419.65 per square metre. The contribution is required at the time of Final Adoption of the Rezoning Bylaw.

Affordable Housing Strategy

- On April 9, 2018, Council approved the City's Affordable Housing Strategy (Corporate Report No. Ro66; 2018) requiring that all new rezoning applications for residential development contribute \$1,068 per new unit to support the development of new affordable housing. The funds collected through the Affordable Housing Contribution will be used to purchase land for new affordable rental housing projects.
- The applicant will be required to register a Section 219 Restrictive Covenant to address the City's needs with respect to the City's Affordable Housing Strategy.

Public Art Policy

• The applicant will be required to provide public art or register a Restrictive Covenant agreeing to provide cash-in-lieu, at a rate of 0.5% of construction value, to adequately address the City's needs with respect to public art, in accordance with the City's Public Art Policy requirements. The applicant will be required to resolve this requirement prior to consideration of Final Adoption.

PUBLIC ENGAGEMENT

- Pre-notification letters were sent on January 3, 2024, and the Development Proposal Signs were installed on June 24, 2024. Staff received three (3) responses from area residents (staff comments in italics):
 - Two individuals requested general information about the proposed development.
 - o One individual expressed concern about the building height and density.

(The proposal aligns with the minimum height and density permitted for sites in Tier 2 SkyTrain Transit Oriented Areas [TOA] that allows for an FAR of 4.0 and 12-storey building height. In addition, the site is designated "Low to High Rise Mixed Use" in the Fleetwood Plan [Stage 1] which permits a maximum density of up to 3.25 FAR and 20-storey building height).

• Two individuals expressed concerns about increased traffic and potential noise generated by construction activities.

(The subject site is located within roughly 85 metres of existing bus stops that serve Newton, Guildford and City Centre as well as 230 metres from a future SkyTrain station at 160 Street and Fraser Highway. The proximity of frequent transit is expected to mitigate the impacts of additional traffic generated by the proposed development.

The proposal was reviewed by Transportation Division and staff confirmed that a Traffic Impact Study was not required given the proposed development does not meet the threshold for requiring an independent site-specific assessment.

The Surrey Noise Control Bylaw, 1982, No. 7044, as amended, permits construction activities between the hours of 7:00 a.m. and 10:00 p.m. from Monday to Saturday. The applicant does not anticipate that construction activities will take place outside of normal business hours.)

 One individual expressed concern about the pressure that increased density would place on existing schools.

(The School District will continue to monitor school enrollment and will work with the City and Province to address school capacity issues. As noted in the School District comments, this includes classroom additions and identifying future school sites within the plan area.)

One individual asked if the proposed development is anticipated to impact the evergreen trees on the west side of 160 Street or Francis Park.

(The proposal will not impact the trees on the west side of 160 Street or Francis Park.)

- One individual asked about the number of dwelling units geared to low-income families.
 - (The applicant is not proposing any dwelling units directed toward low-income households.)
- o One individual asked for information regarding the applicant's plan to manage traffic related to construction activities taking place on-site.

(The applicant is committed to managing construction traffic and will develop a construction management plan that addresses concerns within the surrounding neighbourhood.)

- The subject development application was reviewed by the Fleetwood Business Improvement Association and Fleetwood Community Association. The Fleetwood Community Association provided the following comments (staff comments in italics):
 - The proposed development should comply with the allowable density and building height, as specified in the Fleetwood Plan (Stage 1).
 - The applicant should provide significant community amenities on-site (e.g. an urgent care medical centre) in exchange for the City supporting increased density and building height.
 - Any development proposal needs to seriously consider the impacts on school capacity and additional strains placed on municipal infrastructure.

(The Fleetwood Community Association provided comments before the Province introduced legislation [Bill 47] which allows for a minimum density of 4.0 FAR [Net] and 12-storey height on properties located within 200 to 400 metres of future SkyTrain. The proposal generally aligns with the minimum density and building height prescribed in the legislation.

The School District has advised the proposed development is expected to generate fifty (50) public school students and will continue to work with the City and Province to address school capacity issues in order to accommodate redevelopment.

The proposed development includes road dedications and servicing upgrades along the street frontages, that will be included in the Servicing Agreement, which is required as a condition of Final Adoption.

The applicant is providing at-grade commercial units which could accommodate a range of businesses that provide community amenities [e.g. medical office, community service, etc.] as well as a dedicated child care space which will serve the broader community.)

DEVELOPMENT PERMITS

Form and Character Development Permit Requirement

- The proposed development is subject to a Development Permit for Form and Character.
- The proposal generally complies with the Form and Character Development Permit guidelines in the OCP and the applicant has worked with staff to ensure an appropriate interface between land-uses as well as further refine the overall building massing in order to ensure an attractive streetscape and reflect an urban public realm.

Building Design

- The proposed development is comprised of one 5-storey, one 6-storey and one 30-storey mixed-use building consisting of 529 market condo units and 1,846 square metres of atgrade commercial space.
- The tower separation diagram, included in the architectural drawing set, demonstrates that the proposed tower location and orientation on the subject site is at an acceptable distance away from potential future towers on neighbouring lots, per the minimum building separation requirements in the OCP.
- The tower tapers its form and floor plates from the twenty-fifth storey and upwards.
- The ground-floor level of each building provides for a continuous street wall with at-grade commercial/retail units (CRUs) that wrap around the street frontages and extend the façade plane continuously for at least 4-storeys, in compliance with the Stage 1 Fleetwood Plan, to create street enclosure for this urban area.
- With the commercial street frontages, the applicant will provide on-site landscaping and fixed furnishings to support commercial activities and the public realm.

- The common residential and commercial unit entrances are designed to be easily identifiable. The common lobby entrances are located along 160 Street and 84 Avenue.
- Along the eastern elevation of Building 2, the applicant proposes residential units at-grade adjacent the north-south lane. Each of these units will have individual exterior patio entries that directly connect to the lane. The patios will have landscaping to buffer and beautify this interface.
- The applicant will work with City staff to develop a design that incorporates the current urban design guidelines and principles in the Stage 1 Fleetwood Plan before Final Adoption through tower and podium refinement as well as public realm and street interfaces.
- The podium building street elevations have a contemporary character this is comprised of traditional dark grey colour brick veneer that spans several storeys and are combined with contemporary window walls and smooth fibre cement panels. The balconies are characterized by its metal frame and glass panels for a transparent effect. The commercial frontages come with a continuous wrap of metal and glass weather protection canopies. All rooftops will be comprised of high albedo roofing materials to address the urban head island effect.
- The building elevations on the tower component include window wall, grey colour metal panel and metal frame balconies with transparent glass panels.
- The at-grade outdoor amenity will come with weather protection canopies to allow prolonged usage throughout the year. The outdoor play space for the child care centre will be directly in front of the child care's indoor facility to maintain a functional relationship and buffered from residential programs to mitigate interference.
- The seventh level of the podium (Building 3) includes an indoor amenity space with direct linkages to the outdoor amenity space on that same level. Additional rooftop outdoor amenity space is provided on Level 2 (Building 2) and Level 6 (Building 3).

Commercial Component

- The commercial component is located at-grade along 84 Avenue (an arterial road) and wraps around the corner to extend southward along the east side of 160 Street (a collector road). The applicant proposes a total of 1,846 square metres of commercial space consisting of fifteen (15) CRUs and a 181 square metre purpose-built child care centre with associated outdoor play area located adjacent the outdoor amenity space for the residential dwelling units.
- The retail units will front onto 84 Avenue and/or 160 Street to provide maximum exposure to pedestrian and vehicular traffic. The commercial land-uses will have a separate lobby entrance and elevator access from the residential component. The location of the proposed commercial uses, along the south side of 84 Avenue and east side of 160 Street, is consistent with the intent of the mixed-use designation, as is shown in the Stage 1 Plan.

Proposed Signage

- For the proposed development, the applicant is proposing to provide one (1) fascia sign along the street frontage for each ground-floor commercial unit with direct access to 84 Avenue or 160 Street. The fascia signage will consist of individual channel letters mounted directly above each unit entry.
- The proposed fascia signage will not extend more than 0.5 metre from the building façade and will comply with all aspects of the Surrey Sign By-law.
- The proposed free-standing sign, as shown on the landscape plans, is not supported by staff. This is consistent with the position that staff have taken on similar mixed-use developments of this type, scale and urban context. As such, staff will continue to work with the applicant towards an acceptable signage package prior to Final Adoption.
- At this time, no other signage is proposed on the subject site. If required in future, all further signage proposed will be considered as part of a separate development application and will be expected to comply with the Sign By-law.

Indoor Amenity Space

- The applicant is proposing one large indoor amenity area, located at-grade, that will be shared between the residential components of each building. The ground-level indoor amenity space is located adjacent to a large central courtyard with direct access to the outdoor amenity space.
- Additional indoor amenity space is provided at-grade in Building 1 with a larger rooftop indoor amenity space provided on Level 7 (Building 3) with direct access to the outdoor amenity space provided atop the podium.
- The indoor amenity space consists of kitchen facilities, multi-purposes halls, two gyms as well as a media room, family room, lounge, library and meeting room.
- According to the Zoning By-law, the proposed development on the subject site is required to provide the following minimum indoor amenity space requirement:
 - o 3 square metres per dwelling unit for buildings 6-storeys in height or less;
 - o 3 square metres per dwelling unit up to 557 sq. m. (equivalent to 186 dwelling units) for buildings greater than 6-storeys in building height;
 - o 1 square metre per dwelling unit for that portion greater than 557 sq. m. for buildings greater than 6-storeys in building height; and
 - 4 square metres per dwelling unit for micro units.
- Based upon the Zoning Bylaw requirement, the proposed development is required to provide 1,211 square metres of indoor amenity space. The proposed indoor amenity space is 955 square metres in total area, which is 256 square metres less than the Zoning Bylaw requirement.

- Overall, the applicant is proposing to provide 79% of the required indoor amenity space on site and has agreed to a monetary contribution, in accordance with City Policy, to address the shortfall.
- The cash-in-lieu of indoor amenity space must be provided at the rate in effect at the time of Final Adoption of the Rezoning By-law.

Outdoor Amenity Space and Proposed Landscaping

- The ground-level outdoor amenity space is centrally located and directly adjacent to the indoor amenity space. The applicant is proposing the following outdoor amenity spaces:
 - Level 1 (Building 2): ground-level outdoor amenity space consisting of lounge areas, barbeque and dining island with bar stools, bistro tables, harvest tables and benches as well as children's playground equipment.
 - Level 2 (Building 2): yoga and tai chi deck, planter boxes, foosball table, ping pong table, Okanagan chairs, bistro tables, bench seating, potting bench and urban farm boxes.
 - Level 6 (Building 1): sun deck with lounge chairs, open lawn, benches, harvest table, a
 potting bench and urban farm boxes.
 - o Level 7 (Building 3): yoga deck, barbeque, picnic table, Okanagan chairs, planter boxes, lounge area and multi-age children's playground equipment
- The proposed outdoor amenity space is roughly 1,734 square metres in total area which exceeds the minimum outdoor amenity space requirement, per the Zoning By-law, based upon a total of 3 square metres per dwelling unit and 4 square metres per micro unit.
- The proposed landscaping has been designed to respond to the urban nature of Fleetwood Town Centre as an active, pedestrian-friendly space. The overall design considers the grade change, pedestrian circulation and provides an inclusive interface between the public and private realm.
- Each individual ground-oriented unit will have a small private patio or front yard enclosed by a 1.0 to 1.2 metre high metal picket fence and private gate with layered planting that includes a by-law sized tree, small shrubs and/or low-lying ground cover.
- Each apartment unit that faces onto the street frontage or outdoor amenity space will provide an "eyes-on-the-street" function with active rooms facing toward the public realm.
- Exterior lighting is designed to reduce light pollution as well as provide adequate lighting to ensure community safety, in keeping with CPTED principles.

Advisory Design Panel

ADP date: June 27, 2024

The applicant has agreed to resolve the remaining outstanding items noted below, from the ADP review to the satisfaction of the Planning and Development Department before Final Adoption.

Outstanding Items

- City staff will continue to work with the applicant to resolve the following outstanding designrelated issues and Advisory Design Panel Comments, as follows:
 - Refine the streetwall enclosure and massing along 84 Avenue and 160 Street with a flush plane from the first to fourth storey;
 - Refine the public realm interfaces with setbacks, massing and building planes defined in the Stage 1 Fleetwood Plan as well as associated landscape features towards the streets and lane;
 - o Increase the building separation between the tower and low-rise;
 - Refine the form and character of the tower, including making its lower, mid, upper and crown components to be congruent;
 - o Refine the location, buffering, program relationship and access of the childcare;
 - o Refine the south building's south elevation massing, projection and character;
 - Refine each outdoor amenity area's programing, access, accessibility and functionality and relationship to the indoor amenity areas; and
 - Resolve all other urban design issues.
- The applicant has been provided a detailed list identifying these requirements and has agreed to resolve these prior to Final Adoption of the Development Permit, should the application be supported by Council.

TREES

• Noah Talbot, ISA Certified Arborist of McElhanney Consulting Services Ltd. prepared an Arborist Assessment for the subject property. The table below provides a summary of the proposed tree retention and removal by tree species:

Table 1: Summary of Proposed Tree Preservation by Tree Species:

Table 1: Summary of Proposed Tree Preservation by Tree Species:						
Tree Species	Existing		Remove	Retain		
Alder and Cottonwood Trees						
Red Alder		7	7	0		
(excludin _i	Deciduous Trees (excluding Alder and Cottonwood Trees)					
Elm		3	3	0		
European Mountain Ash		1	1	0		
Cherry		3	3	0		
Black Locust		4	4	0		
Apple		2	2	0		
Bigleaf Maple		4	4	0		
English Walnut		1	1	0		
Pacific Dogwood		1	1	0		
	Conife	rous Trees				
Douglas Fir		27	27	0		
Grand Fir		1	1	0		
Western Red Cedar	5		5	0		
Western Hemlock	3		3	0		
Sitka Spruce	2		2	0		
Austrian Pine		1	1	0		
Shore Pine		1	1	0		
False Cypress		1	1	0		
Total (excluding Alder and Cottonwood Trees)		59	59	o		
Total Replacement Trees Proposed (excluding Boulevard Street Trees)		127				
Total Retained and Replacement Trees Proposed		127				
Estimated Contribution to the Green City Program			N/A			

• The Arborist Assessment states that there are a total of fifty-two (52) mature trees on the site, excluding Alder trees. Seven (7) existing trees, approximately twelve (12%) of the total trees on the site, are Alder trees. The applicant is not proposing to retain any trees. The proposed tree retention was assessed taking into consideration the location of services, building footprints, road dedication and proposed lot grading.

- For those trees that cannot be retained, the applicant will be required to plant trees on a 1 to 1 replacement ratio for Alder trees, and a 2 to 1 replacement ratio for all other trees. This will require a proposed total of one-hundred eleven (111) replacement trees on the subject site. The applicant is proposing one-hundred twenty-seven (127) replacement trees, thereby exceeding City requirements.
- In addition to the replacement trees, boulevard street trees will be planted along 84 Avenue and 160 Street. This will be determined by the Engineering Department during the servicing design review process.
- The new trees on the site will consist of a variety of trees including Teddy Bear Southern Magnolia, Cutleaf Staghorn Sumac, Paperbark Maple, Forest Pansy Sourwood, Princeton Sentry Maidenhair Tree, Slender Hinoki False Cypress, Pink Flowering Dogwood, Slender Silhouette Sweetgum, Black Dragon Japanese Cedar, Leylands Cypress, Columnar Kentucky Coffee Bean Tree, Southern Magnolia Vitoria, Flowering Crabapple, Vanderwolf's Pyramidal Limber Pine, Vanessa Persian Ironwood and Columnar White Oak.
- In summary, a total of one-hundred twenty-seven (127) trees are proposed to be replaced on the site with no contribution required to the Green City Program.
- The proposed tree retention and replacement strategy will be refined as the applicant works through the detailed design process.

INFORMATION ATTACHED TO THIS REPORT

The following information is attached to this Report:

Appendix I. Site Plan, Building Elevation Drawings, Landscape Plans and Perspective

Appendix II. Engineering Summary
Appendix III. School District Comments

Appendix IV. Summary of Tree Survey, Tree Preservation and Tree Plans

Appendix V. OCP Redesignation Map (Figure 3)
Appendix VI. OCP Redesignation Map (Figure 12)

Appendix VII. NCP Redesignation Map

approved by Ron Gill

Don Luymes General Manager Planning and Development

PROPOSED MIXED-USE DEVELOPMENT AT 160 STREET & 84 AVENUE, SURREY, BC



3D AERIAL VIEW-FROM 84 AVE.

SUBMISSION TO DP (18-0134)

FOR TWO SIX STOREY AND ONE THIRTY STOREY MIXED-USE BUILDING

SITE SUMMARY

ZONING

CMC ADDRESS 8352/8366/8380/8390 - 160 STREET AND 16042 - 84 AVENUE, SURREY

LEGAL DESCRIPTION NORTH 70 FEET PLOT 1 PLAN 12786, PLOT 1 EXCEPT: NORTH 70 FEET PLAN 12786 LOT 2 & 3 PLAN 12786, AND PARCEL "C" (N99040E) NORTHERLY HALF PLOT 1 PLAN

242

ALL OF SECTION 25 TOWNSHIP 2, NEW WESTMINISTER DISTRICT.

CD (BASED ON RM-135 AND C-5)

UNDERGROUND PARKADE, DAY CARE, COMMERCIAL RETAIL UNIT, RESTAURANT,

USAGE UNDERGROUND PARKADE,
OFFICE USE, RESIDENTIAL

SITE COVERAGE 65%

PARKING TOTAL PARKING PROVIDED 631 STALLS

PROPOSED FAR 4.21 ON GROSS

	BUILDING 1	BUILDING 2	BUILDING 3	TOTAL
TOTAL RESIDENTIAL				
	404 LINITO	CZ LINITO	OAO LINITO	FOA LINITO
UNITS	161 UN I TS	57 UN I TS	313 UNITS	531 UN I TS
BUILDING HEIGHT	19 m (6 STOREY)	19 m (6 STOREY)	91 m (30 STOREY)
DOLLDING HEIGHT	10 111 (0 0 1 0 1 1 1 1)	10 111 (0 0 1 0 1 1 1 1)	0111110001011	/

CONSULTANT LIST		
CLIENT: PLATINUM GROUP 201 12837 76 AVE., SURREY, BC CONTACT: AVTAR JOHL T:604 599 4652	ARCHITECTURAL: FLAT ARCHITECTURE INC, 209-6321 KING GEORGE BLVD., SURREY, BC CONTACT: RAJINDER WARRAICH T:604 503 4484	CIVIL: MELIHANNEY CONSULTING SERVICES LTD. SUIT 2300 CENTRAL CITY TOWER 13450-102 AVE., SURREY, BC CONTACT: T:604 596 0391
LANDSCAPE: PMG LANDSCAPE ARCHITECTS C100 - 4185 STILL REEK DRIVE, BURNABY, BC CONTACT: CAELAN L. GRIFFITHS T:504 294 0011	ARBORIST: MELHANNEY CONSULTING SERVICES LTD. SUIT 2300 CENTRAL CITY TOWER 13450-102 AVE, SURREY, BC CONTACT: NOAH TALBOT T:604 424 4936	SURVEYOR: H.Y. ASSOCIATES LAND SURVEYING LTD. 200 9128-152ND STREET., SURREY, BC CONTACT-EUGENE O, WONG T:604 583 1616
STRUCTURE: WSP CANADA 840 HOWE STREET, 10TH FLOOR, VANCOUVER, BC CONTACT: ROBERT WEST		

T:604 862 8054

TABLE OF CONTENTS

GENERAL

A.P 204

A 000	COVER PAGE
A 001	DRAWING LIST
A 002	PROJECT DATA - SITE
A 003	PROJECT DATA - BUILDINGS
A 004	DESIGN RATIONALE
A 005	CONTEXT PLAN
A 006	CONTEXT PHOTOS
A 007	CONTEXT DIAGRAM
A 008	SITE ANALYSIS
A 009	CONTEXT PHOTOS
A 010	HEIGHT DIAGRAM
A 050	CONCEPTUAL SHADOW STUDY
A 051	CONCEPTUAL TOWER SEPARATION PLAN
A 052	MASSING STUDY
A 053	MASSING & PROGRAM
A 054	PRECEDENTS
A 055	MATERIALS .
A 056	SITE ACCESS ANALYSIS
A 057	OVERALL VIEWS
A 058	OVERALL VIEWS
A 059	OVERALL VIEWS
A 060	OVERALL VIEWS
A 061	OVERALL VIEWS
A 062	OVERALL VIEWS
A 063	0VERALL VIEWS
A 064	OVERALL VIEWS
A 065	OVERALL VIEWS
A 066	OVERALL VIEWS
A 067	OVERALL VIEWS
A 068 A 069	0VERALL VIEWS 0VERALL VIEWS
	OVERALL VIEWS OVERALL VIEWS
A 070 A 071	OVERALL VIEWS
A 072	OVERALL VIEWS
A 073	OVERALL VIEWS
A 074	OVERALL VIEWS
A 075	OVERALL VIEWS
A 100	BASE PLAN
A 101	SITE PLAN - INTERIM
A 102	SITE PLAN - ULTIMATE
A 103	PHASING PLAN
A 104	NTERIM - FIRE RESPONSE
A 105	ULTIMATE - FIRE RESPONSE
A 106	SITE PLAN
A 107	OVERALL LEVEL 2 PLAN
A 108	OVERALL LEVEL 3 PLAN
A 150	BLDG, 1 AMENITY SPACE
A 151	BLDG. 2 AMENITY SPACES
A 152	BLDG, 3 AMENITY SPACES
A 152B	BLDG, 3 AMENITY SPACES
A 153	SITE ELEVATION 160 ST.
A 154	SITE ELEVATION 84 AVE
A 155	SITE ELEVATION-LANE
A 156	SITE SECTION
A 157	SITE SECTION
A 158	DETAIL SECTIONS
A 159	DETAIL SECTIONS
A 160	DETAIL SECTIONS
A 161	ENCLOSURE DETAILS
A 162	SIGNAGE DETAILS
A 164	ENTRANCE LOBBY ELEVATIONS
A 165	OUTDOOR AMENITY AREA
A.P 200	PARKING STANDARDS
A-P 201	U/G PARKADE P1
A.P 202	U/G PARKADE P1 - MEZZANINE LEVEL
A.P 203	U/G PARKADE P2

U/G PARKADE P3



Unit 209- 6321 King George Blw Surrey BC, V3X 1G1 www.flatarchitecture.ca contact@flatarchitecture.ca Ph: 604-503-4484

KUJECI INFO: ROPOSED MIXED-USE DEVELOPMENT T 160 STREET & 84 AVENUE, SURREY, BC

DATE 04/07/2024
PROJECT NO: 20-224
SCALE: DRAWN BY 1: 48 A.R.C.

COVER PAGE

		CITE STATISTICS				
CIVIC ADDRESS:		SITE STATISTICS 8352/8365/8380/8580 - 150 Street an	d 16047 - 84 America S	LIDDEA		
					1786 AND PARCE: 10° /k ggnar	E) NORTHERLY HALF LOT 1 PLAN 2425
LEGAL DISCRIPTION		AU, OF SECTION 25 TOWNSHIP 2, NEW	WESTMINISTER DISTE	SCT.	TOO AND PARKET C YESTON	SHO THOSE IND COLLEGE
ZON NG		CD (BASED ON RM-135 AND C-5)				
			0.007.07			***
GROSS SITE AREA: NET AREA:		101,044.81 sq.ft 89,306.95 sq.ft	5387.37 sq.m. 5296.85 sq.m.		2.32 ac 2.05 ac	.94 ha .83 ha
NET ANEX:		69,300.00 90,11	2230,003 sq. (C		2,00 80	70.5 He
ZON NG						
	BUILDING HEIGHT	ALLOWED			PROVIDED	
	MAXIMUM BUILDING HEIGHT FERMITED UNDER RM-135 ZONE BUILDING HEIGHT UNDER C-5 ZONE	NO YAX, HE GH			19 m/ 91 m	
	SETBACKS	REQD			PROVIDED	ENCRGACHMENT INTO SETBACK
	UNDER RAV-125 ZONE	7.5 m 7.5 m				
	UNDER C-5 ZONE	7.5 m				
	NORTH (FROM E4 AVE.)				3.0 m.	1.8 m (canopy Bidg, 1 and Bidg, 2)
	9CUTH				5.3 m.	1.4 m (Building 1)
	EAST(FROM 160 ST.) WEST				4.50 m. 2.50 m.	2.7 m (canopy Building 1 secondary)
.DT COVERAGE	W D				2.30 m.	1.8 m (canopy Bidg, 1 and Biog, 3)
		PERMITTED				PROV DEC
	UNDER RM-L35 ZONE	33%			(55 % ON NET
SEM PEN	UNDER C-5 ZONE	50%				
DEN STY	PROPOSED PSR on GRCSS	425229 97/101044.81 sq.ft.		39505.16/9387.37 sq.m.	4.21	on GROSS
	PROPOSED ISR on NET	425229 97/89305.55 sc ft.		39505.16/8296.85 sq.m.	4.76	on NET
	PROPOSED COMMERCIAL FAR ON GROSS EROPOSED COMMERCIAL FAR ON MET	19874.00/101044.81 sc.ft.		1845 35/9387.37 sq.m.	0.20	on GROSS
	FROPOSED COMMERCIAL FAR ON NET FROPOSED RESIDENT AL FAR ON GROSS	19874.00/89306.55 sq.ft. 405355 4/101044.81 sq.ft.		1845 35/8295.85 sq.m. 37658.75/9387.37 sq.m.	5.22 4.01	on NET on GRO65
	PROPOSED RESIDENT AL FAR ON NET	405355 4/89306.55 sq.4.		37658.75/8296.85 sq.m.	4.54	on NET
OUTDOOR AMENITY:						PROV DEC
	REQUIRED \$1.9 units X 3 sc m.	REQUIRED 16,759.41 sq.fr.	1557.00 sc m.	BUILDING A CUTDOOR AMENITY	2,547.18 sq.ft.	
	anna anna ar a 36 Mb		4527.9G 36.FM.	BUILDING & CUTDOOR AVENITY	2,623.40 sq.ft.	236,64 sq m. 187,70 sq m.
	10 Micro units X 4 sq.m.	430.56 sq.ft.	40.00 sc.m.	BUILDING CIGUTDOOR AMENITY	3,754.61 sq.ft.	348.81 sq тг.
	TOTAL OUTDOOR AMENITY	17,189.96 sq.ft.	4507.00	CENTRAL OUTDOOR AMENITY	11,585.24 sq.ft. 19,907.43 sq.ft.	1076.30 sc m.
NDOOR AMENITY	TOTAL COIDODR AMENITY	17,189.96 sq.R.	1597.00 sq.m.		19,907.43 sq.m.	1849.45 sc. m
		REQUIRED				FROV DEC
	557 sq.m. (186 units) + 1 sq.m. per unit @ 333units	9,795.16 sq.ft.	910,00 sq m.	BUILDING A INDOOR AMENITY	1,734.00 sq.ft.	161.09 sq m.
	10 Micro units X 4 sq.m.	430.56 sq.ft.	40.00 sq.m.	BUILDING BINDOOR AMENTY BUILDING CINDOOR AMENTY	4,527.59 sq.H. 4,018.71 sq.ft.	420,53 sq m. 373,35 sq m.
	TOTAL INDOOR AMENITY	10,225.71 sq.ft.	950.00 sq.m.	BUILDING CINDOGRAMENTI	10,280.30 sq.ft.	955.07 sqm.
COMMERCIAL						
	Caulin					PROVIDED
	CRU [0] CRU [0]					
	CRU 102 CRU 103				1,932.00 sq.ft. 1,195.00 sq.ft. 1,084.00 sq.ft.	PROVIDED 179.49 sq m. 111.02 sq m. 100.71 sq m.
BUILDING 1	CRU 103 CRU 103				1,932.60 sq.ft. 1,195.60 sq.ft. 1,684.60 sq.ft. 1,228.60 sq.ft.	FROV DEC 179,49 sq m. 111,02 sq m. 111,02 sq m. 100,71 sq m. 114,08 sq m.
BUILDING 1	CRU 102 CRU 104 CRU 106 CRU 106				1,932.60 sq.ft. 1,195.60 sq.ft. 1,686.60 sq.ft. 1,228.60 sq.ft. 1,622.60 sq.ft.	FROV DEC 179.49 sq m. 111.02 sq m. 110.02 sq m. 100.71 sq m. 114.08 sq m. 144.08 sq
BUILDING 1 BUILDING 2	CRU 103 CRU 103 CRU 104 CRU 105 CRU 106 CRU 107				1,932,00 sq.ft. 1,195,00 sq.ft. 1,086,00 sq.ft. 1,228,00 sq.ft. 1,022,00 sq.ft. 1,233,00 sq.ft. 1,339,00 sq.ft.	FROV DEC 179.49 sg m. 111.02 sg m. 100.71 sg m. 114.08 sg m. 64.95 sg.m. 111.75 sg m. 129.14 sg m.
BUILDING 1 BUILDING 2	CRU 100 CRU 100 CRU 100 CRU 106 CRU 106 CRU 108 CRU 108				1,932.00 9q.ft. 1,195.00 9q.ft. 1,086.00 9q.ft. 1,022.00 9q.ft. 1,022.00 9q.ft. 1,032.00 9q.ft. 1,393.00 9q.ft. 973.00 9q.ft.	FROV DEC 179.49 50 Th. 151.02 50 Th. 151.02 50 Th. 151.02 50 Th. 150.71 50 Th. 151.02
IUILDING 1 IUILDING 2	CRU 103 CRU 103 CRU 104 CRU 105 CRU 105 CRU 107 CRU 108 CRU 108				1,932.00 9a,fr. 1,195.00 9a,fr. 1,086.00 9a,fr. 1,028.00 9a,fr. 1,022.00 9a,fr. 1,023.00 9a,fr. 1,293.00 9a,fr. 1,393.00 9a,fr. 1,038.00 9a,fr. 1,038.00 9a,fr.	FROV DEC 179.43 sq m. 11102 sq m. 11102 sq m. 11102 sq m. 11027 sq m. 11408 sq m. 11408 sq m. 11176 sq m. 11176 sq m. 11914 sq
IUILDING 1 IUILDING 2	CRU 100 CRU 10				1,932,00 94ft. 1,195,00 94ft. 1,684,00 94ft. 1,223,00 94ft. 1,222,00 94ft. 1,233,00 94ft. 1,033,00 94ft. 1,633,00 94ft.	FROV DEC 179-49 sg m. 51102 sg m. 100271 sg m. 14540 sg m. 14540 sg m. 117-5 sg m. 129-14 sg m. 64.38 sg m. 64.38 sg m. 64.38 sg m. 64.38 sg m. 64.38 sg m.
BUILDING 1 BUILDING 2	CRU 1001 CRU 1001 CRU 1005 CRU 1005 CRU 1005 CRU 1006				1,532,00 pdf. 1,195,00 pdf. 1,195,00 pdf. 1,195,00 pdf. 1,223,00 pdf. 1,223,00 pdf. 1,233,00 pdf. 1,933,00 pdf. 1,933,00 pdf. 1,633,00 pdf. 1,633,00 pdf. 1,633,00 pdf. 1,165,00 pdf. 1,165,00 pdf. 1,165,00 pdf.	FROUDEC 179.49 sq m. 511.02 sq m. 502.73 sq m. 134.08 sq m. 121.176 sq m. 121.176 sq m. 503.93 sq m. 503.93 sq m. 503.93 sq m. 503.93 sq m. 103.73 sq m. 103.73 sq m.
IUILDING 1 IUILDING 2	CRU 1001 CRU 1001 CRU 1001 CRU 1005 CRU 1006 CRU				1,532,00 3g ft. 1,155,00 3g ft. 1,155,00 3g ft. 1,086,00 3g ft. 1,232,00 3g ft. 1,232,00 3g ft. 1,232,00 3g ft. 1,332,00 3g ft. 1,532,00 3g ft. 1,633,00 3g ft. 1,633,00 3g ft. 1,653,00 3g ft. 1,655,00 3g ft. 1,855,00 3g ft. 1,855,00 3g ft. 1,855,00 3g ft.	FROV DEC 179.43 5q m. 11102 5q m. 11103 5q m. 11103 5q m. 11105 5q m. 1105 5
BUILDING 1 BUILDING 2	CRU 100 CRU 10				1,932,00 agf; 1,195,00 agf; 1,084,00 agf; 1,084,00 agf; 1,022,00 agf; 1,032,00 agf; 1,032,00 agf; 1,032,00 agf; 1,034,00 agf; 1,035,00 agf; 1,035,00 agf; 1,035,00 agf; 1,035,00 agf; 1,035,00 agf; 1,035,00 agf; 1,035,00 agf; 1,035,00 agf;	FROV DEC 179.49 sq m. 1110.2 sq m. 1110.2 sq m. 1110.2 sq m. 1140.8 sq m. 1140.8 sq m. 1140.8 sq m. 1141.7 sq m. 1141.7 sq m. 119.14 sq m. 119.14 sq m. 119.14 sq m. 119.14 sq m. 117.6 sq q m. 117.6
BUILDING 1 BUILDING 2	CRU 103 CRU 103 CRU 103 CRU 105 CRU 105 CRU 106 CRU 106 CRU 106 CRU 107 CRU 106 CRU 105 CRU 10				1,932,00 34 ft. 1,195,00 34 ft. 1,195,00 34 ft. 1,128,00 34 ft. 1,123,00 34 ft. 1,233,00 34 ft. 1,333,00 34 ft. 1,333,00 34 ft. 1,135,00 34 ft.	FROV DEC 179,43 to m. 11102 to m. 11408 to m. 119,14 to m. 119,14 to m. 119,14 to m. 119,14 to m. 1103,14 to m. 113,14 to m
IULDING 1 IULDING 2 IULDING 3	CRU 1001 CRU 1001 CRU 1001 CRU 1006 CRU 1006 CRU 1006 CRU 1008 CRU 1009 CRU 1009 CRU 1010 CRU 1010 CRU 1011 CRU 1012 CRU 1012 CRU 1013 CRU 1014 CRU 1015				1,932.00 sq.ft. 1,155.00 sq.ft. 1,155.00 sq.ft. 1,084.00 sq.ft. 1,023.00 sq.ft. 1,223.00 sq.ft. 1,233.00 sq.ft. 1,333.00 sq.ft. 1,033.00 sq.ft. 1,165.00 sq.ft. 1,165.00 sq.ft. 1,255.00 sq.ft. 1,155.00 sq.ft. 1,155.00 sq.ft. 1,155.00 sq.ft. 1,155.00 sq.ft. 1,155.00 sq.ft.	FROV DEC 179-69 top m. 110-20
JULDING 1 JULDING 2 SUILDING 3	CRU 103 CRU 103 CRU 103 CRU 105 CRU 105 CRU 106 CRU 106 CRU 106 CRU 107 CRU 106 CRU 105 CRU 10				1,932.00 34 ft. 1,195.00 34 ft. 1,195.00 34 ft. 1,283.00 34 ft. 1,283.00 34 ft. 1,283.00 34 ft. 1,283.00 34 ft. 1,933.00 34 ft. 1,683.00 34 ft. 1,683.00 34 ft. 1,683.00 34 ft. 1,165.00 34 ft. 1,165.00 34 ft. 1,165.00 34 ft. 1,195.00 34 ft. 1,195.00 34 ft. 1,953.00 34 ft. 1,953.00 34 ft. 1,953.00 34 ft.	FROV DEC 179.43 tq m. 111.02 tq m. 111.02 tq m. 100.71 tg m. 114.08 tq m. 154.95 tq.m. 1117.5 tg m. 119.14 tg m. 156.33 tq.m. 156.43 tq.m. 156.53 tq.m. 117.62 tq m. 152.37 tq.m. 152.37 tq.m. 152.37 tq.m. 152.38 tq.m. 152.38 tq.m. 152.38 tq.m. 152.38 tq.m. 152.38 tq.m. 152.38 tq.m. 153.48 tq.m. 153.14 tq.m. 153.14 tq.m. 153.14 tq.m. 153.14 tq.m.
BUILDING 1 BUILDING 2 BUILDING 3 DEF-STREET PARKING	CRU 100 CRU 101 CRU 10	3 car est 100 s.p.			1,932,00 sq.ft. 1,195,00 sq.ft. 1,195,00 sq.ft. 1,085,00 sq.ft. 1,023,00 sq.ft. 1,023,00 sq.ft. 1,233,00 sq.ft. 1,233,00 sq.ft. 1,333,00 sq.ft. 1,033,00 sq.ft. 1,165,00 sq.ft. 1,165,00 sq.ft. 1,165,00 sq.ft. 1,165,00 sq.ft. 1,195,00 sq.ft. 1,955,00 sq.ft. 1,955,00 sq.ft. 1,955,00 sq.ft.	FEOV DEC 179-69 to m
DULDING 1 DULDING 2 DIFF STREET PARKING DOWN STRIAL AREA 2004 AREA 2004 AREA	CRU 1001 CRU 1001 CRU 1005 CRU 1005 CRU 1005 CRU 1006 CRU 1010 CRU 1011 CRU 1012 CRU 1012 CRU 1015 CRU 10	3 car per 100 sg.m. 66 BS(\$100 CCT + 4 FOR STAFF			1,532,00 54 ft. 1,195,00 54 ft. 1,195,00 54 ft. 1,286,00 54 ft. 1,282,00 54 ft. 1,283,00 54 ft. 1,933,00 54 ft. 1,933,00 54 ft. 1,933,00 54 ft. 1,653,00 54 ft. 1,653,00 54 ft. 1,165,00 54 ft. 1,953,00 54 ft	FROV DEC 179.49 tg m. 51107 tg m. 51007 tg m. 10027 tg m. 124.08 tg m. 144.08 tg m. 121.75 tg m. 129.14 tg m. 150.37 tg
JULDING 1 JULDING 2 JULDING 3 OFF STREET PARKING COVERDIA, AREA 27CARE FOR ROSINS	CRU 1001 CRU 1001 CRU 1005 CRU 1005 CRU 1005 CRU 1006 CRU 1010 CRU 1011 CRU 1012 CRU 1012 CRU 1015 CRU 10				1,532.00 3g ft. 1,155.00 3g ft. 1,155.00 3g ft. 1,086.00 3g ft. 1,223.00 3g ft. 1,223.00 3g ft. 1,223.00 3g ft. 1,233.00 3g ft. 1,233.00 3g ft. 1,233.00 3g ft. 1,053.00 3g ft. 1,053.00 3g ft. 1,055.00 3g ft. 1,055.00 3g ft. 1,155.00 3g ft. 1,233.00 3g ft	FROV DEC 179.49 tg m. 51107 tg m. 51007 tg m. 10027 tg m. 124.08 tg m. 144.08 tg m. 121.75 tg m. 129.14 tg m. 150.37 tg
JULDING 1 JULDING 2 JULDING 3 JULDING 3 JULDING 3 JOHN STREET PARKING JOHN STREET PARKI	CRU 1001 CRU 1001 CRU 1005 CRU 1005 CRU 1005 CRU 1006 CRU 1010 CRU 1011 CRU 1012 CRU 1012 CRU 1015 CRU 10				1,532,00 54 ft. 1,195,00 54 ft. 1,195,00 54 ft. 1,286,00 54 ft. 1,282,00 54 ft. 1,283,00 54 ft. 1,933,00 54 ft. 1,933,00 54 ft. 1,933,00 54 ft. 1,653,00 54 ft. 1,653,00 54 ft. 1,165,00 54 ft. 1,953,00 54 ft	FROV DEC 179-69 tg m. 11102 tg m. 120271 tg m. 120408 tg m. 124-68 tg m. 121-75 tg m. 129-16 tg m. 129-16 tg m. 150-37 tg m. 138-68 tg m.
JULDING 1 JULDING 2 JULDING 3 JULDING 3 JULDING 3 JOHN STREET PARKING JOHN STREET PARKI	CRU 1001 CRU 1001 CRU 1005 CRU 1005 CRU 1005 CRU 1006 CRU 1010 CRU 1011 CRU 1012 CRU 1012 CRU 1015 CRU 10				1,532,00 59 ft. 1,195,00 59 ft. 1,195,00 59 ft. 1,195,00 59 ft. 1,293,00 59 ft. 1,293,00 59 ft. 1,293,00 59 ft. 1,933,00 59 ft. 1,933,00 59 ft. 1,193,00 59 ft. 1,195,00 59 ft	FROV DEC 179.49 to m. 179.49 to m. 171.02 to m. 171.02 to m. 170.07 to m. 171.05 to m. 171.05 to m. 170.07 to
JULDING 1 JULDING 2 JULDING 3 JOHN STREET PARKING JOHN VERDIA, AREA JOYCARE PICE, AREA JOYCARE RICK,	CRU 100 CRU 101 CRU 10				1,632_CO 5q.ft.	FROV DEC 179-49 sg m. 11102 sg m. 12102 sg m. 124-08 sg m. 124-08 sg m. 121-75 sg m. 129-15 sg m. 129-15 sg m. 129-15 sg m. 129-15 sg m. 128-32 sg m. 117-32 sg m. 117-32 sg m. 128-32 sg m. 117-32 sg m. 128-32 sg m. 128-32 sg m. 138-38 sg m. 138-48 sg m. 138-48 sg m. 138-48 sg m. 138-48 sg m. 138-58 sg m. 148-58 sg m. 158-58 sg m.
JULDING 1 JULDING 2 JULDING 3 JOHN STREET PARKING JOHN VERDIA, AREA JOYCARE PICE, AREA JOYCARE RICK,	CRU 100 CRU 101 CRU 10				1,532,00 59 ft. 1,195,00 59 ft. 1,195,00 59 ft. 1,195,00 59 ft. 1,293,00 59 ft. 1,293,00 59 ft. 1,293,00 59 ft. 1,933,00 59 ft. 1,933,00 59 ft. 1,193,00 59 ft. 1,195,00 59 ft	FROV DEC 179.49 sq m. 11102 sq m. 12102 sq m. 124.08 sq m. 124.08 sq m. 124.08 sq m. 129.14 sq m. 129.14 sq m. 129.14 sq m. 129.14 sq m. 128.32 sq m. 117.67 sq m. 128.32 sq m. 117.67 sq m. 128.48 sq m. 128.48 sq m. 138.48 sq m. 138.58 sq m. 148.59 sq m. 148.59 sq m. 159.59 sq m. 159.59 sq m. 159.59 sq m. 169.59 s
ULDING 1 ULDING 2 ULDING 3 FF STREET PARKING OW VERDIAL AREA SYCARE FOR 80 dies OTAL PARK NO Including shared parking	CRU 100 CRU 101 CRU 10				1,632_CO 5q.ft.	FROV DEC 179.49 sq m. 11102 sq m. 12102 sq m. 124.08 sq m. 124.08 sq m. 124.08 sq m. 129.14 sq m. 129.14 sq m. 129.14 sq m. 129.14 sq m. 128.32 sq m. 117.67 sq m. 128.32 sq m. 117.67 sq m. 128.48 sq m. 128.48 sq m. 138.48 sq m. 138.58 sq m. 148.59 sq m. 148.59 sq m. 159.59 sq m. 159.59 sq m. 159.59 sq m. 169.59 s
ULDING 1 ULDING 2 ULDING 3 DEF STREET PARKING COVERCIAL ARE A. SYCART FOR 40 disk OTAL FARR NO THE Using Shared pasking	CRU 100 CRU 101 CRU 10	6K DS/D1GP CIF + 4 FGR STATE			1,632_CO 5q.ft.	FEOV DEC 179-93 to m. 179-93 to m. 17102 to m. 17102 to m. 170071 to m. 17103 to m. 17
LULDING 1 LULDING 2 DEF STREET PARKING COMMERCIAL AREA SYCARE FOR ROUGH OTAL FARR NO THE Using shared parking ES DENTAL	CRU 100 CRU 101 CRU 10	6 K DŞ(D)GO CIF + 4 FOR STATE REQUIRED			1,632_CO 5q.ft.	FROV DEC 179.49 5q m. 110.02 sq m. 117.69 sq m. 117.69 sq m. 117.69 sq m. 117.60 sq
LULDING 1 LULDING 2 DEF STREET PARKING COMMERCIAL AREA SYCARE FOR ROUGH OTAL FARR NO THE Using shared parking ES DENTAL	CRU 100 CRU 101 CRU	6K DS/DIGO CIF + 4 FOR STAIF REQUIRED 26.45			1,632_CO 5q.ft.	FEGV DEC 179-93 gm. 179-93 gm. 1102 to gm. 1102 to gm. 1202 to gm.
ULLDING 1 ULLDING 2 DEF STREET PARKING COVERCIA, ARE A AVEARE FOR 40 dies OTAL FARK NS including shared parking ES DEBITAL	CRU 100 CRU 101 CRU 10	6 K DŞ(D)GO CIF + 4 FOR STATE REQUIRED			1,632_CO 5q.ft.	FROV DEC 179.43 sq m. 110.23 sq m. 110.23 sq m. 110.23 sq m. 120.27 sq m. 120.27 sq m. 120.27 sq m. 120.27 sq m. 1217.5 sq m. 1219.15 sq m. 12
ULLDING 1 ULLDING 2 DEF STREET PARKING COVERCIA, ARE A AVEARE FOR 40 dies OTAL FARK NS including shared parking ES DEBITAL	CRU 1001 CRU 1005 CRU 1006 CRU 1006 CRU 1006 CRU 1006 CRU 1006 CRU 1009 CRU 1009 CRU 1010 CRU 1010 CRU 1010 CRU 1011 CRU 1011 CRU 1012 CRU 1013 CRU	REQUIRED REQUIRED REQUIRED REQUIRED			1,872.00 sq.fr. 1,952.00 sq.fr. 1,952.00 sq.fr. 1,952.00 sq.fr. 1,232.00 sq.fr. 1,232.00 sq.fr. 1,232.00 sq.fr. 1,233.00 sq.fr. 1,333.00 sq.fr. 1,953.00 sq.fr. 1,95	FROV DEC 179-95 sq m. 1102 sq m. 1102 sq m. 1202 sq m. 1202 sq m. 1202 sq m. 1203 sq m. 1240 sq m. 1240 sq m. 1241 sq m. 1251 sq m. 1251 sq m. 1251 sq m. 1263 sq sq m. 127-67 sq m. 1263 sq sq m. 127-67 sq m. 128-68 sq m.
JULDING 1 JULDING 2 JULDING 3 JOFF STREET PARKING JOHN WERDIAL AREA JOHN AND AND AND AND AND AND AND AND AND AN	CRU 100 CRU 101 CRU	6 K DS/D100 CIF + 4 FGR STATE REQUIRED 26.43 13.725			1,872.00 sq.fr. 1,952.00 sq.fr. 1,952.00 sq.fr. 1,952.00 sq.fr. 1,232.00 sq.fr. 1,232.00 sq.fr. 1,232.00 sq.fr. 1,233.00 sq.fr. 1,333.00 sq.fr. 1,953.00 sq.fr. 1,95	FROV DEC 179-69 5g m. 1100 5g m. 1100 5g m. 1100 5g m. 126-08 5g m. 124-08 5g m. 129-16 5g m. 129-16 5g m. 129-16 5g m. 129-16 5g m. 138-37 5g m. 138-37 5g m. 138-37 5g m. 138-37 5g m. 138-38 5g m. 148-39 5g AG = 51.0 SPAC = 61.0 SPAC
BUILDING 1 BUILDING 2 BUILDING 3 DOFF STREET PARKING DOWN VERDIAL AREA BY CARE FOR BOTH SHARE A BY CARE FOR BOTH SHA	CRU 1001 CRU 1005 CRU 1006 CRU 1006 CRU 1006 CRU 1006 CRU 1006 CRU 1009 CRU 1009 CRU 1010 CRU 1010 CRU 1010 CRU 1011 CRU 1011 CRU 1012 CRU 1013 CRU	REQUIRED REQUIRED 26.45 13.225 REQUIRED = 214.5 %CE	F. M.T.B	NORMS.	1,872.00 sq.fr. 1,952.00 sq.fr. 1,952.00 sq.fr. 1,952.00 sq.fr. 1,232.00 sq.fr. 1,232.00 sq.fr. 1,232.00 sq.fr. 1,233.00 sq.fr. 1,333.00 sq.fr. 1,953.00 sq.fr. 1,95	FROV DEC 179-95 sq m. 1102 sq m. 1102 sq m. 1202 sq m. 1202 sq m. 1202 sq m. 1203 sq m. 1240 sq m. 1240 sq m. 1241 sq m. 1251 sq m. 1251 sq m. 1251 sq m. 1263 sq sq m. 127-67 sq m. 1263 sq sq m. 127-67 sq m. 128-68 sq m.
BUILDING 1 BUILDING 2 BUILDING 3 DOFF STREET PARKING DOWN VERDIAL AREA BY CARE FOR BOTH SHARE A BY CARE FOR BOTH SHA	CRU 105 CRU 105 CRU 105 CRU 106 CRU 106 CRU 107 CRU 107 CRU 108 CRU 108 CRU 108 CRU 108 CRU 108 CRU 108 CRU 101 CRU 111 CRU 111 CRU 112 CRU 113 CRU 113 CRU 114 CRU 115 CRU 11	8 EQUIRED 264 1 4 1 70 8 STATE 8 EQUIRED 26 45 13.225 REQUIRED 27 4 5 %CE	CLASS B ECCMMERC AL = 12	ATGRADE	1,872.00 sq.fr. 1,952.00 sq.fr. 1,952.00 sq.fr. 1,952.00 sq.fr. 1,232.00 sq.fr. 1,232.00 sq.fr. 1,232.00 sq.fr. 1,233.00 sq.fr. 1,333.00 sq.fr. 1,953.00 sq.fr. 1,95	FROV DEC 179.49 50 m. 1102 10 m. 1102 10 m. 120271 10 m. 12498 10 m. 14498 10 m. 1449 10 m. 154 50 10 m. 155 50 10 SPACI 155 50 SPACI 155 50 SPACI 157 50 SPACI 157 50 SPACI 157 50 SPACI 158 50 SPACI 159 50 SPACI 150 SPACI
	CRU 1001 CRU 1005 CRU 1006 CRU 1006 CRU 1006 CRU 1006 CRU 1006 CRU 1009 CRU 1009 CRU 1010 CRU 1010 CRU 1010 CRU 1011 CRU 1011 CRU 1012 CRU 1013 CRU	REQUIRED REQUIRED 26.45 13.225 REQUIRED = 214.5 %CE	CLASS B ECCMMERC AL = 12 FES IS	6 PER BUILDING = 18	1.532.00 54ft. 1.155.00 54ft. 1.155.00 54ft. 1.155.00 54ft. 1.223.00 54ft. 1.223.00 54ft. 1.223.00 54ft. 1.235.00 54ft. 1.235.	FROV DEC 179-69 5g m. 110-2 kg m. 110-2 kg m. 120-27 kg m. 120-27 kg m. 120-28 k



Unit 209-6321 King George Blvd Surrey BC, V3X 1G1 www.flatarchitecture.ca contact@flatarchitecture.ca Ph: 604-503-4484

PROJECT INFO:
PROPOSED MIXED-USE DEVELOPMENT
AT 160 STREET & 84 AVENUE, SURREY, BC

CLIENT: PLATINUM GROUP LTD.

20-224

SCALE: DRAWN BY:
A.R.C.

PROJECT DATA - SITE

UNIT MIX SCHEDULE	BUILDING 1											
LEVELS	STUDIO	1 BD	1 BD+DEN	2 BD	2 BD + DEN	3 BD	INDOOR AMENITY (sq.ft.)	RETAIL (sq.ft.)	DAY CARE (sq.ft.)	TOTAL AREA (sq.ft.) WITHOUT AMENITY	TOTAL UNITS	
LVL P1		1		2	7					13684.44	10	
LVL 1		2	4	14			1116	5439		22872.13	20	
LVL 2	1	2	10	15	1	1				22258.87	30	
LVL 3	1	2	10	15	1	1				22258.87	30	
LVL 4	1	2	10	15	1	1				22258.87	30	
LVL 5	1	2	10	15	1	1				22258.87	30	
LVL 6	1	1	6	1	1	1				8985.18	11	
TOTAL	5 UNITS	12 UNITS	50 UNITS	77 UNITS	12 UN TS	5 UNITS	1116	5439		134577.23	161	

UNIT MIX SCHEDULE		BUILDING 2												
LEVELS	STUDIO	1 BD	1 BD+DEN	2 BD	2 BD + DEN	38D	INDOOR AMENITY (sq.ft.)	RETAIL (sq.ft.)	DAY CARE (sq.ft.)	TOTAL AREA (sq.ft.) WITHOUT AMENITY	TOTAL UNITS			
LVL P1		1	3					2225.57		7086.13	4			
LVL 1	1		4				4527.59	1390		8560.01	5			
LVL 2	1		8	2		1				8486.48	12			
LVL 3	1		8	1		2				8486.48	12			
LVL 4	1		8	1		2				8486.48	12			
LVL 5	1		8	1		2				8486.48	12			
TOTAL	5 UNITS	1 UNITS	39 UNITS	5 UNITS	0 UNITS	7 UNITS	4527.59	3615.57		49592.06	57			

UNIT MIX					BUILD	ING 3 - MIX	USE- COMMERCIAL /	RESIDENTIAL TOWE	R		
LEVELS		1 BD	1 BD+DEN	2 BD	2 BD + DEN	3BD	INDOOR AMENITY (sq.ft.)	RETAIL (sq.ft.)	DAY CARE (sq.ft.)	TOTAL AREA (sq.ft.) WITHOUT AMENITY	TOTAL UNITS
LVL 1							2522.71	8867	1953	13842.45	0
LVL 2		3	8	2	3					12812.23	16
LVL 3		3	8	2	3					12812.23	16
LVL 4		3	8	2	3					12812.23	15
LVL 5		3	8	2	3					12812.23	16
LVL 6		3	8	2	3					12812.23	15
LVL 7		1	4		2		1468			5741.87	7
LVL 8		2	4		4					7262.58	10
LVL 9		2	4		4					7262.58	10
LVL 10		2	4		4					7262.58	10
LVL 11		2	4		4					7262.58	10
LVL 12		2	4		4					7262.58	10
LVL 13		2	4		4					7262.58	10
LVL 14		2	4		4					7262.58	10
LVL 15		2	4		4					7262.58	10
LVL 16		2	4		4					7262.58	10
LVL 17		2	4		4					7262.58	10
LVL 18		2	4		4					7262.58	10
LVL 19		2	4		4					7262.58	10
LVL 20		2	4		4					7262.58	10
LVL 21		2	4		4					7262.58	10
LVL 22		2	4		4					7262.58	10
LVL 23		2	4		4					7262.58	10
LVL 24		2	4		4					7262.58	10
LVL 25		10								5866.22	10
LVL 26		10								5866.22	10
LVL 27		10								5866.22	10
LVL 28		10								5866.22	10
LVL 29		10								5866.22	10
LVL 30						4				4620.25	4
TOTAL		100 UNITS	112 UNITS	10 UNITS	85 UNITS	4 UNITS	3990.7 1	8867	1953	241060.68	311
							9,634.30 Sq.Ft.	17,921.57 Sq.Ft.	1,953.00 Sq.Ft.	425,229.97 Sq.Ft.	529 UNITS
	10 UNITS	113 UNITS	201 UNITS	92 UNITS	97 UNITS	16 UNITS				FSR: 4.21 on GROSS	
	2%	21%	38%	17%	18%	3%					100%




Unit 209-6321 King George Blvd Surrey BC, V3X 1G1 www.flatarchitecture.ca contact@flatarchitecture.ca Ph: 604-503-4484

PROPOSED MIXED-USE DEVELOPMENT
AT 160 STREET & 84 AVENUE, SURREY, BC
CLIENT:
PLATINUM GROUP LTD.

04/07/2024
PROJECT NO:
20-224
SCALE: DRAWN BY:
A.R.C.

PROJECT DATA -BUILDINGS

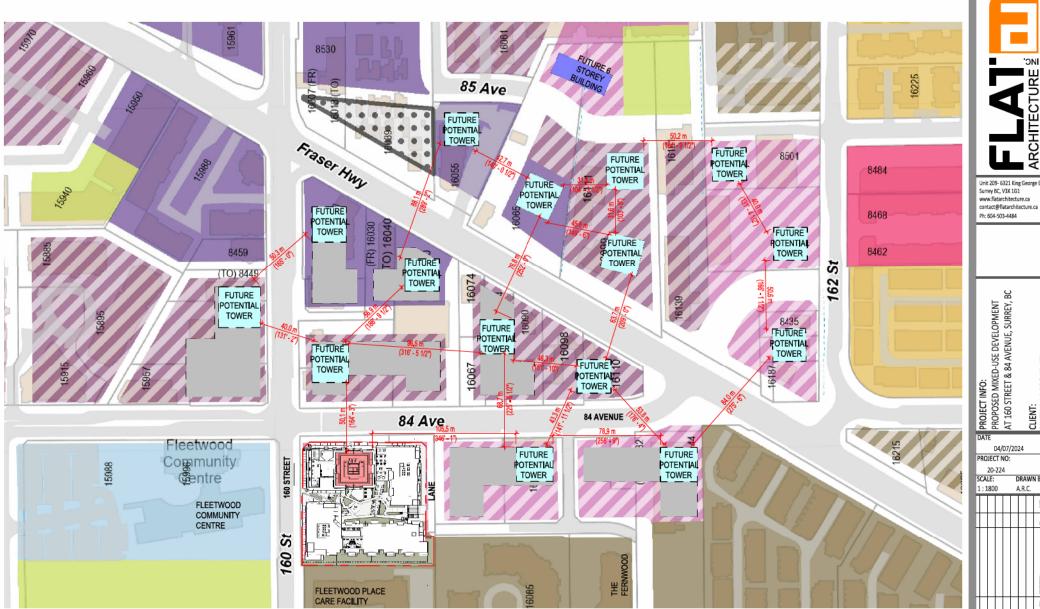




PROJECT INFO: PROPOSED MIXED-USE DEVELOPMENT AT 160 STREET & 84 AVENUE, SURREY, BC

DATE 04/07/2024 PROJECT NO:

20-224 1:1800

A.R.C.

CONCEPTUAL TOWER SEPARATION PLAN

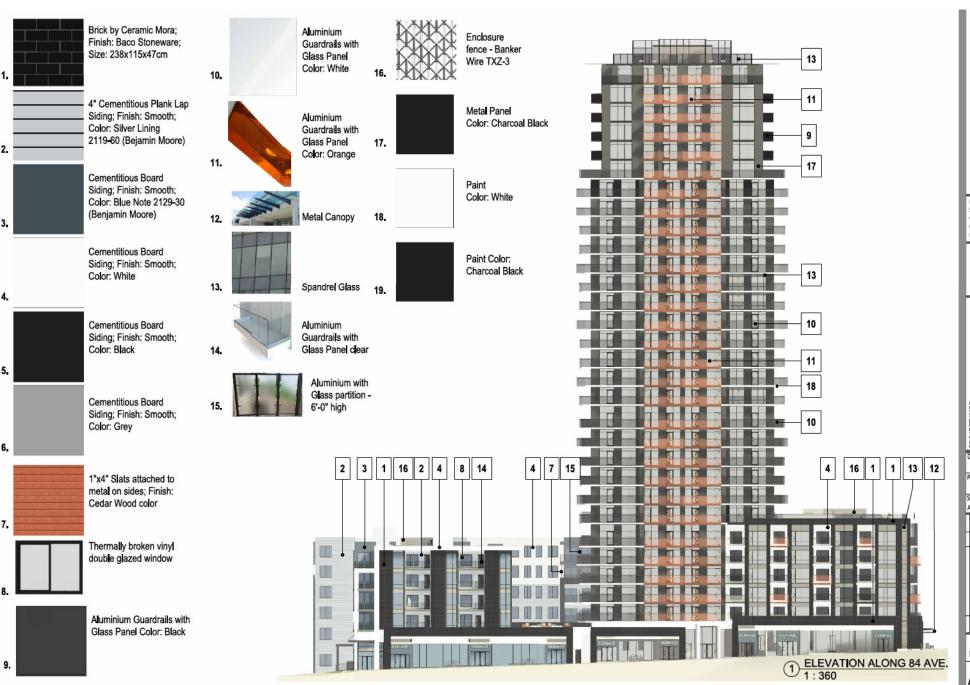



Unit 209- 6321 King George Blvd Surrey BC, V3X 1G1 www.flatarchitecture.ca contact@flatarchitecture.ca Ph: 604-503-4484

PROJECT INFO: PROPOSED MIXED-USE DEVELOPMENT AT 160 STREET & 84 AVENUE, SURREY, BC

DATE
04/07/2024
PROJECT NO:
20-224
SCALE: DRAWN BY:
As indicated A.R.C.

MATERIALS



ARCHITECTURE INC.

Unit 209-6321 King George Blvd Surrey BC, V3X 1G1 www.flatarchitecture.ca contact@flatarchitecture.ca Ph: 604-503-4484

> PROPOSED MIXED-USE DEVELOPMENT AT 160 STREET & 84 AVENUE, SURREY, BC

04/07/2024 PROJECT NO: 20-224

20-224 SCALE: DRAWN E A.R.C.



OVERALL VIEWS







Unit 209- 6321 King George Blvd Surrey BC, V3X 161 www.flatarchitecture.ca contact @flatarchitecture.ca Ph: 604-503-4484

PROJECT INFO: PROPOSED MIXED-USE DEVELOPMENT AT 160 STREET & 84 AVENUE, SURREY, BC

04/07/2024 PROJECT NO: 20-224

20-224
SCALE: DRAWN BY:
A.R.C.

IV as NUMBERS

OVERALL VIEWS





OVERALL VIEWS


04/07/2024 PROJECT NO: 20-224 SCALE:

Unit 209-6321 King George Blvd Surrey BC, V3X 161 www.flatarchitecture.ca contact@flatarchitecture.ca Ph: 604-503-4484

A 063

VIEW FROM 84 AVE



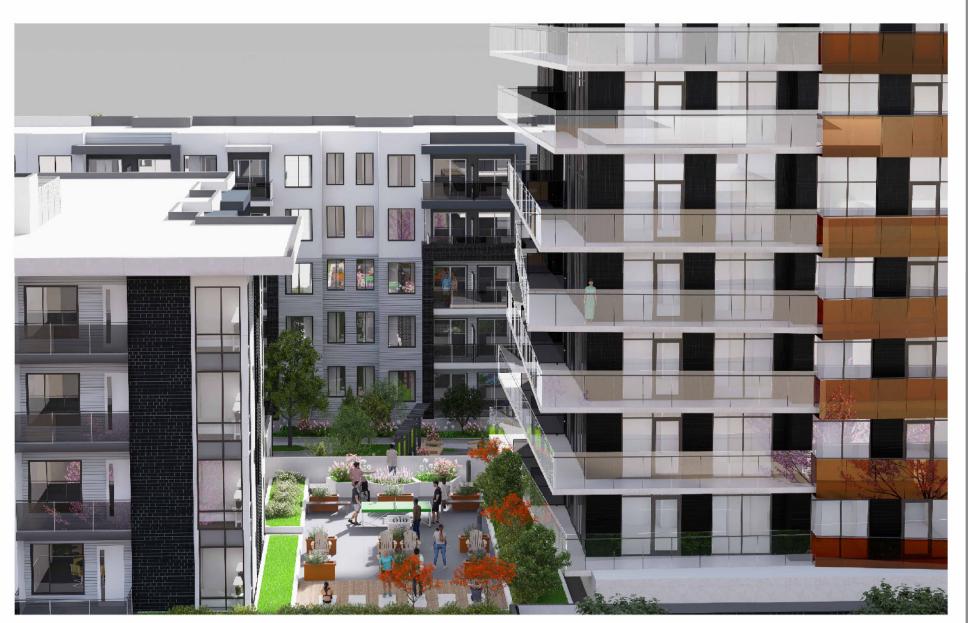



Unit 209-6321 King George Blvd Surrey BC, V3X 1G1 www.flatarchitecture.ca contact@flatarchitecture.ca Ph: 604-503-4484


PROJECT INFO: PROPOSED MIXED-USE DEVELOPMENT AT 160 STREET & 84 AVENUE, SURREY, BC

DATE 04/07/2024 PROJECT NO:

20-224 SCALE: DR

ALE: DRAWN BY:
A.R.C.

OVERALL VIEWS

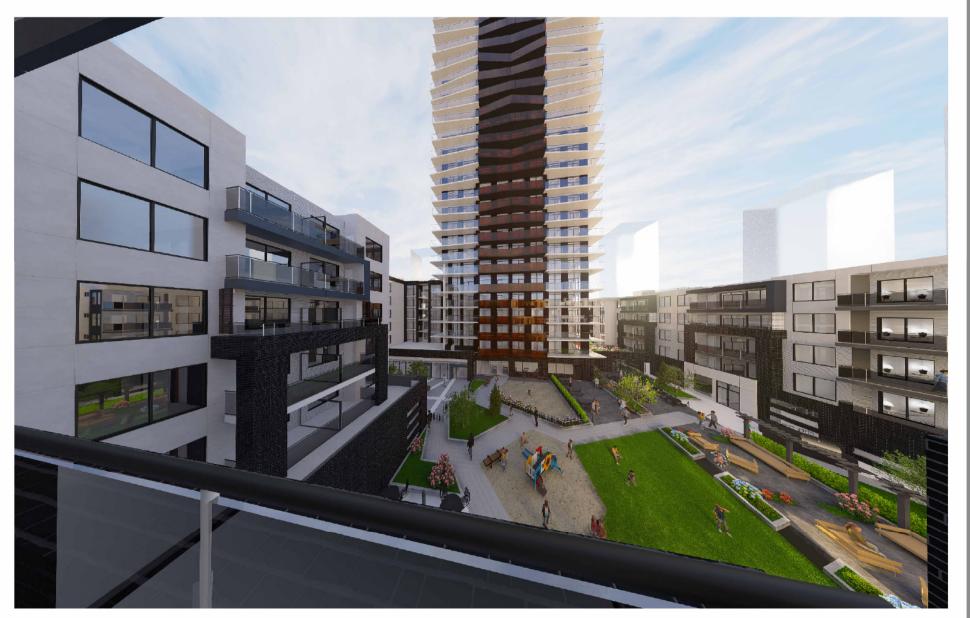





Unit 209- 6321 King George Blvd Surrey BC, V3X IG1 www.flatarchitecture.ca contact@flatarchitecture.ca Ph: 604-503-4484

PROPOSED MIXED-USE DEVELOPMENT
PROPOSED MIXED-USE DEVELOPMENT
AT 160 STREET & 84 AVENUE, SURREY, BC

04/07/2024

PROJECT NO:
20-224

SCALE: DRAWN BY:
A.R.C.

A.R.C.

OVERALL VIEWS






Unit 209- 6321 King George Blvd Surrey BC, V3X IG1 www.flatarchitecture.ca contact@flatarchitecture.ca Ph: 604-503-4484

PROPOSED MIXED-USE DEVELOPMENT
PROPOSED MIXED-USE DEVELOPMENT
AT 160 STREET & 84 AVENUE, SURREY, BC

04/07/2024
PROJECT NO:
20-224
SCALE: DRAN

OVERALL VIEWS

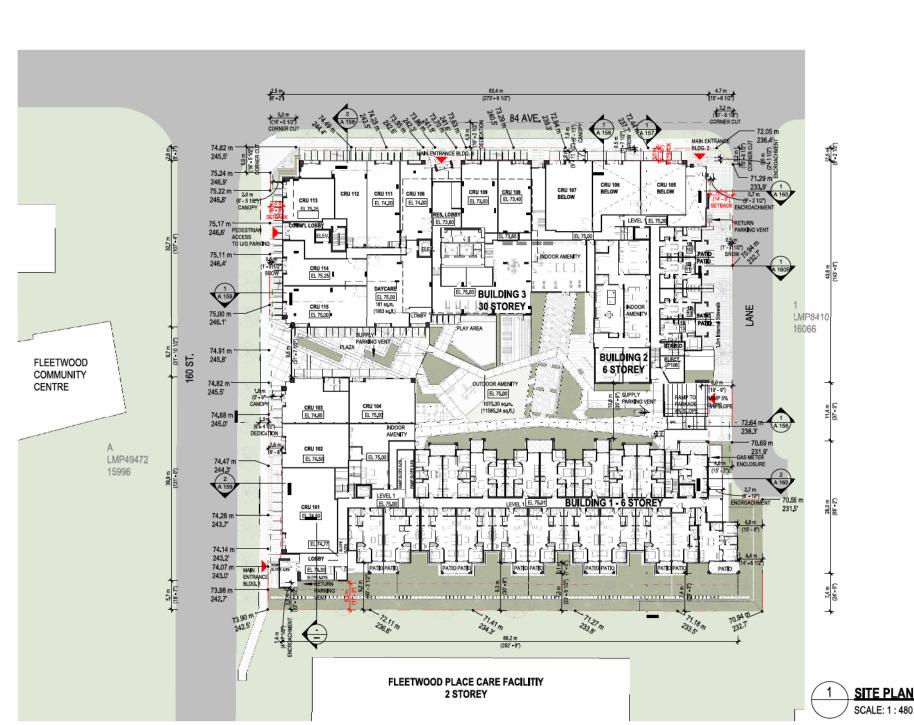





Unit 209-6321 King George Blw Surrey BC, V3X 1G1 www.flatarchitecture.ca contact@flatarchitecture.ca Ph: 604-503-4484

PROJECT INFO: PROPOSED MIXED-USE DEVELOPMENT AT 160 STREET & 84 AVENUE, SURREY, BC


20-224
SCALE: DRAWN BY:
1: 480 A.R.C.

SITE PLAN

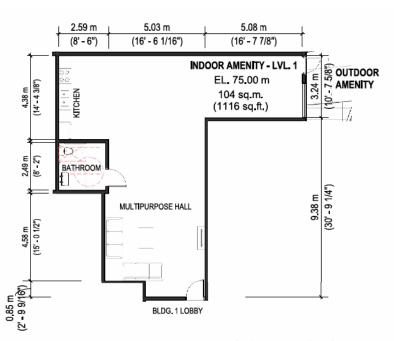

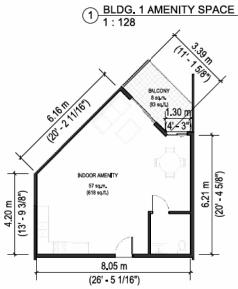

2 BLDG. 1 LEVEL 6 AMENITY SPACE 1:128

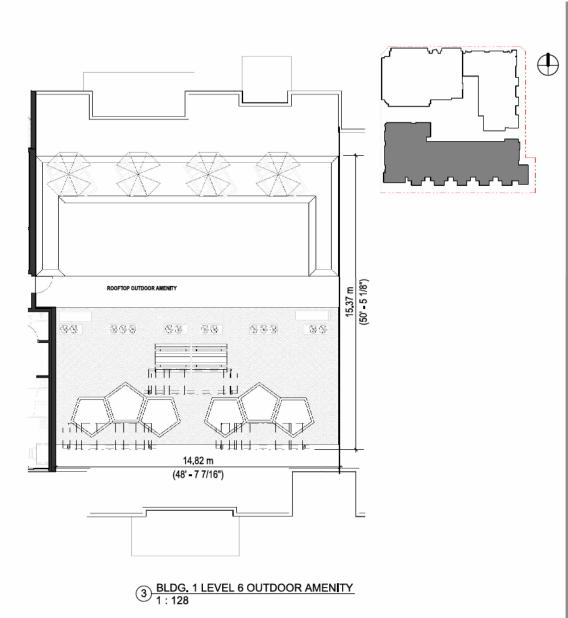


Unit 209- 6321 King George Blvd Surrey BC, V3X 1G1 www.flatarchitecture.ca contact@flatarchitecture.ca Ph: 604-503-4484

PROJECT INFO: PROPOSED MIXED-USE DEVELOPMENT AT 160 STREET & 84 AVENUE, SURREY, BC

04/07/2024 PROJECT NO:

SCALE: DRAWN BY: As indicated A.R.C.

BLDG. 1 AMENITY SPACE

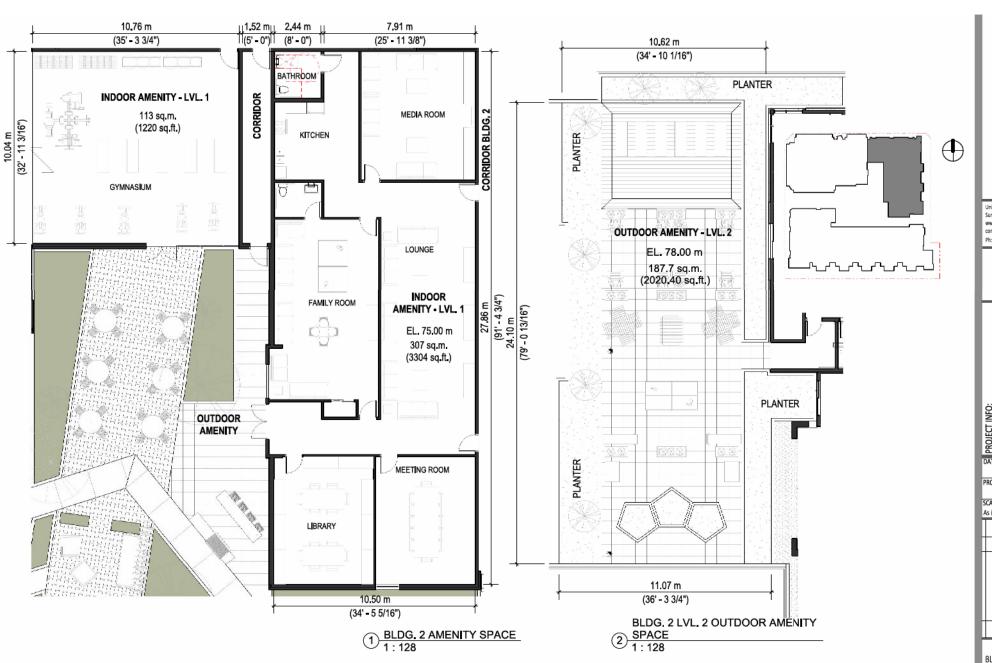




Unit 209- 6321 King George Blvd Surrey BC, V3X 1G1 www.flatarchitecture.ca contact@flatarchitecture.ca Ph: 604-503-4484

PROJECT INFO:
PROPOSED MIXED-USE DEVELOPMENT
AT 160 STREET & 84 AVENUE, SURREY, BC

04/07/2024
PROJECT NO:
20-224
SCALE: DRAWN BY
As indicated A.R.C.



BLDG. 2 AMENITY
SPACES
A 151

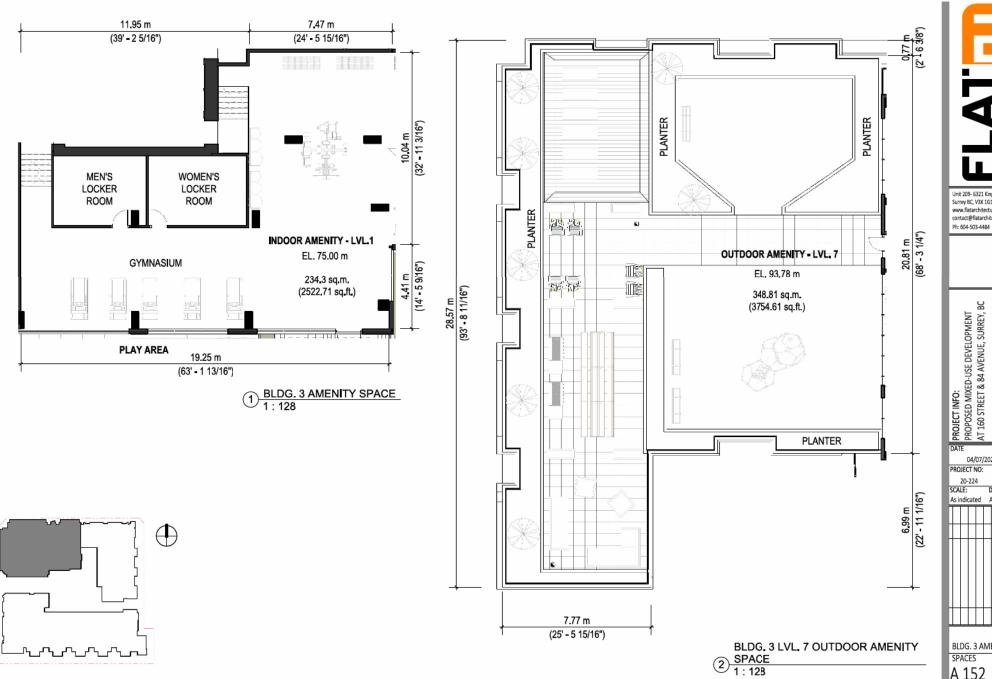




PROJECT INFO: PROPOSED MIXED-USE DEVELOPMENT AT 160 STREET & 84 AVENUE, SURREY, BC


04/07/2024 PROJECT NO:

20-224 SCALE:

As indicated A.R.C.


BLDG. 3 AMENITY SPACES

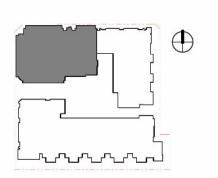

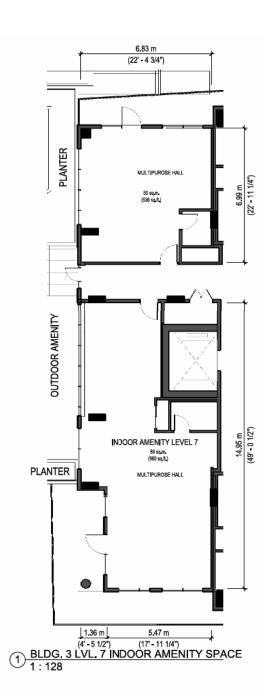



BLDG. 3 AMENITY
SPACES
A 152B

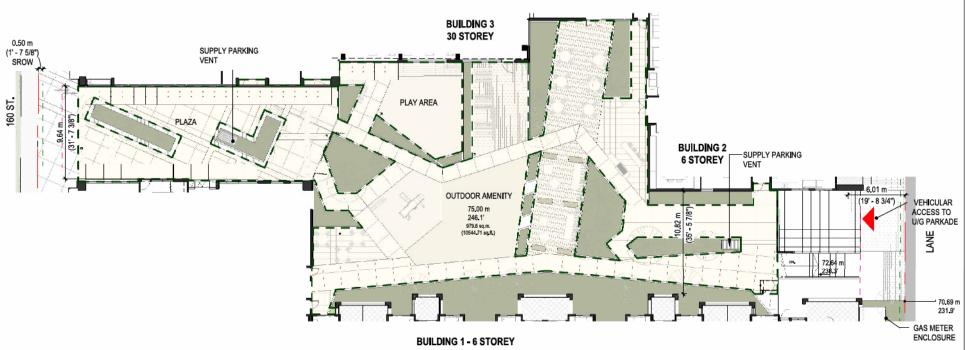


① OUTDOOR AMENITY SPACE 1:256



PROJECT INFO: PROPOSED MIXED-USE DEVELOPMENT AT 160 STREET & 84 AVENUE, SURREY, BC

CLIENT: PLATINUM GROUP LTD. DATE 04/07/2024 PROJECT NO: 20-224 SCALE: A.R.C. 1:256

OUTDOOR AMENITY AREA

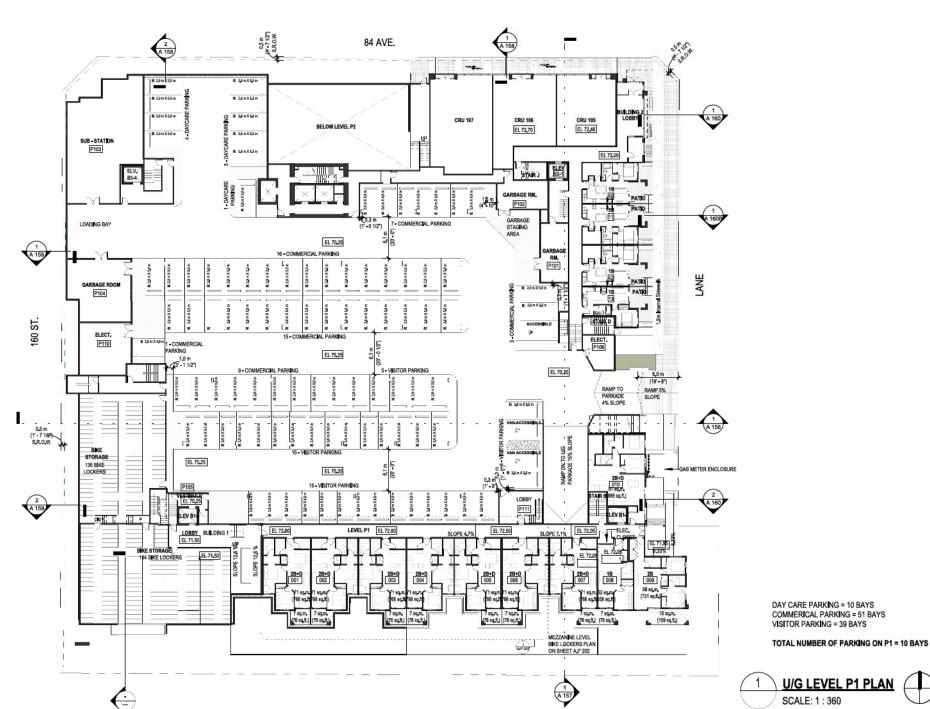



Unit 209- 6321 King George Blvd Surrey BC, V3X 1G1 www.flatarchitecture.ca contact@flatarchitecture.ca Ph: 604-503-4484

PROJECT INFO: PROPOSED MIXED-USE DEVELOPMENT AT 160 STREET & 84 AVENUE, SURREY, BC


04/07/2024 PROJECT NO:

1:360 A.R.C.

U/G PARKADE P1

A.P 201

U/G LEVEL P1 PLAN SCALE: 1:360

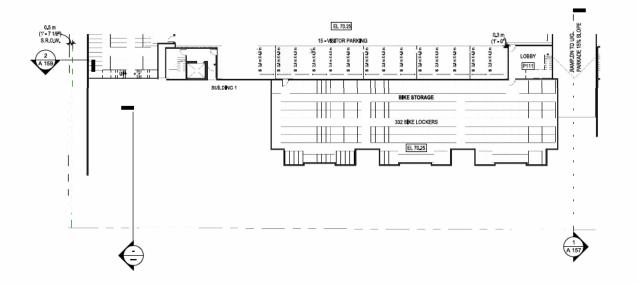

 $\underbrace{1 \underbrace{\text{ MEZZANINE LEVEL BIKE STORAGE}}_{1:360}}$




Unit 209- 6321 King George Blvd Surrey BC, V3X 161 www.flatarchitecture.ca contact @flatarchitecture.ca Ph: 604-503-4484

PROJECT INFO: PROPOSED MIXED-USE DEVELOPMENT AT 160 STREET & 84 AVENUE, SURREY, BC

CLIENT: PLATINUM GROUP LTD. DATE 04/07/2024 PROJECT NO: 20-224 SCALE: 1:360 A.R.C.

U/G PARKADE P1 -MEZZANINE LEVEL



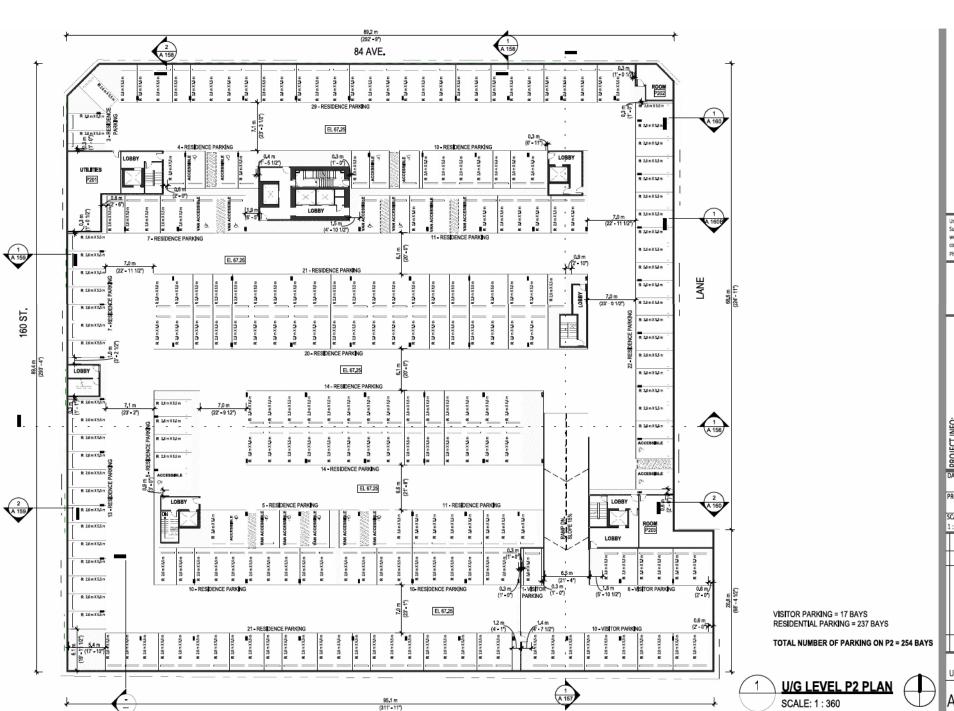



Unit 209- 6321 King George Blvd Surrey BC, V3X 1G1 www.flatarchitecture.ca contact@flatarchitecture.ca Ph: 604-503-4484


PROJECT INFO: PROPOSED MIXED-USE DEVELOPMENT AT 160 STREET & 84 AVENUE, SURREY, BC

04/07/2024 PROJECT NO: 20-224 A.R.C.

1:360

U/G PARKADE P2

A.P 203

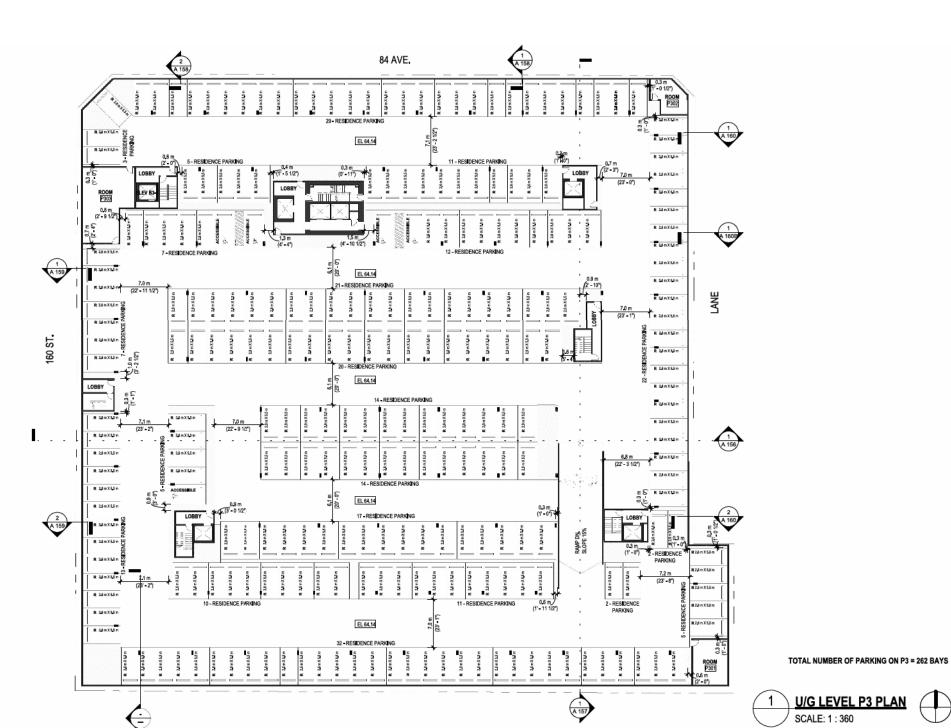



Surrey BC, V3X 1G1 www.flatarchitecture.ca contact@flatarchitecture.ca Ph: 604-503-4484

PROJECT INFO: PROPOSED MIXED-USE DEVELOPMENT AT 160 STREET & 84 AVENUE, SURREY, BC

04/07/2024 PROJECT NO:


20-224


1:360 A.R.C.

U/G PARKADE P3

U/G LEVEL P3 PLAN SCALE: 1:360

A.P 204

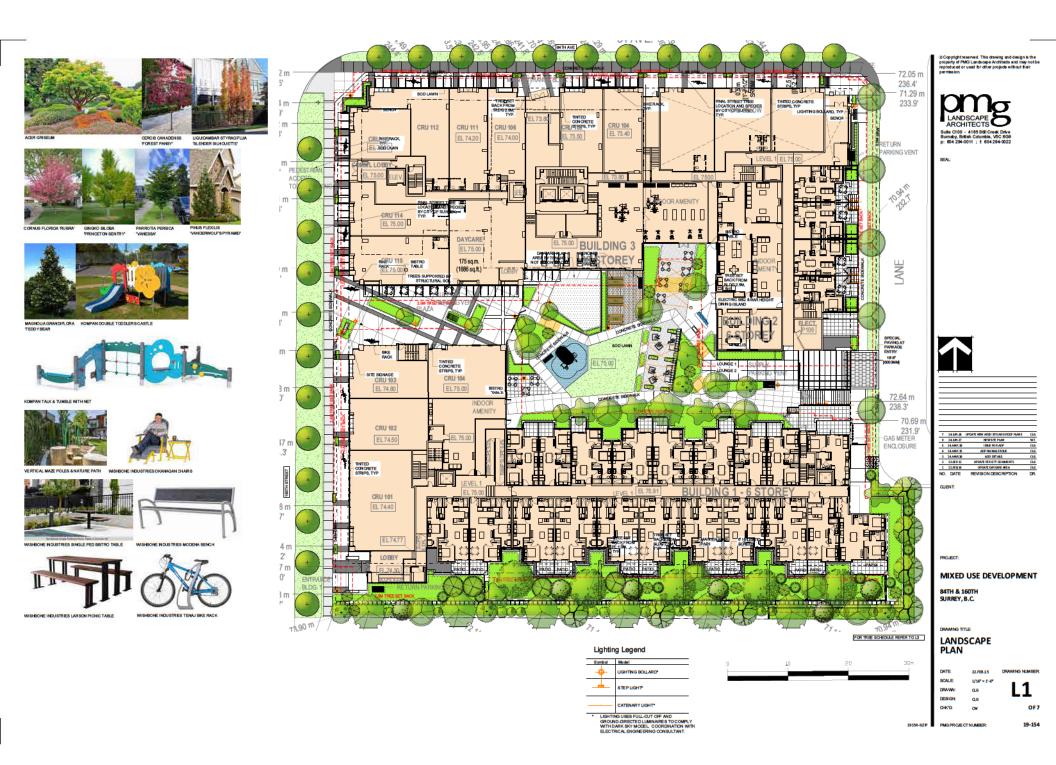

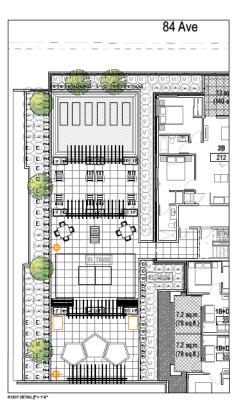

84 Ave



PLANT SCHEDULE - LEVEL 2 PLANTED SIZE / REMARKS COMMON NAME MAGNOLIA TEDDY BEAR RHUS TYPHINA TIGER EYES* TEDDYBEAR SOUTHERN MAGNOLIA CUTLEAF STAGHORN SUMAC 3MHT, B&B, CLIMATE RESILIENT 2MHT: B&B, 3 STEM OR MORE CLIMATE RESILIENT EUONYMUS FORTUNE 'EMERALD GAETY' EMERALD GAETY WINTERCREEPER #8 POT; 50CM; 36" C.C. #2 POT; #0CM; 36" C.C. NATIVE; BIRD FRIENDLY #8 POT; 50CM; 36" C.C. MAHONIA AQUIFOLIUM NANDINA DOMESTICA TIREPOWER OREGON GRAPE FIREPOWER HEAVENLY BAMBOO 23 NAMENIA GOMESTICA 911
 70 9 CALAMARGESTIS ACUITIF
 40 11
 40 11
 40 CALAMAGROSTIS ACUTIFLORA YARL FOERSTER' HAKONECHLOAMACRA YALL GOLD' FEATHER REED GRASS GOLDEN JAPANESE FOREST GRASS #1 POT; 30*0.C. #1 POT; 24*0.C. ALUUM WILLENIUM LAVENDULA ANGUSTIFOLIA WUNSTEAD PEROVSKIA ATRIPLICIFOLIA 'UITLE SPIRE' #I POT; POLLINATOR FRENDLY; 16" O.C. #I POT; 24" O.C.; POLLINATOR FRENDLY 16CM POT; 24" O.C.; 24" O.C.; POLLINATOR FRIENDLY #1 POT; 20CM; 60CM O.C.; NATIVE NOTES: "PLANT SEES IN THIS LIST ARE SPROFED ACCORDING TO THE BIC LAND BOMPE STANDARD AND CAMADIAN LAND BOMPE STANDARD, ACT EST EDITION. CONTINUES SEES SEES FILED APPEAR CHAIR STANDARD, BOTH PLANT SEE AND CHAIRMER SEES." REPER TO SEND CHAIRMER SEES." REPER TO SEND CHAIRMER SEES." REPER TO SEND CHAIRMER SEES. "REPER TO SEND CHAIRMER SEES." REPER TO SEND CHAIRMER SEE

1

KEY PLAN N.T.S



RHUS TYPHINA TIGER EYES'

© Copyright reserved. This drawing and design is the property of PMG Landscape Architects and may not be reproduced or used bridher projects without their permission.



SEAL:



CLIENT:

PROJECT:

MIXED USE DEVELOPMENT

84TH & 160TH SURREY, B.C.


RAWING TITLE


UPPER LEVEL LANDSCAPE PLAN

DATE	22.FEB.15	DRAWING NUMBER
SCALE	1/16" = 1'-0"	
DRAWN:	a.e	LB
DESIGN	a.c	
OH(D)	CW	OF7

19154-9ZP PMGPROJECT NUMBER:

19-154

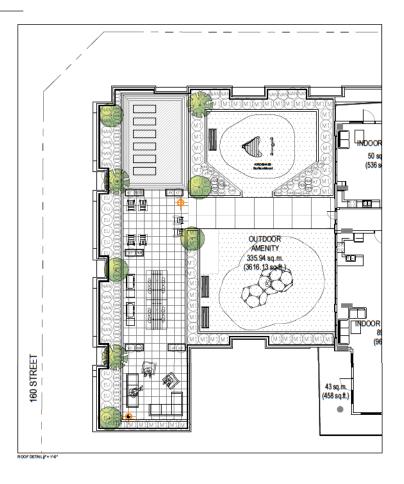

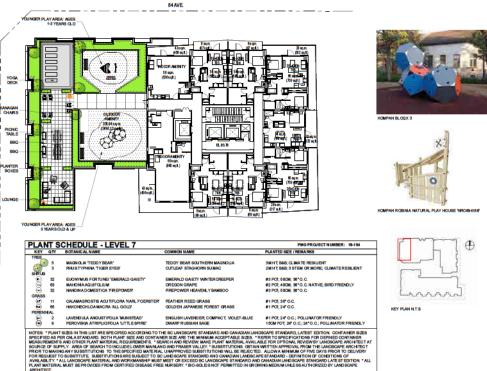



© Copyright reserved. This drawing and design is the property of PMG Landscape Architects and may not be responduled or used for other projects without their permission.



SEAL:



_			_
_			_
_			_
,	24.89.30	UPDATE HIS ARCH STEAM DROOF RANS	
6	24.8H.D	HEWSTE PLAN	
5	24 MWC 28	LISSUE FOR ACP	

PROJECT:

MIXED USE DEVELOPMENT

84TH & 160TH SURREY, B.C.

UPPER LEVEL LANDSCAPE PLAN

DATE	22.FEB.15	DRAWING NUMBE
SCALE	1/16" = 1'-0"	
DRAWN:	a.e	L4
DESIGN	a.c	
αжα	CW	OF

19154-9ZP PMGPRQJECTNUMBER:

19-154



© Copyright reserved. This drawing and design is the property of PMO Landscape Architects and may not be reproduced or used for other projects without their permission.





MIXED USE DEVELOPMENT

84TH & 160TH SURREY, B.C.

LEVEL 6, BUILDING 1 LANDSCAPE PLAN

DATE	22.FEB.15	DRAWING NUMBER
SCALE	1/16" = 1'-0"	
DRAWN:	a.e	Lb
DESIGN	a.c	
OHK10:	CW	OF7
l .		

19-154



| Appendix II | INTER-OFFICE MEMO

TO: Director, Development Planning, Planning and Development Department

FROM: Manager, Development Services, Engineering Department

DATE: **June 28, 2024** PROJECT FILE: **7818-0134-00**

RE: Engineering Requirements

Location: 8380 160 St

REZONE/SUBDIVISION

Property and Right-of-Way Requirements

- Dedicate 4.942 meters along 84 Avenue.
- Dedicate 1.942 meters along 160 Street.
- Dedicate 6.om for Lane.
- Dedicate 5.om x 5.om corner cut at 84 Avenue and 160 Street.
- Dedicate 3.om x 3.om corner cut at 84 Avenue and Lane.
- Register o.5m SRW along 84 Avenue and 160 Street frontage.

Works and Services

- Construct south side of 84 Avenue.
- Construct east side of 160 Street.
- Provide water, storm and sanitary service connection to lot.
- Complete sanitary capacity analysis and storm water catchment plan, and resolve downstream constraints as identified.
- Provide on-site stormwater mitigation features.
- Register restrictive covenants for on-site stormwater mitigation features.
- Pay latecomer fees #5915-0083-00-1 (Drainage).

Jeff Pang, P.Eng. Manager, Development Services

RH



Planning and Demographics June 27, 2024 City of Surrey Department:

Date: Report For:

Development Impact Analysis on Schools For:

18-0134 Application #:

The proposed development of 218 units and Low Rise Apartment High Rise Apartment units are estimated to have the following impact

on elementary and secondary schools within the school regions.

School-aged children population projection 60

Projected Number of Students From This L	Development In:	
Elementary School =	35	
Secondary School =	15	
Total Students =	50	

Current Enrolment and Capacities:		
Walnut Road Elementary		
Enrolment	812	
Operating Capacity	542	
# of Portables	10	
Fleetwood Park Secondary		
Enrolment	1733	
Operating Capacity	1200	
# of Portables	12	

Summary of Impact and Commentary

311


The following tables illustrate the historical, current and future enrolment projections ncluding current/approved ministry operating capacity for the elementary and secondary schools serving the proposed development.

As of September 2023, Walnut Road is operating at 150%. There are currently 10 portables on

n response to continued growth the Ministry of Education and Child Care approved in November 2023 the installation of 12 modular classrooms to open in Fall 2024. Additionally, another 4 nodular classrooms are scheduled to open the following year in September 2025. As part of the 2025/26 Capital Plan the District is looking to secure land for new schools as the construction of ew housing begins that is planned with the arrival of skytrain.


s of September 2023 Fleetwood Secondary is operating at 145% capacity. The school has relied on portables to make up the seat shortfall. The District has started a feasibility report to build a 500-capacity addition but has yet to receive funding to move forward.

dditionally, given the coming Skytrain and increased development, the District is planning ahead by identifying future elementary and secondary school sites; no funding from the Ministry has een allocated for these future sites.

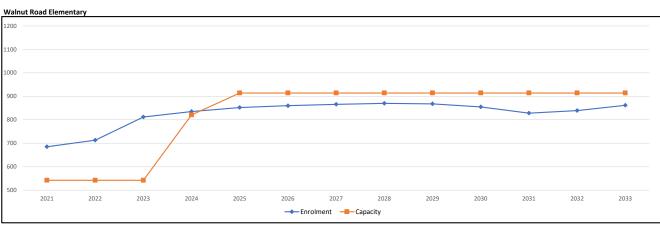

Note: If this report is provided in the months of October, November and December, the 10-year projections are out of date and they will be updated in January of next year.

Fleetwood Park Secondary

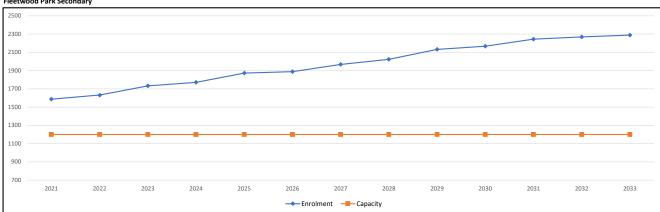

Note: If this report is provided in the months of October, November and December, the 10-year projections are out of date and they will be updated in January of next year.

Population: The projected population of children aged 0-17 Impacted by the development. Enrolment: The number of students projected to attend the Surrey School District ONLY.

Appendix IV

Appendix B: Tree Preservation Summary	
Surrey Project No: 18-0134-00	
Address: 8390/8380/8366/8352 160 Street & 16042 84 Avenue	37 NDK((?!/M)
Registered Arborist: Noah Talbot, BA ISA Certified Arborist (PN6822A), Tree Risk Assessment Qualified	
On-Site Trees	Number of Trees
Protected Trees Identified (on-site and shared trees, including trees within boulevards and proposed streets and lanes, but excluding trees in proposed open space or riparian areas).	68
Protected Trees to be Removed	68
Protected Trees to be Retained (excluding trees within proposed open space or riparian areas)	0
Total Replacement Trees Required Alder & Cottonwood Trees Requiring 1 to 1 Replacement Ratio 7 X one(1) = 7 All other Trees Requiring 2 to 1 Replacement Ratio 61 X two(2) = 122	129
Replacement Trees Proposed	Unknown
Replacement Trees in Deficit	Unknown
Protected Trees to be Retained in Proposed Open Space/Riparian Areas	NA
Off-Site Trees	Number of Trees
Protected Off-Site Trees to be Retained	0.55
Protected Off-Site Trees to be Removed	(29)
Total Replacement Trees Required - Alder & Cottonwood Trees Requiring 1 to 1 Replacement Ratio 2	4
Replacement Trees Proposed	Unknown
Replacement Trees in Deficit	Unknown
Total Replacement Trees	
TOTAL REPLACEMENT TREES PROPOSED	133

Tree Protection Banter. The areas, surrounding the trees to be retained, should be isolated from the construction activity by energing protective barrier fending. Where possible, the fencing should be erected at the perimeter of the root protection zones. The barrier fending to be erected must be a minimum of 1200mm in height, of solid frame construction that is attached to wooden or metal posts. A solid board or rail must run between the posts at the top and the bottom of the fencing. This solid frame can then be covered with plywood, or flexible snow fencing. The fencing must be erected prior to the start of any construction activity on site (i.e. demostron, excavation, construction), and remain in place through completion of the project. Signs should be posted around the protection zone to declare it off limits to all construction related activity. The project arborist must be consulted before this fencing is removed or moved for any purpose.

<u>Excavation</u>: We recommend that no excavation occur within tree protection zones of trees that are to be retained. Any excavation that is necessary, within the working space selback of trees to be retained must be completed under the direction of the project alburist. If it is found, at the time of excession, that the excession cannot be completed without severing note that are critical to the trees health or stability it may be necessary

Demolison: If tree removal is proposed to be undertaken in conjunction with demolision operations, tree removal permits may be necessary. Note that some municipalities may

not approve free removal at this phase. If the municipality relaxes the requirement for barrier fending installations prior to demolition (subject to onsite arborist supervision during demolition operations) a Letter of Undertaking may be required by the municipality. The project arborist must be onsite to supervise/monitor demolition activities during the specific instances listed below:

Demoition of the existing residences on the 8366 160 Street, 8380 160 Street and

 Demoktion of the existing residences on the 8309 (160 Street, 8380 160 Street and 10042 at Avia, properties.
 Removal of any existing hardscape or existing underground utilities boated on the subject propriets within the proposed development site.

Material storage. Areas must be designated for material storage and staging during the constitution process. Ideally these areas will be located outside of the time protection areas that will be solidated by barrier fencing. Should it be necessary to store material exposurely within any of the time protection areas. The project aborder must be consulted. Much layer or plywood over heavy traffic areas: Should it be necessary to access tree protection areas during the construction phase of the project, and heavy foot traffic or verticular encountment is required, we recommend that a layer of wood chip horticultural mulch or plygood be installed to reduce compaction. This project arborist must be consulted prior to removing or moving the protection banter for this purpose

Once tree clearing has taken place we recommend that trees to be retained be pruned to

como eles basing in salvar place e externinario una cese di se realiza de punto di removo deadwood, and lo address any structural flavs. We recommend that any pruning of bylaw-protected trees be performed to ANSI A300 standards and Best Management Practices. Stump removat: We recommend that, if stumps require removat, they are removed under

arborist supervision, or ground using a stump grinder to avoid disturbing root systems of trees in close proximity, that are shown on the tree management drawing to be retained. <u>Vandhow</u>. Where towast edge trees are proposed to be removed, we recommend that trees that may experience an increase in wind exposure, be re-examined, once tree clearing has taken place, to ensure that they are structurally stable, and suitable for refention as leading edge trees. Paved areas over ordical root zones of trees to be retained: Where paved areas cannot avoid encroachment within official root zones of frees to be retained, construction

avoid encroachment within official root zones of these to be retained, construction techniques, such as floating permeable panding, may be required, (specifications can be provided by the project arborist, in consultation with the design consultant). <u>Landecaping</u>, Any proposed instructioning within the official root zones of these to be retained must be reviewed with the project arborist. Arborists Polic it is the responsibility of the client or his/her representative to contact the project arborist for the purpose of:

- Locating the barrier fencing.
- Reviewing the report with the project foreman or sits supervisor.
 Locating work zones and machine access confiders where required.
 Supervising excavation for any areas within the critical not crose of trees to be retained including any proposed its areas. near trees to be retained

LEGEND

Site Boundary

Root protection zone (RPZ)

Working space setback (1.5m)

Broadleaf treew/Tag No.

Coniferous tree w/Tag No

Tree to be removed (proposed)

Tree protection barrier

Tree to be retained and protected

Off-site tree to be protected

Non-bylaw regulated tree

High Risk Tree - Refer to arborist report for

DRAFT - FOR DISCUSSION ONLY

SKETCH T1

Tree Management Plan 84 Avenue & 160 Street Surrey, BC


DATE: April 5, 2019 PREPARED FOR: Platinum Group 1 : 750 @ 11" X 17" SCALE: MCSL PROJECT: 2111-05163-00 MUN. PROJECT: 18-0134-00




McElhenney

Suite 2300 13450 - 102 Avenue Surrey BC Canada V3T 5X3 Tel 604 596 0391 - Fax 604 584 5050

THE SAMPLE OF DESCRIPTION AND DESCRIPTION AND

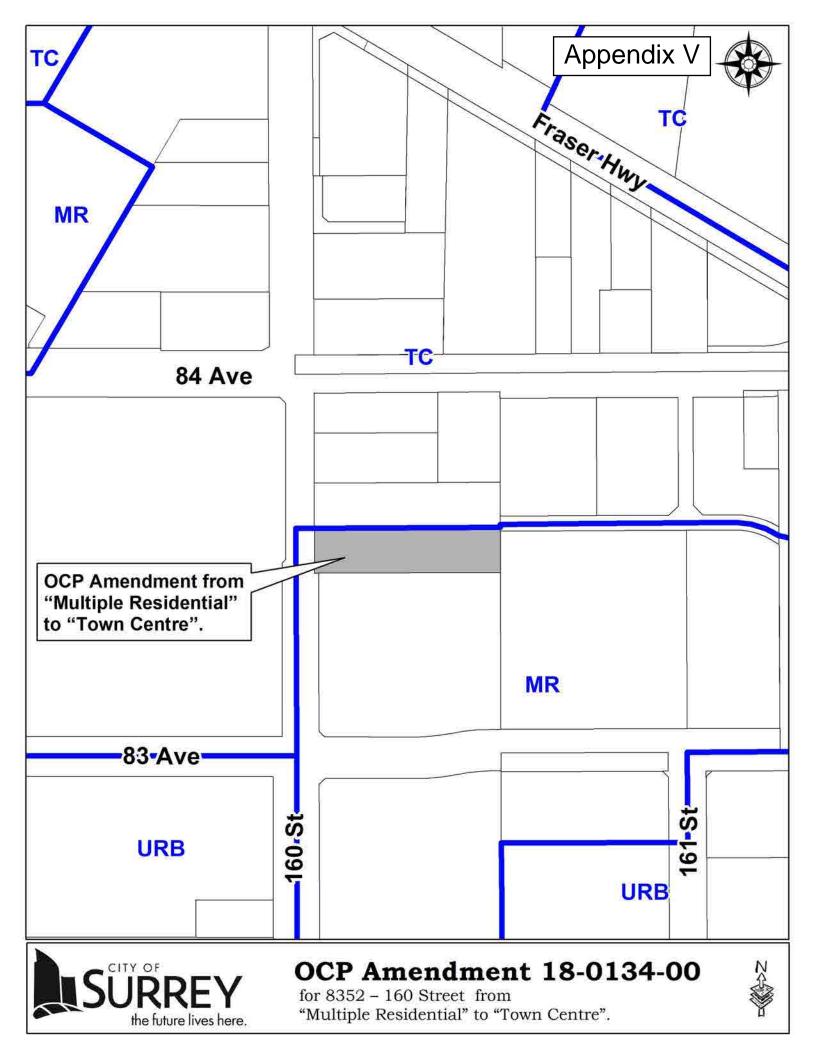

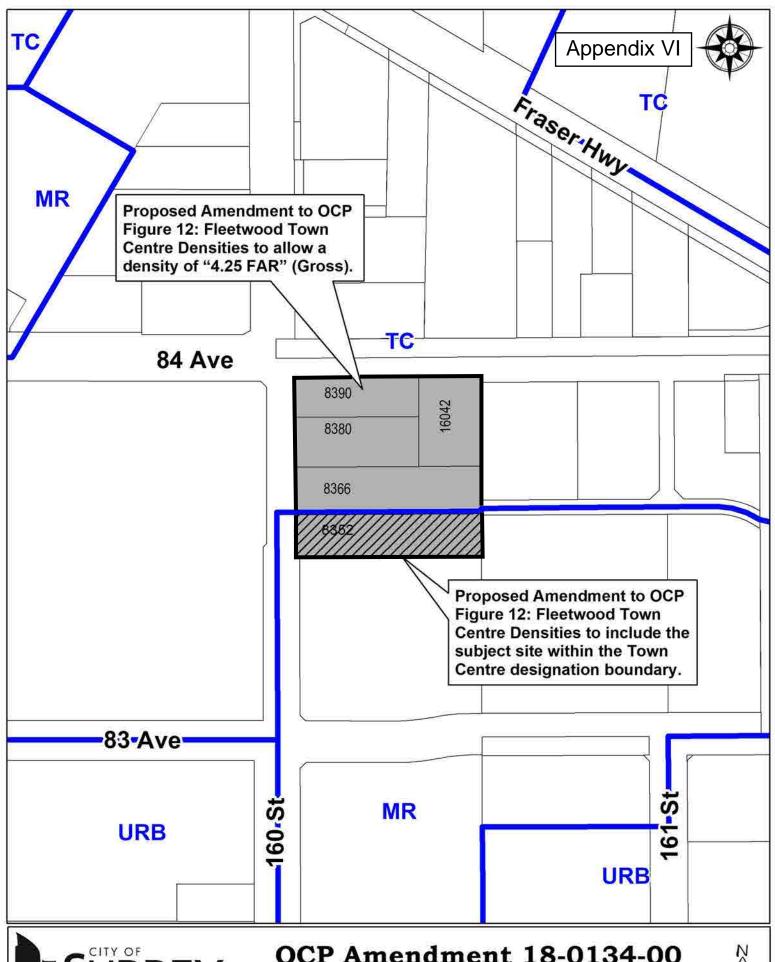



OCP Amendment 18-0134-00

Figure 12: Fleetwood Town Centre Densities with a density of "4.25 FAR".



Appendix VII

Proposed amendment to the Fleetwood Plan (Stage 1) from "Low Rise Residential" and "Low to High Rise Mixed Use" to "High Rise Mixed Use"

