
#### City of Surrey PLANNING & DEVELOPMENT REPORT Application No.: 7922-0191-00


Planning Report Date: February 13, 2023


#### **PROPOSAL:**

- **LAP Amendment** to reduce the size of the "Commercial" node and increase the amount of "Business Park" area.
- **Rezoning** from A-2 to CD (based on IB-1 and C-8)
- Development Permit
- Development Variance Permit

to permit the development of two multi-tenant lightimpact industrial buildings with an ancillary commercial node with a total floor area of 22,607 square metres and 44,795 square metres, respectively

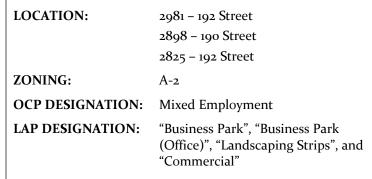

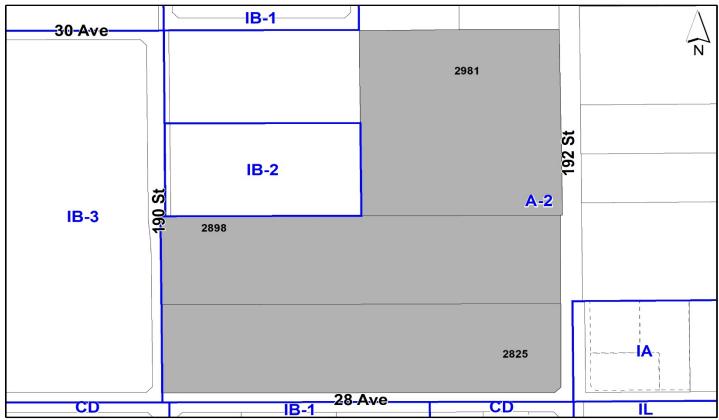

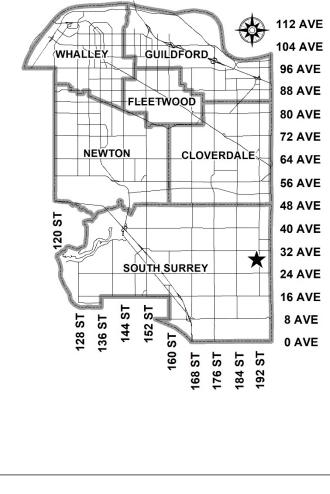

#### **RECOMMENDATION SUMMARY**

- By-law Introduction and set date for Public Hearing for Rezoning.
- Approval to draft Development Permit for Form and Character.
- Approval for Development Variance Permit to proceed to Public Notification.

#### **DEVIATION FROM PLANS, POLICIES OR REGULATIONS**

- Proposing an amendment to the Campbell Heights Local Area Plan (LAP) to reduce the size of the "Commercial" node and increase the amount of "Business Park" area.
- Proposing to reduce the industrial parking rate to allow for a reduced number of parking stalls on-site.

#### **RATIONALE OF RECOMMENDATION**

- The proposal complies with the Mixed Employment designation in the Official Community Plan (OCP).
- The proposal generally complies with the "Business Park", "Business Park (Office)", "Landscaping Strips", and "Commercial", land use designations in the Campbell Heights Local Area Plan (LAP); however, the applicant proposes to reduce the size of the "Commercial" Node.
- The proposed reduced commercial area will allow for greater floor area dedicated to lightimpact industrial business park uses. While the reduced area allocated to commercial uses is a departure from the Campbell Heights LAP, the intent of providing local commercial services for employees in the area will be met with the provision of a minimum of 1,999 square metres of commercial floor area.
- The proposal complies with the Mixed Employment designation in the Metro Vancouver Regional Growth Strategy (RGS).
- The proposal generally complies with the Development Permit requirements in the OCP for Form and Character.
- The proposed building achieves an attractive architectural built form, which utilizes high quality materials and contemporary lines. The street interface, including the featured commercial node, has been designed to a high quality to achieve a positive urban experience between the proposed building and the public realm.
- The applicant is proposing to provide a total of 787 stalls on site, equating to a 11-stall (1%) reduction. The proposed reduction is considered minimal and is supported by registration of a restrictive covenant on title to limit the maximum amount of mezzanine floor area that would be permitted to be constructed.

#### RECOMMENDATION

The Planning & Development Department recommends that:

- A By-law be introduced to rezone a portion of the subject site shown as Block A on the attached Survey Plan (Appendix I) from "Intensive Agriculture Zone (A-2)" to "Comprehensive Development Zone (CD)" [based on "Business Park 1 Zone (IB-1)"], and Block B on the attached Survey Plan from "Intensive Agriculture Zone (A-2)" to "Comprehensive Development Zone (CD)" [based on "Business Park 1 Zone (IB-1)" and "Community Commercial Zone (C-8)"], and a date be set for Public Hearing.
- 2. Council authorize staff to draft Development Permit No. 7922-0191-00 generally in accordance with the attached drawings (Appendix II).
- 3. Council approve Development Variance Permit No. 7922-0191-00 (Appendix V) varying the following, to proceed to Public Notification:
  - (a) to reduce the industrial parking rate from 1.0 parking spaces per 100 square metres to 0.983 parking spaces per 100 square metres.
- 4. Council instruct staff to resolve the following issues prior to final adoption:
  - (a) ensure that all engineering requirements and issues including restrictive covenants, dedications, and rights-of-way where necessary, are addressed to the satisfaction of the General Manager, Engineering;
  - (b) submission of a finalized Transportation Impact Analysis report;
  - (c) submission of a subdivision layout to the satisfaction of the Approving Officer;
  - (d) resolution of all urban design issues to the satisfaction of the Planning and Development Department;
  - (e) submission of a finalized landscaping plan and landscaping cost estimate to the specifications and satisfaction of the Planning and Development Department;
  - (f) submission of a finalized tree survey and a statement regarding tree preservation to the satisfaction of the City Landscape Architect;
  - (g) the applicant satisfy the deficiency in tree replacement on the site, to the satisfaction of the Planning and Development Department;
  - (h) submission of a finalized Ecosystem Development Plan and Impact Mitigation Plan to the satisfaction of City staff;
  - (i) registration of a Section 219 Restrictive Covenant to prohibit any use that require a Metro Vancouver air quality permit from locating on the site;

- (j) registration of a Section 219 Restrictive Covenant to adequately address the City's needs with respect to public art, to the satisfaction of the General Manager Parks, Recreation and Culture;
- (k) registration of a Section 219 Restrictive Covenant to prohibit the conversion of the commercial area into light-impact industrial space; and
- (l) registration of a Section 219 Restrictive Covenant to limit the amount of mezzanine floor area based on the current floor area proposed.
- 5. Council pass a resolution to amend the Campbell Heights Local Area Plan (LAP) to reduce the size of the "Commercial" node and increase the amount of "Business Park" area when the project is considered for final adoption.

Direction	Existing Use	LAP Designation	Existing Zone
Subject Site	Underutilized Acreage agricultural lots with single family residences	"Business Park", "Business Park (Office)", "Landscaping Strips", and "Commercial"	A-2
North:	Agricultural uses and a lot with an approved multi-tenant light-impact industrial building under Development Application No. 7919-0045-00 that was granted Final Adoption at the March 8, 2021 Regular Council – Land Use meeting.	Business Park", "Business Park (Office)", "Landscaping Strips",	A-2, IB-2

#### SITE CONTEXT & BACKGROUND

Direction	Existing Use	LAP Designation	Existing Zone
East (Across 192 Street):	<ul> <li>Acreage agricultural lots under various development applications for proposed multi-tenant light-impact industrial buildings (7920-0321-00);</li> <li>A temporary truck and equipment storage facility approved under</li> <li>Development Application No. 7920- 0106-00, which expired in November</li> <li>2021. A subsequent TUP extension under</li> <li>Development Application No. 7921- 0345-00 was conditionally supported by</li> <li>Council at the November 14, 2022</li> <li>Regular Council – Public Hearing meeting; several unpermitted truck</li> <li>parking facilities with current</li> <li>Temporary Use Permit applications</li> </ul>	"Business Park", "Landscaping Strips", and "Commercial"	CD (By-law No. 20305) and A-2
	under Development Application Nos. 7922-0259-00 and 7922-0373-00; And a commercial development including a gas station, drive-through restaurant, and commercial office building that was approved under Development Application No. 7917-0411- 00, which received Final Adoption at the November 14, 2022 Regular Council – Land Use meeting.	"Technology Park or	CD (By law
South (Across 28 Avenue):	Multi-tenant light-impact industrial buildings and a commercial retail plaza	Business Park", "Landscaping Strips", and "Commercial"	CD (By-law No. 16180) and IB-1
West (Across 190 Street):	Light-impact industrial warehouses and a vacant property with an approved Development Permit for a 10,222 square metre multi-tenant light-impact industrial building under Development Application No. 7919-0045-00.	Business Park", "Business Park (Office)", "Landscaping Strips",	A-2, IB-2, and IB-3

#### **Context & Background**

• The subject site is approximately 11.4 hectares in size and is located in the Campbell Heights Business Park along the major truck transportation route of 192 Street. The site is designated "Mixed Employment" in the Official Community Plan (OCP) and "Business Park", "Business Park (Office)", "Landscaping Strips", and "Commercial" in the Campbell Heights Local Area Plan (LAP). The property is zoned "Intensive Agriculture Zone (A-2)". • The "Commercial" designation is for a small portion of the subject site at its southeast corner. The "Commercial" designation on this property, together with "Commercial" designations on two other corners of the intersection of 192 Street and 28 Avenue form the main commercial node in Campbell Heights. The commercial node is intended to provide local serving amenities to employees of Campbell Heights Business Park.

### **DEVELOPMENT PROPOSAL**

#### **Planning Considerations**

- The applicant proposes to rezone the site from "Intensive Agriculture Zone (A-2)" to "Comprehensive Development Zone (CD)" based on "Business Park Zone (IB-1)" and "Community Commercial Zone (C-8)"; a Development Permit for Form and Character; Development Variance Permit to reduce the number of required parking spaces; and consolidation into a single property to permit the development of two multi-tenant light-impact industrial buildings with an ancillary commercial node with a total floor area of 22,607 square metres and 44,795 square metres, respectively.
- The applicant also proposes an Amendment to the Campbell Heights LAP to reduce the size of the "Commercial" node and increase the amount of "Business Park" area.
- Further discussion for the proposed LAP Amendment is provided in the Policy and By-law Considerations section.
- Further discussion for the proposed parking variance is provided in the Transportation Considerations section.

	Proposed						
Lot Area							
Gross Site Area:	11.4 hectares						
Road Dedication:	1.0 hectare						
Undevelopable Area:	n/a						
Net Site Area:	10.4 hectares	10.4 hectares					
Number of Lots:	1						
Building Height:	Building 1 (Block A)	Building 2 (Block B)					
	<b>17.2</b> metres	17.3 metres					
Floor Area Ratio (FAR):	0.64						
Floor Area							
	Building 1	Building 2					
Industrial:	20,636 sq. m.	39,199.5 sq. m.					
Office:	1,971 sq. m.	3,596 sq. m.					
Commercial:	n/a	1,999 sq. m.					
Total:	22,607 sq. m.	44,795 sq. m.					

#### Referrals

Engineering:	The Engineering Department has no objection to the project subject to the completion of Engineering servicing requirements as outlined in Appendix III.
Parks, Recreation & Culture:	No concerns.
	The closest active park is Latimer Park, with amenities including, a recreational trail network, and contains natural area. The park is Across the street from the development.
Surrey Fire Department:	No concerns.
Advisory Design Panel:	The application was not referred to the ADP but was reviewed by staff and found satisfactory.

#### **Transportation Considerations**

#### Road Network and Infrastructure

- The applicant will be required to provide the following improvements:
  - Dedication and construction of 30 Avenue along the northern property line. 30 Avenue is ultimately planned as a continuous connection between 188 Street and 194 Street and will provide full-movement ability for the block via a future signalized intersection at 192 Street;
  - Dedication and construction of the east side of 190 Street;
  - Dedication and construction of the north side of 28 Avenue; and
  - Dedication of the west side of 192 Street to protect for future arterial road widening.

#### Traffic Impacts

- A transportation impact analysis ("TIA") was provided for the subject proposal. Based on the TIA, the site is anticipated to generate approximately 323 vehicle trips in the peak hour (equating to five to six vehicles per minute).
- According to the TIA, the surrounding road network and intersections were found to operate at acceptable levels with implementation of mitigation measures. The applicant will be contributing towards future mitigation measures, including intersection improvements, as part of the subject proposal.

#### Access

• The subject site is proposed to be accessed via several driveways to 30 Avenue, 192 Street, and 190 Street, and 28 Avenue.

#### Application No.: 7922-0191-00

- Staff worked with the applicant to ensure efficient and functional access management to the surrounding road network, in consideration of the long site frontages, existing and future signalization, and need for adequate access to support the proposed commercial uses at the southeast corner of the subject site.
- The applicant is required to construct a new 4-metre-wide multi-use pathway along the north side of 28 Avenue to accommodate pedestrian and cycling activity, boulevards with lighting, curb and gutter, and pavement widening.
- An accessible bus stop is located both east and south of the site at the corner of 192 Street and 28 Avenue. TransLink's Bus Route No. 531 serves the site, connecting to White Rock to the west and Willowbrook to the east.

#### **Parking**

- According to the Zoning Bylaw, 798 stalls are required to be provided on site.
- The applicant is proposing to provide a total of 787 stalls on site, equating to a 11-stall (1%) reduction. The proposed reduction is considered minimal and is supported by registration of a restrictive covenant on title to limit the maximum amount of mezzanine floor area that would be permitted to be constructed.

#### **Sustainability Considerations**

- The applicant has met all of the typical sustainable development criteria, as indicated in the Sustainable Development Checklist.
- In addition, the applicant has highlighted the following additional sustainable features:
  - The applicant proposes to provide a high-albedo roof with a minimum Solar Reflectance Index value of 75 for the non-parking area of the roof. The non-parking area equates to approximately 72% of the rooftop area of Building 1 (Block A) and 71% of the rooftop area of Building 2 (Block B).
- The applicant proposes additional parking on the rooftop of each building thereby increasing the available land to develop. However, in place of treed landscape islands every six stalls in the rooftop parking, the applicant proposes a number of landscape planters with shrubs spaced greater than every six stalls.
- The applicant suggests the cost and survivability of trees within rooftop landscape islands renders this option unviable given the scale of the buildings.

#### POLICY & BY-LAW CONSIDERATIONS

#### **Regional Growth Strategy**

• The proposal complies with the "Mixed Employment" land use designation in the Metro Vancouver Regional Growth Strategy (RGS).

Page 9

## Official Community Plan

#### Land Use Designation

• The proposal complies with the "Mixed Employment" land use designation in the Official Community Plan.

#### **Themes/Policies**

• B6.6 – Design buildings to enhance the activity, safety and interest of adjacent public streets, plazas, and spaces.

(The proposed building is anchored to the northwest corner of 192 Street and 28 Avenue with extensive glazing and a large publicly accessible plaza leading from the intersection into the site.)

• E1.5 – Encourage the full utilization and efficient use of industrial and other employment lands in order to maximize jobs and economic activity per hectare.

(The proposal includes a significant number rooftop parking stalls to ensure the site is efficiently utilized.)

• E1.20 – Encourage the continued expansion of high-tech, research and development and light manufacturing to locate within Mixed Employment areas that are accessible to major transportation corridors and/or frequent transit services.

(The proposed development is compatible with the Mixed Employment designation and adds a significant number of employment opportunities in Campbell Heights. The subject site is also located at the corner of major arterial transportation corridors of 192 Street and 28 Avenue, which provide important transportation connections into and out of Campbell Heights.)

#### **Secondary Plans**

#### Land Use Designation

• The proposal requires a Local Area Plan Amendment to reduce the size of the "Commercial" node and increase the amount of "Business Park" area. Otherwise, the proposal complies with the "Business Park", "Business Park (Office)", "Landscaping Strips", and "Commercial" land use designations.

#### Amendment Rationale

• The proposed reduced "Commercial Area" will allow for greater floor area dedicated to lightimpact industrial business park uses. While the reduced area allocated to commercial uses is a departure from the Campbell Heights LAP, the intent of providing local commercial services for employees in the area will be met with the provision of a minimum of 1,999 square metres of commercial floor area.

#### **Themes/Objectives**

- The proposed development is supported by the following guidelines in the Campbell Heights Local Area Plan:
- 6.5.1.4 Design Guidelines Business Park The use of glass and high-quality materials and finishes is required of buildings facing the street. Blank walls should be avoided.

(The proposed development incorporates store-front glazing over two-storeys with the commercial node at the corner of 192 Street and 28 Avenue serving as an architectural focal point. Each industrial unit is delineated with detailed storefront glazing and coloured concrete tilt-up panels along with variation in tilt-up panel height to differentiate the unit entrances from the remainder of the building.)

• 6.5.1.4 – Design Guidelines – Business Park – The exterior of buildings should be coordinated in the design on all elevations with regard to colour, materials, architectural form, and detailing to achieve design harmony and continuity.

(The proposed buildings are architecturally coordinated with a modern appearance that promotes harmony through the use of consistent cladding materials, glazing, and landscaping.)

• 6.5.1.8 – Design Guidelines – Commercial Node – Commercial areas should be designed to cater to pedestrians by creating a pleasant outdoor commercial environment.

(The proposed commercial node is oriented towards the intersection corner of 192 Street and 28 Avenue with expansive storefront glazing. The node caters to pedestrians through its raised surface connection through the parking area and expansive under-canopy patio area that can be utilized by future tenants of the commercial space.)

#### CD By-law

- The applicant is proposing a "Comprehensive Development Zone (CD)" to accommodate two proposed multi-tenant light impact industrial buildings, including one building with a commercial space, on the subject site. The proposed CD By-law for the proposed development site identifies the uses, densities and setbacks proposed. The CD By-law will have provisions based on the "Business Park 1 Zone (IB-1)" and the "Community Commercial Zone (C-8)".
- The proposal includes a Block Plan where the site is divided into Block A and Block B. A "Building Location Plan" is also appended to the CD By-law, which differentiates the "light-impact industrial" use from the "commercial area" on Block B. The Building Location Plan is intended to identify the location and extent of the commercial area on Block B, which is to be delivered generally in keeping with the "Commercial" land use designation in the LAP.
- A comparison of the density, lot coverage, setbacks, building height and permitted uses in the IB-1 Zone, C-8 Zone and the proposed CD By-law is illustrated in the following table:

#### Application No.: 7922-0191-00

Page 11

	IB-1 Zone	C-8 Zone	
Zoning	(Part 47A)	(Part 36)	Proposed CD Zone
Floor Area	1.0	0.80	1.0
Ratio:			
Lot Coverage:	60%	50%	63%
Yards and	Front yard: 16.0 m	Front yard: 7.5 m	Front yard: 16.0 m*
Setbacks	Rear yard: 7.5 m Side yard: 7.5 m Side yard on flanking	Rear yard: 7.5 m Side yard: 7.5 m Side yard on flanking	Rear yard: 7.5 m Side yard: 7.5 m Side yard on flanking
	street: 9.0 m	street: 7.5 m	street: 9.0 m *the front yard setback (north) for Block A may be reduced to 4.6 metres
Principal Building Height:	14 metres	12 metres	Block A: 17.2 metres Block B: 17.3 metres
Permitted Uses:	<ul> <li><u>Principal Uses</u></li> <li>Light impact industry</li> <li>Warehouse uses</li> <li>Distribution centres</li> <li>Office uses (with exclusions)</li> </ul>	<ul> <li><u>Principal Uses</u></li> <li>Retail stores</li> <li>Personal service uses</li> <li>General service uses</li> <li>Beverage container return centre</li> </ul>	<u>Block A and Block B –</u> <u>Excluding</u> <u>Commercial Area</u> • Same uses as in IB-1 Zone <u>Block B – Commercial</u>
	Accessory Uses General service uses Eating establishments Community services Child care centres Caretaker unit	<ul> <li>Eating establishment</li> <li>Neighbourhood pubs</li> <li>Liquor store</li> <li>Office uses</li> <li>Parking facilities</li> <li>Automotive service uses</li> <li>Indoor recreational facilities</li> <li>Entertainment uses</li> <li>Assembly halls</li> <li><u>Accessory Uses</u></li> <li>Caretaker unit</li> </ul>	AreaPrincipal Uses• Retail stores• Personal service uses• General service uses• Beverage container return centre• Eating establishments• Neighbourhood pubs• Liquor store• Office uses• Liquor manufacturing• And other uses in C-8 Zone.Accessory Uses• Caretaker unit
Par	king (Part 5)	Required	Proposed
Number of Stal	ls		
Commercial:		60.00	
Industrial:		598.34	
Office:		139.18	
Total:		798	787

• The CD By-law for Block A retains the majority of the same provisions as outlined in the "Business Park 1 Zone (IB-1)" with the exception of the following:

- Increased lot coverage from 60% to 63%; and
- Reduced setbacks to the north property line from 7.5 metres to 4.6 metres.
- Increased building height from 14 metres to 17.2 metres for Building 1 (Block A) and 17.3 metres for Building 2 (Block B).
- The increased lot coverage and reduced building setback on the north property line are sought to accommodate a jog in 30 Avenue that is required to provide the minimum interim "half-road" width as a result of an inability to secure off-site permission for either road dedication or a statutory right-of-way from the properties to the north.
- The CD By-law for Block B is divided into two sections: "Block B: Excluding Commercial Area" and "Block B: Commercial Area".
- Block B: Excluding Commercial Area allows the same increase to lot coverage as in Block A but retains the remaining provisions as in the IB-1 Zone.
- Block B: Excluding Commercial Area also includes a provision that the light-impact industrial uses on Block B are only permitted provided a minimum of 1,999 square metres of floor area with commercial uses in the "Commercial Area" are provided. This provision will ensure that the "Commercial Area" is retained for commercial uses in keeping with the intent of the Campbell Heights LAP.
- Block B: Commercial Area has uses based on the "Community Commercial Zone (C-8)", which include retail stores, personal service uses, general service uses, eating establishments, and liquor store. Liquor manufacturing with an associated liquor tasing lounge is also a permitted use in this area. The commercial uses are open to the public and provide local serving amenities to employees in the Campbell Heights Business Park.

## Parking Variance

- The applicant is requesting the following variances:
  - (a) to reduce the industrial parking rate from 1.0 parking spaces per 100 square metres to 0.983 parking spaces per 100 square metres.
- Discussion of the proposed parking variance is noted in the Transportation Considerations section.
- Staff support the requested variances to proceed for consideration.

## **Public Art Policy**

• The applicant will be required to provide public art or register a Restrictive Covenant agreeing to provide cash-in-lieu, at a rate of 0.5% of construction value, to adequately address the City's needs with respect to public art, in accordance with the City's Public Art Policy requirements. The applicant will be required to resolve this requirement prior to consideration of Final Adoption.

#### PUBLIC ENGAGEMENT

• Pre-notification letters were sent on January 3, 2023 and the Development Proposal Signs were installed on January 12, 2023. Staff received one response from the Little Campbell Watershed Society seeking clarification on tree retention and whether air quality permits would be sought by future users on the site. Staff provided comments to the Little Campbell Watershed Society for clarification. Tree removal and retention information is noted in the "Trees" section of the report. The applicant will be required to register a restrictive covenant on title, restricting future businesses from seeking an air quality permit from Metro Vancouver.

#### **DEVELOPMENT PERMITS**

#### Form and Character Development Permit Requirement

- The proposed development is subject to a Development Permit for Form and Character and is also subject to the urban design guidelines in the Campbell Heights Local Area Plan (LAP).
- The proposed development generally complies with the Form and Character Development Permit guidelines in the OCP and the design guidelines in the Campbell Heights Local Area Plan (LAP).
- The applicant has worked with staff to provide a commercially-viable, prominent focal point, and attractive commercial node at the corner of 192 Street and 28 Avenue to support meeting the intent of the "Commercial" land use designation in the Campbell Heights LAP. While the proposed commercial node is not situated at the minimum setbacks along 192 Street and 28 Avenue, the design does include an expansive semi-public outdoor seating area, large outdoor commercial patios, a raised, visually demarcated connection to the intersection of 192 Street and 28 Avenue, and a large publicly accessible plaza near the intersection.
- The site consists of two multi-tenant light impact industrial buildings, one of which is oriented towards 192 Street and the other towards 28 Avenue. The buildings are surrounded by surface parking for passenger vehicles and a shared loading court area in the centre of the site. Rooftop-parking ramps are located on the south façade of Building 1 (Block A north) and west façade of Building 2 (Block B south). The parking ramps are architecturally integrated with the rest of the building through the use of coloured concrete tilt-up panels.
- The buildings are proposed to be constructed of concrete tilt-up panels in shades of grey, brown, and cream with brown metal canopies. Architectural emphasis is placed along the building facades of 192 Street and 28 Avenue by utilizing building articulation, variation in building heights, and expansive storefront glazing.
- The commercial space is visually anchored to the corner of 192 Street and 28 Avenue through the use of a large black aluminum canopy panel, extensive storefront glazing that wraps the full extent of the commercial floor on both facades, and an extended plaza canopy feature that is intended to connect to the publicly accessible plaza at the intersection. The articulation and architectural features create a strong architectural edge that reinforces an attractive pedestrian environment while retaining vehicular access for visitors to the commercial units.
- The loading bays will be screened from public view with a 3.0 metre tall architectural screen wall along 192 Street, 190 Street, and 30 Avenue.

#### Application No.: 7922-0191-00

• Employee amenity areas are located throughout the site for each building. Building 1 (Block A) contains employee amenity areas at the south and north end of the building along 192 Street, including additional amenity in the publicly accessible open space at the intersection of 30 Avenue and 192 Street. Building 2 (Block B) contains an employee amenity at the southwest corner of the site. Additional amenity space is located adjacent to the commercial retail units where expansive outdoor patio seating (subject to future tenants) and plaza seating is proposed.

#### Landscaping

- The proposed landscaping consists of a 6.0 metre-wide landscape buffer on 192 Street, 28 Avenue, 190 Street, and 30 Avenue.
- The proposed landscaping consists of a variety of trees, including Norway Maple, Purple Leaf Beech, Western Red Cedar, Persian Ironwood, and Freeman Maple. The tree plantings are complemented by a variety of shrubs and groundcover.
- In addition, the applicant proposes a series of landscape planters in the rooftop parking area for both buildings. The rooftop planter landscaping will consist of a variety of shrubs and perennials.

#### **Outstanding Items**

- There are a limited number of Urban Design items that remain outstanding, and which do not affect the overall character or quality of the project. These generally include:
  - Increasing the articulation depth of the street fronting façades;
  - Clarifying the roofing material, which is to be a high-albedo material with a minimum Solar Reflectance Index value of 75; and
  - Minor drawing clarifications and coordination.
- The applicant has been provided a detailed list identifying these requirements and has agreed to resolve these prior to Final Approval of the Development Permit, should the application be supported by Council.

#### TREES

• Andrew Briggs, ISA Certified Arborist of 818 Studio prepared an Arborist Assessment for the subject property. The table below provides a summary of the tree retention and removal by tree species:

Tree Species	Existing	Remove	Retain				
Alder and Cottonwood Trees							
Alder	1	1	0				
Cottonwood	8	8	0				

#### Table 1: Summary of Tree Preservation by Tree Species:

#### Application No.: 7922-0191-00

(excluding		ious Trees	ood Trees)		
Apple		2	2	0	
Cherry		6	6	0	
Trembling Aspen		18	18	0	
Dogwood		3	3	0	
Common Fig		1	1	0	
Hawthorne		2	2	0	
Japanese Maple		2	2	0	
Plum		2	2	0	
	Conife	rous Trees			
Douglas Fir		7	7	0	
Austrian Pine		5	5	0	
Shore Pine		5	5	0	
Sitka Spruce		2	2	0	
<b>Total</b> (excluding Alder and Cottonwood Trees)		55	55	o	
Total Replacement Trees Proposed (excluding Boulevard Street Trees)181					
Total Retained and Replacement T	181				
Contribution to the Green City Pro		\$ <b>0</b>			

- The Arborist Assessment states that there are a total of fifty-five mature trees on the site, excluding Alder and Cottonwood trees. Nine (9) existing trees, approximately 14% of the total trees on the site, are Alder and Cottonwood trees. It was determined that no trees can be retained as part of this development proposal. The proposed tree retention was assessed taking into consideration the location of services, building footprints, road dedication and proposed lot grading.
- For those trees that cannot be retained, the applicant will be required to plant trees on a 1 to 1 replacement ratio for Alder and Cottonwood trees, and a 2 to 1 replacement ratio for all other trees. This will require a total of 119 replacement trees on the site. The applicant is proposing 181 replacement trees, exceeding City requirements.
- There are no existing City trees proposed for removal. There are trees located within future road dedication that are required to be removed to facilitate future road widening on 192 Street, 190 Street, and 28 Avenue.
- The new trees on the site will consist of a variety of trees including Purple Leaf Beech, Freeman Maple, Norway Maple, and Western Red-Cedar
- In summary, a total of 181 trees are proposed to be retained or replaced on the site.

Page 15

Page 16

#### INFORMATION ATTACHED TO THIS REPORT


The following information is attached to this Report:


Appendix I. Block Plan & Building Location Plan
Appendix II. Site Plan, Building Elevations, Landscape Plans and Perspective
Appendix III. Engineering Summary
Appendix IV. Summary of Tree Survey and Tree Preservation
Appendix V. Development Variance Permit
Appendix VI. LAP Plan

approved by Shawn Low

Jeff Arason Acting General Manager Planning and Development

KS/ar

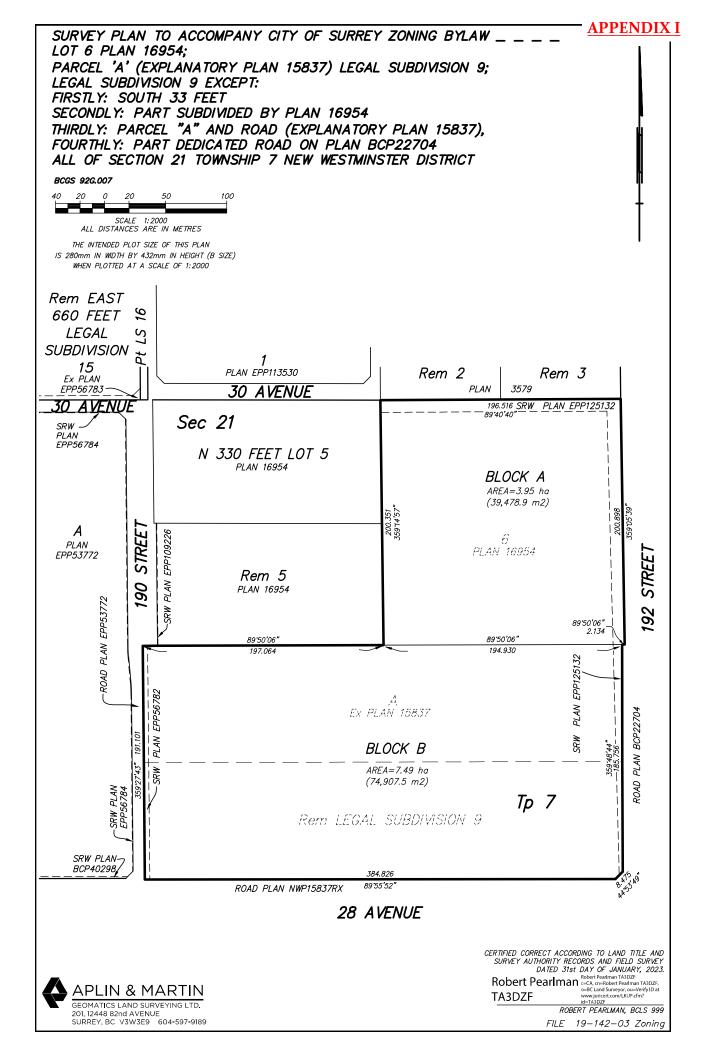

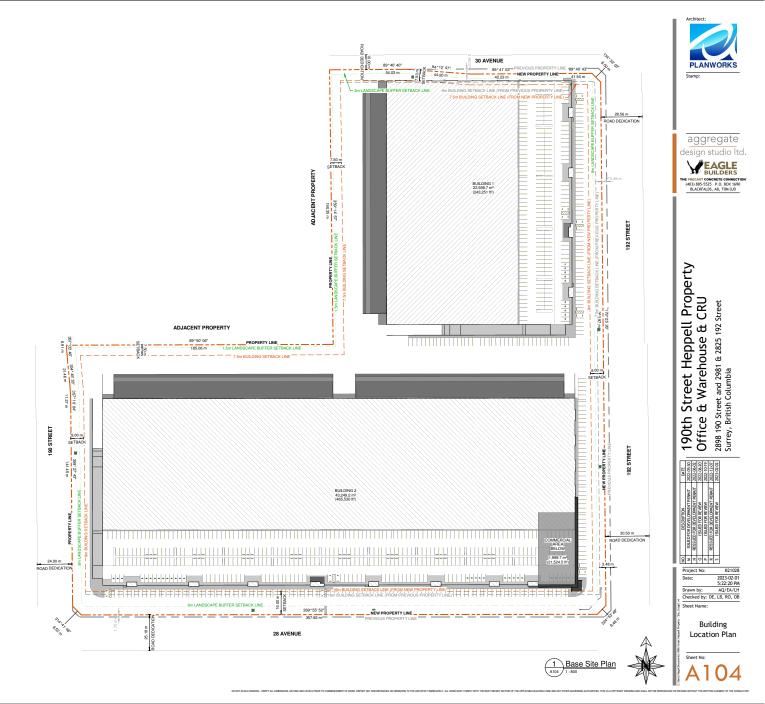








# **190th Street Heppell Property**



2981 & 2825 192 Stree

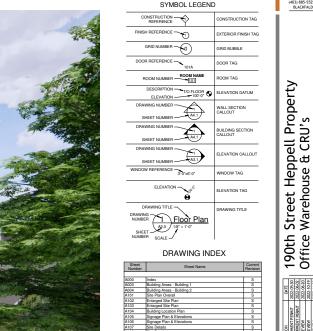



Current Revision				;;;;;;;;;;;;;;;;;;;;;;;;;;;;;;;;;;;;;;;				
~ ~ ~ ~ ~ ~ ~ ~ ~ ~ ~ ~ ~ ~ ~ ~ ~ ~ ~ ~	L	<u>س</u>	0022-05-30	2090	22-06-20	8022-10-19	022-11-30	PO 01 0000
S		Щ	ă	ă	ă	à	à	ł
6			8	8	8	8	8	Ş
s		Г	Г	_				
s			Ę	X				THE REAL OF THE PARTY OF THE PARTY OF
S			8	8				3
S			lê	토	l≽	≥	≥	
S		z	8	X	ž	F	ž	
S		١Ĕ	18	2	2	2	2	
S		DESCRIPTION	1g	2	ISSUED FOR REVIEW	ISSUED FOR REVIEW	ISSUED FOR REVIEW	
S		۱Ŋ	8	ã	a	8	8	
S		P	18	ö	B	B	B	
S	ŝ		ГĔ	ē	l≌	l≌	123	ŝ
S	metv-Sterv.		ISSUED FOR DEVELOPMENT PERMIT	REISSUED FOR DEVELOPMENT				
S	Ĩ		18	끏				

8-49-00 A 40/F4/L Checked by: DE, LB, RO, OB

A000

Surrey, British Columbia


Office Warehouse & CRU's









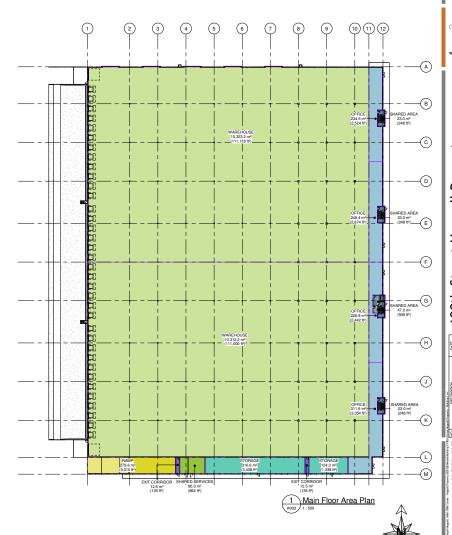

Floor Areas EXIT CORRIDOR OFFICE

RAMP SHARED AREA SHARED SERVICES STORAGE WAREHOUSE

OFFICE

SHARED AREA

PARKING AREA

SHARED AREA Grand total

25.08 m² 1,021.28 m²

270 ft² 10,992.97 ft² 
 1,029,128 m²
 10,992,37 m²

 279,64 m²
 3,010 ft²

 116,07 m²
 1,249,41 ft²

 80,27 m²
 864 ft²


 400,92 m²
 4,746 ft²

 20,635,45 m²
 222,118.14 ft²

 22,598,71 m²
 243,250.51 ft²

950.33 m<sup>2</sup> 10,229.28 ft<sup>2</sup> 109.91 m<sup>2</sup> 1,183.09 ft<sup>2</sup> 1,060.24 m<sup>2</sup> 11,412.38 ft<sup>2</sup>

6,060.85 m<sup>2</sup> 105.91 m<sup>2</sup> 6,166.76 m<sup>2</sup> 29,825.72 m<sup>2</sup> 6,104.1.33 ft<sup>2</sup> 6,104.1.33 ft<sup>2</sup> 6,104.1.33 ft<sup>2</sup>

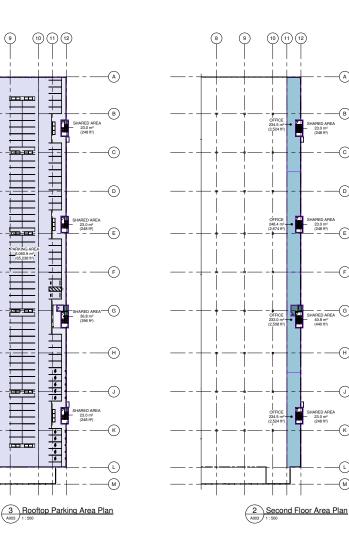

(8)

m

A DEE

\_

ri 📼

\_

A DEE

\_

(10) (11) (12)

OFFICE 234.5 m<sup>2</sup> (2,524 ft<sup>2</sup>) 

OFFICE 248.4 m<sup>2</sup> (2,674 ft<sup>2</sup>)

OFFICE 233.0 m<sup>2</sup> (2,508 ft<sup>2</sup>)

OFFICE 234.5 m<sup>2</sup> (2,524 ft<sup>2</sup>)

-(A)

-®

-©

-(D)

E)

-(F)

-(H)

-(J)

(к

-(1)


(м)

SHARED AREA = 23.0 m<sup>2</sup> (248 ft<sup>2</sup>)

2 SHARED AREA 23.0 m<sup>2</sup> (248 ft<sup>2</sup>)

G SHARED AREA 40.8 m<sup>2</sup> (440 ft<sup>2</sup>)

SHARED AREA 23.0 m<sup>2</sup> (248 ft<sup>2</sup>)

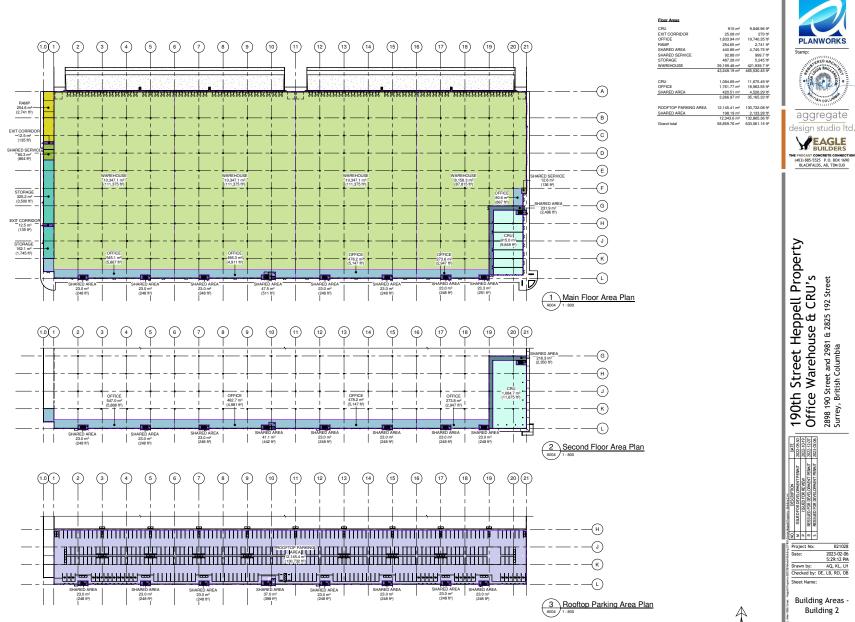

Sheet No: A004

#### NOTES CONCERNING BUILDING LOCATION

- THIS SITE PLAN IS BASED ON INFORMATION PROVIDED BY THE OWNER, AND NOT A SURVEY OR ACTUALS SITE MEASUREMENTS. ENGINEER IS TO BE ADVISED BEFORE START OF CONSTRUCTION OF ANY UN-KNOWN FEATURES ON THIS OR THE ADJACENT SITES THAT MIGHT IMPACT ON THE PROJECT EITHER DURING CONSTRUCTION OR FUTURE USE.
- đ<sup>i</sup> https://bit.ly/3xcf4Sc
  - THE "NORTH" ORIENTATION REFERS TO NOMINAL NORTH RATHER THAN TRUE OR MAGNETIC NORTH ANY DIMENSIONS THAT SHOW THE LOCATION OF EXISTING FEATURES ARE APPROXIMATE ONLY, AND ARE TO BE CONFIRMED BEFORE CONSTRUCTION START AS REQUIRED BY A CERTIFIED ALBERTA LAND SURVEYOR. 169.92 m 7.99 m 11.00 r 30 AVENUE 54.03 m 37.96 m ERTY BUILDING 1 22,598.7 m<sup>2</sup> (243,251 ft<sup>2</sup>) 7.50 m SETRACI 37.39 m 128.93 m
  - (1) (A103) 36.17 m -APPROX. FIRE HYDRANT LOCATION (T.B.C. ADJACENT PROPERTY ROOFTOP PARKING ACCESS 185.06 m 334.98 m STREET

39°41'03

-

-

-10.00

BUILDING 2 43,249,2 m<sup>2</sup> (465 530 ft<sup>2</sup>) ETBAC 1 SETBA <u>┤┤┤┤┤┤┤</u>Ĩ╎┤╎╎╎╎╎╷**╷**╷ ROOFTOP PARKING INII E I I I RETAIL NOI BELOW ROOFTOP PARKING uuun (in<u>in on on</u> 5/A107 APPROX. FIRE RANT LOCATION (T.B.C.)

28 AVENUE

APPROX. FIRE HYDRANT LOCATION (T.B.C.)

220.861

APPROX. FIRE

HYDRANT LOCATION (T.B.C.)



USE

WAREHOUS

OFFICI

MAIN OFFICE

ΜΔΙΝ

MAIN OFFICE

MAIN RETAIL

MAIN

ACCESSIBLE PARKING STALL REQUIREMENTS REQUIRED NUMBER OF ACCESSIBLE PARKING

SPACES BASED OFF OF REQUIRED NUMBER OF STANDARD PARKING SPACE

2nd FLOOR RETAIL

UIREMENTS

TYPE OF STALL

SECURE BIKE STALLS

VISITOR BIKE STALLS

FLOOR OFFICE

AREA

ft<sup>2</sup> m<sup>2</sup>

222 118 14 20 635 5

11,675.49 1,084.7

8.963.55 1.761.8

STANDARD STALLS

AREA

ft<sup>2</sup> m<sup>2</sup>

SUBTOTAL 725,508.44 67,401.9 TOTAL PARKING STALLS REQUIRE

797.52 2%

TOTAL VEHICLE PARKING STALLS REQUIRED:

725,508.44 67,401.9 0.06 SPACE PER 100 m<sup>2</sup> 40.44

725,508.44 67,401.9 0.06 SPACE PER 100 m2 40.44 80.88

10,992.97 1,021.3

> 229.28 950.3

19,740,35 1.833.9

9,848.96 915.0

WAREHOUSE 421 939 70 39 199 5

PARKING CALCULATION

BUILDING

BUILDING 2

BICYCLE PARKING R

BUILDING

GENERAL SERVICE

USE AND EATING ESTABLISHMENT

ANT LOCATION

APPROX, FIRE

TRC

HYDRANT LOCATION

44A1

8

-

ANT LOCATION

(T.B.C 1 10.0

HYDRANT



SITE SCHEDULE	
ON OTTO	

PARKING BY GROSS FLOOR AREA					UN SITE					
PARKING BT GRUSS FLOUR AREA					APRON	18,976.53 ft <sup>e</sup>	1,763.0 m <sup>2</sup>			
REQUIREM	MENT REOL			EQUIREMENT REQUIRED			IRED	DECORATIVE PAVING	10,876.57 ft <sup>e</sup>	1,010.5 m <sup>2</sup>
		_			HARD LANDSCAPING	788.12 ft <sup>e</sup>	73.2 m <sup>2</sup>			
5 STALL PER	100	m <sup>2</sup>	25.53		HEAVY DUTY ASPHALT	242,749.16 18	22,552.1 m <sup>2</sup>			
STALL PER	100	-	206.35		LANDSCAPING	67,717.89 ft <sup>e</sup>	6,291.2 m <sup>2</sup>			
STALLFER	100				LIGHT DUTY ASPHALT	39,233.01 ft <sup>e</sup>	3,644.9 m <sup>2</sup>			
.5 STALL PER	100	m <sup>2</sup>	23.76	255.64	MULCH	4,396.57 ft <sup>2</sup>	408.5 m <sup>2</sup>			
5 STALL PER	100	m <sup>2</sup>	45.85		SIDEWALK	28,544.45 ft <sup>2</sup>	2,651.9 m <sup>2</sup>			
J STALL FLA	100		40.00			413,282.32 #	38,395.2 m <sup>2</sup>			
STALL PER	100	m <sup>2</sup>	27.45							
STALL PER	100	m²	391.99		OFF SITE					
STALL PER	100	m-	391.99		HEAVY DUTY ASPHALT - BOULEVARD	8,399.85 ft <sup>2</sup>	780.4 m <sup>2</sup>			
STALL PER	100	m <sup>2</sup>	32.54		LANDSCAPING - BOULEVARD	48,070.97 ft <sup>2</sup>	4,465.9 m <sup>2</sup>			
					SIDEWALK - BOULEVARD	37,666.08 ft <sup>2</sup>	3,499.3 m <sup>2</sup>			
5 STALL PER	100	m2	44.04	541.88		94,136.89 ft <sup>2</sup>	8,745.6 m <sup>2</sup>			
OTAL PARKING STALLS REQUIRED 797.52				797.52	Grand total	507,419.21 ft <sup>2</sup>	47,140.8 m <sup>2</sup>			

1	PARKING	SCHEDULE		
	BUILDING 1	BARRIER FREE PARKING STALL	GROUND PARKING	6
		STANDARD PARKING STALL	GROUND PARKING	53
	BUILDING 1	BARRIER FREE PARKING STALL	ROOF PARKING	2
	BUILDING 1	EV PARKING STALL	ROOF PARKING	10
	BUILDING 1	STANDARD PARKING STALL	ROOF PARKING	174
	BUILDING 1	245		-

BUILDING 2 BARRIER FREE PARKING STALL GROUND PARKING 6 GROUND PARKING BUILDING 2 STANDARD PARKING STALL BUILDING 2 BARRIER FREE PARKING STALL ROOF PARKING BUILDING 2 EV PARKING STALL ROOF PARKING 3 BUILDING 2 STANDARD PARKING STALL ROOF PARKING BUILDING 2:542 81 GRAND TOTAL: 781

LOADING DOORS

TYPE SIZE TY I4'x10' OHD Dock D

SECURE BIKE STALLS TO BE PROVIDED IN FUTURE TENANT IMPROVEMENT STAGE

	EV PANNING STALL	REQUIREMENTS						
		BUILDING	COMMERCIAL STALLS	REQUIREMENT	REQU	IRED	BICYCLE PARKING	
	COMMERCIAL	BUILDING 1	49.29	20%	9.86		STALL TYPE	BIKE CAPACI
	AREA (OFFICE & RETAIL)	BUILDING 2	149.88	20%	29.98	39.83	VISITOR BIKE STALL	
07				TOTAL EV STALLS R	EQUIRED	40		

TOTAL BIKE SPACES REQUIRED

PARKING BY GROSS FLOOR A

REQUIRED

15.0

2.5 STALL PER 100 m<sup>2</sup>

REQUIREMENT

0.02

PARKING BY GROSS FLOOR AREA

REQUIREMENT REQUIRED

#### Mar? SITE MATERIAL LEGEND SITE PLAN LEGEND PROPERTYLINE APRON MULCH DIGHT OF WAY HA \*\*\*\*\* SIDEWALK LANDSCAPING MAN DOOR OVERHEAD DOOR X LIGHT DUTY ASPHALT HARD LANDSCAPING BARRIER EREE ⊽ APPROX FIRE HYDRANT LOCATION (T.B.C.) ENTRANCE HEAVY DUTY ASPHA DECORATIVE PAVING

2898 190 Street and 2981 & 2825 192 Street Surrey, British Columbia 190th Office DATE 2022-05-30 2022-06-02 2022-10-19 2022-11-30 2022-11-30 2022-11-30 2022-12-30 2022-1 PERMIT TION OPMENT PERMIT LOPMENT PERMIT LOPMENT PERMIT LOPMENT PERMIT LOPMENT PERMIT ACITY 46 46 DESCRIPTIC FOR DEVELOP 7 FOR DEVELOP 15SUED FOR R 15SUED FOR R 15SUED FOR R 15SUED FOR R 5 FOR DEVELO COUN



Sheet No:

Sheet Name: Site Plan Overall

PLANWORKS Stamp

aggregate

design studio Itd

THE PRECAST CONCRETE CONNECTION (403) 885-5525 P.O. BOX 1690 BLACKFALDS, AB, TOM 0J0

Heppell Property use & CRU's

Street Hep

10000 VISUAL SCALE 1:100









\_





02





6m DECORATIVE PAVING

> MIN LAN DSCAPING

OPERTY

ADJACENT PR

PROPOSED FENCE LOCATION (REFER TO A109)

EXISTING TREE TO BE RETAINED

92 F










Δ


A101 1:500


03




VISUAL SCALE 1:500

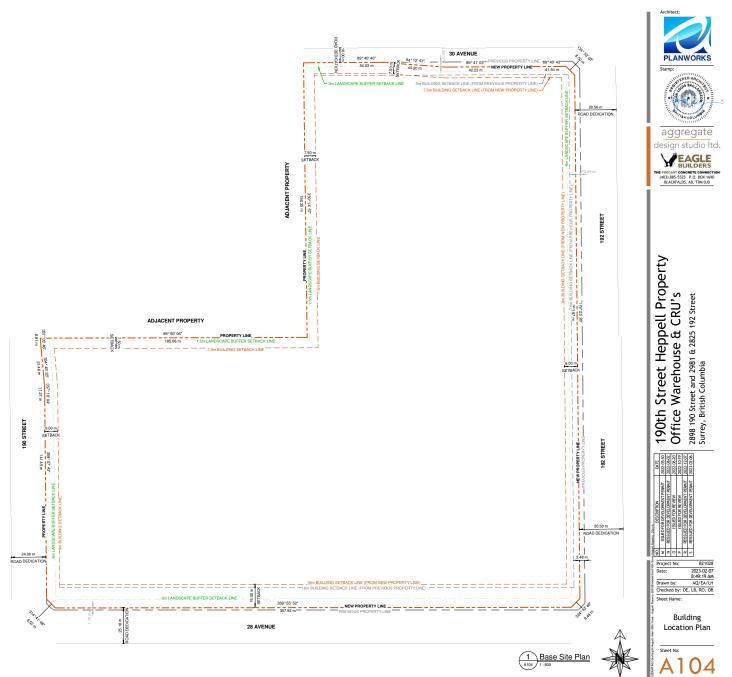


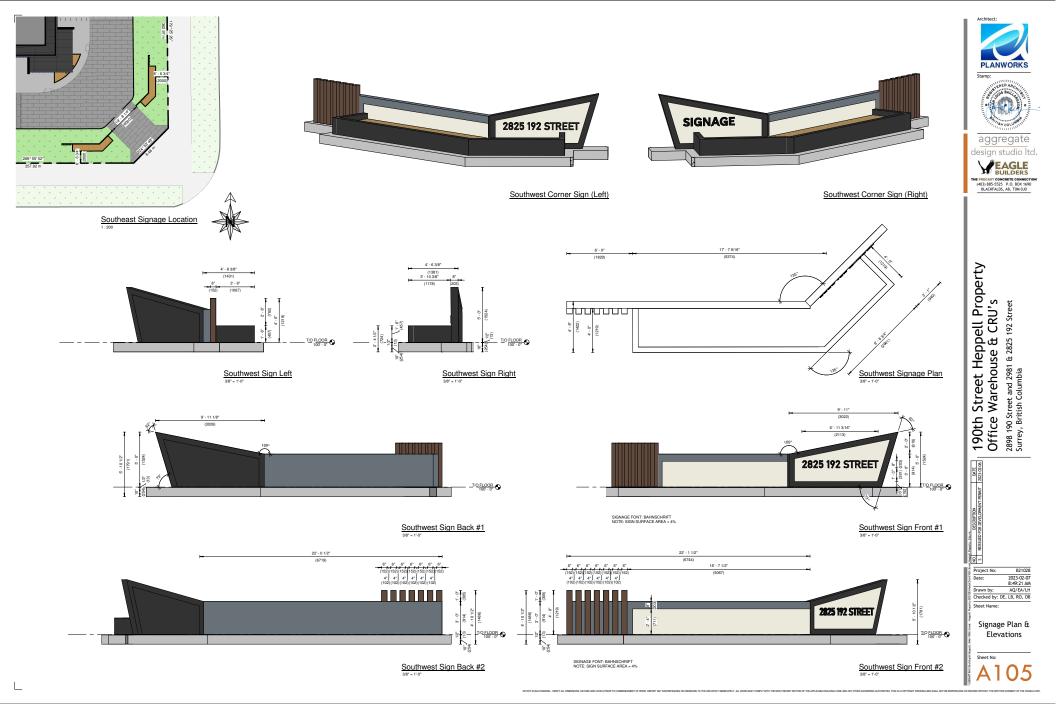


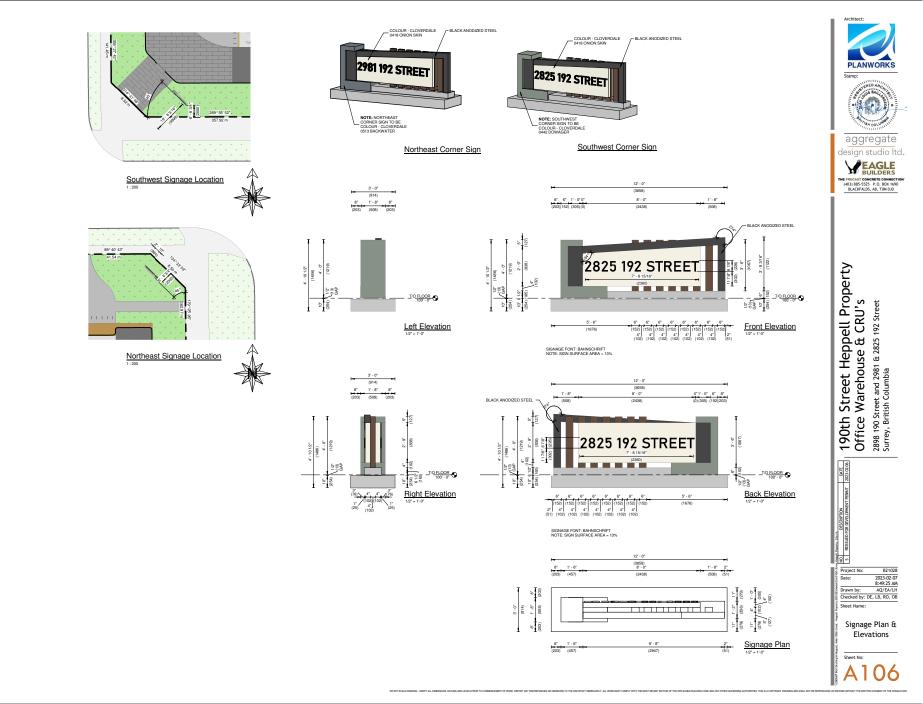



Γ

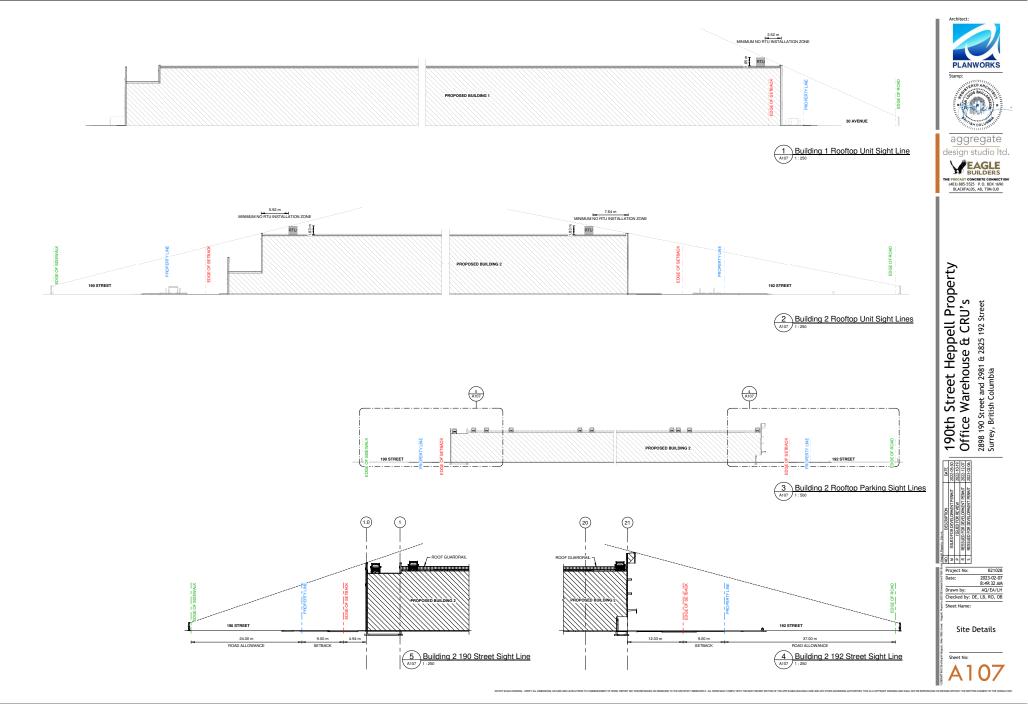

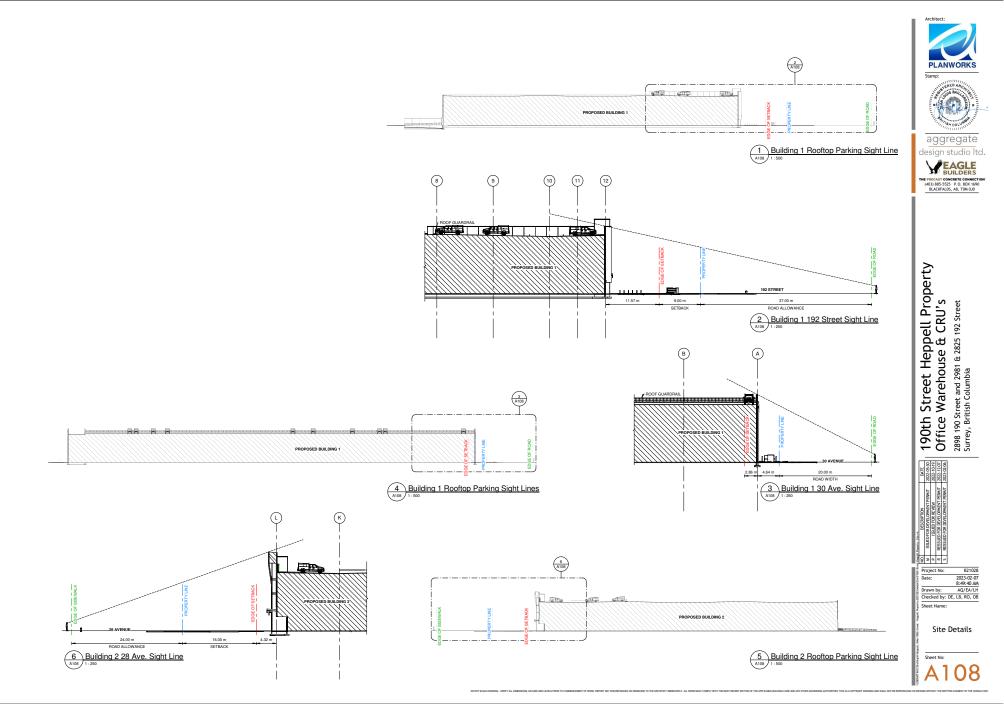


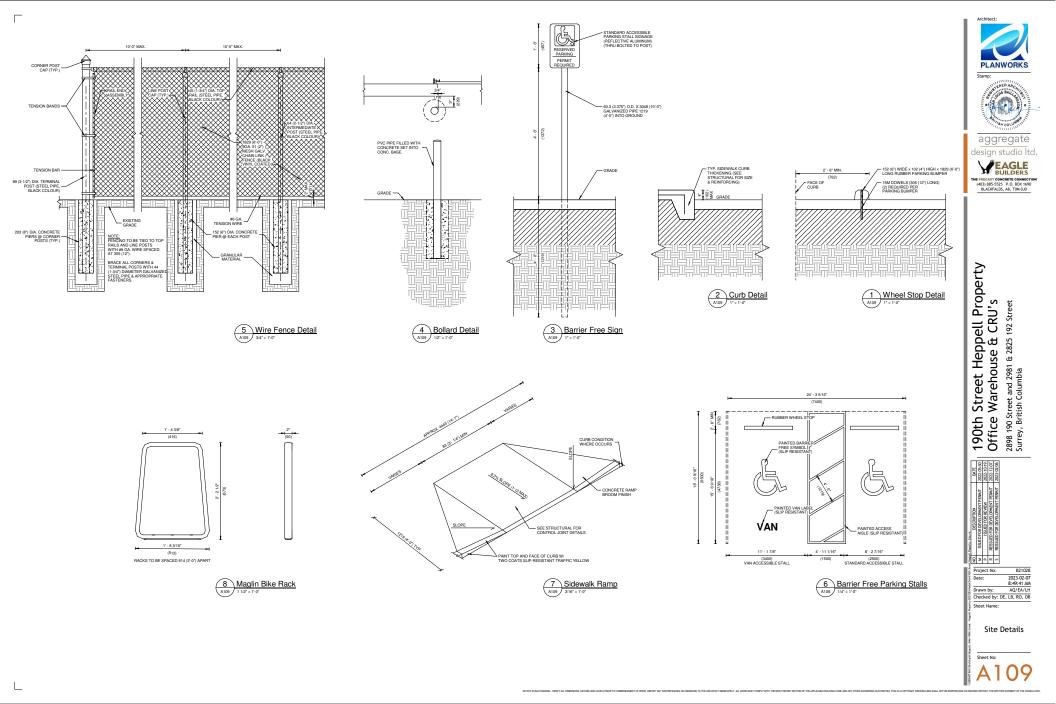

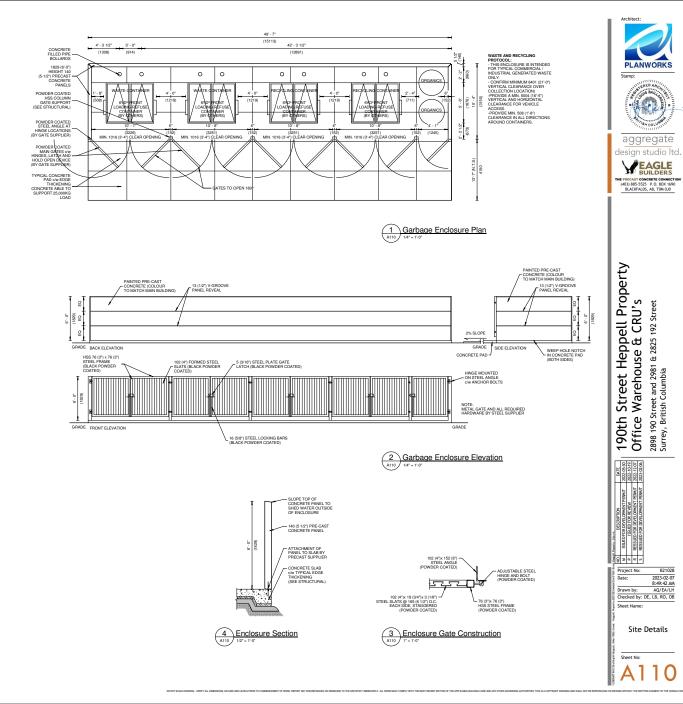

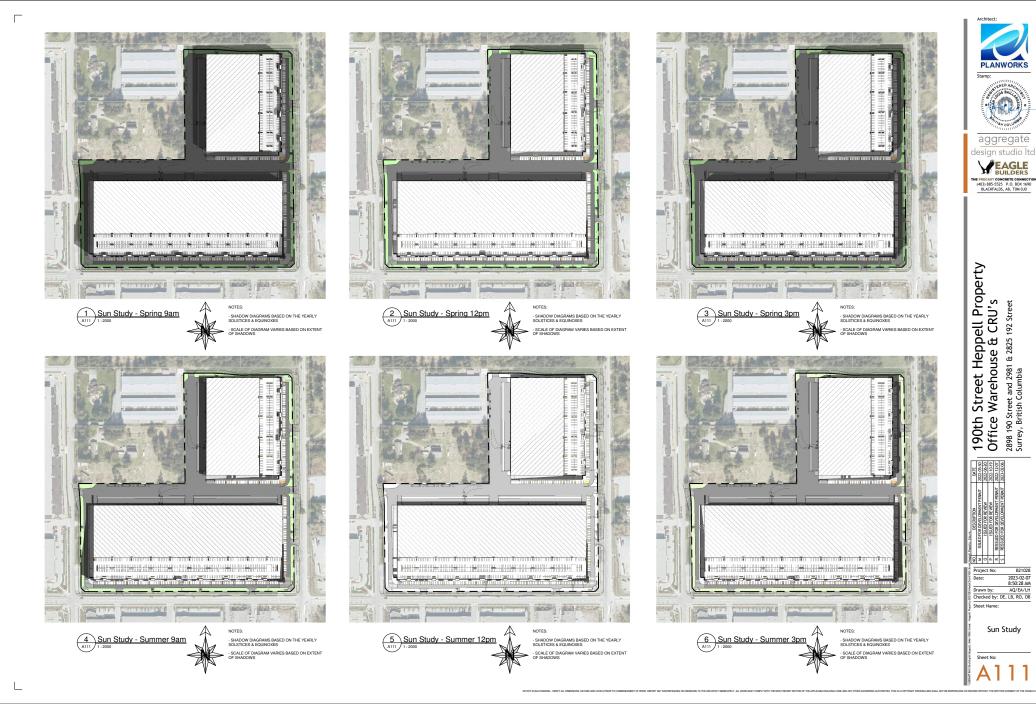


B21028

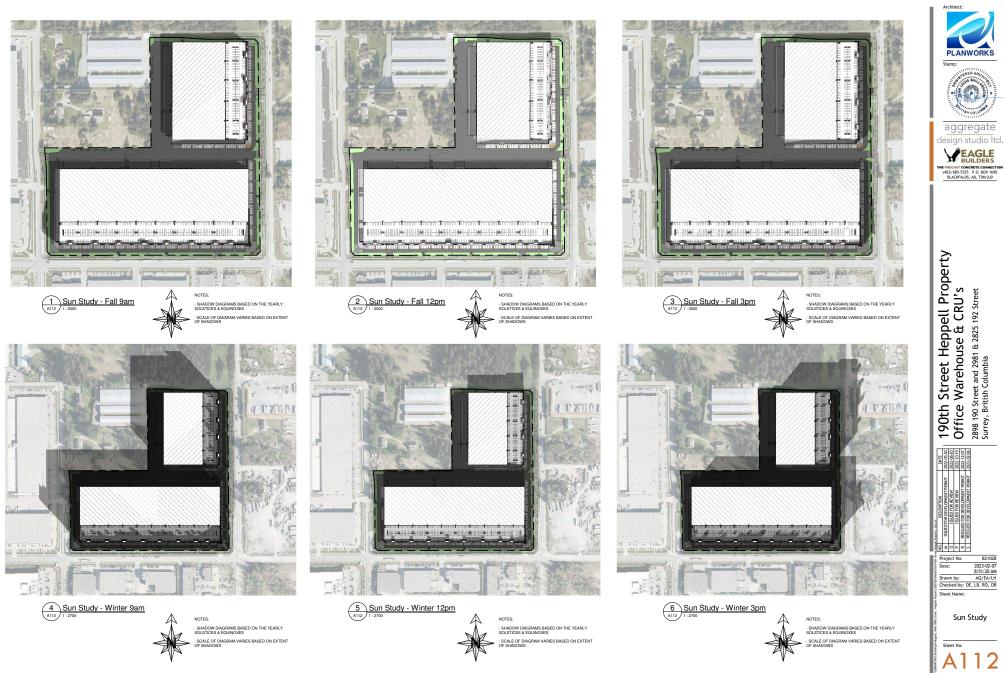

A112


B21028


2023-02-07 8:51:20 AM

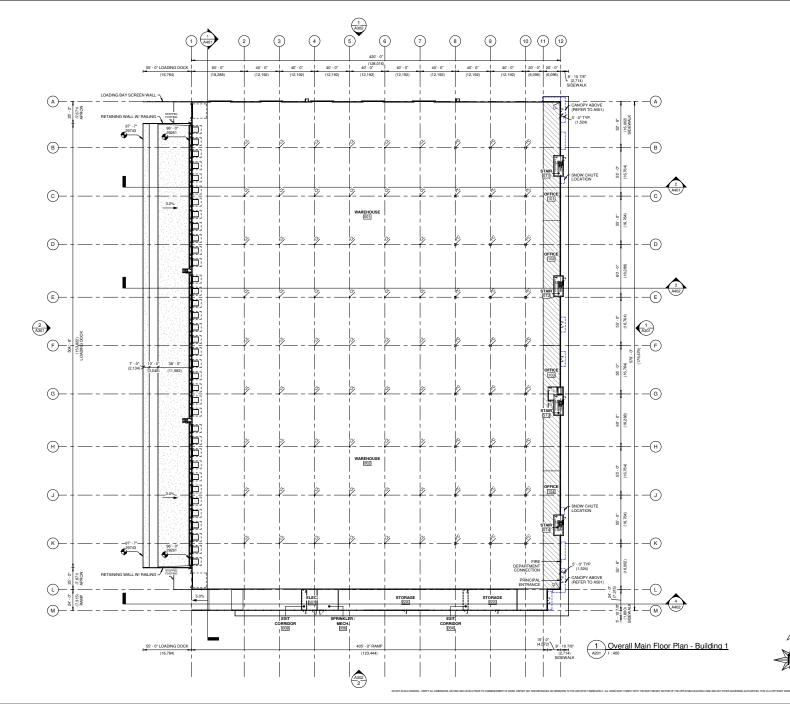






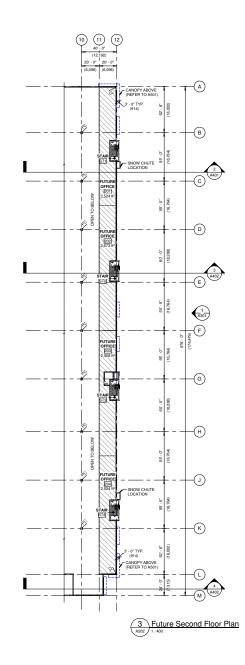

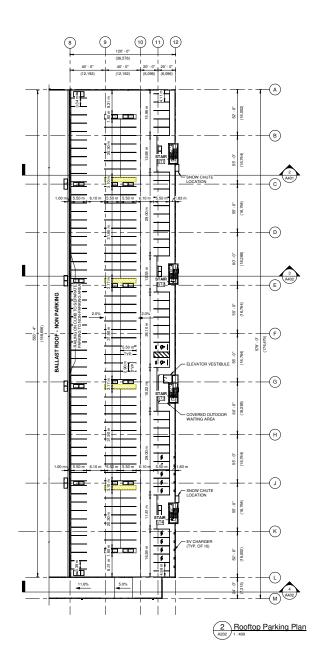

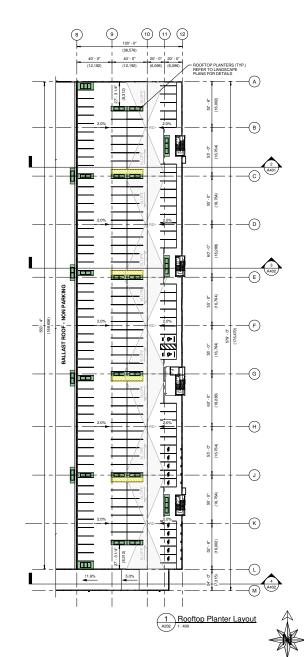






DATE 2022-05-30 2022-10-19 2022-12-07 2023-02-06

> Rooftop Parking & 2nd Floor Plan - Building 1


Sheet No:

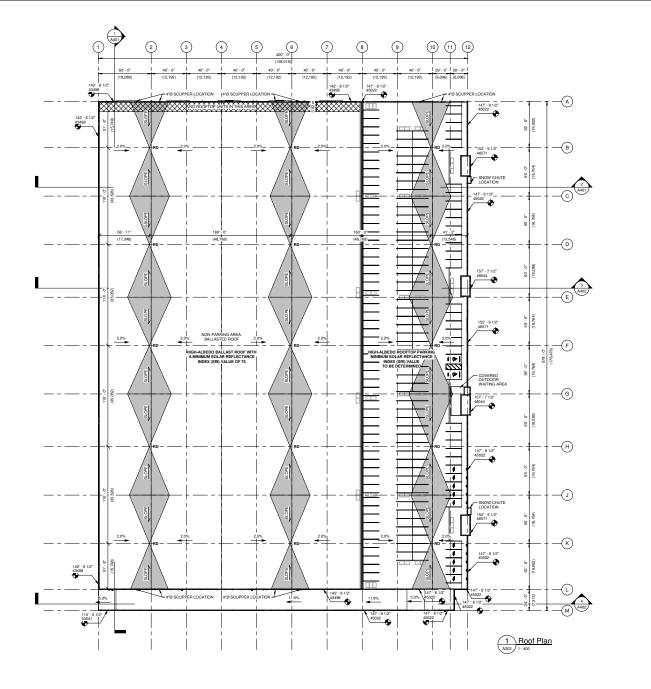




\_\_\_\_



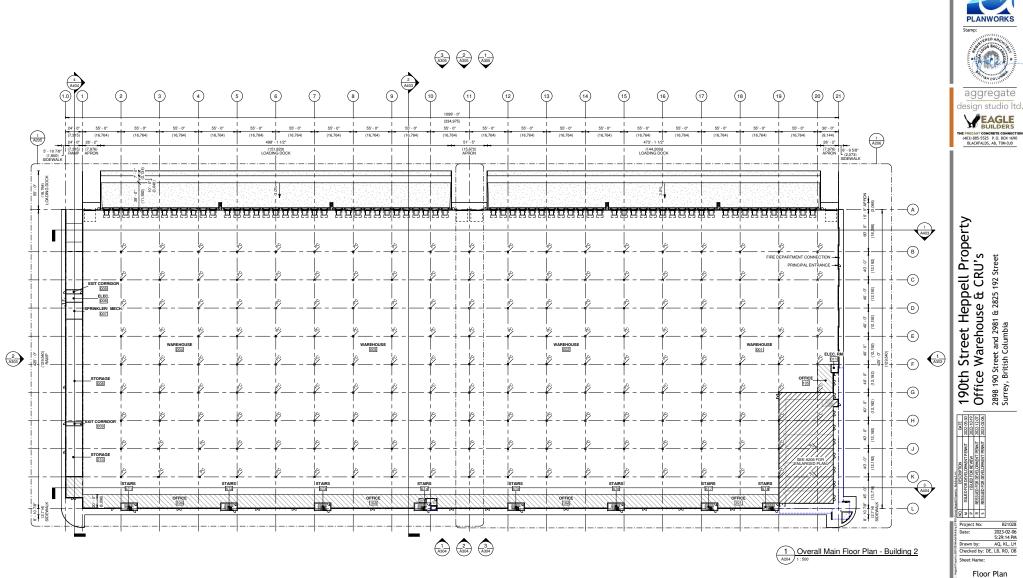

Overall -Building 2 Sheet No:

A204

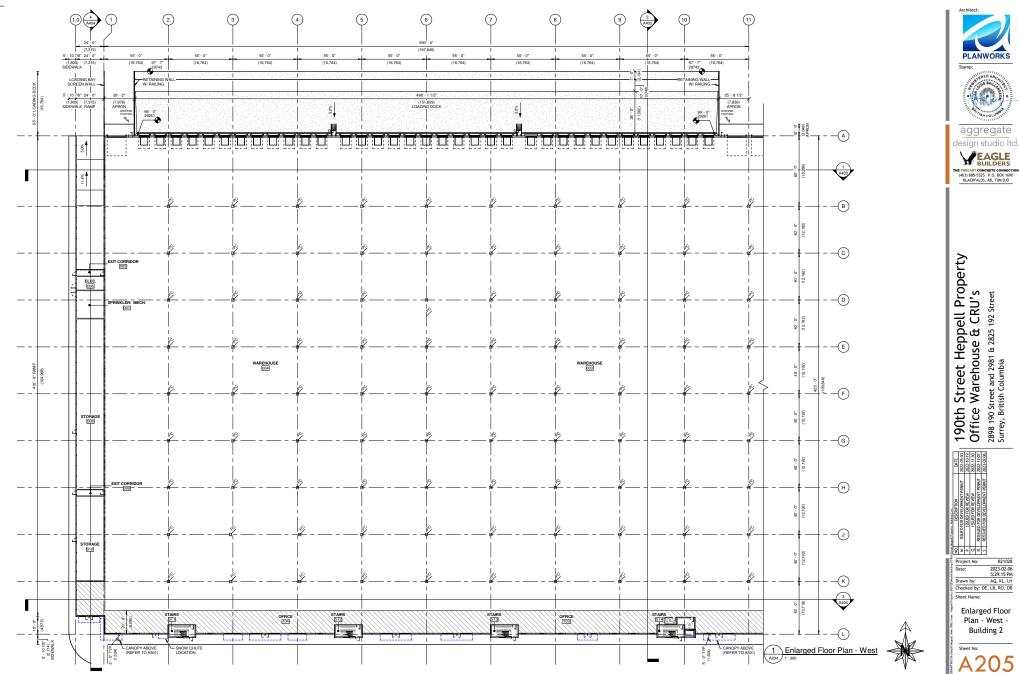


190th Street Heppell Property Office Warehouse & CRU's 2898 190 Street and 2981 & 2825 192 Street Surrey, British Columbia

B21028

2023-02-06 5:29:15 PM AQ, KL, LH


Plan - West -Building 2 Sheet No: A205

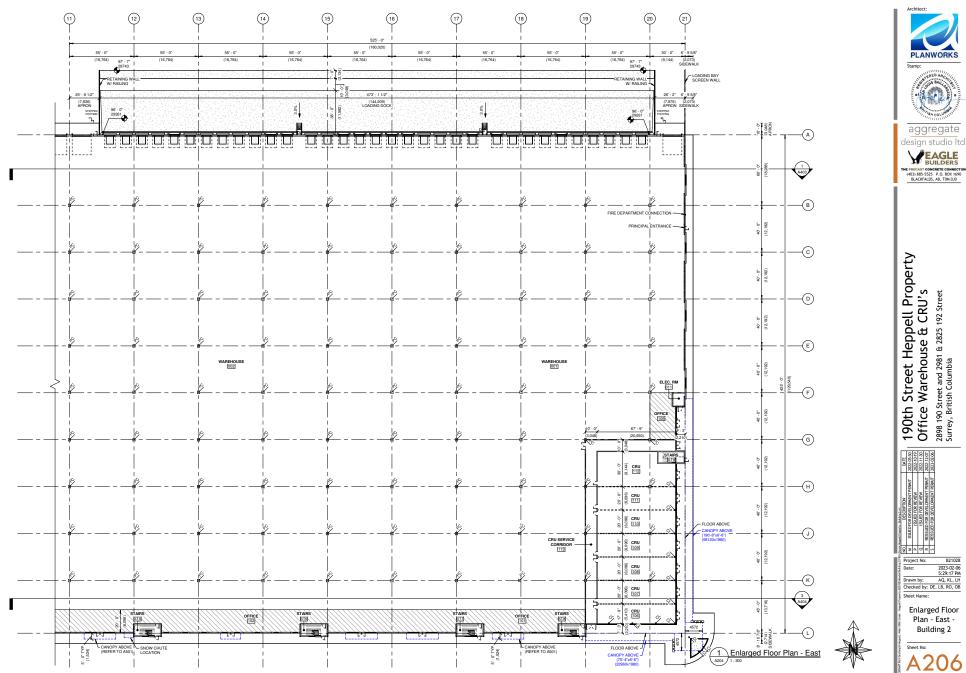

CAUSE CONCRETE CONNECTION (403) 885-5525 P.O. BOX 1690 BLACKFALDS, AB, TOM 0.JO 190th Street Heppell Property Office Warehouse & CRU's 2898 190 Street and 2981 & 2825 192 Street Surrey, British Columbia

B21028

GREDA

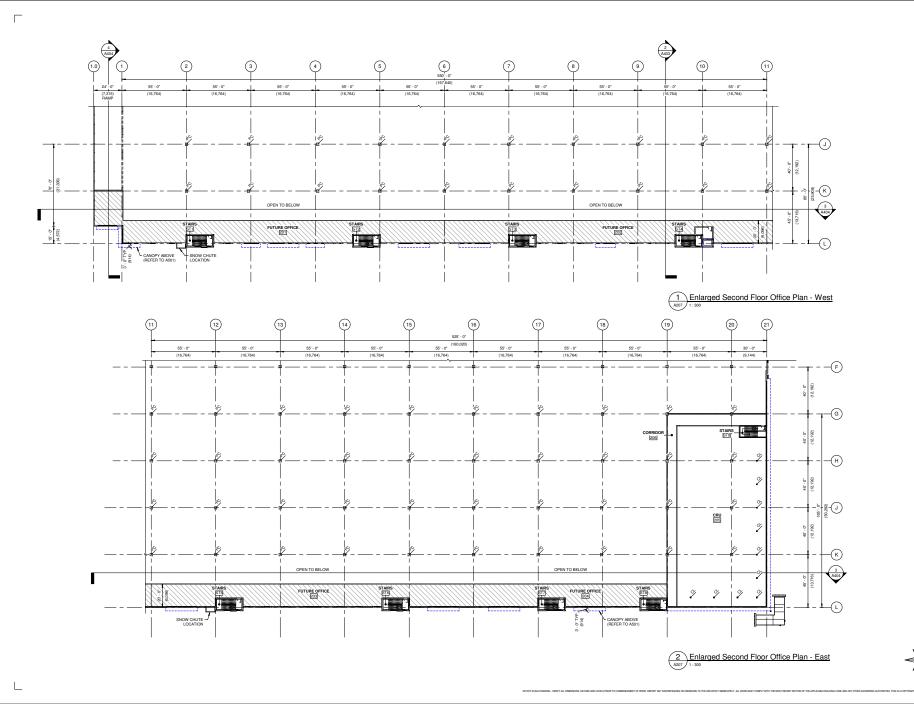

aggregate design studio Itd. CCR0,2 The rest of the state of the state

PLANWORKS


GREDA

Stamp:

190th Street Heppell Property Office Warehouse & CRU's 2898 190 Street and 2981 & 2825 192 Street Surrey, British Columbia



Sheet No:

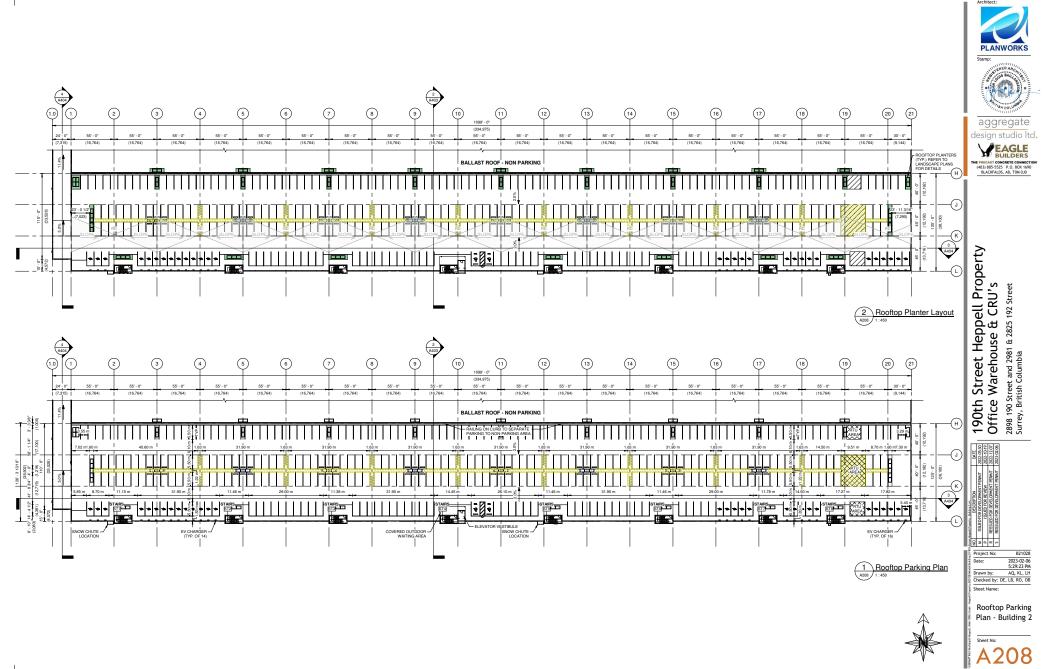






190th Street Heppell Property Office Warehouse & CRU's 2898 190 Street and 2981 & 2825 192 Street Surrey, British Columbia

\_


PERMIT

Project No:

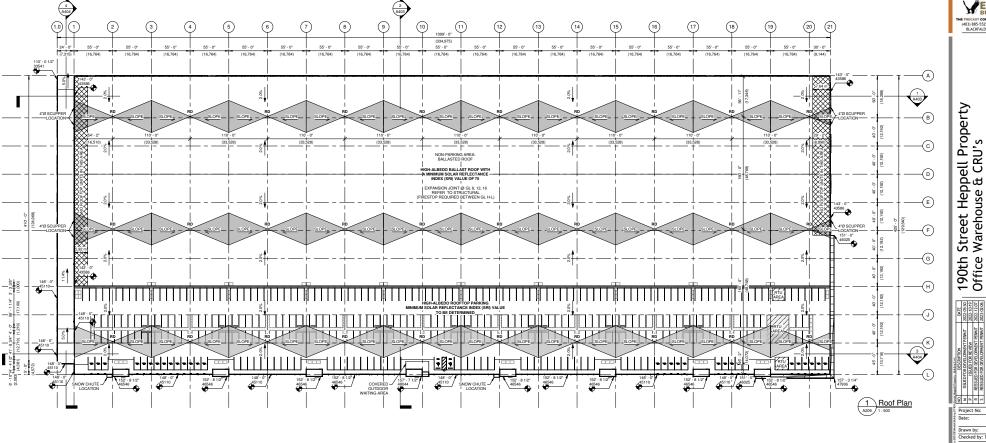

A209

B21028

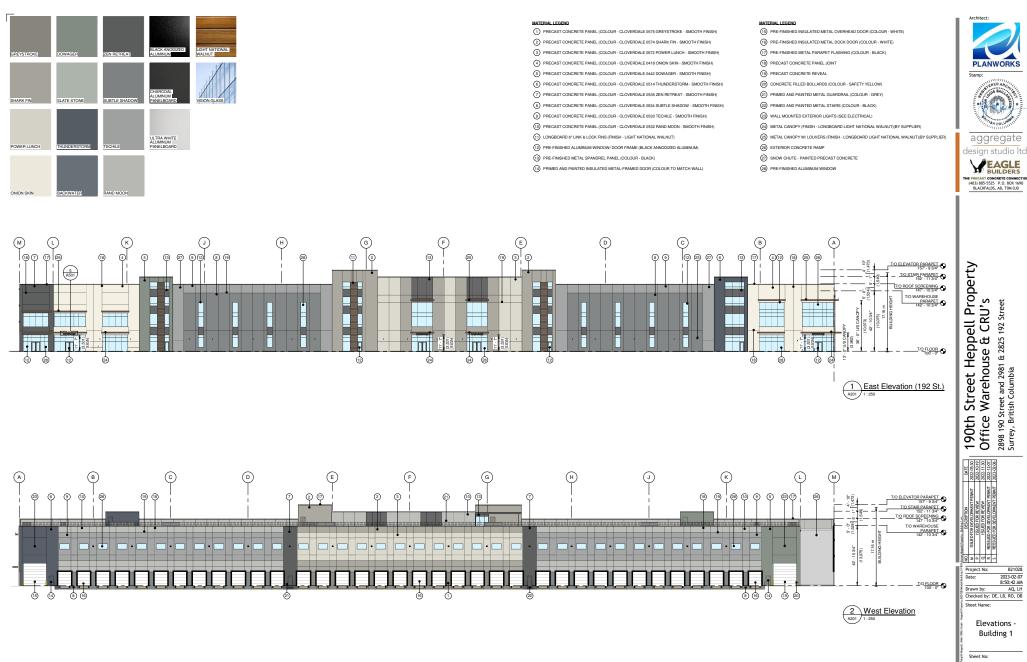

DO NOT SCALE DRAWING - VERIFY ALL DIMENSIONS, DATUMS AND LEVELS PRIOR TO CO

#### MATERIAL LEGEND 1 PRECAST CONCRETE PANEL (COLOUR - CLOVERDALE 0575 GREYSTROKE - SMOOTH FINISH)

2 PRECAST CONCRETE PANEL (COLOUR - CLOVERDALE 0574 SHARK FIN - SMOOTH FINISH)

4 PRECAST CONCRETE PANEL (COLOUR - CLOVERDALE 0418 ONION SKIN - SMOOTH FINISH)

5 PRECAST CONCRETE PANEL (COLOUR - CLOVERDALE 0442 DOWAGER - SMOOTH FINISH)

9 PRECAST CONCRETE PANEL (COLOUR - CLOVERDALE 0533 TECHILE - SMOOTH FINISH)

(2) PRE-FINISHED ALUMINUM WINDOW/ DOOR FRAME (BLACK ANNODIZED ALUMINUM)

(14) PRIMED AND PAINTED INSULATED METAL-FRAMED DOOR (COLOUR TO MATCH WALL)

(1) LONGBOARD 6" LINK & LOCK FINS (FINISH - LIGHT NATIONAL WALNUT)

3 PRE-FINISHED METAL SPANDREL PANEL (COLOUR - BLACK)

(1) PRECAST CONCRETE PANEL (COLOUR - CLOVERDALE 0532 RAND MOON - SMOOTH FINISH)

3 PRECAST CONCRETE PANEL (COLOUR - CLOVERDALE 0572 POWER LUNCH - SMOOTH FINISH)

6 PRECAST CONCRETE PANEL (COLOUR - CLOVERDALE 0514 THUNDERSTORM - SMOOTH FINISH)

(8) PRECAST CONCRETE PANEL (COLOUR - CLOVERDALE 0534 SUBTLE SHADOW - SMOOTH FINISH)

7 PRECAST CONCRETE PANEL (COLOUR - CLOVERDALE 0535 ZEN RETREAT - SMOOTH FINISH)

#### MATERIAL LEGEND

- (15) PRE-FINISHED INSULATED METAL OVERHEAD DOOR (COLOUR WHITE)
- (16) PRE-FINISHED INSULATED METAL DOCK DOOR (COLOUR WHITE)
- (17) PRE-FINISHED METAL PARAPET FLASHING (COLOUR BLACK)
- (18) PRECAST CONCRETE PANEL JOINT
- (19) PRECAST CONCRETE REVEAL
- 20 CONCRETE FILLED BOLLARDS (COLOUR SAFETY YELLOW)
- 21 PRIMED AND PAINTED METAL GUARDRAIL (COLOUR GREY)
- 22 PRIMED AND PAINTED METAL STAIRS (COLOUR BLACK)
- 23 WALL MOUNTED EXTERIOR LIGHTS (SEE ELECTRICAL)
- (24) METAL CANOPY (FINISH LONGBOARD LIGHT NATIONAL WALNUT)(BY SUPPLIER)
- (25) METAL CANOPY W/ LOUVERS (FINISH LONGBOARD LIGHT NATIONAL WALNUT) (BY SUPPLIER)
- (26) EXTERIOR CONCRETE RAMP
- (27) SNOW CHUTE PAINTED PRECAST CONCRETE
- (28) PRE-FINISHED ALUMINUM WINDOW





aggregate design studio Itd



B21028

40. LH

2023-02-07 8:50:45 AM

Building 1

Sheet No: A302

(12) (11) (10) (9) (8) (7)(6) (5) (3) (2) (4) (1)62128 SCUPPER HEIGHT TBC SCUPPER HEIGHT TBC SCUPPER HEIGHT TBC SCUPPE HEIGHT T/Q ELEVATOR PARAPET (4) 9 17 ₿ 4000 3 (1) 2 141'-7 (23) (12) (2) (19) (18) (17) 141' - 7" 38906 141' 141' - 7" 141 T/P ROOF SCREENING 147' - 10 3/4" 190th Street Heppell Property Office Warehouse & CRU's 2898 190 Street and 2981 & 2825 192 Street Surrey, British Columbia T/O WAREHOUSE 1 A501 PARAPET 142' - 10 3/4" T/O FLOOR 100' · 0" 14 14 12 20 ٢ 1 1 North Elevation (30 Ave.) (2) (1)(3) (4) (5) (6) G (8) (9) (10) (11) (12) DATE 2022-05-30 2022-10-19 2022-11-30 2022-112-07 2023-02-06 5QØ 4 TIO ELEVATOR PARAPET SCUPPER (3) (7) TO STAIR PARAPET TO STAIR PARAPET 157 - 9 3/4" TO STAIR PARAPET 152 - 113/4" TO STAIR PARAPET 157 - 9 3/4" 157 - 10 3/4" 157 - 10 3 Q @ @ 5009083 2 (19) SCUPPER HEIGHT TBC SCUPPER HEIGHT TBC  $\widehat{\sigma}$ (18) (2) SCUPPER HEIGHT TBC (18) 4 10 00 141'-7" 141' - 7\* 141' - 7" REVIEW REVIEW REVIEW τ. T/O WAREHOUSE PARAPET 142' - 10 3/4\* - 1 . OR DEV SSUED 1 SSUED 1 <u>Ny × ∘ 0 × v</u> Project No: Date: 5 T/O FLOOR 100' - 0" Drawn by: 14 14 14 14 14 14 00 40 0 Checked by: DE, LB, RO, OB Sheet Name: 2 South Elevation Elevations -

DO NOT SCALE DRAWING - VERIFY ALL DIMENSIONS, DATUMS AND LEVELS PRIOR TO COM



#### MATERIAL LEGEND

1 PRECAST CONCRETE PANEL (COLOUR - CLOVERDALE 0575 GREYSTROKE - SMOOTH FINISH) (2) PRECAST CONCRETE PANEL (COLOUR - CLOVERDALE 0574 SHARK FIN - SMOOTH FINISH) 3 PRECAST CONCRETE PANEL (COLOUR - CLOVERDALE 0572 POWER LUNCH - SMOOTH FINISH) (4) PRECAST CONCRETE PANEL (COLOUR - CLOVERDALE 0418 ONION SKIN - SMOOTH FINISH) 5 PRECAST CONCRETE PANEL (COLOUR - CLOVERDALE 0442 DOWAGER - SMOOTH FINISH) 6) PRECAST CONCRETE PANEL (COLOUR - CLOVERDALE 0441 SLATE STONE - SMOOTH FINISH) 1 PRECAST CONCRETE PANEL (COLOUR - CLOVERDALE 0514 THUNDERSTORM - SMOOTH FINISH (8) PRECAST CONCRETE PANEL (COLOUR - CLOVERDALE 0513 BACKWATER - SMOOTH FINISH) (9) PRECAST CONCRETE PANEL (COLOUR - CLOVERDALE 0535 ZEN RETREAT - SMOOTH FINISH) (1) PRECAST CONCRETE PANEL (COLOUR - CLOVERDALE 0534 SUBTLE SHADOW - SMOOTH FINISH

1) PRECAST CONCRETE PANEL (COLOUR - CLOVERDALE 0533 TECHILE - SMOOTH FINISH)

#### MATERIAL LEGEND

- (2) PRECAST CONCRETE PANEL (COLOUR CLOVERDALE 0532 RAND MOON SMOOTH FINISH)
- (3) PRE-FINISHED ALUMINUM PANELBOARD (COLOUR ULTRA WHITE)

MATERIAL LEGEND

23 CONCRETE FILLED BOLLARDS (COLOUR - SAFETY YELLOW)

(24) PRIMED AND PAINTED METAL GUARDRAIL (COLOUR - GREY)

27 METAL CANOPY (FINISH - LONGBOARD LIGHT NATIONAL WALNUT)(BY SUPPLIER)

(28) METAL CANOPY W/ LOUVERS (FINISH - LONGBOARD LIGHT NATIONAL WALNUT)(BY SUPPLIER)

25 PRIMED AND PAINTED METAL STAIRS (COLOUR - BLACK)

(26) WALL MOUNTED EXTERIOR LIGHTS (SEE ELECTRICAL)

30 SNOW CHUTE - PAINTED PRECAST CONCRETE

32 PRE-FINISHED ALUMINUM PANELBOARD (COLOUR - CHARCOAL)

(29) EXTERIOR CONCRETE RAMP

31 PRE-FINISHED ALUMINUM WINDOW

- (1) PRE-FINISHED METAL SPANDREL PANEL (COLOUR BLACK)
- (5) LONGBOARD 6" LINK & LOCK FINS (FINISH LIGHT NATIONAL WALNUT)
- (6) PRE-FINISHED ALUMINUM WINDOW/DOOR FRAME (BLACK ANNODIZED ALUMINUM)
- (7) PRIMED AND PAINTED INSULATED METAL-FRAMED DOOR (COLOUR TO MATCH WALL)
- (B) PRE-FINISHED INSULATED METAL OVERHEAD DOOR (COLOUR WHITE)
- (19) PRE-FINISHED INSULATED METAL DOCK DOOR (COLOUR WHITE)
- (20) PRE-FINISHED METAL PARAPET FLASHING (COLOUR BLACK)
- (21) PRECAST CONCRETE PANEL JOINT
- (2) PRECAST CONCRETE REVEAL






Stamp


190th Street Heppell Property Office Warehouse & CRU's

2898 190 Street and 2981 & 2825 192 Street Surrey, British Columbia

design studio Ito THE PRECAST CONCRETE CONNECTIO (403) 885-5525 P.O. BOX 1690 BLACKFALDS, AB, TOM 0J0

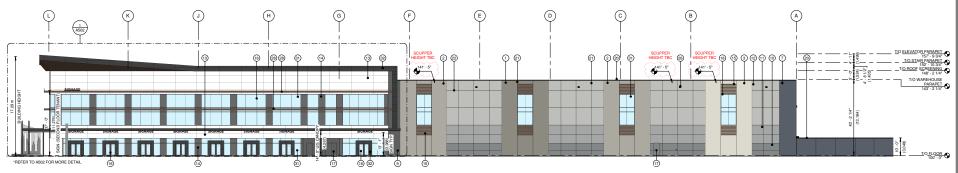

1 East Elevation (192 St.)

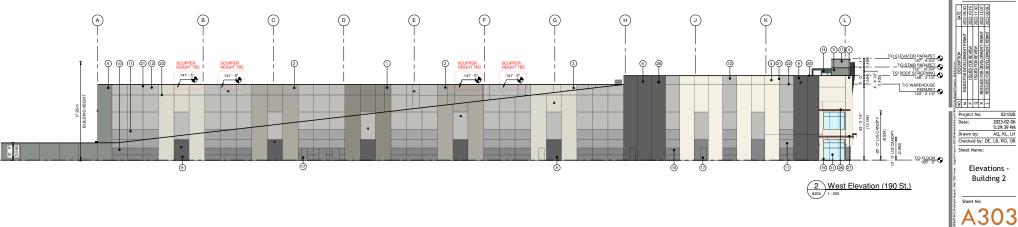

DO NOT SCALE DRAWING - VERIFY ALL DIMENSIONS, DATUMS AND LEVELS PRIOR TO COMMENC

B21028 2023-02-06 5:29:39 PM 40. KL . LH Checked by: DE, LB, RO, OB



#### MATERIAL LEGEND

- 1 PRECAST CONCRETE PANEL (COLOUR CLOVERDALE 0575 GREYSTROKE SMOOTH FINISH)

#### 2 PRECAST CONCRETE PANEL (COLOUR - CLOVERDALE 0574 SHARK FIN - SMOOTH FINISH)

- 3 PRECAST CONCRETE PANEL (COLOUR CLOVERDALE 0572 POWER LUNCH SMOOTH FINISH)
- (4) PRECAST CONCRETE PANEL (COLOUR CLOVERDALE 0418 ONION SKIN SMOOTH FINISH)
- 5 PRECAST CONCRETE PANEL (COLOUR CLOVERDALE 0442 DOWAGER SMOOTH FINISH)
- (6) PRECAST CONCRETE PANEL (COLOUR CLOVERDALE 0441 SLATE STONE SMOOTH FINISH)
- (7) PRECAST CONCRETE PANEL (COLOUR CLOVERDALE 0514 THUNDERSTORM SMOOTH FINISH)
- 8 PRECAST CONCRETE PANEL (COLOUR CLOVERDALE 0513 BACKWATER SMOOTH FINISH)
- 9 PRECAST CONCRETE PANEL (COLOUR CLOVERDALE 0535 ZEN RETREAT SMOOTH FINISH)
- (0) PRECAST CONCRETE PANEL (COLOUR CLOVERDALE 0534 SUBTLE SHADOW SMOOTH FINISH)
- 1) PRECAST CONCRETE PANEL (COLOUR CLOVERDALE 0533 TECHILE SMOOTH FINISH)

### MATERIAL LEGEND

21 PRECAST CONCRETE PANEL JOINT

DO NOT SCALE DRAWING- VERIFY ALL DIMENSIONS, DATUMS AND LEVELS PRIOR TO C

(14) PRE-FINISHED METAL SPANDREL PANEL (COLOUR - BLACK)

(5) LONGBOARD 6" LINK & LOCK FINS (FINISH - LIGHT NATIONAL WALNUT)

(8) PRE-FINISHED INSULATED METAL OVERHEAD DOOR (COLOUR - WHITE)

(19) PRE-FINISHED INSULATED METAL DOCK DOOR (COLOUR - WHITE)

20 PRE-FINISHED METAL PARAPET FLASHING (COLOUR - BLACK)

(6) PRE-FINISHED ALUMINUM WINDOW/DOOR FRAME (BLACK ANNODIZED ALUMINUM)

(7) PRIMED AND PAINTED INSULATED METAL-FRAMED DOOR (COLOUR TO MATCH WALL)

(2) PRECAST CONCRETE PANEL (COLOUR - CLOVERDALE 0532 RAND MOON - SMOOTH FINISH)

### (3) PRE-FINISHED ALUMINUM PANELBOARD (COLOUR - ULTRA WHITE)

(24) PRIMED AND PAINTED METAL GUARDRAIL (COLOUR - GREY)

MATERIAL LEGEND

- 25 PRIMED AND PAINTED METAL STAIRS (COLOUR - BLACK)

23 CONCRETE FILLED BOLLARDS (COLOUR - SAFETY YELLOW)

- 26) WALL MOUNTED EXTERIOR LIGHTS (SEE ELECTRICAL) @ METAL CANOPY (FINISH - LONGBOARD LIGHT NATIONAL WALNUT)(BY SUPPLIER)
- (28) METAL CANOPY W/ LOUVERS (FINISH - LONGBOARD LIGHT NATIONAL WALNUT) (BY SUPPLIER)
- (29) EXTERIOR CONCRETE RAMP
- 30 SNOW CHUTE PAINTED PRECAST CONCRETE
- 31 PRE-FINISHED ALUMINUM WINDOW
- 2 PRE-FINISHED ALUMINUM PANELBOARD (COLOUR CHARCOAL)





aggregate

Street Heppell Property Warehouse & CRU's 2898 190 Street and 2981 & 2825 192 Street Surrey, British Columbia 190th Office

PERMIT

B21028 2023-02-06 5:29:46 PM

40. KL . LH Checked by: DE, LB, RO, OB Sheet Name:

> Elevations -Building 2

REVIEW REVIEW REVIEW

)ate:

Drawn by:



Α

@ 3 2

Ð

в

(10)

1 PRECAST CONCRETE PANEL (COLOUR - CLOVERDALE 0575 GREYSTROKE - SMOOTH FINISH)

10 PRECAST CONCRETE PANEL (COLOUR - CLOVERDALE 0534 SUBTLE SHADOW - SMOOTH FINISH

1) PRECAST CONCRETE PANEL (COLOUR - CLOVERDALE 0533 TECHILE - SMOOTH FINISH)

(13

nnnnnnnnn

MATERIAL LEGEND

(21)

20

в

8 9 12 11 11

10 19

(11)

\$ 1 (19)

21

 $\overline{O}$ 

hannnnnnn

(18)

(20

1 

(1)

(21) (31) (17)

(16)

nnnnnnnn

(15)

1 2 (31) 12 @ 9

**-**

-

ø

(14)

(2) PRECAST CONCRETE PANEL (COLOUR - CLOVERDALE 0532 RAND MOON - SMOOTH FINISH)

(8)

- 21 PRECAST CONCRETE PANEL JOINT
- (22) PRECAST CONCRETE REVEAL

(9

hananananan

¢4

MATERIAL LEGEND

(14

(5)

@ @ @

(17) 1

(6)

14 12 22

MATERIAL LEGEND

25

26)

@

(28)

29 EXTERIOR CONCRETE RAMP

30 SNOW CHUTE - PAINTED PRECAST CONCRETE

23 CONCRETE FILLED BOLLARDS (COLOUR - SAFETY YELLOW)

(24) PRIMED AND PAINTED METAL GUARDRAIL (COLOUR - GREY)

PRIMED AND PAINTED METAL STAIRS (COLOUR - BLACK)

WALL MOUNTED EXTERIOR LIGHTS (SEE ELECTRICAL)

3

DOCODOCOCOCO

@ 11 12

۱ ش

6

METAL CANOPY (FINISH - LONGBOARD LIGHT NATIONAL WALNUT)(BY SUPPLIER)

METAL CANOPY W/ LOUVERS (FINISH - LONGBOARD LIGHT NATIONAL WALNUT) (BY SUPPLIER)

2

1 North Elevation

43 - 2 1/4" (13,164)

Α

@ 9

@ @

2 North Elevation A

(1.0)

(1)

(4)

- 31 PRE-FINISHED ALUMINUM WINDOW 32 PRE-FINISHED ALUMINUM PANELBOARD (COLOUR - CHARCOAL)

PLANWORKS Stamp





design studio Itc 




B21028 2023-02-06 5:30:25 PM


40. KL . LH

A305



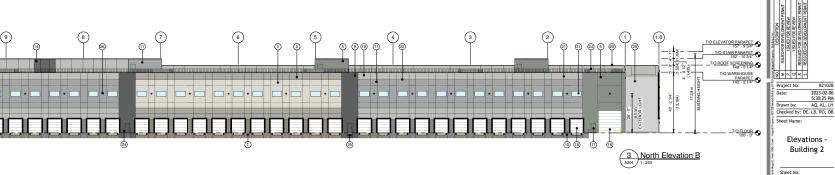

WWNG - VERIFY ALL DMENSIONS, DATUMS AND LEVELS PRICE TO

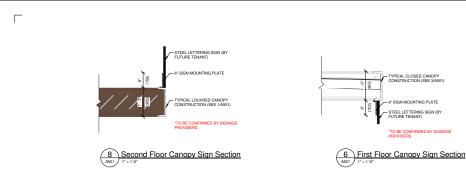

9' - 0" (2,743) VARIES PER TENANT SIGN

ELITURE PROPOSED TENANT SIGNAGE - STEEL LETTERING - MOUNTED UNDERSIDE OF CANOPY - COLOURS AND FINISHES TO BE APPROVED BY TENANT

5 First Floor Canopy Sign


TO BE CONFIRMED BY SIGNAGE PROVIDERS




EUTURE PROPOSED TENANT SIGNAGE - STEEL LETTERING - MOUNTED UNDERSIDE OF CANOPY - COLOURS AND FINISHES TO BE APPROVED BY TENANT \*TO BE CONFIRMED BY SIGNAGE PROVIDERS






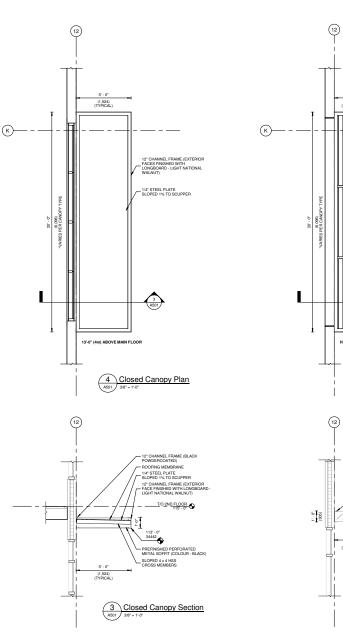

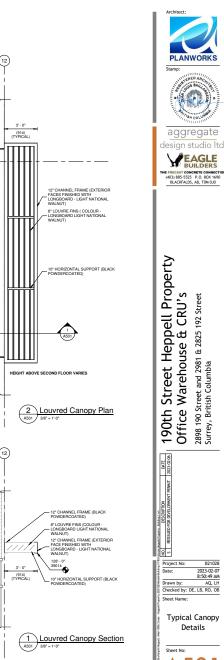

B21028

40. LH

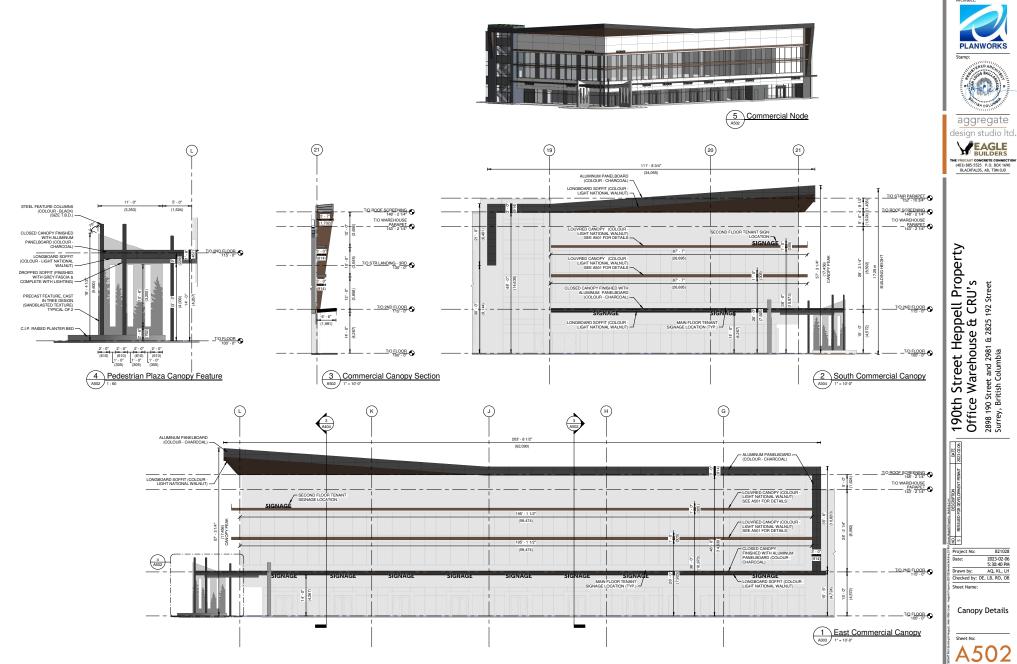





190th Street Heppell Property Office Warehouse & CRU's 2898 190 Street and 2981 & 2825 192 Street Surrey, British Columbia

TE 05-30 12-07 12-07



Exterior Render - Building 1

Sheet No:



 $\square$ 



Γ

190th Street Heppell Property Office Warehouse & CRU's 2898 190 Street and 2981 & 2825 192 Street Surrey, British Columbia


\_

PLANWORKS Stamp:

aggregate lesign studio Itd CALL CONCEPTEONNECTION (403) 855-5525 P.O. BOX 1690 BLACKFALDS, AB, TOM 0.00



Exterior Render - Building 2

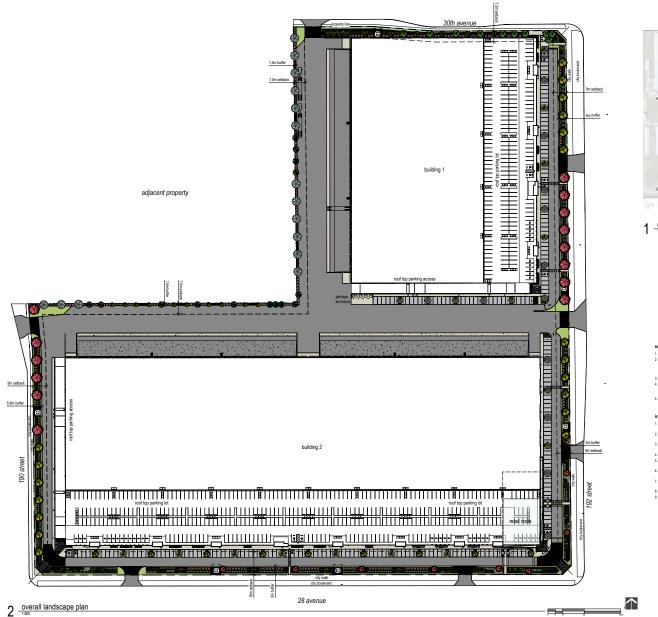



### EIGHT ONE EIGHT STUDIO

This drawing is copyright © 818 studio ltd., and shall not be reproduced, revised, transmitted and / or utilized by any third party cutside of the Owner without written permission from 818 studio ltd.

3. Retro Luid asserge for all grading information. The assessment of the three presented in the part han base based on the second second in the part han base based on a value assertiation of each the for structural fields; taxes, all second second second second second based based on the second second second second based based based on the second second second second of the the second second second second second of the three second s

exclusion were not undertaken. White reascable definition have been made to determine that the trees recommended for reletance and building. The second second second second second second second predict with aboutive centrary to behaviour of any single method with aboutive centrary to behaviour of any single method. The second second second second second second reletance and the second second second second reletance and the second second second second reletance and the second second reletance and reletance and reletance and reletance and reletance and reletance and reletance r

or deterioration. The findings and opinions expressed in this plan are representative of the conditions found on the day of the reviewe (2022-040) only, any terms retained should be reviewed on a regular basis. The root crowns, and overall structure, of all of the trends to be attended must be reviewed immediately following land clearing, grade disturbance.

2. Do not scale drawings. Refer to Civil drawings for all grading information

Ζ notes

O

6	revised base plan	2022-12-06	hel	hul
5	revised base plan	2022-12-02	hel	hul
4	revised base plan	2022-11-23		aag
3	ravise site plan	2022-10-03		ab
2	revise site plan/planting	2022-05-24		ab
1	ravise site plan	2022-05-13	eg.	da
rumber	nivision	date	by	approved
6	issue for dp resubmissio		2023-02-02	
5	issue for dp- re-submissi	2022-12-06		
4	issue for dp- re-submissi		2022-11-24	
3	issue for client review		2022-10-03	
2	issue for do	2022-05-25		

2022-04-29

### soil preparation and placement notes

- 1. All growing medium placed on project to meet or exceed BCNTA and BC Landscape Standards latest edition Submit sieve analysis by an approved independent soil testing laboratory for each type of growing medium being used on the project PROR to placement for review and approval. Clearly identify source and type for each. Resulmit as required until grawing medium approved. Provide non-composed ample of each type of proposed growing medium for each different application within the project. Minimum 1 line physical sample. 3. Submittals shall be made at least seven (7) days before
- Schmittes shall be made labels storem (7) skyst before Constanct shall not nove versk sprave sladim or additione shart hey are excessively wet, externely dy, focare or is any manere which is adhenasily after graving structure. Covering medium whose should not be extended by handing under these conditions all be negliciti. Covering medium, except structure is majorish mission ad minimum deping and adhenut in the short adhenut is adhenut in the short ad

#### irrigation notes

- All "soft" landscape areas are to be irrigated with high efficiency design/build irrigation system to IIABC Standards, cor and Wind Sensors. The irrigation system design and installation should be in accordance with the Irrigation Industry of BC Standards and Guidelines and City of Surrey Bylaw.
- System design and installation to take into accountelevation differences, sun orientation and other factors affecting zoning and operation of the system to minimized evapotranspiration and wind lost.
- 4. System design shall provide for uniform complete 'head to head' coverage of all lawns and planted
- 5. Contractor shall be responsible to provide SHOP DRAWINGS a minimum of 3 weeks prior to installation of any imgetion for review and approval.
- 6 Should the or al, any additional modifications to the impation systems, as directed by the Lands Architect shall be at the contractors cost.
- PRIOR to Substantial Performance, contractor shall provide a maintenance DATAAND OPERATION instruction manual containing operational information for all operating components, cleaning and lubrication schedules, overhaultadjustment schedule.
- 8. Solenoid valves shall be first quality, compatible with the controller selected.
- Valve boxes shall be reinforced plastic boxes manufactured specifically for landscape imgation, complete withcaptive lock boilt cover, sized to suit valves and other components with adequate room for operation and maintenance.

### 190th St. Heppell Project


2898 - 190 Street, 2825/2981 - 192 Street, Surrey BC

drawinn


1 issue for client review

#### overall landscape plan



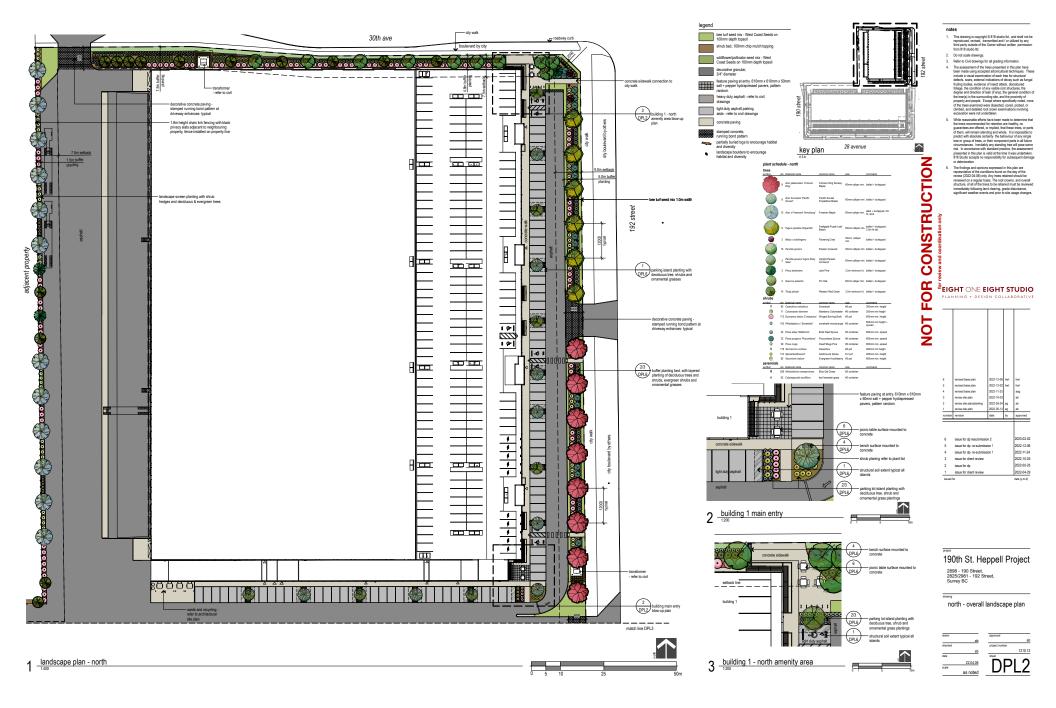



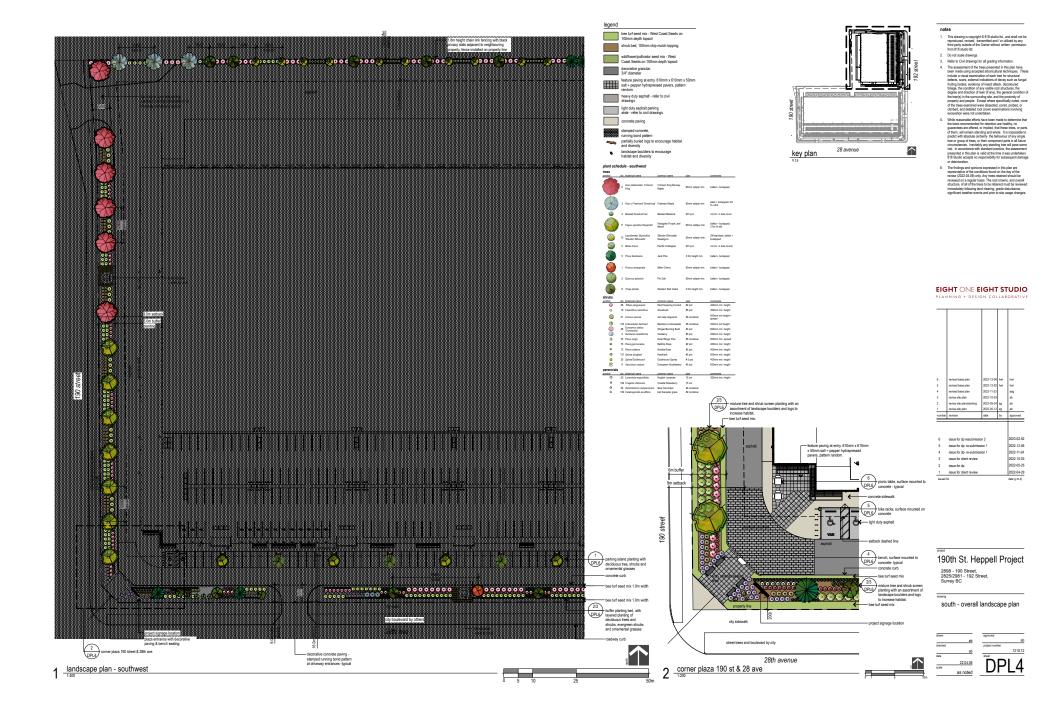





rooftop planting plan

190th St. Heppell Project

2898 - 190 Street, 2825/2981 - 192 Street, Surrey BC

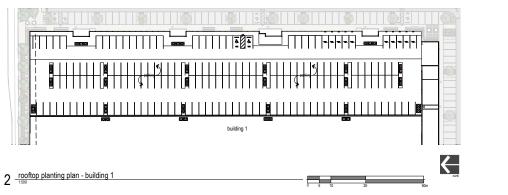



1

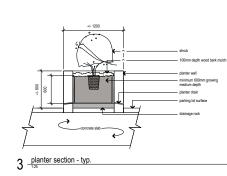

5111 0 0 5						
symbol	quantity	botanical name	common name	size	comments	spacing
	48	Euonymus alatus 'Compactus'	Winged Burning Bush	#3 pot	600mm min. height	+/-1000
۵	85	Spirea'Goldmound'	Goldmound Spirea	# 2 pot	400mm min. height	+/-675
perennials						
symbol	quantity	botanical name	common name	size	comments	spacing
•	532	Lavendula angustifolia	English Lavender	15 cm	300mm min. height	+/-550

rooftop planting - overall shrubs

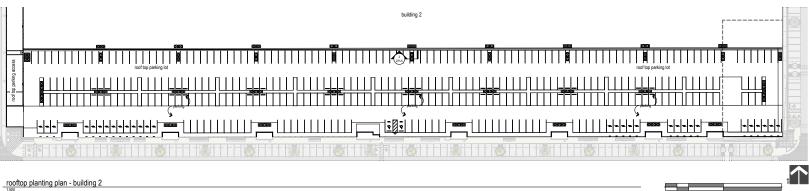

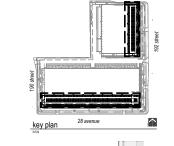

EIGHT ONE EIGHT STUDIO PLANNING + DESIGN COLLABORATIVE

This drawing is copyright © 818 studio ltd., and shall not be reproduced, revised, transmitted and / or utilized by any third party outside of the Owner without written permission from 818 studio ltd.

Reite the Curd sample for all grading information.
 The assessment of the majo spreament of the gain have, include a visual examination of each the for shared addition. Since a visual examination of each the for shared addition. Since a visual examination of each the for shared balange. He conclude on a first shared and provide the darget and direction of the visual nod the provide of the theory is and direction of the shared balance of the theory is and direction of the visual nod the provide of the theory is and direction of the visual nod the provide of the theory is and direction of the visual nod the visual node of the three same shared sends and concerning the visual of the three same send sends concerning the visual node of the three same send sends concerning the visual node of the three same send sends concerning the visual node of the three same send sends concerning the visual node of the three same send sends concerning the visual node of the three same send sends concerning the visual node of the three same send sends concerning the visual node of the three same send sends concerning the visual node of the three sends and send sends node node node the theory the the visual node of the three same send sends concerning the visual node of the three same send sends concerning the visual node of the theory of the three sends node to not not node of the three sends the visual node of the three sends node to not node of the three sends the visual node of the three sends node to node of the three sends the visual node of the three sends node to node the node of the three sends the visual node of the three sends node to node the node of the three sends the visual node of the three sends node to node the node of the three sends the three sends the visual node of the three sends node to node the node of the three sends the thre

excavabors were not undertaken. Wich reasonable driften hare been made to determine that the trees excernession of or relations are healthy, co and the second second second second second second practic with aboution centrary the behaviour of any ranging time or graups of them, with ministration grant and all tunes from or graups of them, of the composed practics of any ranging time or graups of them, of the composed practics of any ranging the social composed on the social second second second relations of the social second or deterioration.

or deterioration. The findings and opinions expressed in this plan are representative of the conditions found on the day of the reviewe (2022-040) only, any tester retained should be reviewed on a regular basis. The root crowns, and overall structure, of all of the trends to be attended must be reviewed immediately following land clearing, grade disturbance.

2. Do not scale drawings. Refer to Civil drawings for all grading information

Z notes

Ō Ē

Ü

TRU

-SNO


Û


FOR

NOT

4		revised base plan	2022-12-06	hel	Inel
1	5	revised base plan	2022-12-02	hel	Inel
4		revised base plan	2022-11-23		aag
1	8	revise site plan	2022-10-03		ab
4		revise site plan/planting	2022-05-24		ab
2		revise site plan	2022-05-13	eg.	ab
ŝ	umber	nivision	date	by	approved
1					
	6	issue for dp resubmissio		2023-02-02	
	5	issue for dp- re-submissi	2022-12-06		
	4	issue for dp- re-submissi		2022-11-24	
	3	issue for client review		2022-10-03	
	2	issue for dp			2022-05-25



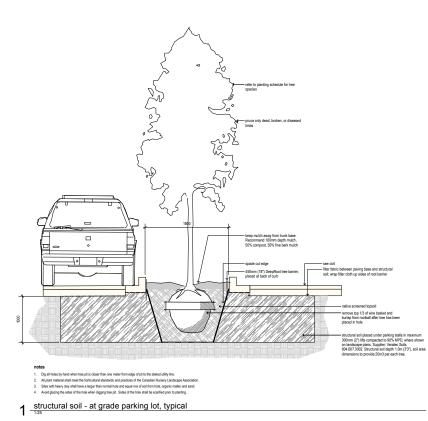

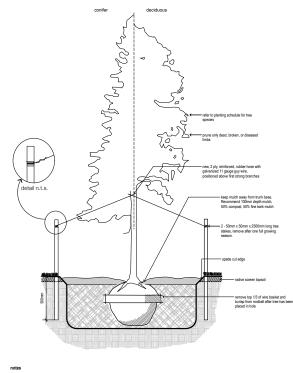

- 1. If minimum utility setbacks permit position tree stakes into direction of prevailing winds.
- 2. All trees to maintain a minimum clearance form all utilities as set out in the City of Surrey land use bylaws
- 3. Dig all holes by hand when tree pit is closer than one meter from edge of pit to the staked utility line.
- 4. Trees larger than 80mm caliper or 3.0 meters height require 3 tree stakes.
- 5. All plant material shall meet the horticultural standards and practices of the Canadian Nursery Landscape Association
- 6. Sites with heavy clay shall have a larger than normal hole and equal mix of soil from hole, organic matter and sand.
- Avoid glazing the sides of the hole when digging tree pit. Sides of the hole shall be scarified prior to planting.

2 tree planting, typical (excludes 1.8m wide parking islands)



2898 - 190 Street, 2825/2981 - 192 Street, Surrey BC

drawing

details



 This drawing is copyright © 818 studio ltd., and shall not be reproduced, revised, transmitted and / or utilized by any third party outside of the Owner without written permission from 818 studio ltd. 2. Do not scale drawings. Refer to Civil drawings for all grading information

notes


Relet to Luid assergs for all packing elements.
 The assessment of the test personal on the logit have an include a value elementation of a dark test personal on the logit have an include a value elementation of each test per totalutation and elements and the per set of elements and the period of the test period. Set of the logit have all devices the logit have all device

escabatoria mer di undertalani. 16. White rescuelare derich save been mode to determine that the times recommonded for interioria am buality, co amplitude second second second second second second of them, vitere manager and second second second second them or any coll second second second second second second them or any coll second second second second second second them or any coll second second second second second second them or any coll second second

or deterioration. 6. The findings and opinions expressed in this plan are representative of the conditions found on the day of the reviews (2022-406) gm/s, My express retained should be reviewed on a regular basis. The rocd creaters, and overall structure, of all of the trees to be retineed must be reviewed immediately following land clearing, grade disturbance, significant weather events and prior to she usage changes.

#### EIGHT ONE EIGHT STUDIO PLANNING + DESIGN COLLABORATIVE

	revised base plan	2022-12-06	hel	Inel	
5	revised base plan	2022-12-02	hel	hul	
	revised base plan	2022-11-23		aag	
	revise site plan	2022-10-03		ab	
2	revise site plan/planting	2022-05-24		ab	
	revise site plan	2022-05-13	eg.	ab	
rumber	nivision	date	by	approved	
6	issue for dp resubmissio	n 2		2023-02-02	
5	issue for dp- re-submissi		2022-12-06		
4	issue for dp- re-submissi		2022-11-24		
3	issue for client review		2022-10-03		
2	issue for dp			2022-05-25	
1	issue for client review			2022-04-29	

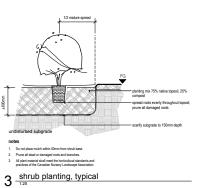



model: MLB970-PCC Bench supplier: magin colour: sitve: 14 materialis: bench ends are made from solid cast aluminum. The seat employs high Density Paper Composite (HEPC) - Charcod colour: installation: autone mount as per manufacturer's specification installation: autone mount as per manufacturer's specification

site furnishing - bench 4

model: MIR-2300-0001 bike rack supplier: magin colour: silver Colour: silver Materials: the bike rack frame is made from solid cast aluminum. Tamper residant flashenes are stanless sited. Installation: surface mount as per manufacturer's specification

5 site furnishing - bicycle rack



site furnishing - picnic table 6 site



# APPENDIX III INTER-OFFICE MEMO

TO:	Manager, Area Planning & Development - South Surrey Division Planning and Development Department				
FROM:	Development Services Manager,	Engineering Dep	artment		
DATE:	February 02, 2023	PROJECT FILE:	7822-0191-00		
RE:	Engineering Requirements (Con	nmercial/Industri	ial)		

## **REZONE/SUBDIVISION**

### **Property and Right-of-Way Requirements**

Location: 2898 190 St

- Dedicate approximately 4.142 m towards 28 Avenue.
- Dedicate 10 m to 13.5 m towards 30 Avenue.
- Dedicate 14.5 m towards 190 Street.
- Dedicate 6.308 m to 8.442 m to 192 Street.
- Dedicate required corner cuts.
- Register 0.5 m SRW along all road frontages.

### Works and Services

- Construct multi-use pathway on 192 Street.
- Construct the east side of 190 Street.
- Construct the north side of 28 Avenue.
- Construct the south side of 30 Avenue.
- Construct water mains along 30 Avenue.
- Construct sanitary main, as required.
- Construct storm mains along 28 Avenue, 192 Street, and 30 Avenue.
- Complete sanitary and storm catchment analysis to determine existing capacities. Resolve downstream constraints, as identified.
- Provide on-site stormwater mitigation, biofiltration, and water quality features.
- Register applicable legal documents as determined through detailed design.

A Servicing Agreement is required prior to Rezone/Subdivision.

### DEVELOPMENT PERMIT/DEVELOPMENT VARIANCE PERMIT

There are no engineering requirements relative to issuance of the Development Permit/ Development Variance Permit.

Jeffy lang

Jeff Pang, P.Eng. Development Services Manager

NOTE: Detailed Land Development Engineering Review available on file

# **Tree Preservation Summary**

Surrey Project No: 7922-01910-00

Address: 2898 - 190 Street, 2981/2825 - 192 Street, Surrey, BC Registered Arborist: Catherine Dowdell CA# PR5221-A

On-Site Trees	Number of Trees
Protected Trees Identified	
(on-site and shared trees, including trees within boulevards and proposed streets	64
and lanes, but excluding trees in proposed open space or riparian areas)	
Protected Trees to be Removed	64
Protected Trees to be Retained (excluding trees within proposed open space or riparian areas)	0
<ul> <li>Total Replacement Trees Required:</li> <li>Alder &amp; Cottonwood Trees Requiring 1 to 1 Replacement Ratio</li> <li>9 X one (1) = 9</li> <li>All other Trees Requiring 2 to 1 Replacement Ratio</li> <li>55 X two (2) = 110</li> </ul>	119
Replacement Trees Proposed	181
Replacement Trees in Deficit	0
Protected Trees to be Retained in Proposed [Open Space / Riparian Areas]	n/a


Off-Site Trees	Number of Trees
Protected Off-Site Trees to be Removed	17
Total Replacement Trees Required: - Alder & Cottonwood Trees Requiring 1 to 1 Replacement Ratio X one (1) = 1	33
<ul> <li>All other Trees Requiring 2 to 1 Replacement Ratio</li> <li><u>16</u> X two (2) = 32</li> </ul>	
Replacement Trees Proposed	0
Replacement Trees in Deficit	33


Summary, report and plan prepared and submitted by: Harrison Luethe

Summary, report and plan reviewed and approved by: Catherine Dowdell CA# PR5221-A

(Signature of Arborist)

2023/02/03

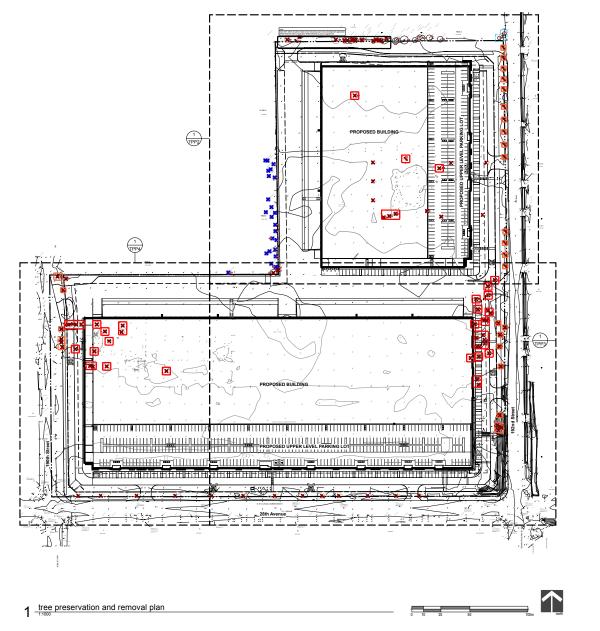

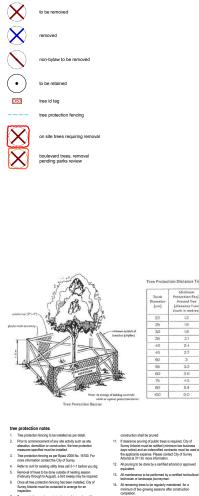

legend



Tree Protection Distance Table Trunk 20 30 36 +10 45 50 55 60 75 90 100

- Tree protection must remain in place and in good condition throughout site demolition and construction and must not be altered, moved or removed until authorized by City of Surrey
- rborist.
- Minimize impact to tree root systems during construction. Any tree root systems impacted during construction activities will need to be addressed through proper pruning techniques.
- It is not anticipated that tree pruning is required, however if pruning is required it is recommended that a certified arborist or qualified professional with extensive tree knowledge perform all tree pruning. 10. Any branches broken or significantly damaged as a result of

## 2 tree protection barrier detail



site base updates

190th Street Heppell Property

added to tree protection zones Absolutely no work to be carried out inside the tree protection zone. It access is required, contact City of Surrey Arborist. Provide 48hrs notice for response. 2898 - 190 Street, 2825/2981 - 192 Street, Surrey BC

Contractor to arrange for watering as needed (minimum of weekly visit - more during temperagte weeks) of existing trees during development partial. Trees to be watered manually from a water truck.

16. Contractor to add 75-100mm of new bark mulch to be

12

2.4

27

3

3.3

3.6

4.5

5.4

60

 No stockpiling or dumping of construction materials is permitted on the adjacent soccer fields, open space of boulevard Armin

tree preservation plan



### CITY OF SURREY

### **APPENDIX V**

### (the "City")

### **DEVELOPMENT VARIANCE PERMIT**

NO.: 7922-0191-00

Issued To:

(the "Owner")

Address of Owner:

Issued To:

(the "Owner")

Address of Owner:

Issued To:

(the "Owner")

Address of Owner:

- 1. This development variance permit is issued subject to compliance by the Owner with all statutes, by-laws, orders, regulations or agreements, except as specifically varied by this development variance permit.
- 2. This development variance permit applies to that real property including land with or without improvements located within the City of Surrey, with the legal description and civic address as follows:

Parcel Identifier: 010-273-581 Lot 6 Section 21 Township 7 New Westminster District Plan 16954

2981 - 192 Street

Parcel Identifier: 004-536-495 Parcel "A" (Explanatory Plan 15837) Legal Subdivision 9 Section 21 Township 7 New Westminster District

2898 - 190 Street

### Parcel Identifier: 002-176-947

Legal Subdivision 9 Section 21 Township 7 Except: Firstly: South 33 Feet Secondly: Part Subdivided By Plan 16954 Thirdly: Parcel "A" And Road (Explanatory Plan 15837), Fourthly: Part Dedicated Road On Plan Bcp22704 New Westminster District

2825 - 192 Street

### (the "Land")

3. (a) As the legal description of the Land is to change, the City Clerk is directed to insert the new legal description for the Land once title(s) has/have been issued, as follows:

Parcel Identifier:

- (b) If the civic address(es) change(s), the City Clerk is directed to insert the new civic address(es) for the Land, as follows:
- 4. Surrey Zoning By-law, 1993, No. 12000, as amended is varied as follows:
  - (a) In Table D.1 of Part 5, Off-Street Parking and Loading/Unloading, the industrial parking rate is reduced from 1.0 parking spaces per 100 square metres to 0.983 parking spaces per 100 square metres.
- 5. This development variance permit applies to only the portion of the Land shown on Schedule A which is attached hereto and forms part of this development variance permit. This development variance permit does not apply to additions to, or replacement of, any of the existing buildings shown on attached Schedule A, which is attached hereto and forms part of this development variance permit.
- 6. The Land shall be developed strictly in accordance with the terms and conditions and provisions of this development variance permit.
- 7. This development variance permit shall lapse if the Owner does not substantially start any construction with respect to which this development variance permit is issued, within two
  (2) years after the date this development variance permit is issued.
- 8. The terms of this development variance permit or any amendment to it, are binding on all persons who acquire an interest in the Land.

9. This development variance permit is not a building permit.


AUTHORIZING RESOLUTION PASSED BY THE COUNCIL, THE DAY OF , 20 . ISSUED THIS DAY OF , 20 .

Mayor – Brenda Locke

City Clerk – Jennifer Ficocelli

#### NCEBNING BUILDING LOCATION

- THIS SITE PLAN IS BASED ON INFORMATION PROVIDED BY THE OWNER, AND NOT A SURVEY OR ACTUALS SITE MEASUREMENTS: ENCINEER IS TO BE ADVISED BEFORE START OF CONSTRUCTION OF ANY UN-KNOWN FEATURES ON THIS OR THE ADACENT SITES THAT MIGHT IMPACT ON THE PROJECT EITHER DURING CONSTRUCTION OR FUTURE USE.
- - THE "NORTH" ORIENTATION REFERS TO NOMINAL NORTH RATHER THAN TRUE OR MAGNETIC NORTH ANY DIMENSIONS THAT SHOW THE LOCATION OF EXISTING FEATURES ARE APPROXIMATE ONLY, AND ARE TO BE CONFIRMED BEFORE CONSTRUCTION START AS REQUIRED BY A CERTIFIED ALBERTA LAND SURVEYOR.

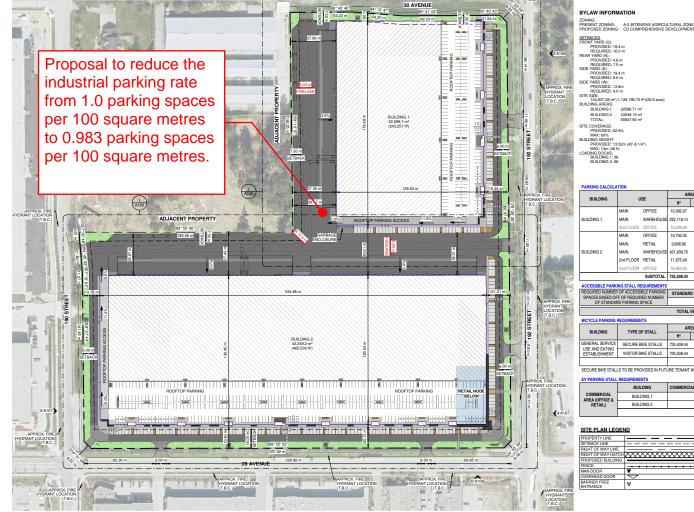

7.99 m 11.00

#### CD COMPREHENSIVE DEVELOPMENT ZONI 10 D L Context Plan SITE SCHEDUI E ON SITE AREA PARKING BY GROSS FLOOR AREA 18,976.53 10,876.57 788.12 REQUIREMENT REQUIRED ECORATIVE ft? m<sup>2</sup> 1,010.5 m<sup>2</sup> 73.2 m<sup>2</sup> OFFICE 10,992.97 1,021.3 5 STALL PER 25.53 HEAVY DUTY ASPHAL 242,749.16 ft<sup>2</sup> 67,717.89 ft<sup>2</sup> 39,233.01 ft<sup>2</sup> 4,396.57 ft<sup>2</sup> 6,291.2 m<sup>2</sup> 3,644.9 m<sup>2</sup> 408.5 m<sup>2</sup> WAREHOU 222 118 14 20,635,6 STALL PER 100 mi 206 35 IGHT DUTY ASPHAL 100 23.76 28,544.45 ft<sup>e</sup> 2,651.9 m<sup>2</sup> 38,395.2 m<sup>2</sup> OFFICE 19,740,35 1.833.9 2.5 STALL PER 100 m<sup>2</sup> 45.85 RETAIL 9,848.96 915.0 STALL PER 100 m<sup>2</sup> 27.45 STALL PER WAREHOUSE 421 939 70 39 199 5 100 m<sup>2</sup> 391 99 8,399.85 ft<sup>2</sup> 48,070.97 ft<sup>2</sup> 37,666.08 ft<sup>2</sup> 780.4 m<sup>2</sup> 4,465.9 m<sup>2</sup> 3,499.3 m<sup>2</sup> 11,675.49 1 084 7 STALL PER 100 m<sup>2</sup> 32.54 SIDEWALK - BOLLEV 1.761.8 5 STALL PER 063 55 100 44.04 541.88 8,745.6 m<sup>2</sup> 47,140.8 m<sup>2</sup> 94,136.89 ft<sup>2</sup> 507,419.21 ft<sup>2</sup> SUBTOTAL 725,508.44 67,401.9 IRED 797.52 Grand tota REQUIREMENT STANDARD STALLS REQUIRE 707 52 2% 0.02

	PARKING	SCHEDULE		
_	BUILDING 1	BARRIER FREE PARKING STALL	GROUND PARKING	6
.95	BUILDING 1	STANDARD PARKING STALL	GROUND PARKING	53
_	BUILDING 1	BARRIER FREE PARKING STALL	ROOF PARKING	2
3	BUILDING 1	EV PARKING STALL	ROOF PARKING	10
	BUILDING 1	STANDARD PARKING STALL	ROOF PARKING	174
	BUILDING 1	245		

**SCHEDULE A** 

UILDING 2 BARRIER FREE PARKING STALL GROUND PARKING STANDARD PARKING STALL GROUND PARKING JILDING 2 BARRIER FREE PARKING STALL ROOF PARKING JILDING 2 EV PARKING STALL ROOF PARKING 2 STANDARD PARKING STALL ROOF PARKING UII DING BUILDING 2: 542 GRAND TOTAL: 787

SECURE BIKE STALLS TO BE PROVIDED IN FUTURE TENANT IMPROVEMENT STAGE

ft<sup>2</sup> m<sup>2</sup>

725,508.44 67,401.9

	EV PARKING STALL	NEUUINEMENT S						
		BUILDING	COMMERCIAL STALLS	REQUIREMENT	REQU	IRED	BICYCLE PARKING	
	COMMERCIAL AREA (OFFICE &	BUILDING 1	49.29	20%	9.86		STALL TYPE VISITOR BIKE STALL	BIKE CAPACITY 46
	RETAIL)	BUILDING 2	149.88	20%	29.98	39.83	VISITOR BIKE STALL	46
7				TOTAL EV STALLS R	EQUIRED	40	1	

PARKING BY GROSS FLOOR AREA

REQUIREMENT REQUIRED

80.88

81

0.06 SPACE PER 100 m<sup>2</sup> 40.44

TOTAL BIKE SPACES REQUIRED

#### SITE MATERIAL LEGEND APRON \*\*\*\*\* LANDSCAPING SIDEWALK کلے LIGHT DUTY ASPHALT HARD LANDSCAPING HEAVY DUTY ASPHA DECORATIVE PAVING

TOTAL VEHICLE PARKING STALLS REQUIRED:

725,508.44 67,401.9 0.06 SPACE PER 100 m<sup>2</sup> 40,44

### Site Plan Overall

Checked by: DE, LB, RO, OB

LOADING DOORS

SIZE





lesign studio Ito

HE PRECAST CONCRETE CONNECTION (403) 885-5525 P.O. BOX 1690 BLACKFALDS, AB, TOM 0J0

Street Heppell Property Warehouse & CRU's

190th Office

LALE 2022-05-30 2022-06-20 2022-10-19 2022-11-30 2022-11-30

<u>Š</u> ≊ Z O ª O ≅ ∾

B2102

2023-02-07 8:49:09 AM

40/F4/LE

Project No:

Drawn by:

Sheet Name:

Sheet No

Date:

2898 190 Street and 2981 & 2825 192 Street Surrey, British Columbia



